40' EASEMENT

PARCEL #5

1998-027369

APN: 034-230-029

LANDS OF P&M

VINEYARDS

HOLDINGS, LLC

(P) HOSPITALITY

-(P) PRIMARY CAVE

SULLIES - PROVIDED BY

CO., DATED 9-1-2021

-EPHEMERAL STREAMS -

·YINEYARD BLOCK (TYP), FROM APPROVED VECP PI9-00080

SOL ECOLOGY INC, SONOMA

PROYIDED BY SOL ECOLOGY INC,

SONOMA CO., DATED 9-1-2021

SPOILS PLACEMENT AREA

PER VECP PI9-00080 TO BE INSTALLED

-PURPLE NEEDLEGRASS RE-ESTABLISHMENT AREA

FOLLOWING TO WINERY EARTHWORKS COMPLETION

P) 60,000 GALLON WINERY

FIRE WATER STORAGE

(P) 10,000 GALLON TREATED

PROCESS WASTEWATER FOR

-WELL DRILLING

RESTRICTED AREA

BLOCK B

PER 1312 OR 138

300' RADII

IRRIGATION STORAGE

(P) BIOFILTRO WORM BED

CONTAINER (19'2" x 7'4")

LANDS OF MININGER

AND BACHICH

3,193 SF, ALTERNATIVE

AREA UNDER BLOCK B

SPOILS PLACEMENT

LANDS OF WOOLLS RANCH

APN: 035-010-054

GRAPHIC SCALE

(IN FEET)

1 inch = 200 FT

APN: 034-270-036

-(2) VINEYARD

IRRIGATION TANKS

PLANS BY OTHERS

PER VECP IRRIGATION

LANDS OF JINKS

APN: 034-270-035

LANDS OF BURRY

APN: 034-270-026

LANDS OF KASTNER

APN: 035-010-001

LANDS OF CUVAISON

APN: 034-230-028

PPROXIMATE

LOCATION 40' EASEMENT

PARCEL #3

1998-027369

APPROXIMATE

40' EASEMENT

LOCATION

PARCEL #2

1998-027369

(P) UPGRADED

DRIVEWAY

-PICKLE

CREEK

40' EASEMENT LOCATION IS

BASED UPON OCCUPATIONAL

-10' EASEMENT

CENTERLINE PARCEL #2

BLOCK

LANDS OF PECK

APN: 034-230-007

EPHEMERAL STREAMS .

ECOLOGY INC, SONOMA CO.,

(P) REPLACEMENT

HATCHED AREAS

OF WORK WITHIN

SETBACKS, TYPICAL-

PROYIDED BY SOL

DATED 9-1-2021-

ABBREVIATIONS

AREA DRAIN

AGGREGATE BASE ASPHALT CONCRETE ARCHITECT BENCHMARK CENTERLINE CORRUGATED METAL PIPE CLEANOUT CONFORM DRAIN INLET DUCTILE IRON PIPE DOWNSPOUT EXISTING GRADE EDGE OF PAVEMENT FINISH FLOOR FLOW LINE GRADE BREAK INVERT IRON PIPE

JOINT POLE MANHOLE PORTLAND CEMENT CONCRETE

PACIFIC GAS AND ELECTRIC POST INDICATOR VALVE PROPOSED POLYVINYL CHLORIDE REINFORCED CONCRETE PIPE SLOPE (FEET/FOOT) SEE ARCHITECTURAL DRAWINGS

SEE STRUCTURAL DRAWING

EARTHWORK NOTES

STANDARD

STD

ALL QUANTITIES SHOWN ON THIS PLAN ARE APPROXIMATE, CALCULATED EXCESS AND SHORTAGE ARE TO FINISHED GRADE AND EXISTING GROUND. THE ACTUAL AMOUNT OF EARTH MOVED WILL VARY, DEPENDENT ON COMPACTION, CONSOLIDATION, STRIPPING REQUIREMENTS, AND THE CONTRACTOR'S METHOD OF OPERATION. DUE TO THE INEXACT NATURE OF EARTHWORK ESTIMATING, THERE IS NO GUARANTEE OF

NO ASSUMPTIONS ARE MADE FOR UTILITY TRENCHES, STRUCTURAL FOOTINGS, BULKING COMPACTION, OR CONSOLIDATION. CONTRACTOR SHALL MAKE HIS OWN ASSUMPTIONS FOR BID AND CONTRACT PURPOSES.

THESE QUANTITIES. CONTRACTOR SHALL MAKE HIS OWN ESTIMATE FOR BID AND

LEGEND

TREE (AS NOTED)

FLOWLINE

WIRE FENCE

TOE OF BANK

TOP OF BANK

GRADEBREAK

EDGE OF ROAD

OVERHEAD UTILITY LINES

UTILITY POLE (AS NOTED)


SURVEY CONTROL STATION (AS NOTED)

SEE GEOTECHNICAL REPORT FOR ADDITIONAL EXCAVATION AND GRADING REQUIREMENTS.

EARTHWORKS ESTIMATE		
	CUT (CY)	FILL (CY)
CAVE	8,700	-
WINERY & NEW ROAD WITH PARKING	3,440	10,965
TURNOUTS & WIDENING (E) ROAD	1,755	50
SPOILS PLACEMENT IN VINEYARD BLOCK B	la le la la	2,880
* NET	13.895	13.895

* EARTHWORKS BALANCE ON-SITE, NO OFF-HAUL REQUIRED.

#	GROUND	GROUND	ELEVATION	DESCRIPTION
	NORTHING	EASTING	4-1101	
1	1001000.13	6454202.00	677.18'	SET RBR NE.20' PP W/TRANS
2	1886398.90	6454560.04	680.69'	SET RBR HILLSIDE
3	1885715.54	6453897.12	4 5.03'	SET MAG W.EP MT VEEDER RD
4	1887434.29	6454277.33	716.21	SET RBR N. ERD GVL
5	1887014.65	6453991.78	640.40'	SET RBR W. SHOULDER GVL D/W
6	1887596.41	6454357.58	733.101	SET 90D NE GVL D/W INT
7	1887153.79	6453861.23	616.40'	SET 90D SW ERD GVL PCC
8	1887428.02	6454001.47	580.II'	SET 90D E'LY 6.0 GVL D/W
9	1887753.16	6453843.01	557.631	SET 90D E 5.0 TOP CUT
10	1887967.54	6453646.34	524.24'	SET MAG NW EP HAIRPIN TURN D/W
11	1886815.73	6454558.61	702.41'	SET 90D HILLTOP
12	1887137.39	6454475.29	740.33'	SET 90D BACKYARD HOMESITE
13	1886972.12	6454630.92	718.62	SET 90D E. EDGE HILLSIDE
14	1887198.91	6454550.62	734.201	SET 90D SE HSE
15	1887264.91	6454530.17	735.581	SET 90D NE HSE
16	1888081.24	6454227.76	774.39'	SET 90D S'LY D/W FORK
61	1888176.24	6453489.36	483.50'	SET MAG E.EP MT VEEDER RD
62	1887585.80	6453509.97	459.65'	SET RBR SHOULDER E. MT VEEDER
63	1887413.67	6453362.20	448.71	SET RBR TURNOUT W. MT VEEDER
64	1887803.83	6453522.56	470.431	SET 90D E. MT VEEDER
65	1887345.34	6453455.15	457.34'	SET 90D S. EP D/W
66	1887632.33	6453664.68	497.75'	SET 90D E. 6.5 TOP D/W CUT
67	1887841.19	6453718.18	511.44'	SET 90D E. ERD GVL
70	1887486.14	6453558.53	476.45'	SET 90D W. ERD GVL

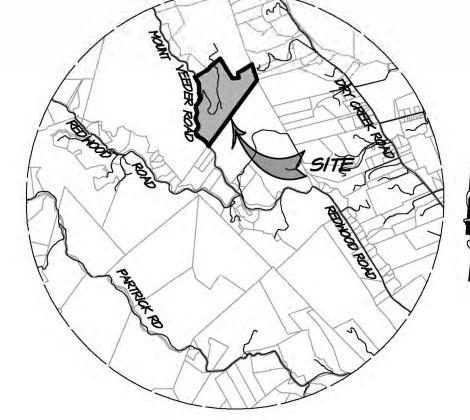

VICINITY MAP

PROJECT INFORMATION

P&M VINEYARDS HOLDINGS, LLC MAILING ADDRESS: SEBASTOPOL, CA 95473 1300 MOUNT VEEDER ROAD SITE ADDRESS: NAPA, CA 94558

CIYIL ENGINEER: 1515 FOURTH STREET

NAPA, CA 94559

15,023 SF (1.12 ACRES)

034-230-029 (II5.27 ACRES)

TOPOGRAPHY NOTES

FADED BACKGROUND REPRESENTS EXISTING TOPOGRAPHIC FEATURES. TOPOGRAPHIC INFORMATION WAS TAKEN FROM THE "TOPOGRAPHIC MAP OF A PORTION OF THE LANDS OF P&M VINEYARDS HOLDINGS LLC A.P.N. 034-230-029 NAPA COUNTY, CALIFORNIA" PREPARED BY RSA* APRIL, 2021.

DISTURBED AREA:

- HORIZONTAL DATUM: NORTH AMERICAN DATUM OF 1983 (NAD83) 2011 EPOCH BASED UPON G.P.S. OBSERVATIONS ON NETWORK UTILIZING CONTINUALLY OPERATING REFERENCE STATION (C.O.R.S.) INFORMATION FROM THE CALIFORNIA SPATIAL REFERENCE CENTER
- VERTICAL DATUM: NORTH AMERICAN VERTICAL DATUM OF 1988
- 3. CONTOURS ARE SHOWN EVERY ONE FOOT (1"), HIGHLIGHTED EVERY FIVE FEET (5").

SUPPLEMENTAL TOPOGRAPHIC INFORMATION SHOWN HERE IS BASED UPON A FIELD TOPOGRAPHIC SURVEY PREPARED BY MUNGELLE CIVIL ENGINEERING ON JULY 7, 2015.


- THE LOCATION OF ANY UNDERGROUND STRUCTURES AND UTILITIES SHOWN HEREON HAVE BEEN DETERMINED FROM PHYSICAL FEATURES OBSERVED AT THE TIME OF THE SURVEY. THE SURVEYOR ACCEPTS NO LIABILITY FOR THE LOCATION, EXISTENCE, OR NON-EXISTENCE OF THOSE UNDERGROUND STRUCTURES, UTILITY LINES, AND RELATED APPURTENANCES. ANY INDIVIDUAL, COMPANY, OR AGENCY USING THIS MAP MUST CONFIRM THE LOCATION OF ALL UNDERGROUND LINES OR STRUCTURES PRIOR TO COMMENCING ANY EXCAYATION. LOCATION OF UNDERGROUND UTILITIES SHALL BE PERFORMED BY A SUBSURFACE UTILITY LOCATING COMPANY (IF DESIRED).
- 2. THE CONTENT OF THIS MAP WAS DEFINED BY CONTRACT AT THE SPECIFIC REQUEST OF THE CLIENT(S) AND/OR THEIR CONSULTANT(S). THE SURVEYOR ACCEPTS NO LIABILITY FOR USE OF THIS MAP BY ANY ONE OTHER THAN THE CLIENT(S) AND/OR CONSULTANTS FOR WHOM IT WAS PREPARED.
- RECORD BOUNDARY LINES SHOWN HEREON ARE DELINEATED FROM RECORD DATA ONLY AND DO NOT CONSTITUTE A BOUNDARY SURVEY. THE PERFORMANCE OF A BOUNDARY SURVEY AND THE ANALYSIS OF LEGAL DESCRIPTIONS PERTAINING TO THE LANDS DEPICTED HEREIN WOULD BE REQUIRED IF PRECISE PROPERTY LOCATION AND BOUNDARY LIMITS ARE NEEDED OR DESIRED. NO LIABILITY IS ASSUMED FOR THE ACCURACY OF THE PROPERTY DATA DELINEATED HEREON.
- BASIS OF BEARING: N35°21'00"E BETWEEN A FOUND T-BAR TAGGED "LS 3137" AND A 34" OAK WITH TAG "LS 3137", AS SHOWN ON THE PARCEL MAP RECORDED IN BOOK 13 OF PARCEL MAPS, AT PAGES 69-11, NAPA COUNTY RECORDS.
- ELEVATIONS SHOWN HEREON ARE ON AN ASSUMED DATUM. BENCHMARK CONTROL POINT #6, A SET 60D. ELEVATION: 930.10'

BOUNDARY NOTES

BOUNDARY SHOWN IS RECORD INFORMATION PER THE GRANT DEED RECORDED AS DOCUMENT NUMBER 2015-0018227, NAPA COUNTY RECORDS.

CLIEFT INDEV

SHEET INDEX		
UPI.O	COVER SHEET	
UP2.0	WINERY LAYOUT	
UP2.1	SLOPE ANALYSIS	
UP2.2	COVERAGE AND DEVELOPMENT	
UP2.3	TREE CANOPY COVERAGE	
UP2.4	CONSTRAINTS MAP	
UP3.0	HILLSIDE GRADING PLAN	
UP4.0	UTILITY PLAN	
UP5.0-UP5.5	DRIVEWAY SHEETS	
UP6.0	FIRE TRUCK PLAN: STA 6+50 - 10+00	

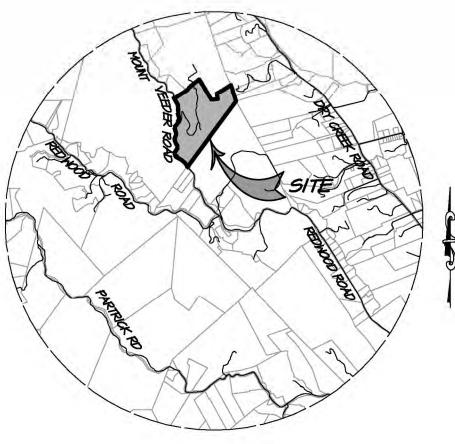


JUNE 23, 2023


DESIGNED CHECKED BWF JOB NO. 4121017.0

Printed on Recycled Paper Please Continue the Cycle

SITE PLAN

SCALE: I" = 200'

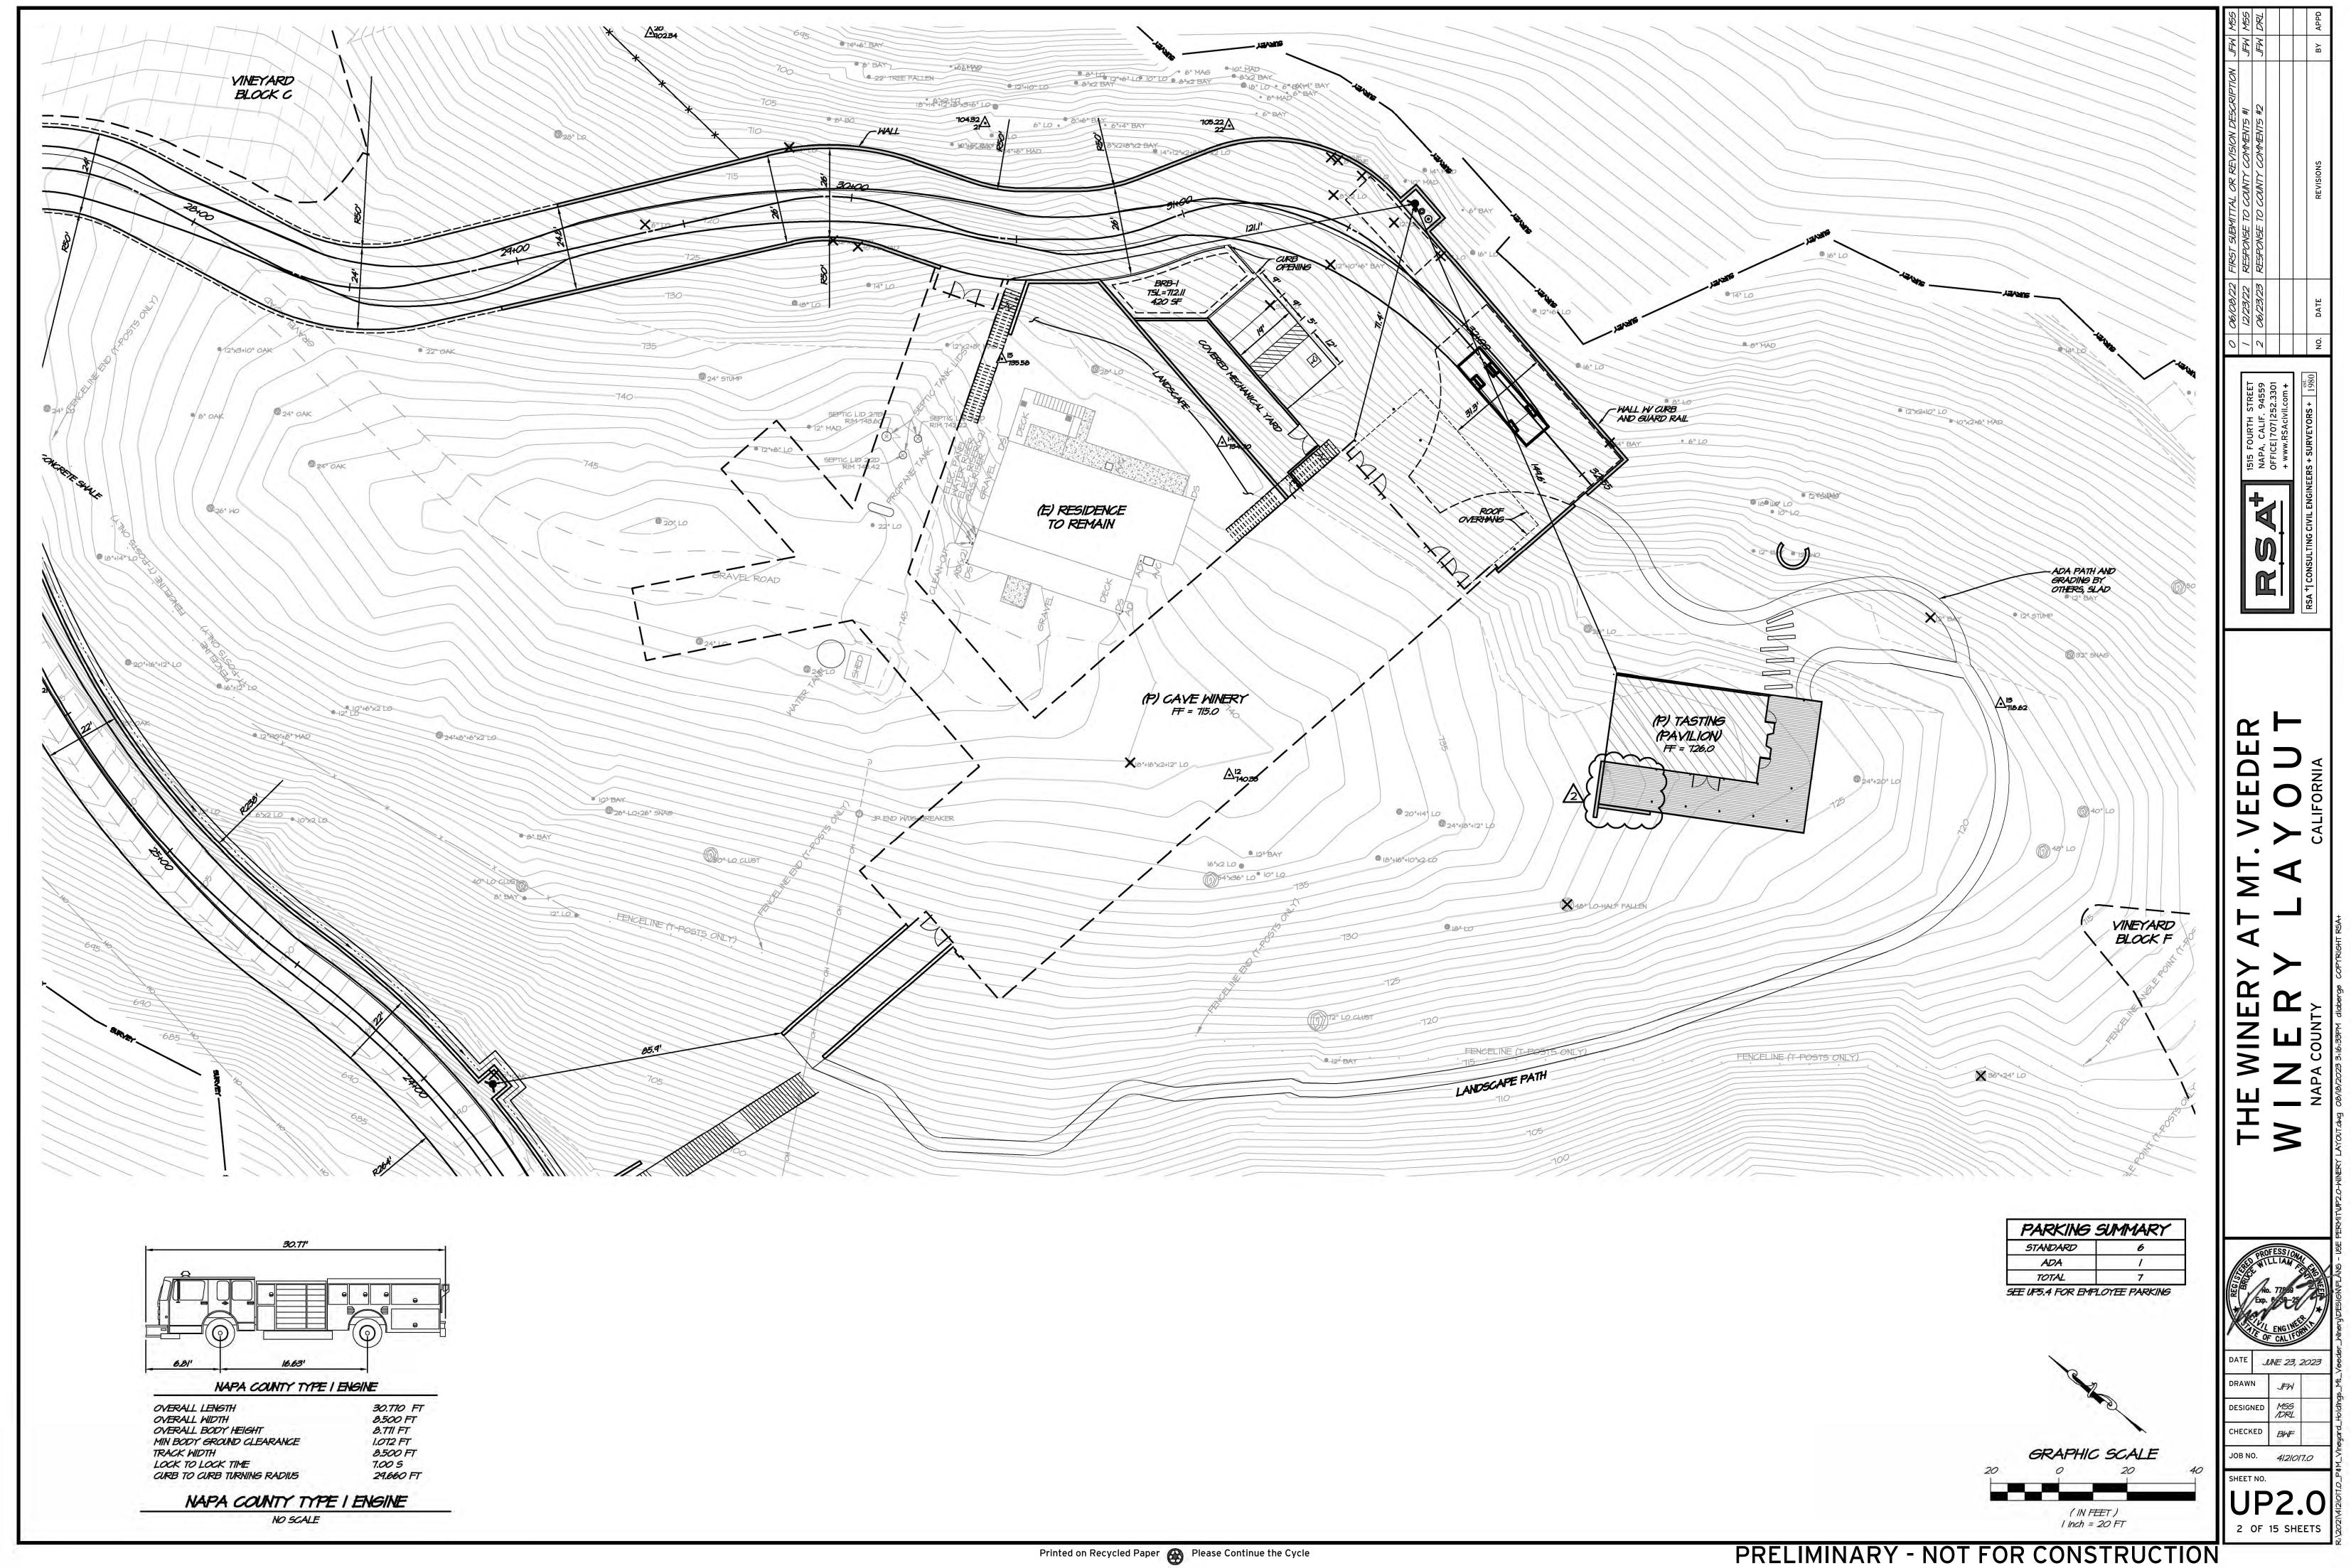

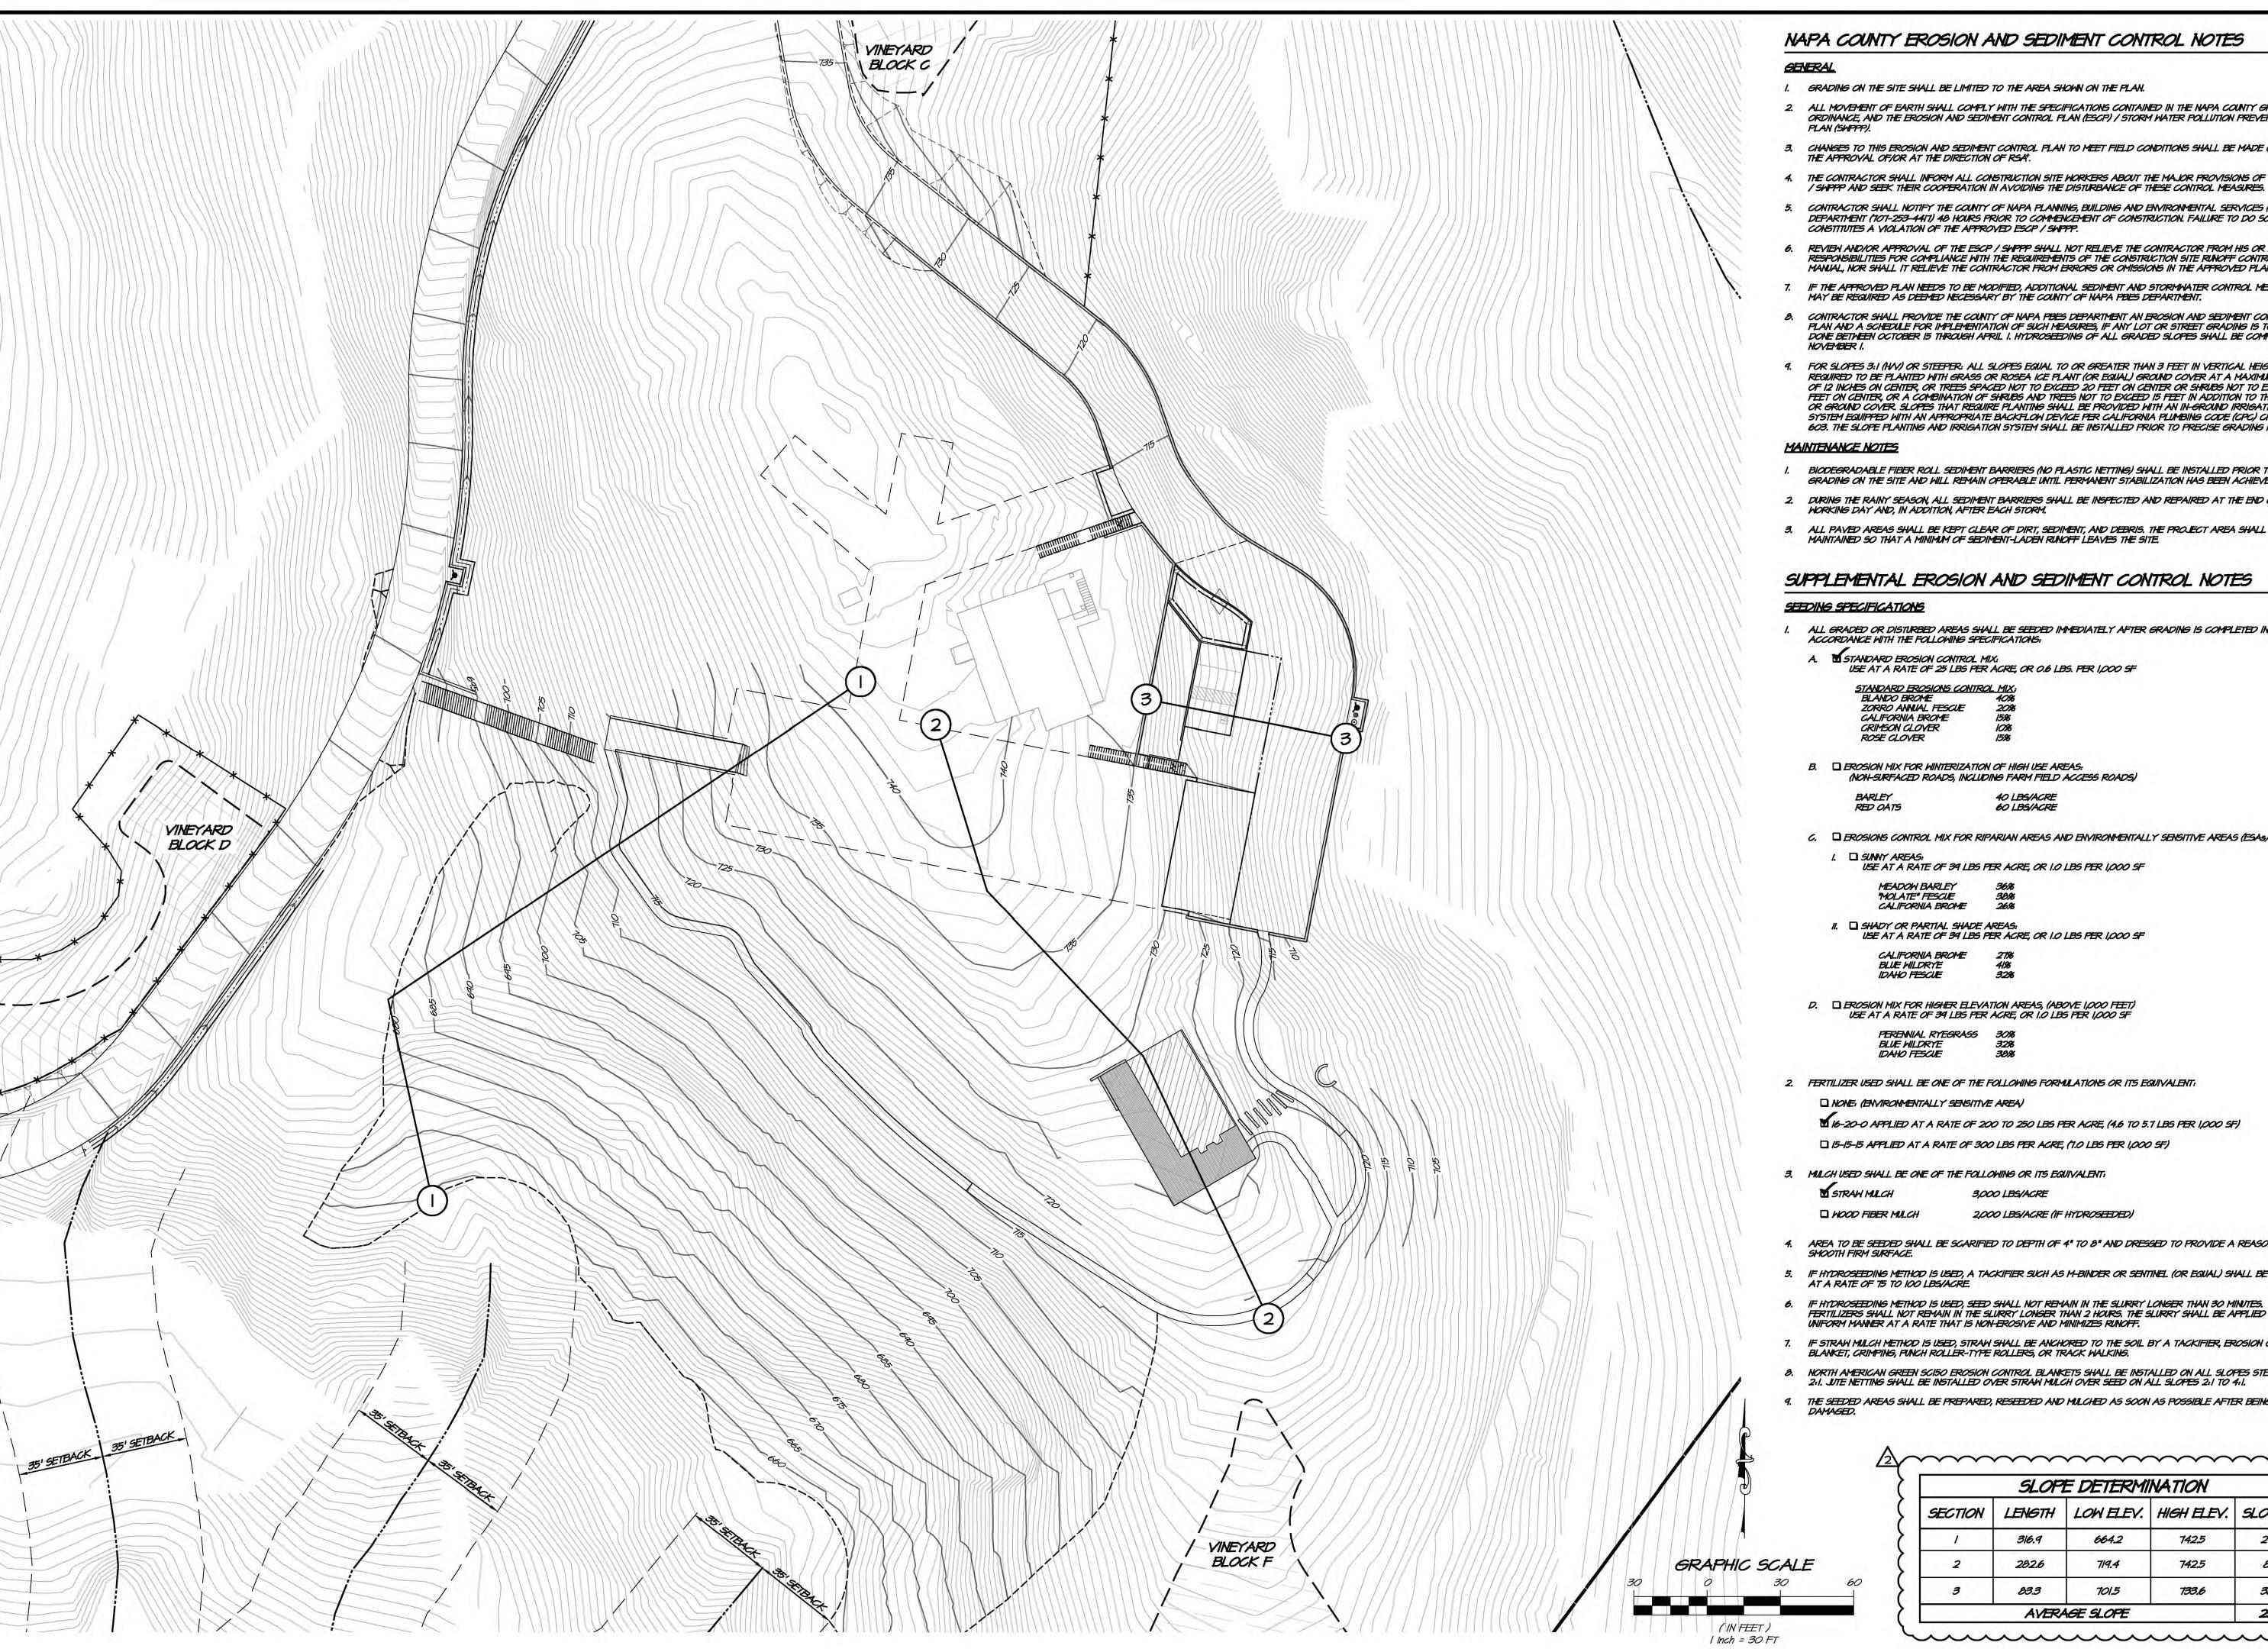

NAPA COUNTY EROSION AND SEDIMENT CONTROL NOTES

- I. GRADING ON THE SITE SHALL BE LIMITED TO THE AREA SHOWN ON THE PLAN.
- 2. ALL MOVEMENT OF EARTH SHALL COMPLY WITH THE SPECIFICATIONS CONTAINED IN THE NAPA COUNTY GRADING ORDINANCE, AND THE EROSION AND SEDIMENT CONTROL PLAN (ESCP) / STORM WATER POLLUTION PREVENTION
- 3. CHANGES TO THIS EROSION AND SEDIMENT CONTROL PLAN TO MEET FIELD CONDITIONS SHALL BE MADE ONLY WITH THE APPROVAL OF/OR AT THE DIRECTION OF RSA.
- 4. THE CONTRACTOR SHALL INFORM ALL CONSTRUCTION SITE WORKERS ABOUT THE MAJOR PROVISIONS OF THE ESCP
- CONTRACTOR SHALL NOTIFY THE COUNTY OF NAPA PLANNING, BUILDING AND ENVIRONMENTAL SERVICES (PBES) DEPARTMENT (101-253-44/1) 48 HOURS PRIOR TO COMMENCEMENT OF CONSTRUCTION. FAILURE TO DO SO CONSTITUTES A VIOLATION OF THE APPROVED ESCP / SWPPP.
- 6. REVIEW AND/OR APPROVAL OF THE ESCP / SWPPP SHALL NOT RELIEVE THE CONTRACTOR FROM HIS OR HER RESPONSIBILITIES FOR COMPLIANCE WITH THE REQUIREMENTS OF THE CONSTRUCTION SITE RUNOFF CONTROL MANUAL, NOR SHALL IT RELIEVE THE CONTRACTOR FROM ERRORS OR OMISSIONS IN THE APPROVED PLAN.
- IF THE APPROVED PLAN NEEDS TO BE MODIFIED, ADDITIONAL SEDIMENT AND STORMWATER CONTROL MEASURES MAY BE REQUIRED AS DEEMED NECESSARY BY THE COUNTY OF NAPA PBES DEPARTMENT.
- 8. CONTRACTOR SHALL PROVIDE THE COUNTY OF NAPA PBES DEPARTMENT AN EROSION AND SEDIMENT CONTROL PLAN AND A SCHEDULE FOR IMPLEMENTATION OF SUCH MEASURES, IF ANY LOT OR STREET GRADING IS TO BE DONE BETWEEN OCTOBER IS THROUGH APRIL I. HYDROSEEDING OF ALL GRADED SLOPES SHALL BE COMPLETED BY
- FOR SLOPES 3:1 (HVV) OR STEEPER: ALL SLOPES EQUAL TO OR GREATER THAN 3 FEET IN VERTICAL HEIGHT ARE REQUIRED TO BE PLANTED WITH GRASS OR ROSEA ICE PLANT (OR EQUAL) GROUND COVER AT A MAXIMUM SPACING OF 12 INCHES ON CENTER, OR TREES SPACED NOT TO EXCEED 20 FEET ON CENTER OR SHRUBS NOT TO EXCEED 10 FEET ON CENTER, OR A COMBINATION OF SHRUBS AND TREES NOT TO EXCEED 15 FEET IN ADDITION TO THE GRASS OR GROUND COVER, SLOPES THAT REQUIRE PLANTING SHALL BE PROVIDED WITH AN IN-GROUND IRRIGATION SYSTEM EQUIPPED WITH AN APPROPRIATE BACKFLOW DEVICE PER CALIFORNIA PLUMBING CODE (CPC) CHAPTER 603. THE SLOPE PLANTING AND IRRIGATION SYSTEM SHALL BE INSTALLED PRIOR TO PRECISE GRADING FINAL.

- BIODESRADABLE FIBER ROLL SEDIMENT BARRIERS (NO PLASTIC NETTING) SHALL BE INSTALLED PRIOR TO ANY GRADING ON THE SITE AND WILL REMAIN OPERABLE UNTIL PERMANENT STABILIZATION HAS BEEN ACHIEVED.
- 2. DURING THE RAINY SEASON, ALL SEDIMENT BARRIERS SHALL BE INSPECTED AND REPAIRED AT THE END OF EACH
- 3. ALL PAVED AREAS SHALL BE KEPT CLEAR OF DIRT, SEDIMENT, AND DEBRIS. THE PROJECT AREA SHALL BE MAINTAINED SO THAT A MINIMUM OF SEDIMENT-LADEN RUNOFF LEAVES THE SITE.

SUPPLEMENTAL EROSION AND SEDIMENT CONTROL NOTES

SEEDING SPECIFICATIONS

- ALL GRADED OR DISTURBED AREAS SHALL BE SEEDED IMMEDIATELY AFTER GRADING IS COMPLETED IN ACCORDANCE WITH THE FOLLOWING SPECIFICATIONS:
- A. STANDARD EROSION CONTROL MIX: USE AT A RATE OF 25 LBS PER ACRE, OR O.6 LBS. PER I,000 SF

ZORRO ANNUAL FESCUE CALIFORNIA BROME CRIMSON CLOYER ROSE CLOVER

B. DEROSION MIX FOR WINTERIZATION OF HIGH USE AREAS: (NON-SURFACED ROADS, INCLUDING FARM FIELD ACCESS ROADS)

> RED OATS 60 LBS/ACRE

- C. DEROSIONS CONTROL MIX FOR RIPARIAN AREAS AND ENVIRONMENTALLY SENSITIVE AREAS (ESAS).
- I. SUNNY AREAS; USE AT A RATE OF 39 LBS PER ACRE, OR I.O LBS PER I,000 SF

"MOLATE" FESCUE CALIFORNIA BROME

II. SHADY OR PARTIAL SHADE AREAS: USE AT A RATE OF 34 LBS PER ACRE, OR I.O LBS PER I,000 SF

> CALIFORNIA BROME BLUE WILDRYE

D. DEROSION MIX FOR HIGHER ELEVATION AREAS, (ABOVE 1,000 FEET) USE AT A RATE OF 39 LBS PER ACRE, OR 1.0 LBS PER 1,000 SF

BLUE WILDRYE

2. FERTILIZER USED SHALL BE ONE OF THE FOLLOWING FORMULATIONS OR ITS EQUIVALENT:

☐ NONE: (ENVIRONMENTALLY SENSITIVE AREA)

16-20-0 APPLIED AT A RATE OF 200 TO 250 LBS PER ACRE, (4.6 TO 5.7 LBS PER 1,000 SF)

3. MULCH USED SHALL BE ONE OF THE FOLLOWING OR ITS EQUIVALENT:

M STRAW MULCH 3,000 LBS/ACRE 2,000 LBS/ACRE (IF HYDROSEEDED)

- 4. AREA TO BE SEEDED SHALL BE SCARIFIED TO DEPTH OF 4" TO 8" AND DRESSED TO PROVIDE A REASONABLY
- 5. IF HYDROSEEDING METHOD IS USED, A TACKIFIER SUCH AS M-BINDER OR SENTINEL (OR EQUAL) SHALL BE APPLIED AT A RATE OF 15 TO 100 LBS/ACRE.
- 6. IF HYDROSEEDING METHOD IS USED, SEED SHALL NOT REMAIN IN THE SLURRY LONGER THAN 30 MINUTES. FERTILIZERS SHALL NOT REMAIN IN THE SLURRY LONGER THAN 2 HOURS, THE SLURRY SHALL BE APPLIED IN A UNIFORM MANNER AT A RATE THAT IS NON-EROSIVE AND MINIMIZES RUNOFF.
- 7. IF STRAW MULCH METHOD IS USED, STRAW SHALL BE ANCHORED TO THE SOIL BY A TACKIFIER, EROSION CONTROL BLANKET, CRIMPING, PUNCH ROLLER-TYPE ROLLERS, OR TRACK WALKING.
- 6. NORTH AMERICAN GREEN SCI50 EROSION CONTROL BLANKETS SHALL BE INSTALLED ON ALL SLOPES STEEPER THAN 2:1. JUTE NETTING SHALL BE INSTALLED OVER STRAW MULCH OVER SEED ON ALL SLOPES 2:1 TO 4:1.
- THE SEEDED AREAS SHALL BE PREPARED, RESEEDED AND MULCHED AS SOON AS POSSIBLE AFTER BEING

	SLOP	E DETERMI	NATION	
SECTION	LENGTH	LOW ELEV.	HIGH ELEV.	SLOPE %
1	316.9	664.2	742.5	24.7
2	282.6	719.4	742.5	8.2
3	83.3	701.5	733.6	38.5
7	AVERA	AGE SLOPE		23.8


DESIGNED CHECKED


Printed on Recycled Paper Please Continue the Cycle

PRELIMINARY - NOT FOR CONSTRUCTION


JUNE 23, 202


3 OF 15 SHEETS

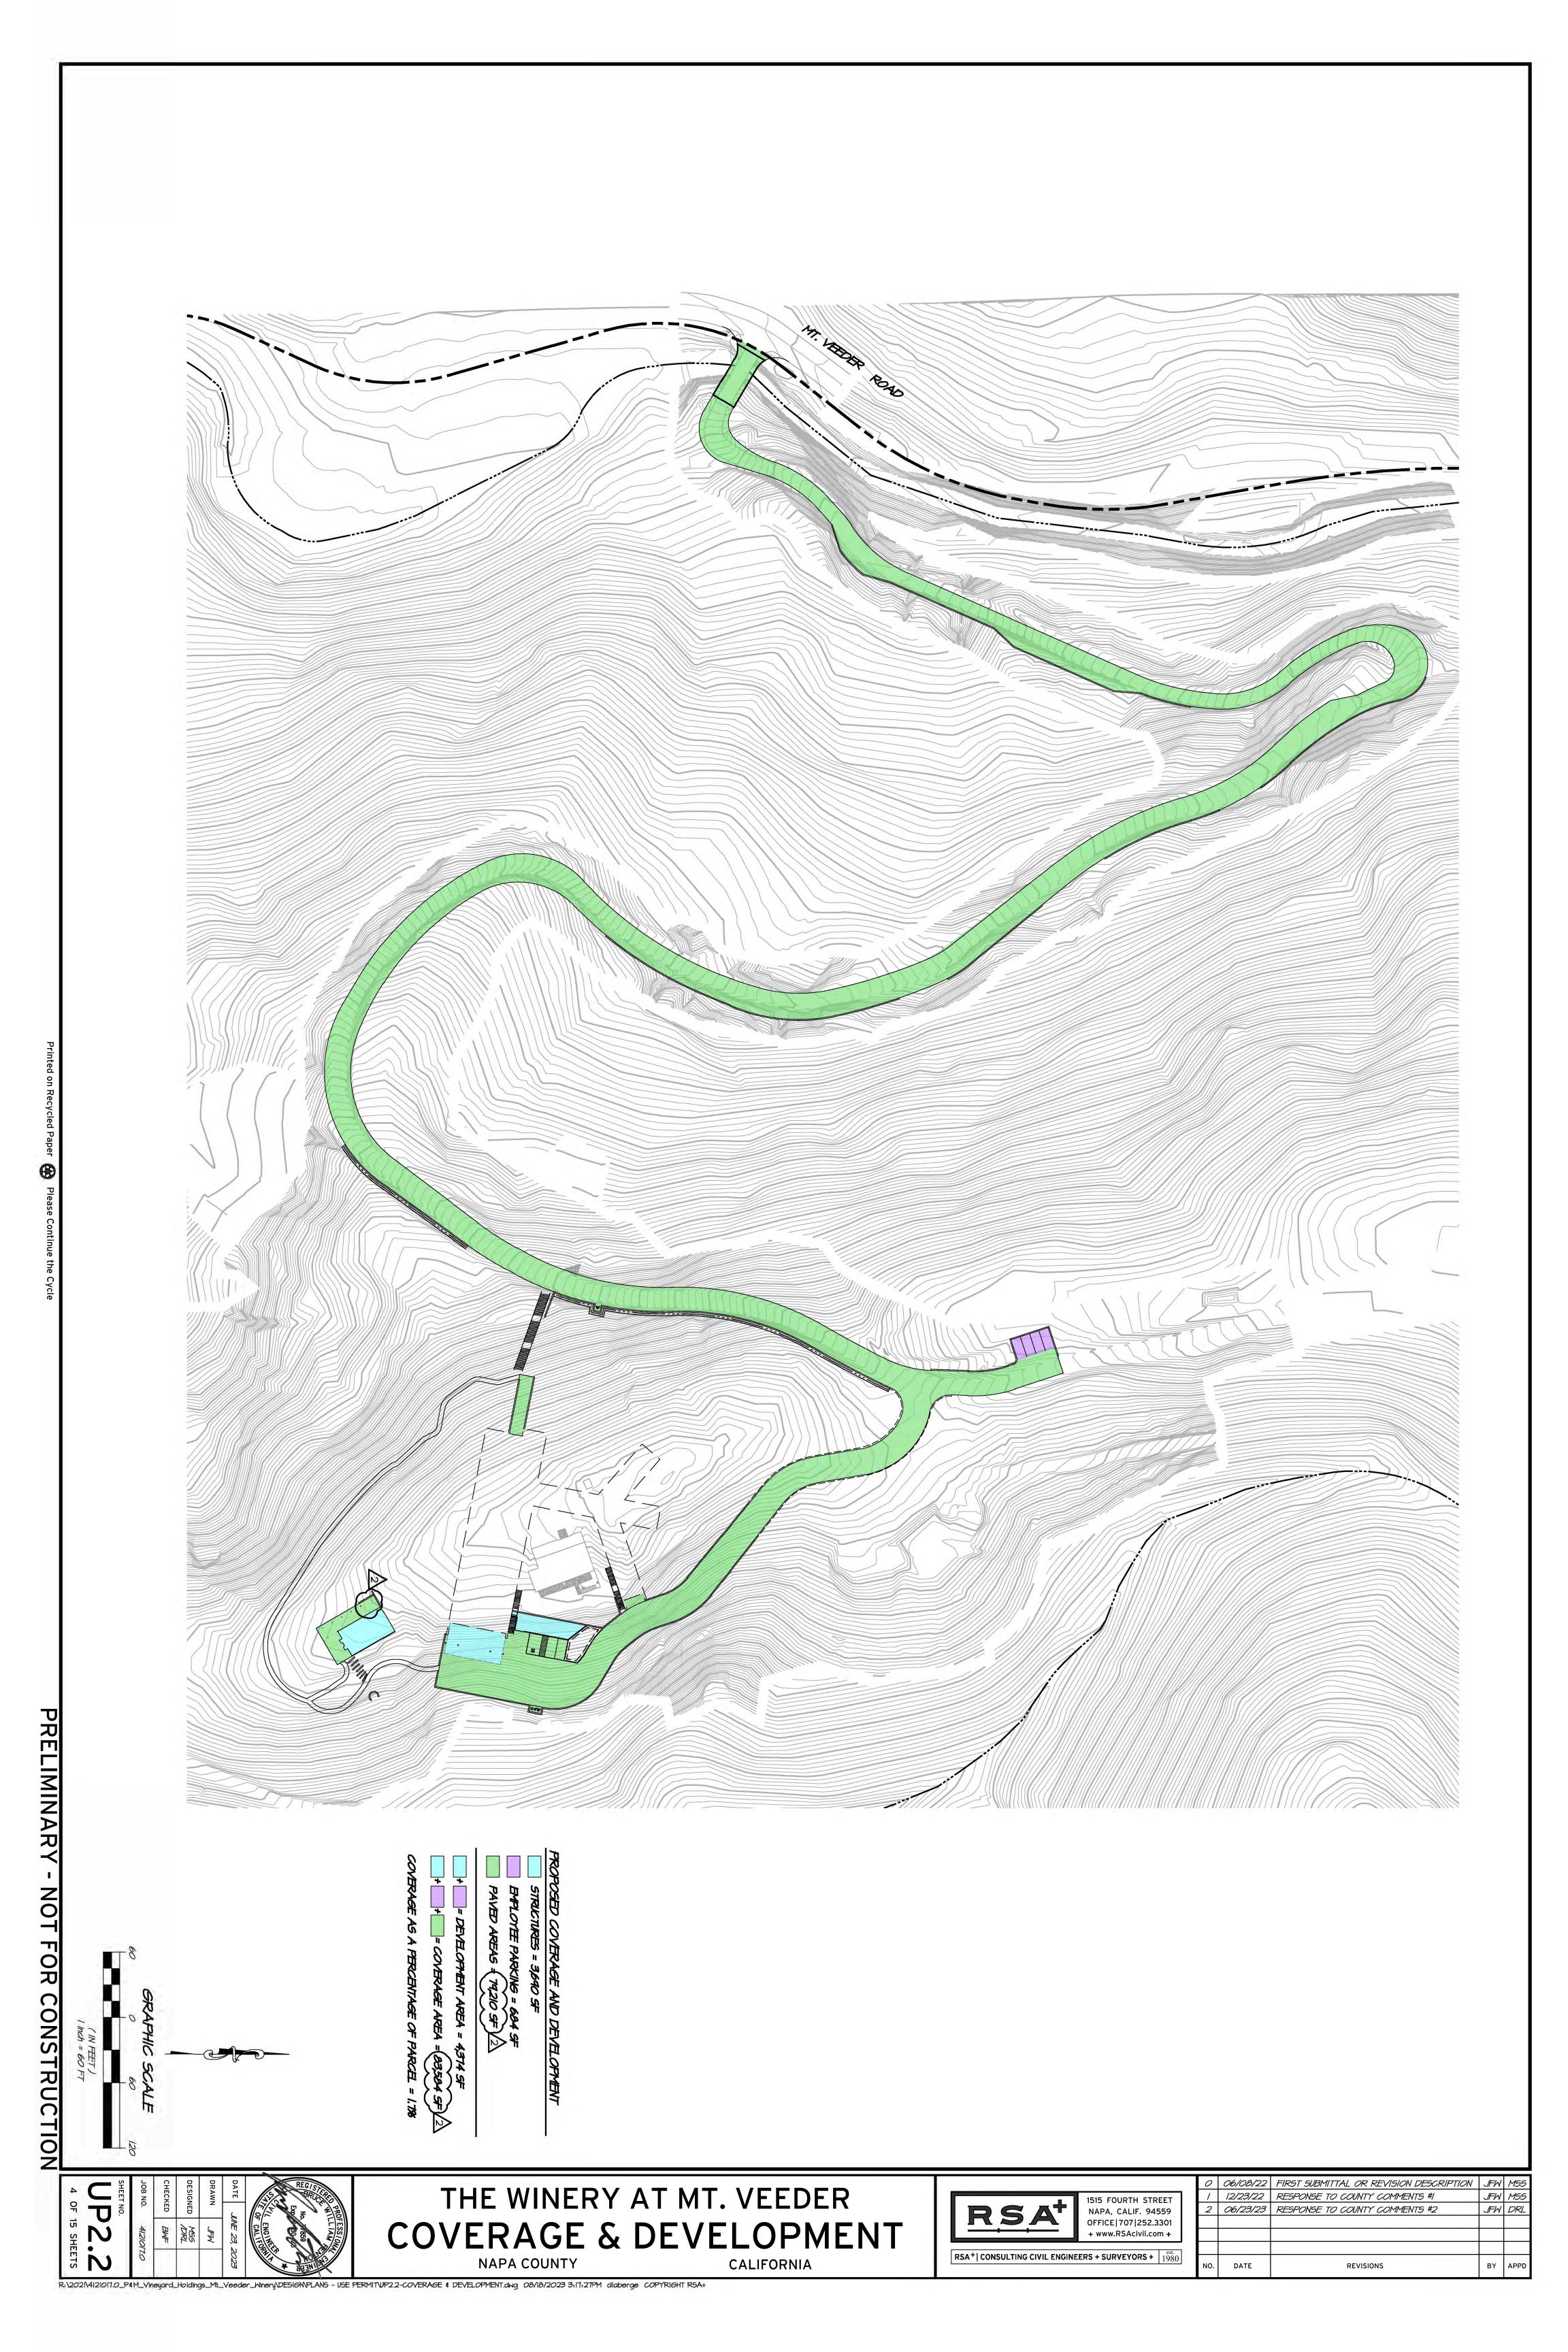


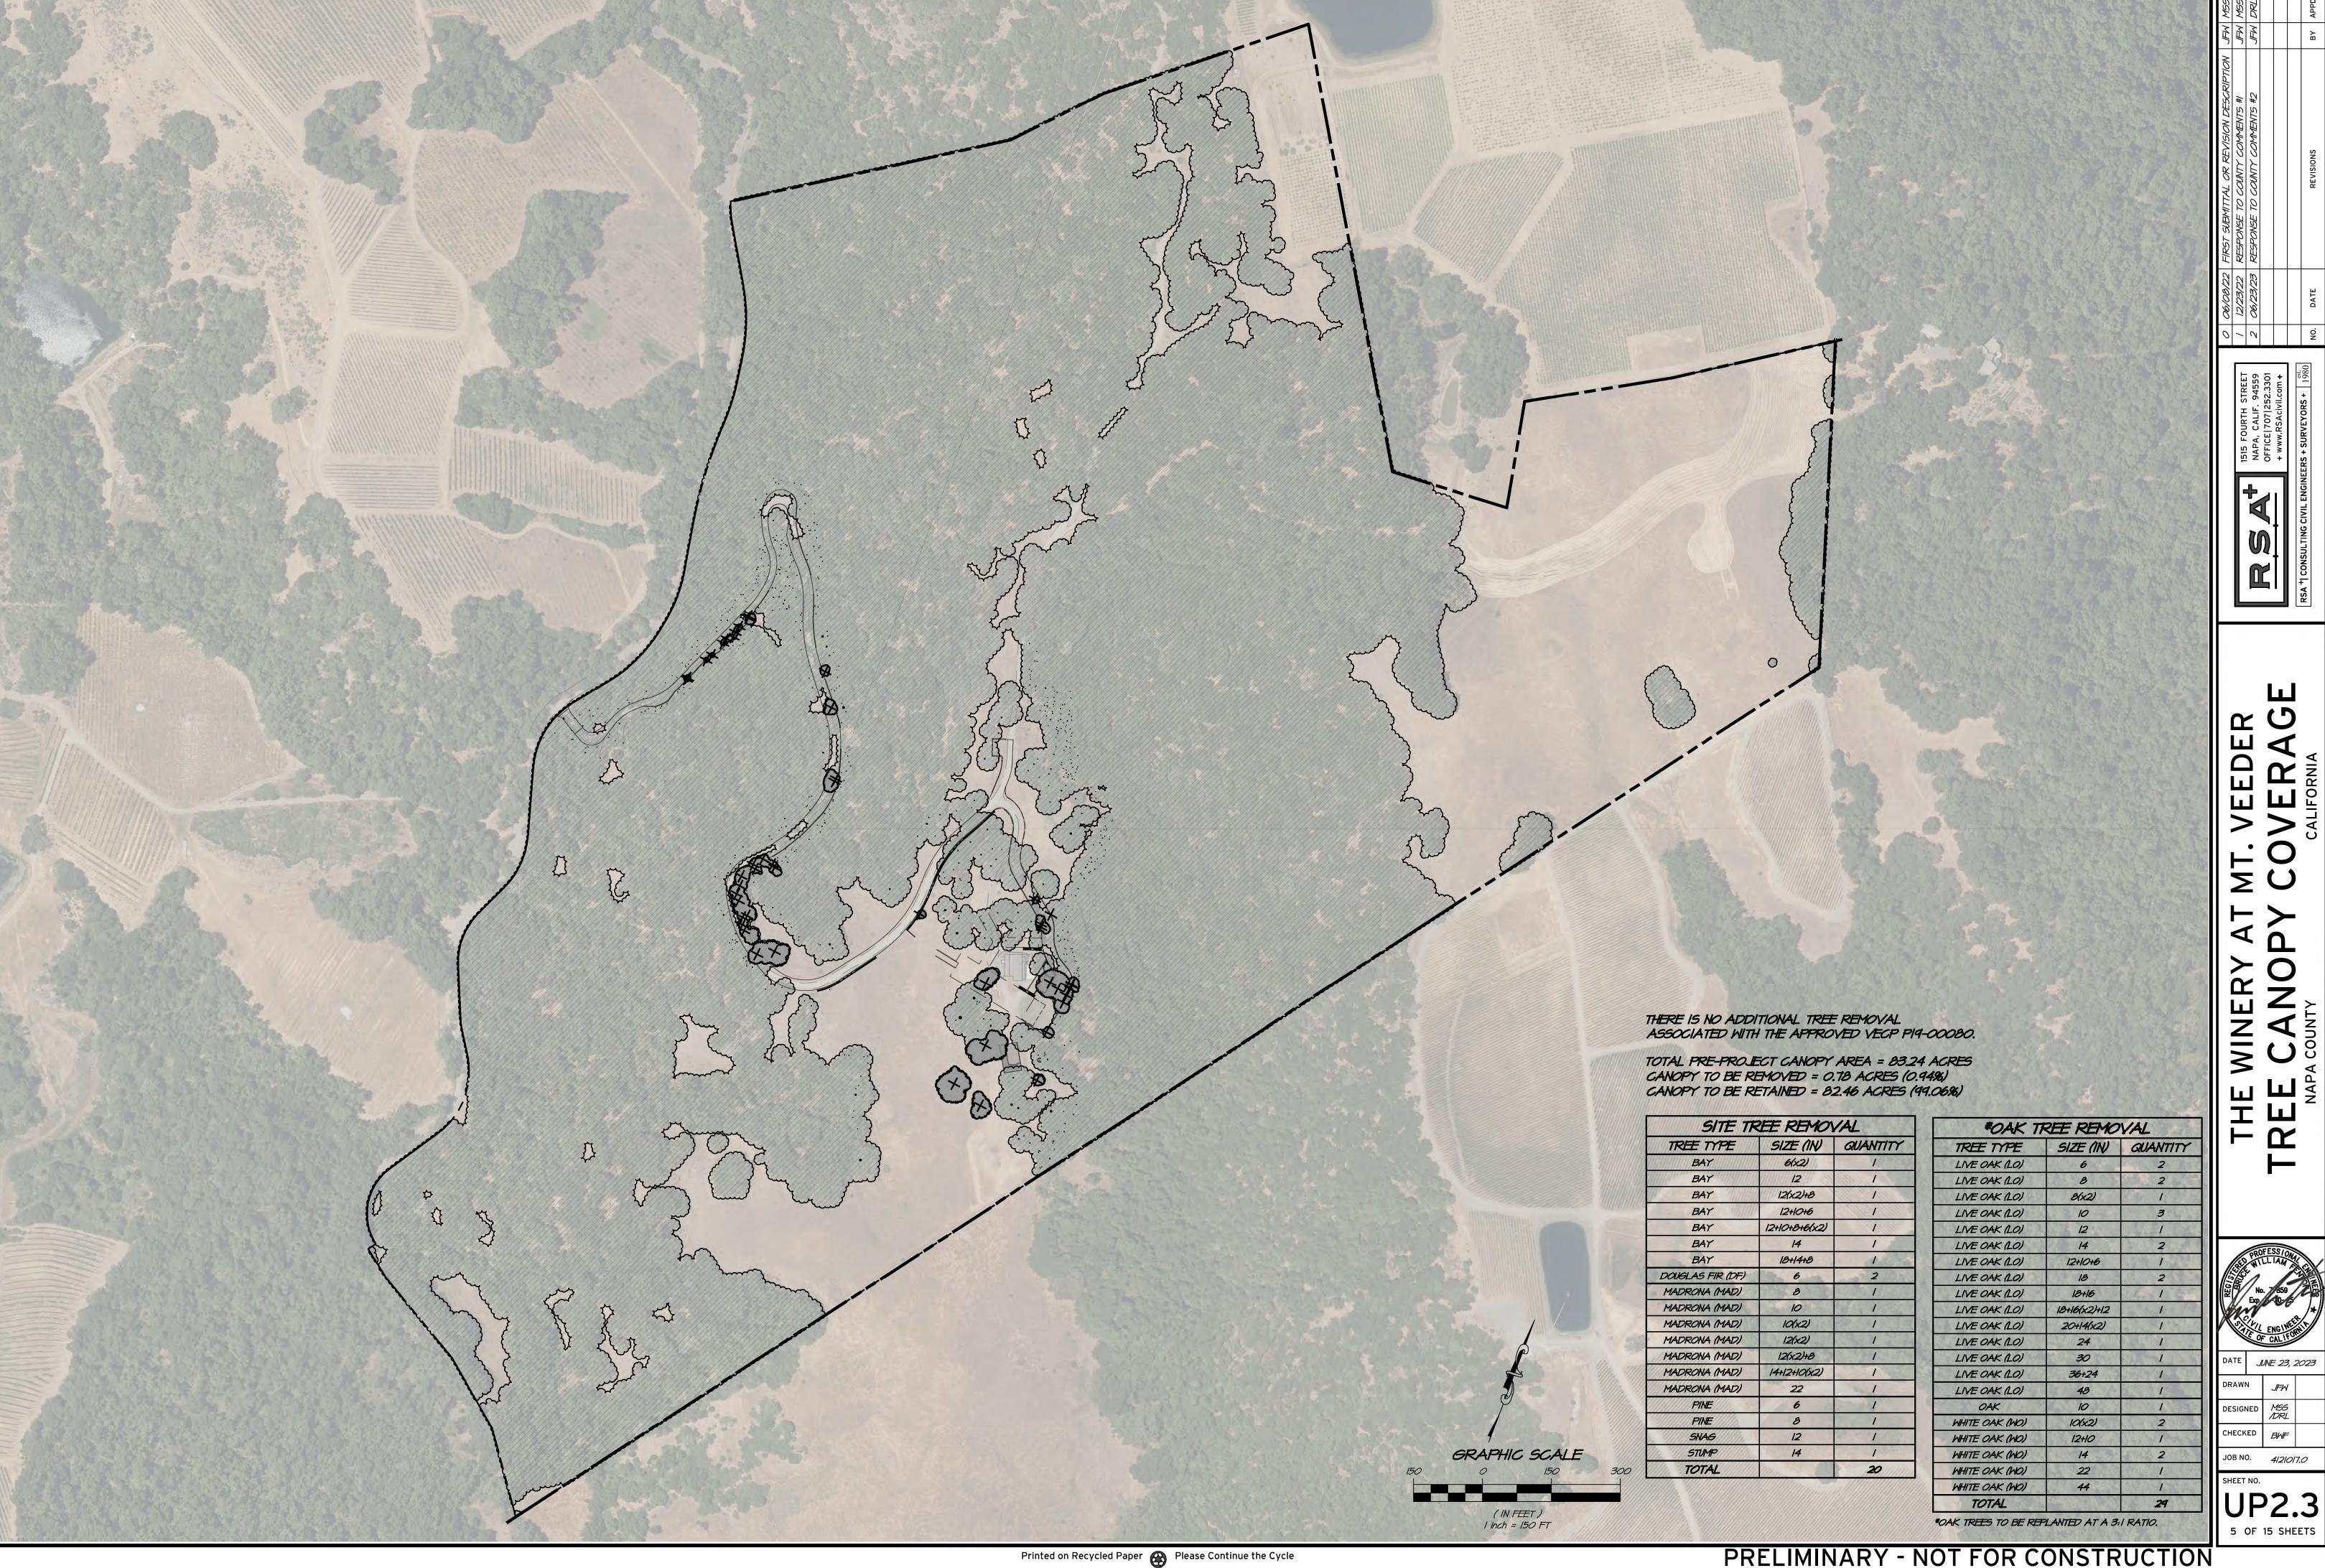



PRELIMINARY - NOT FOR CONSTRUCTION

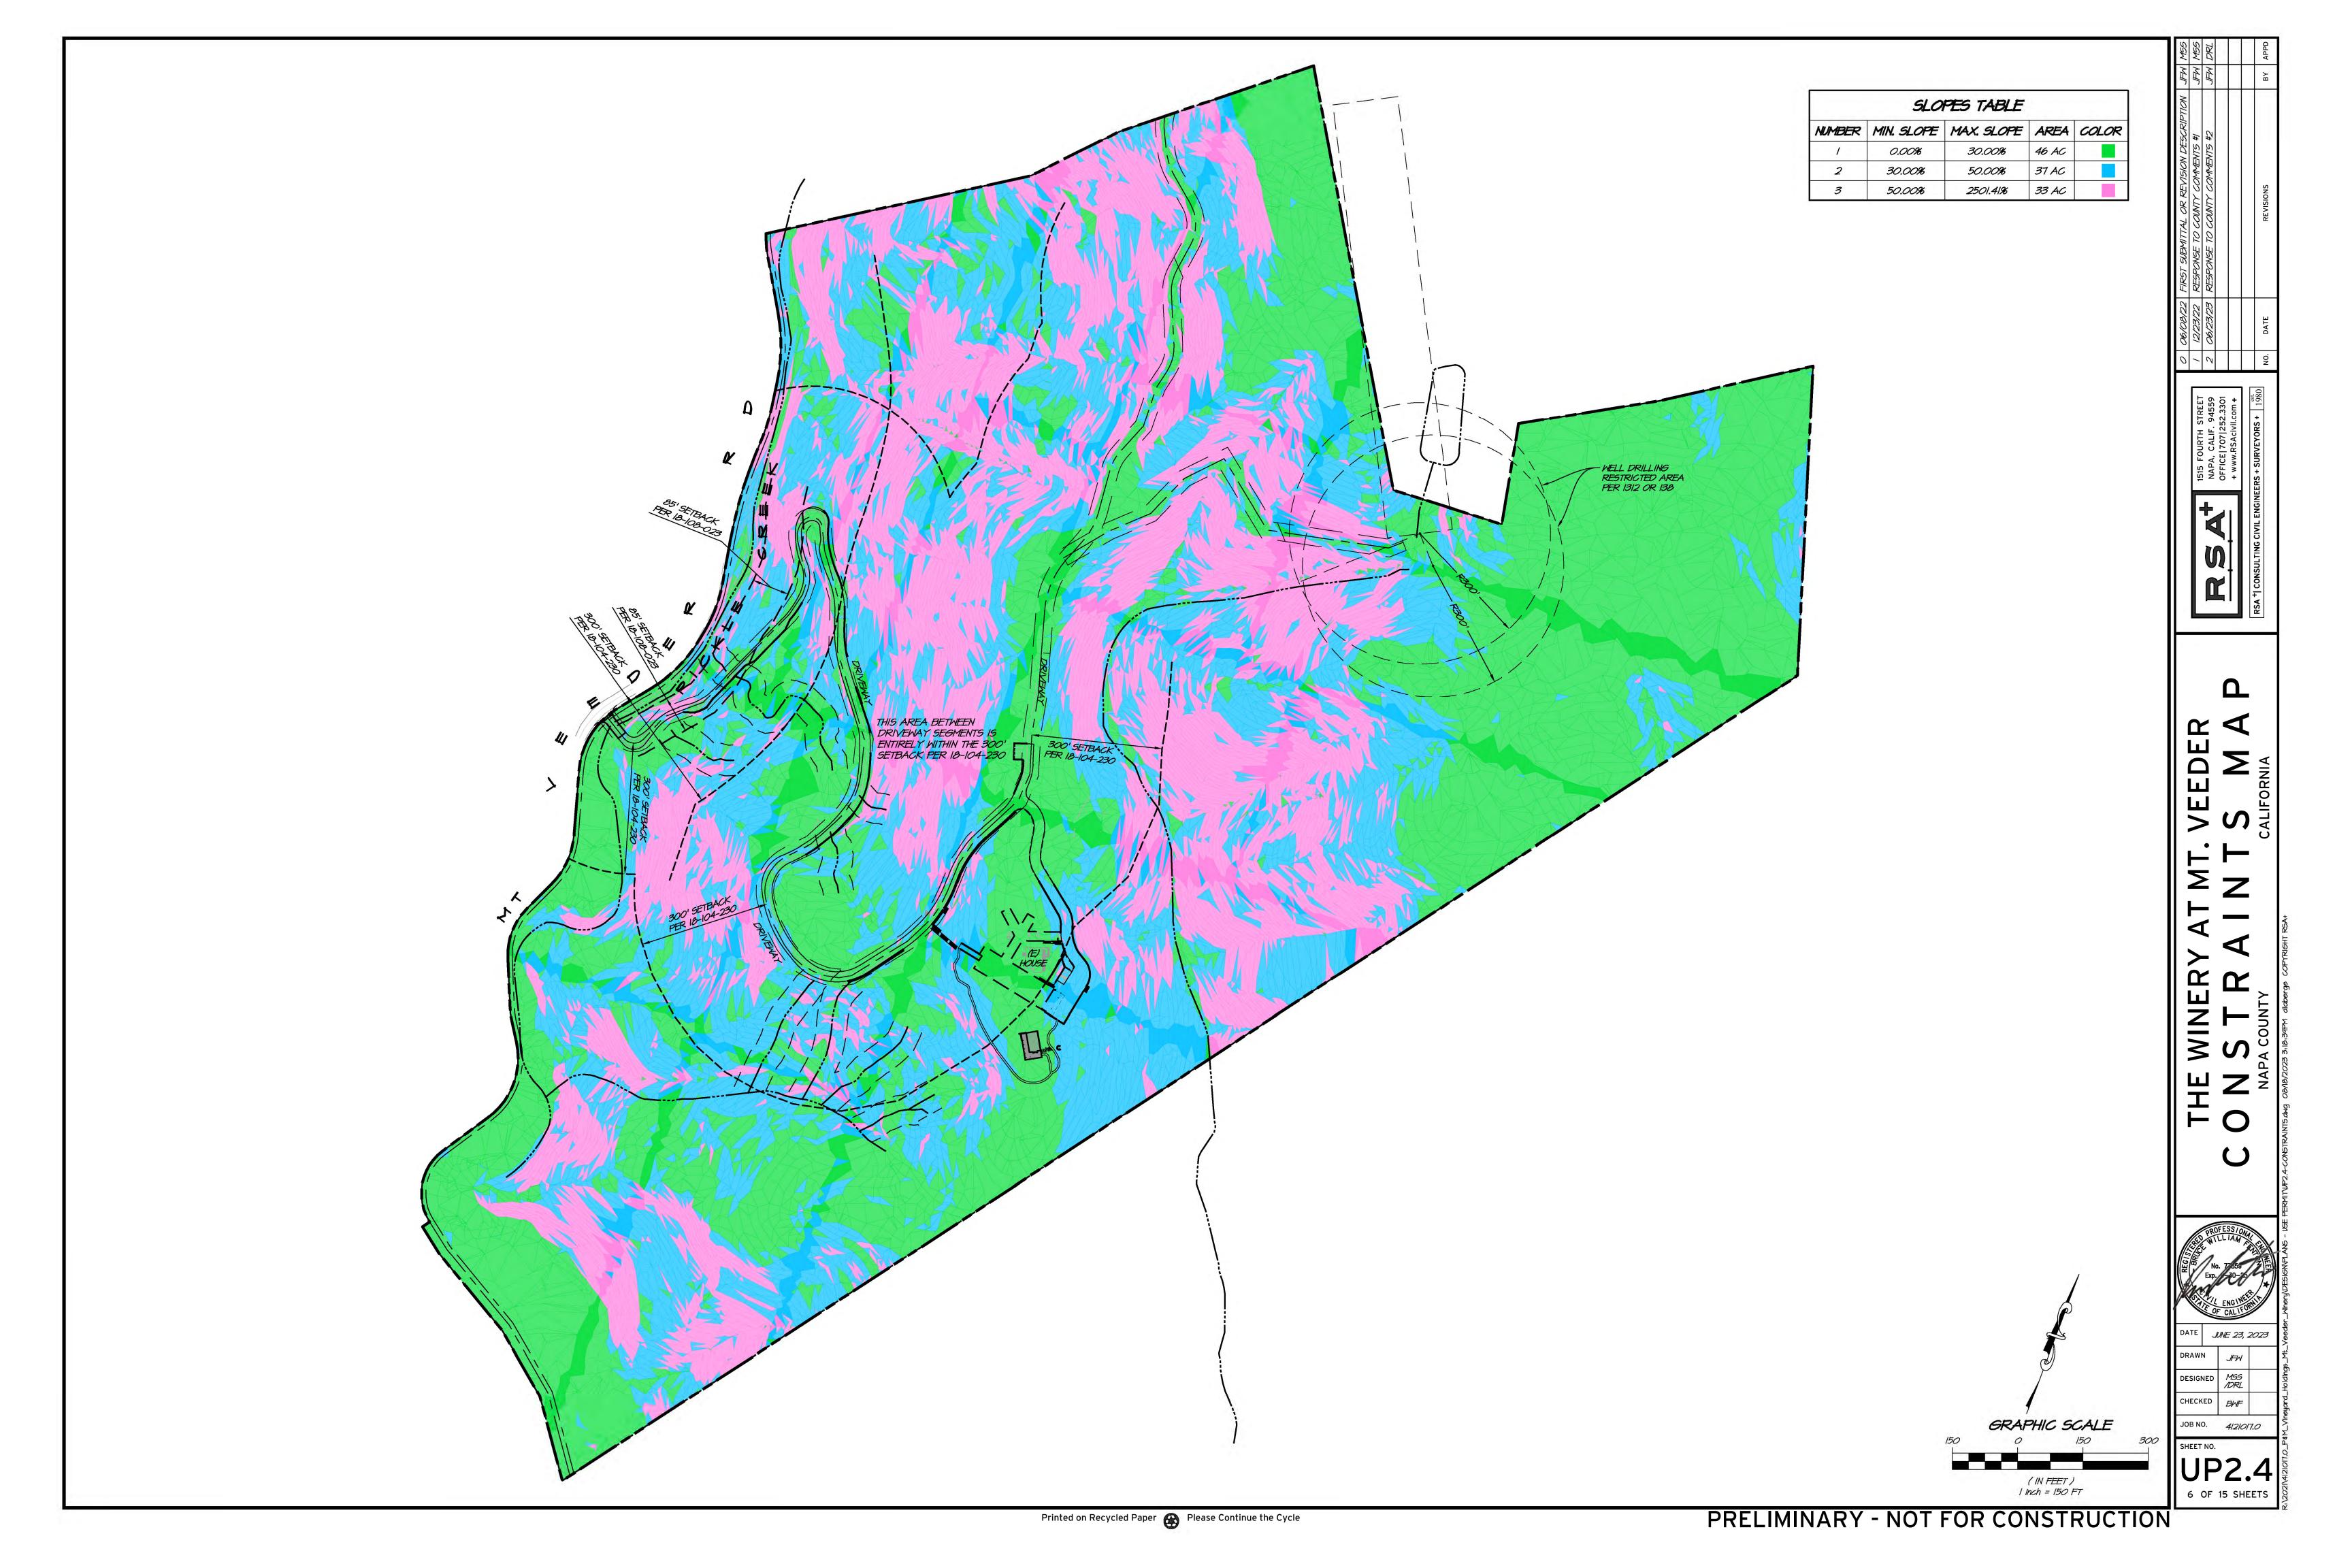

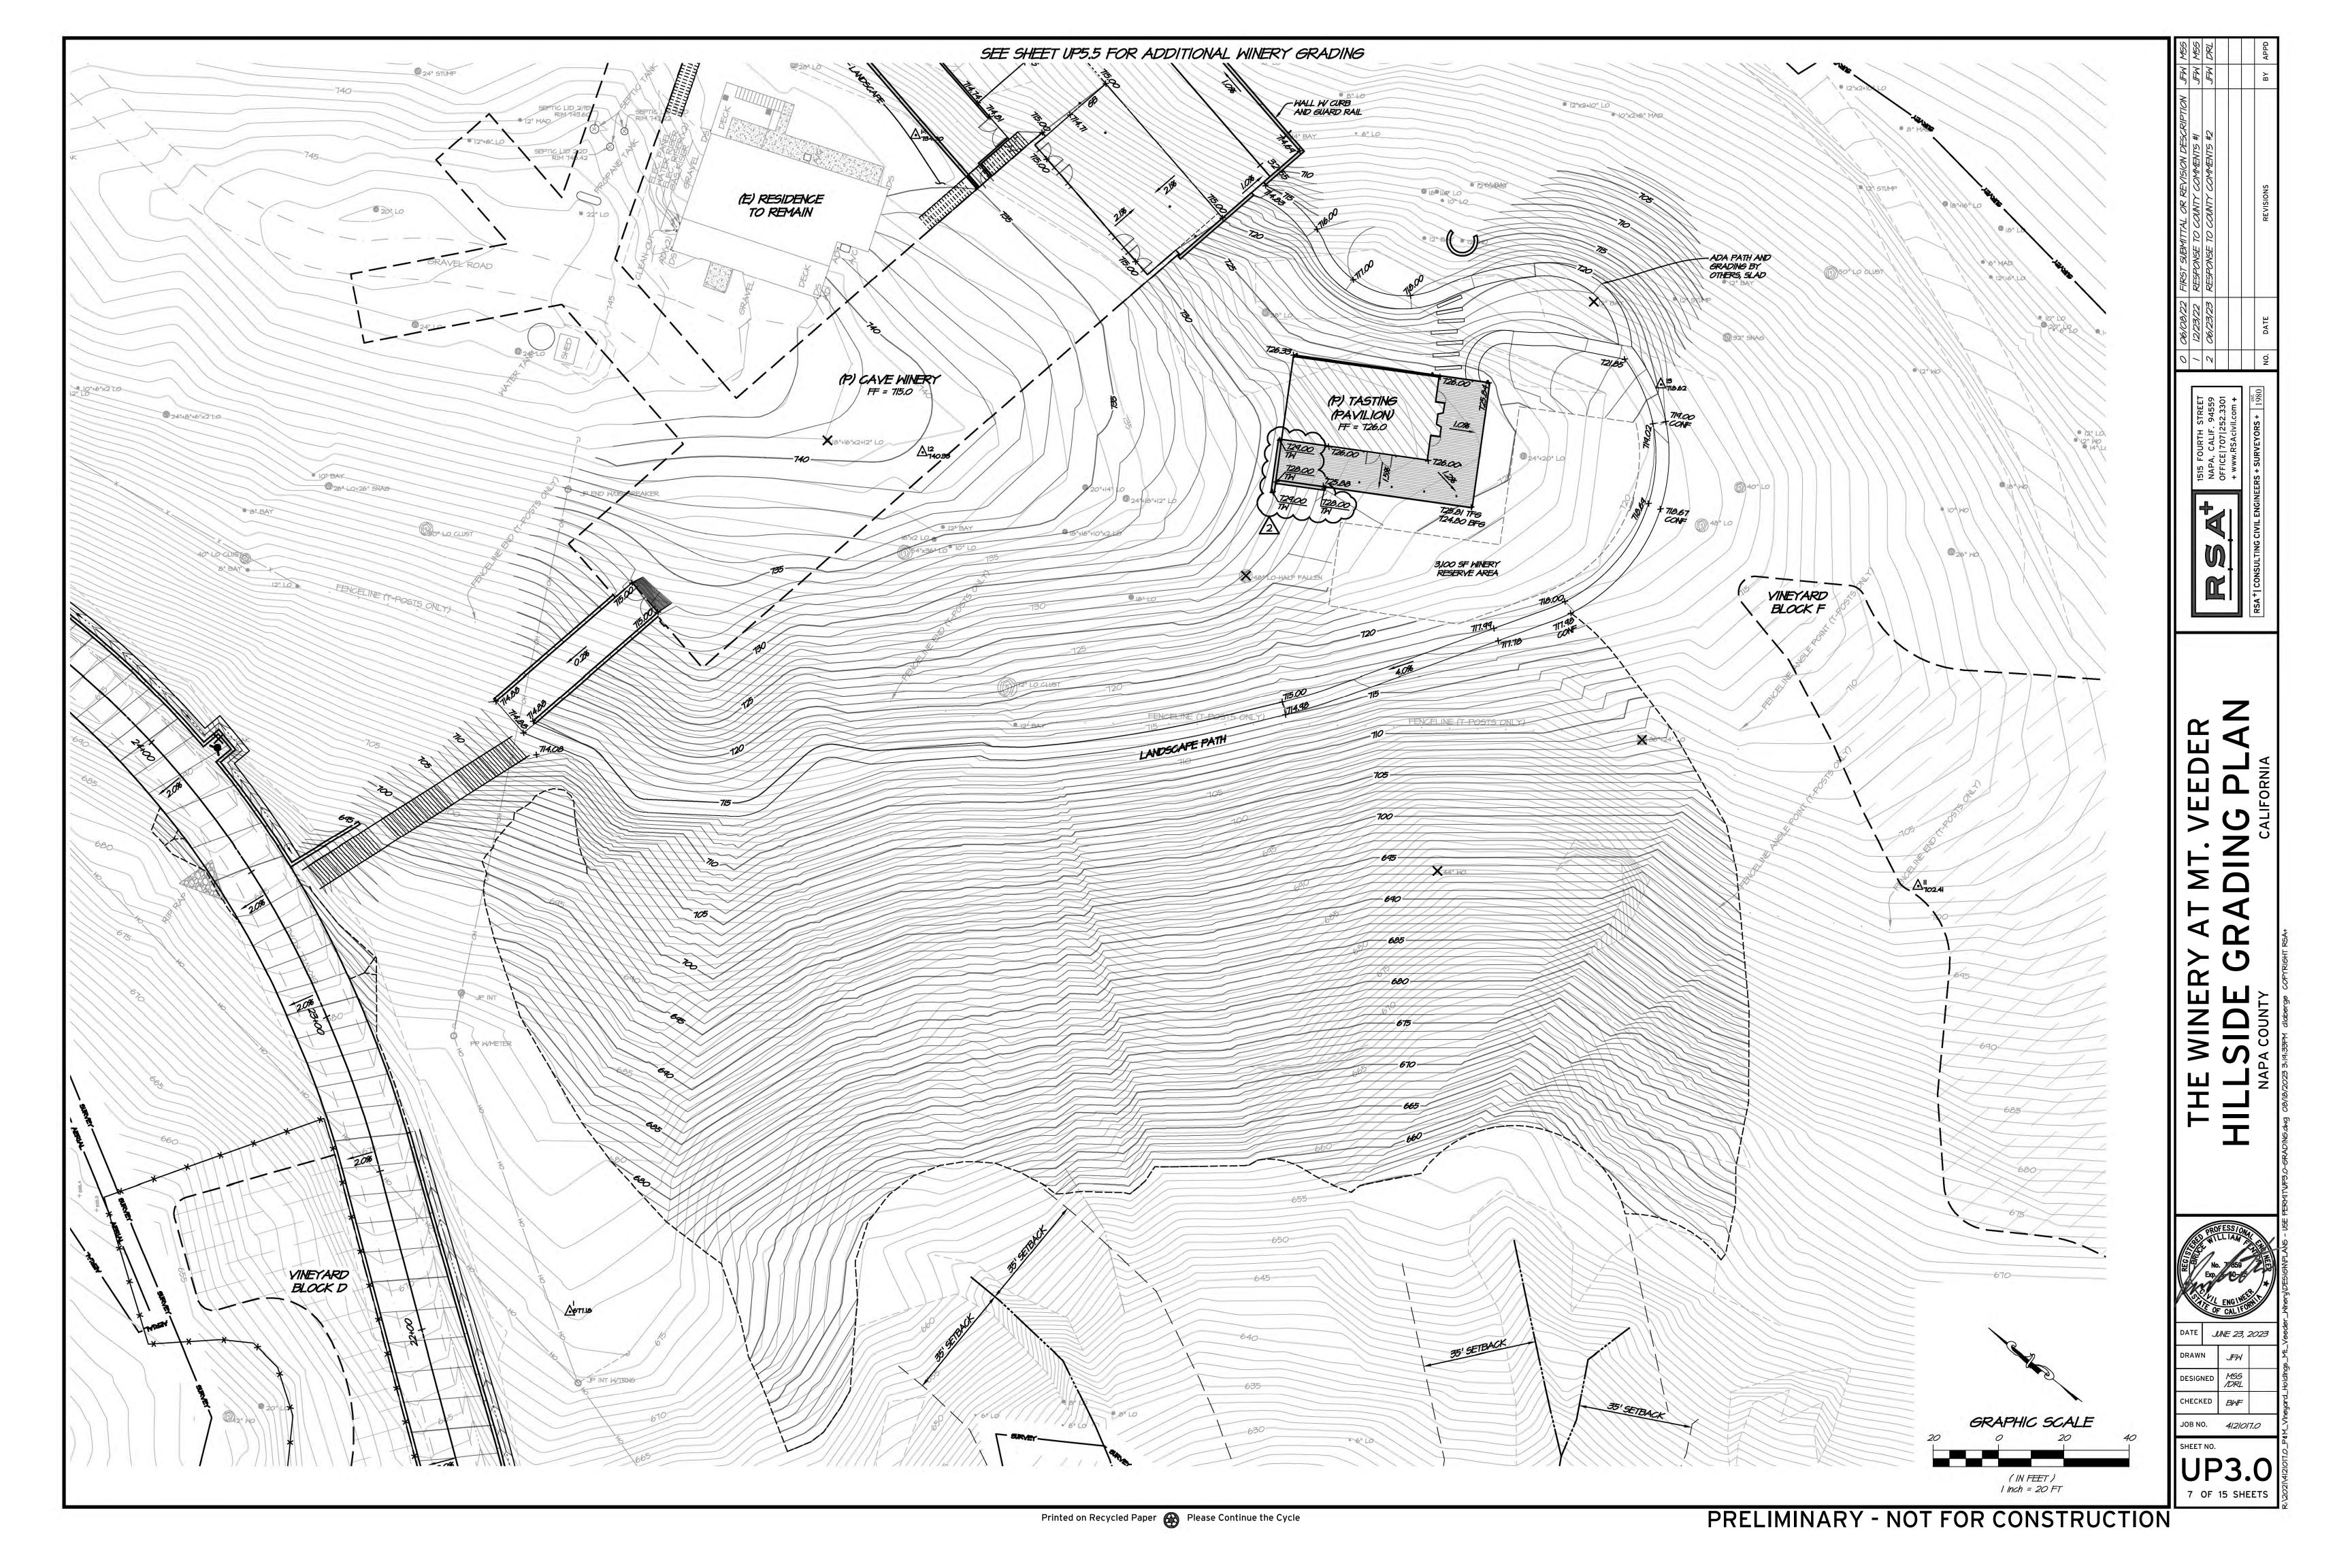


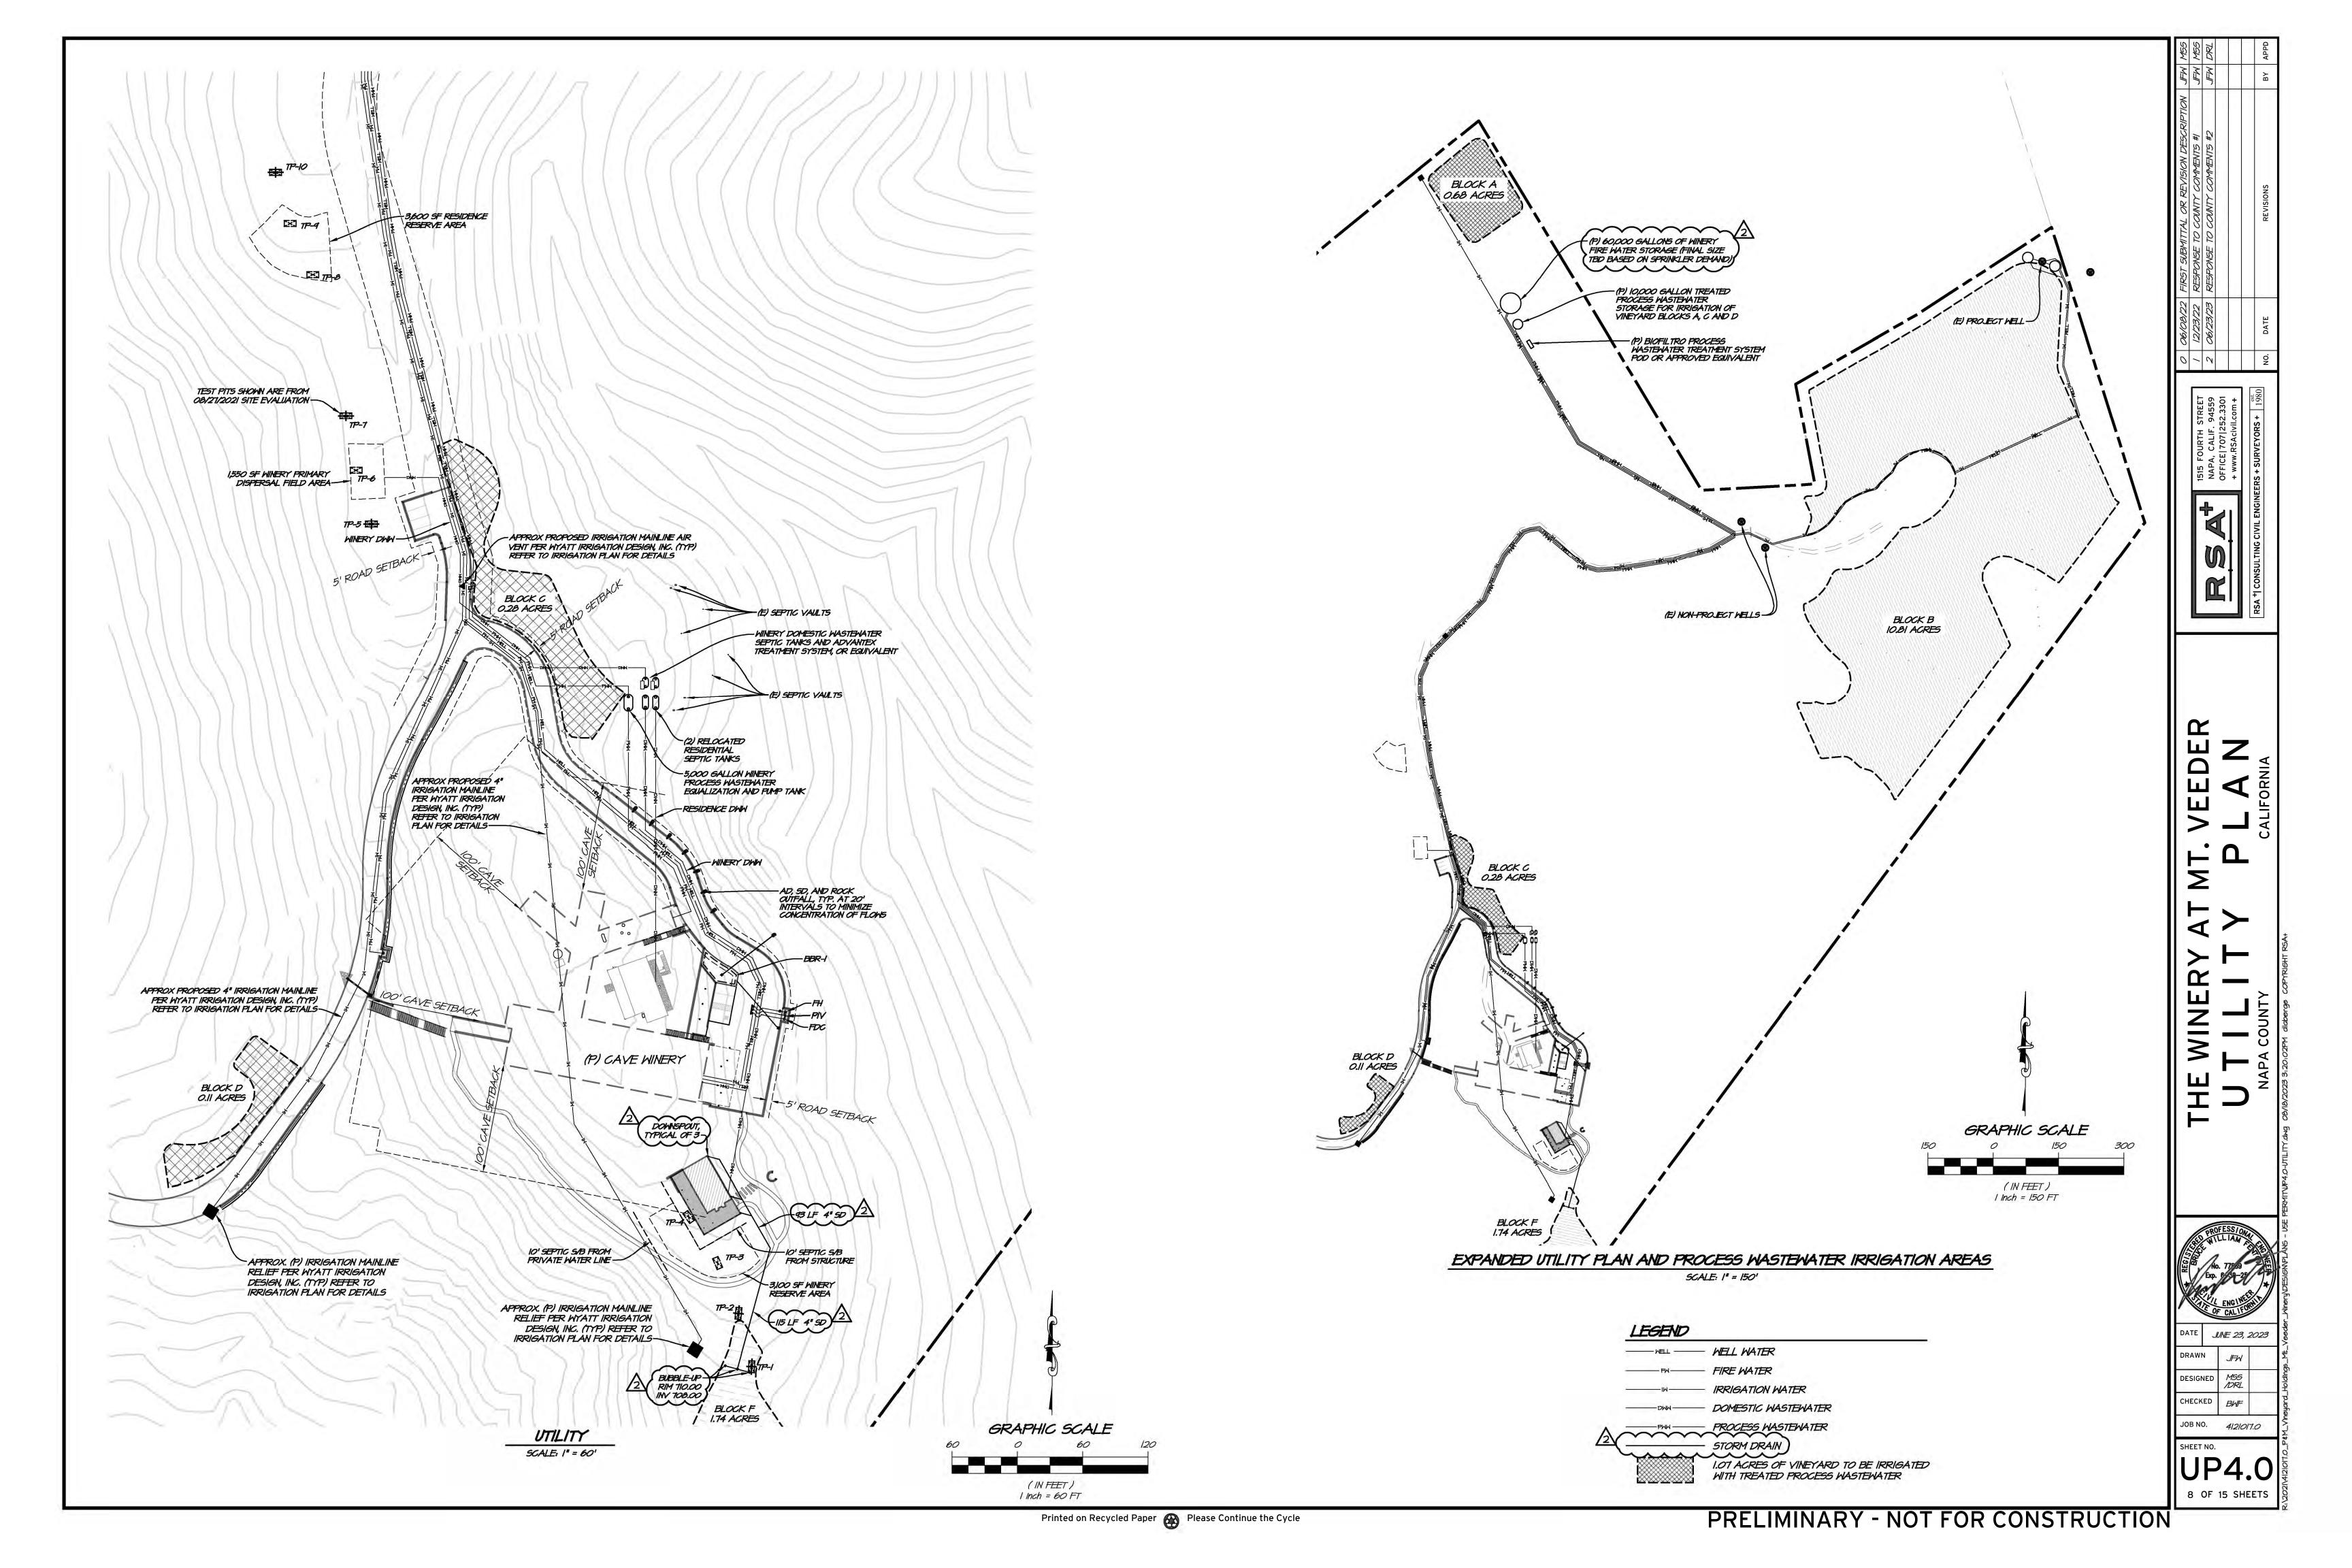


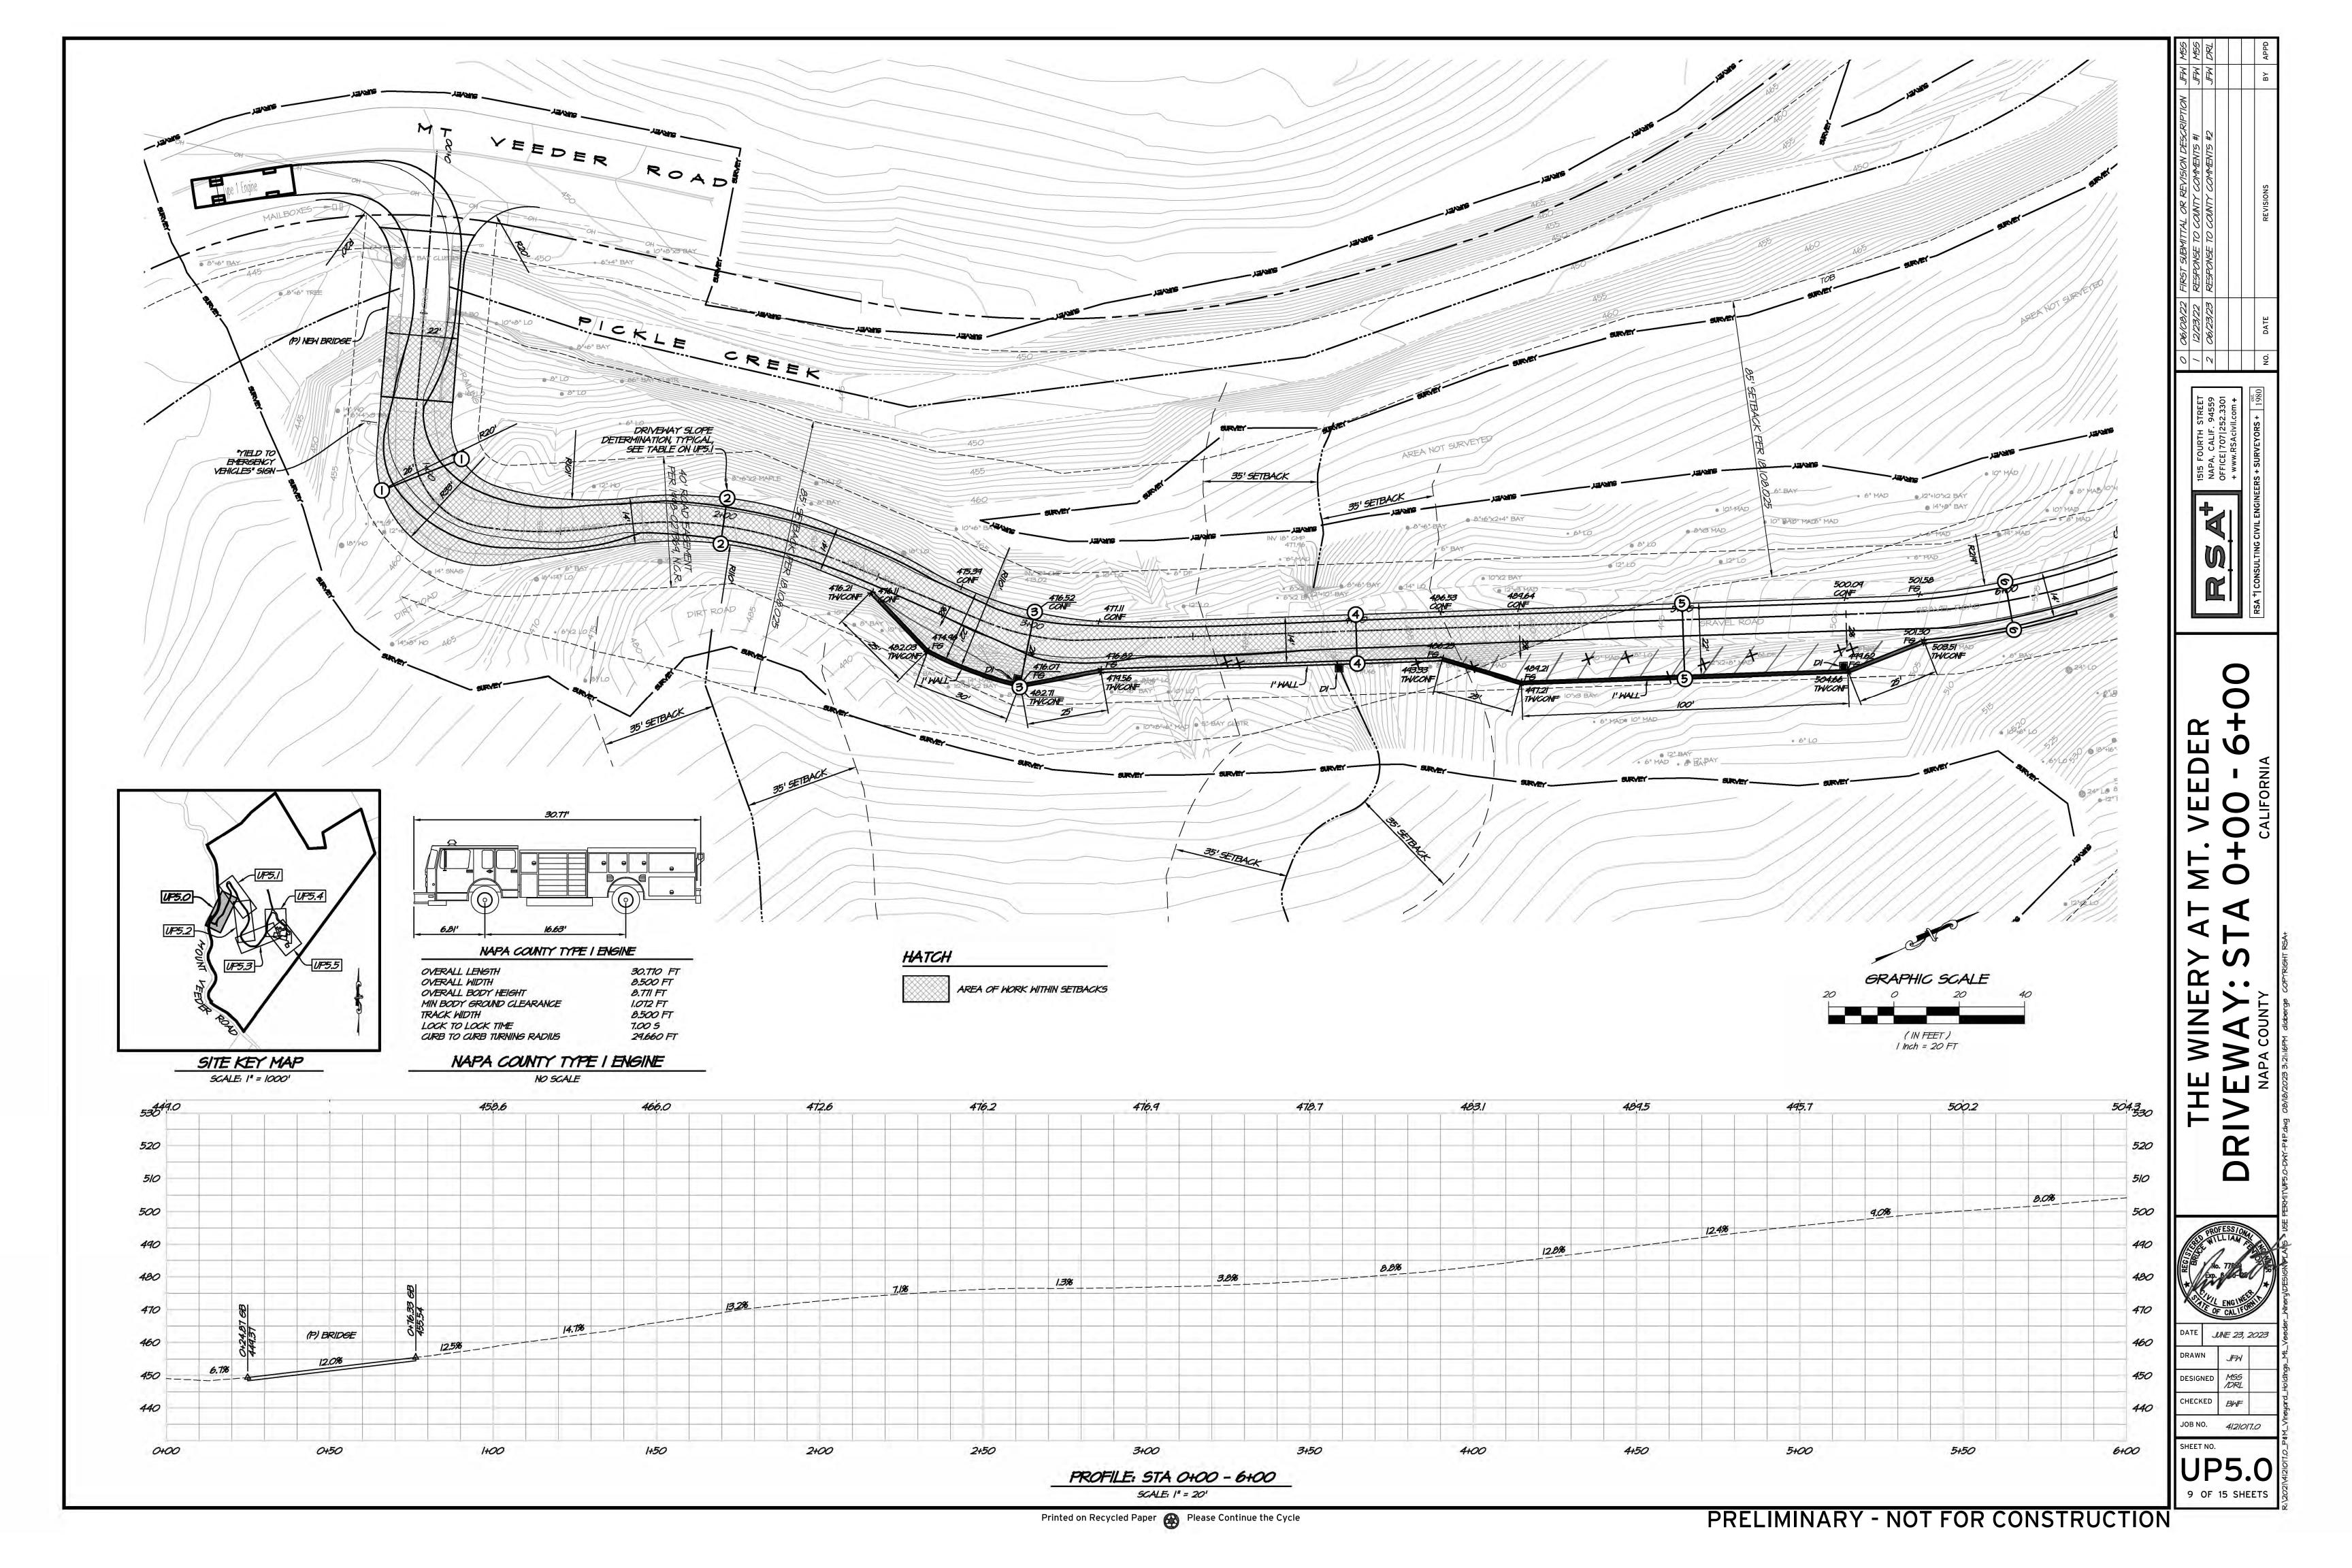


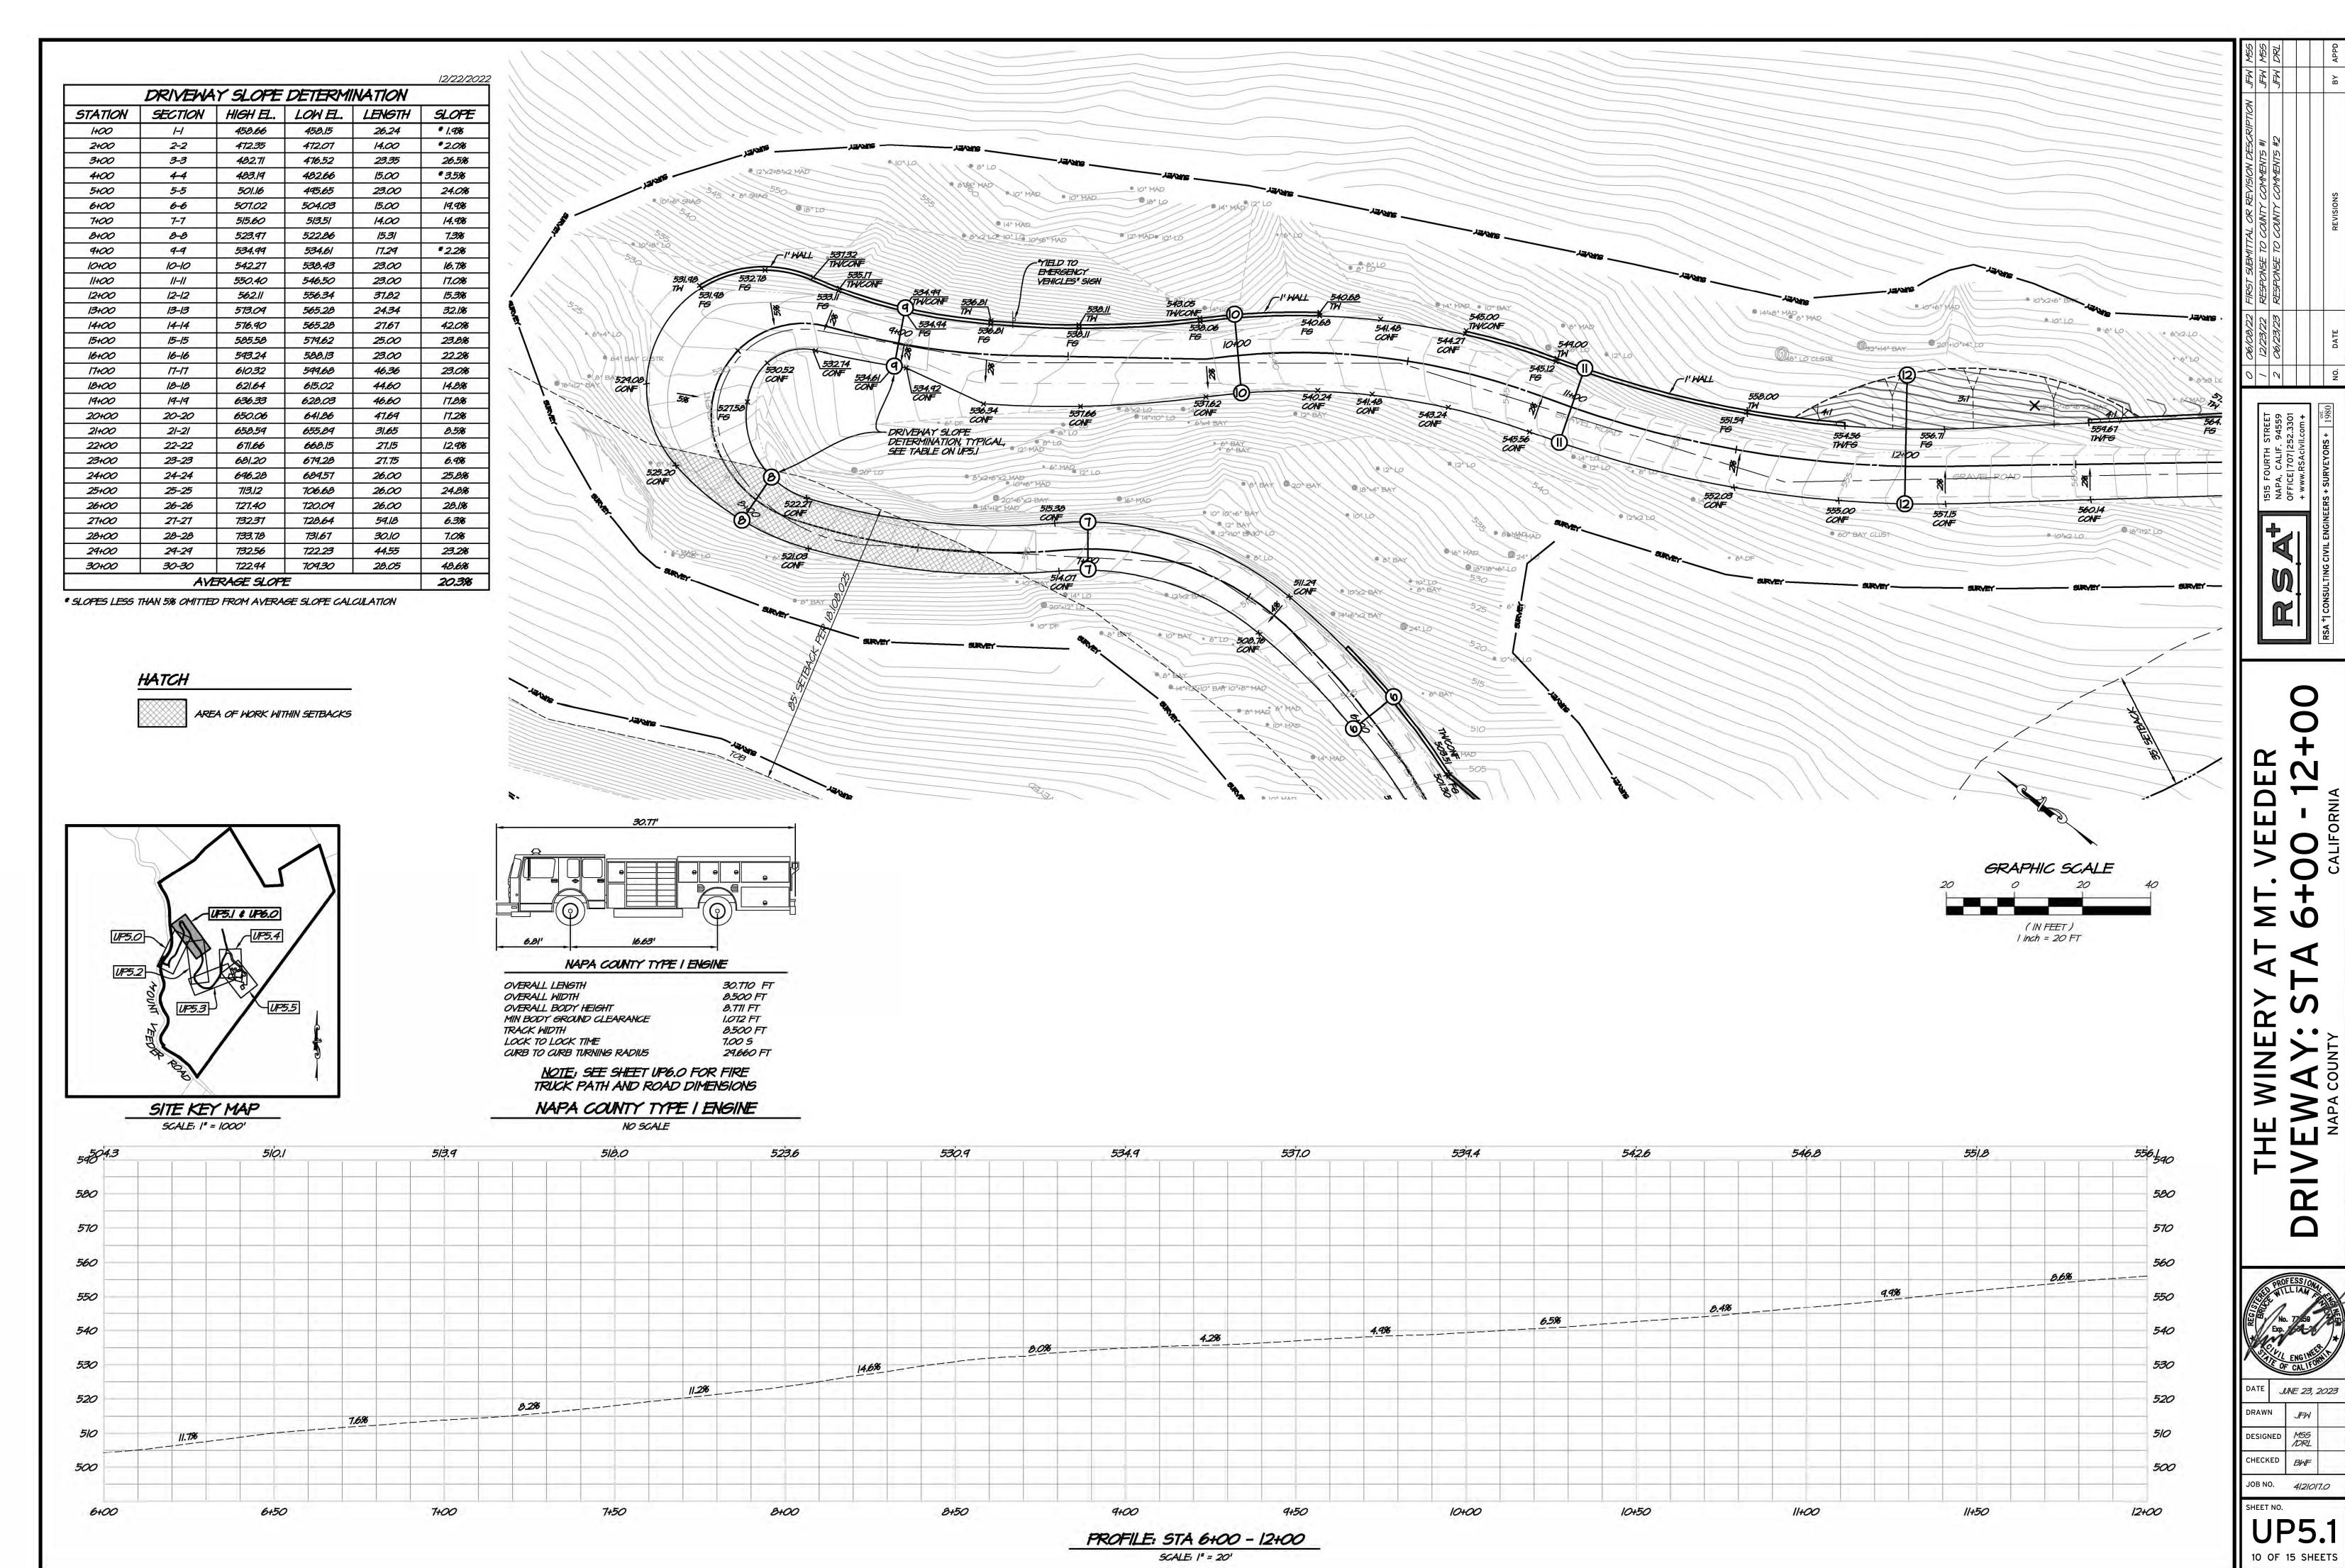



Printed on Recycled Paper Please Continue the Cycle

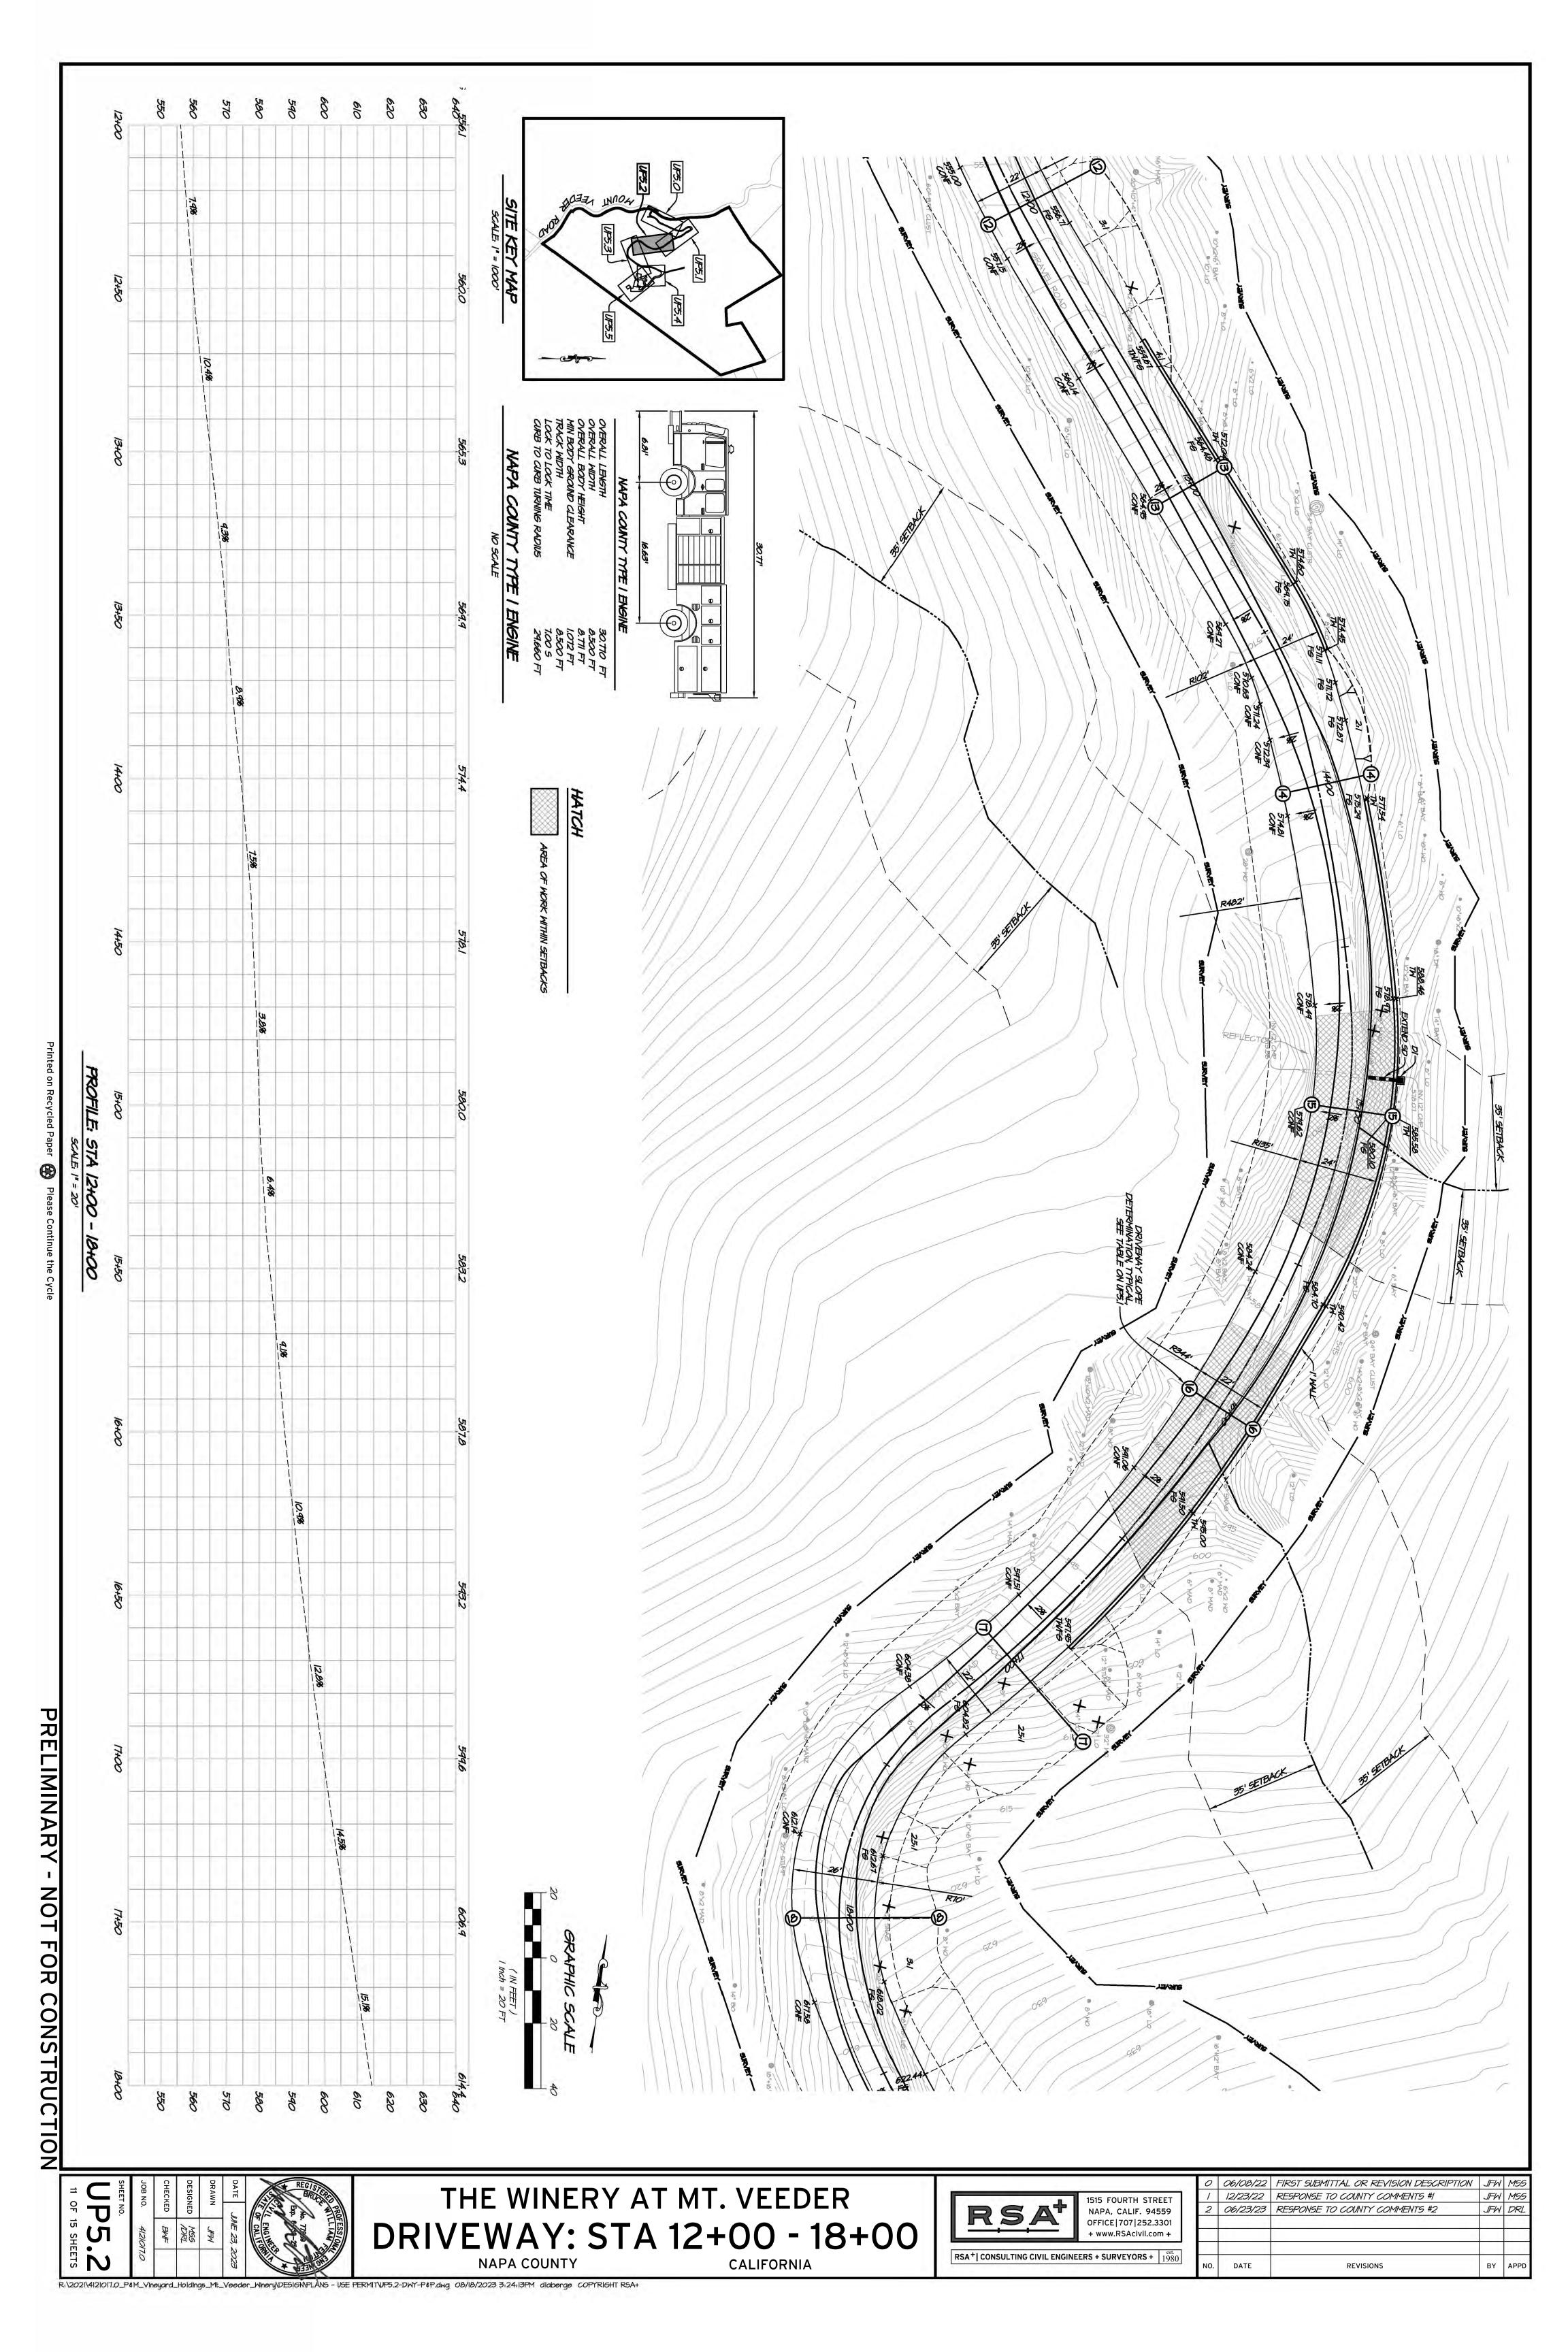

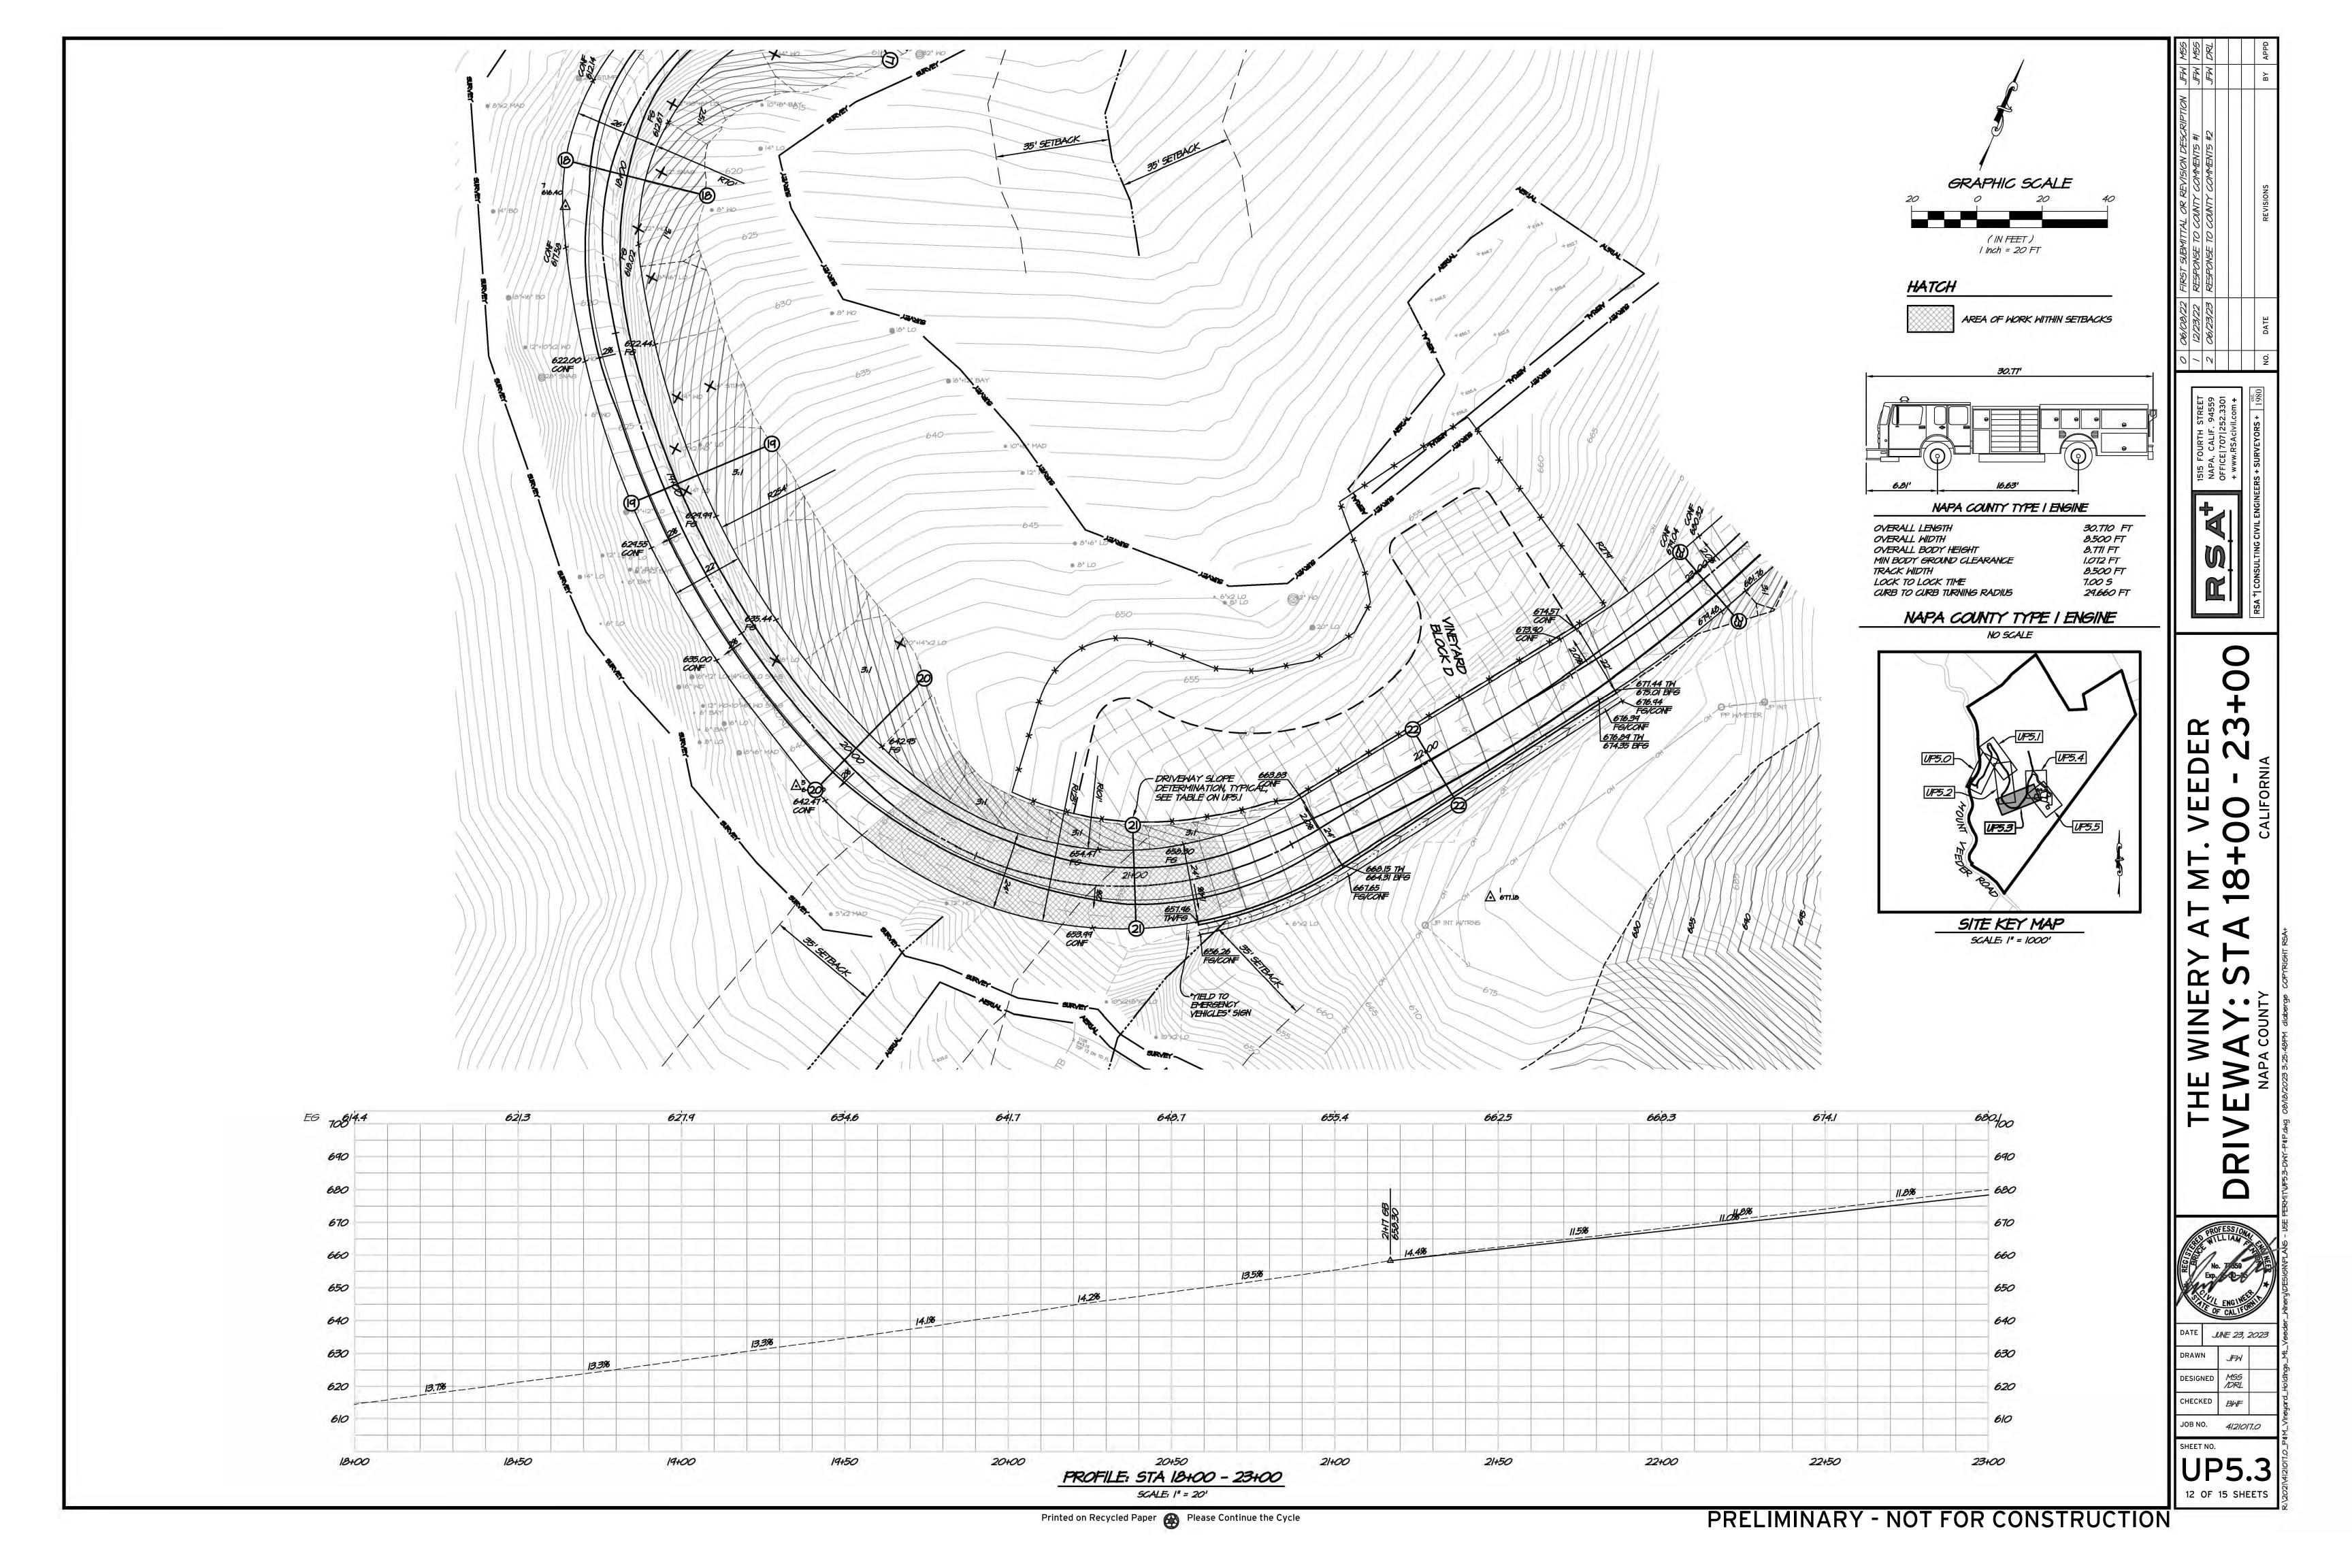

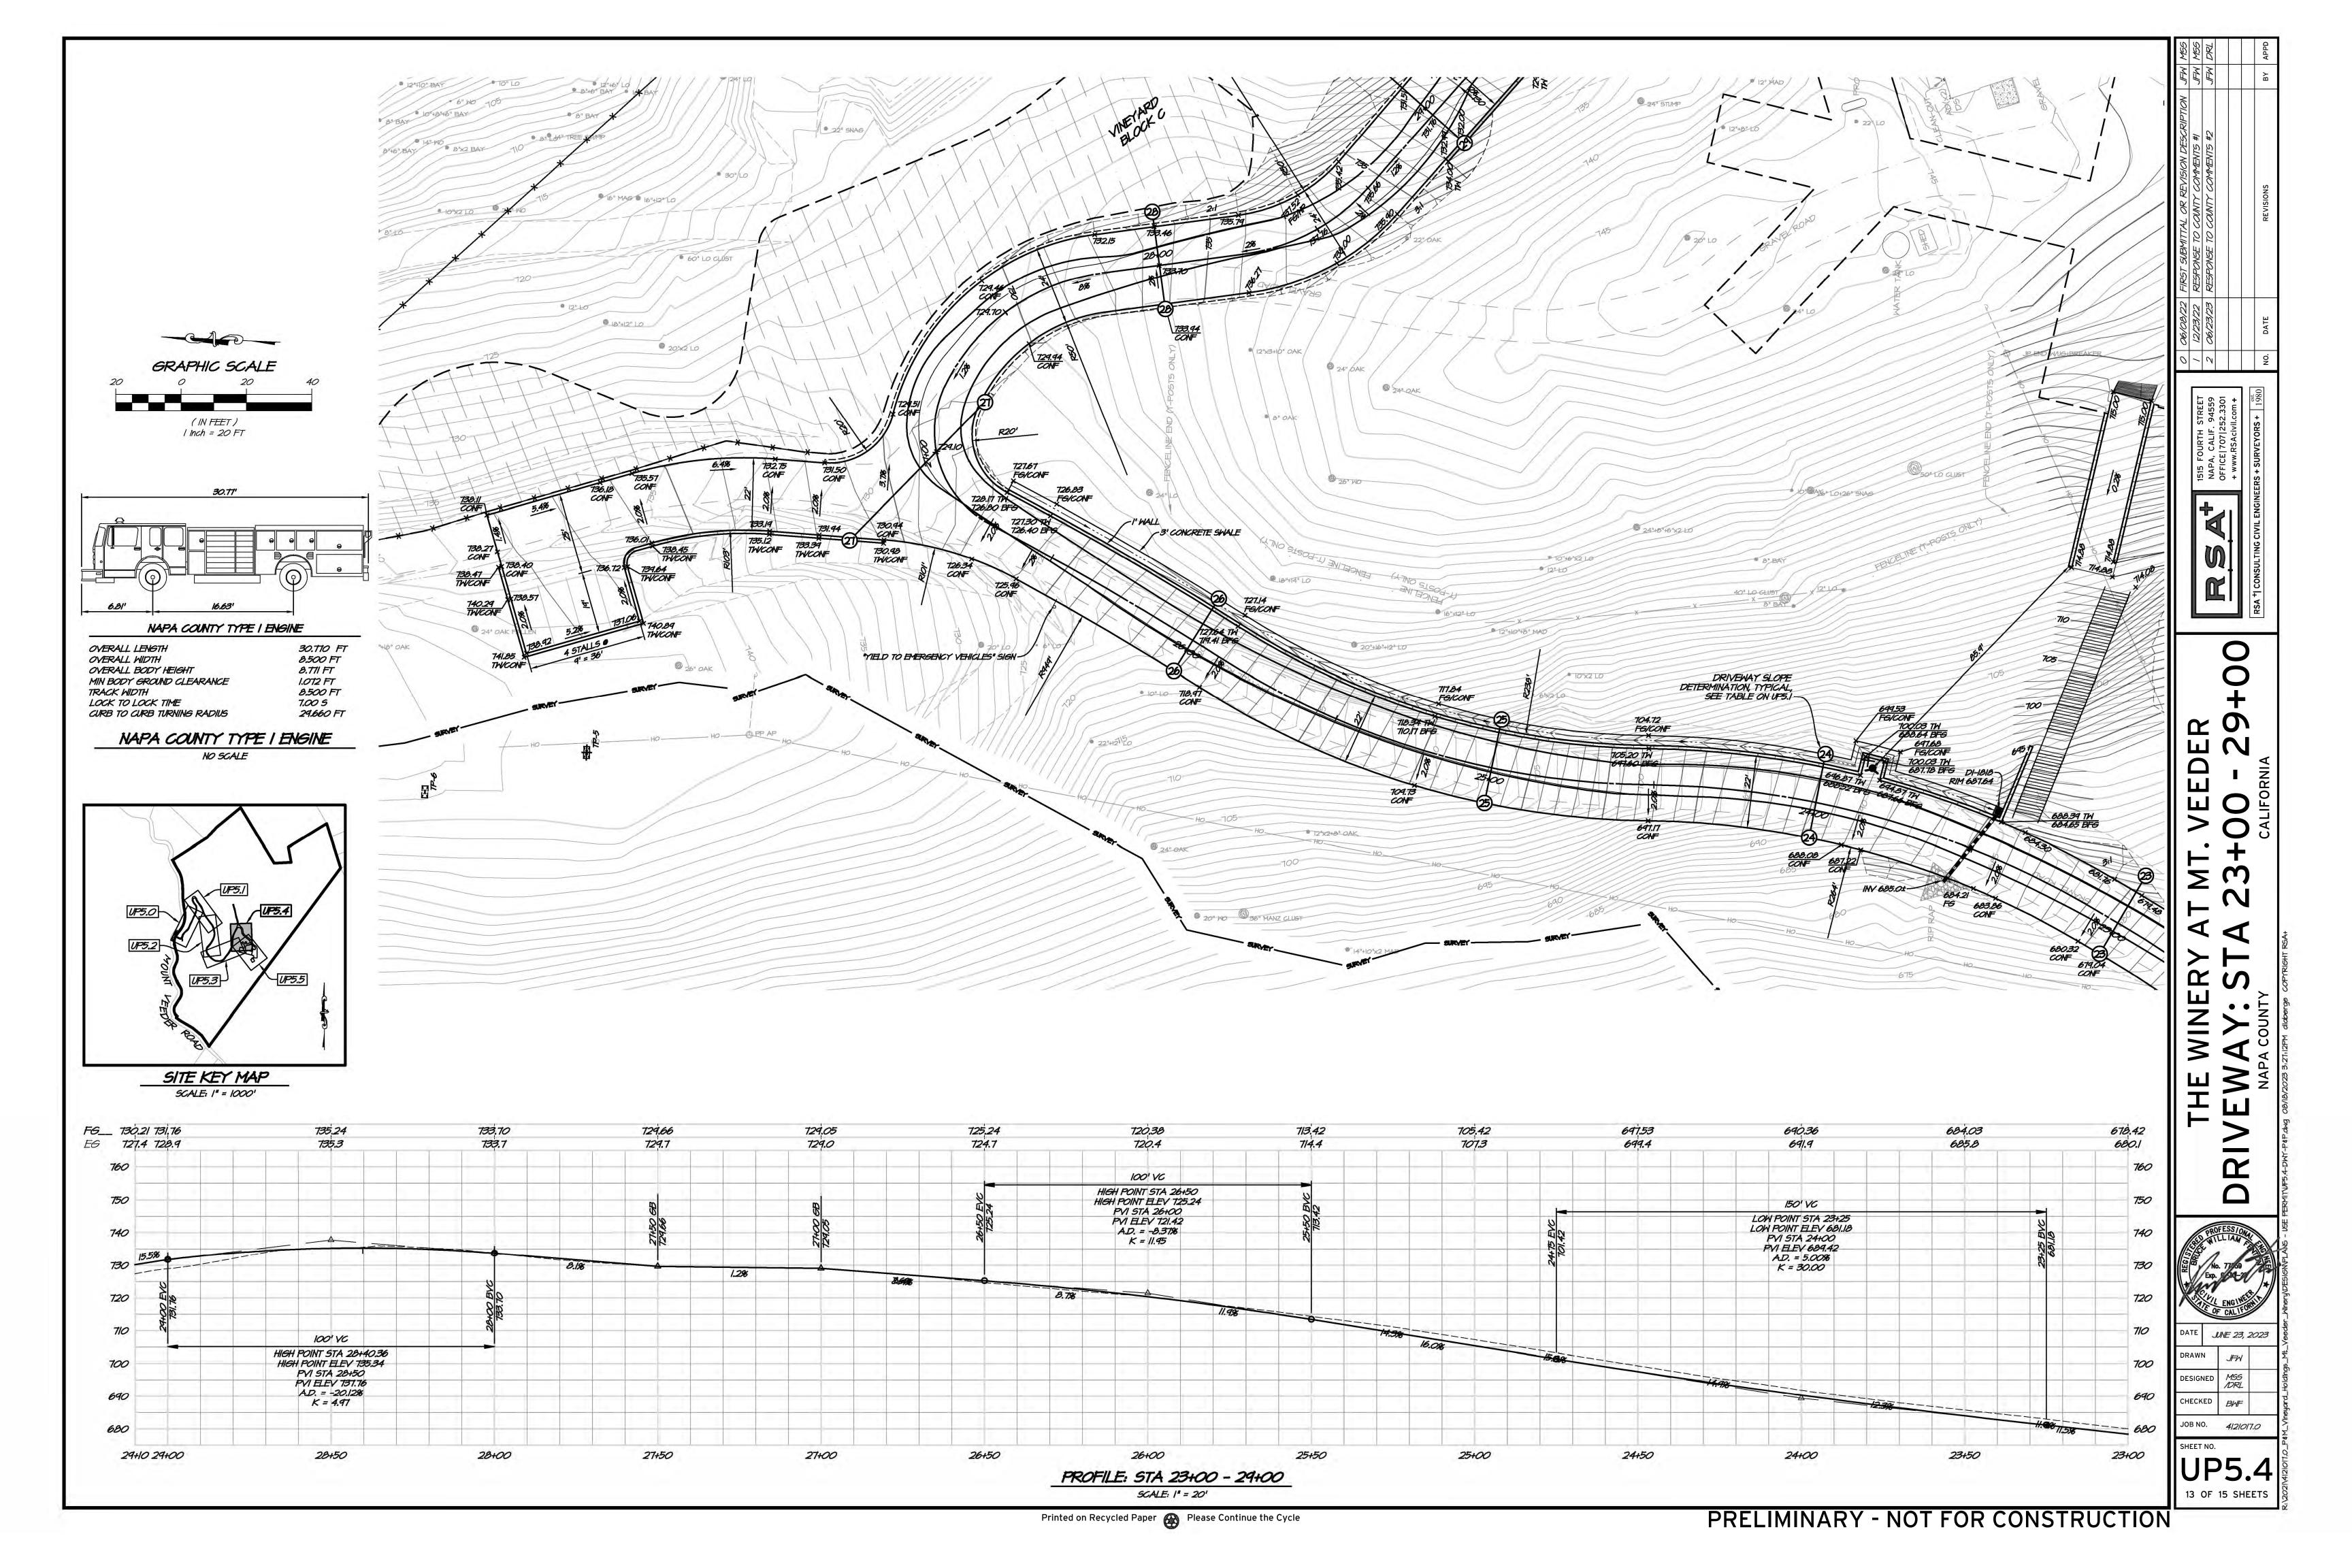

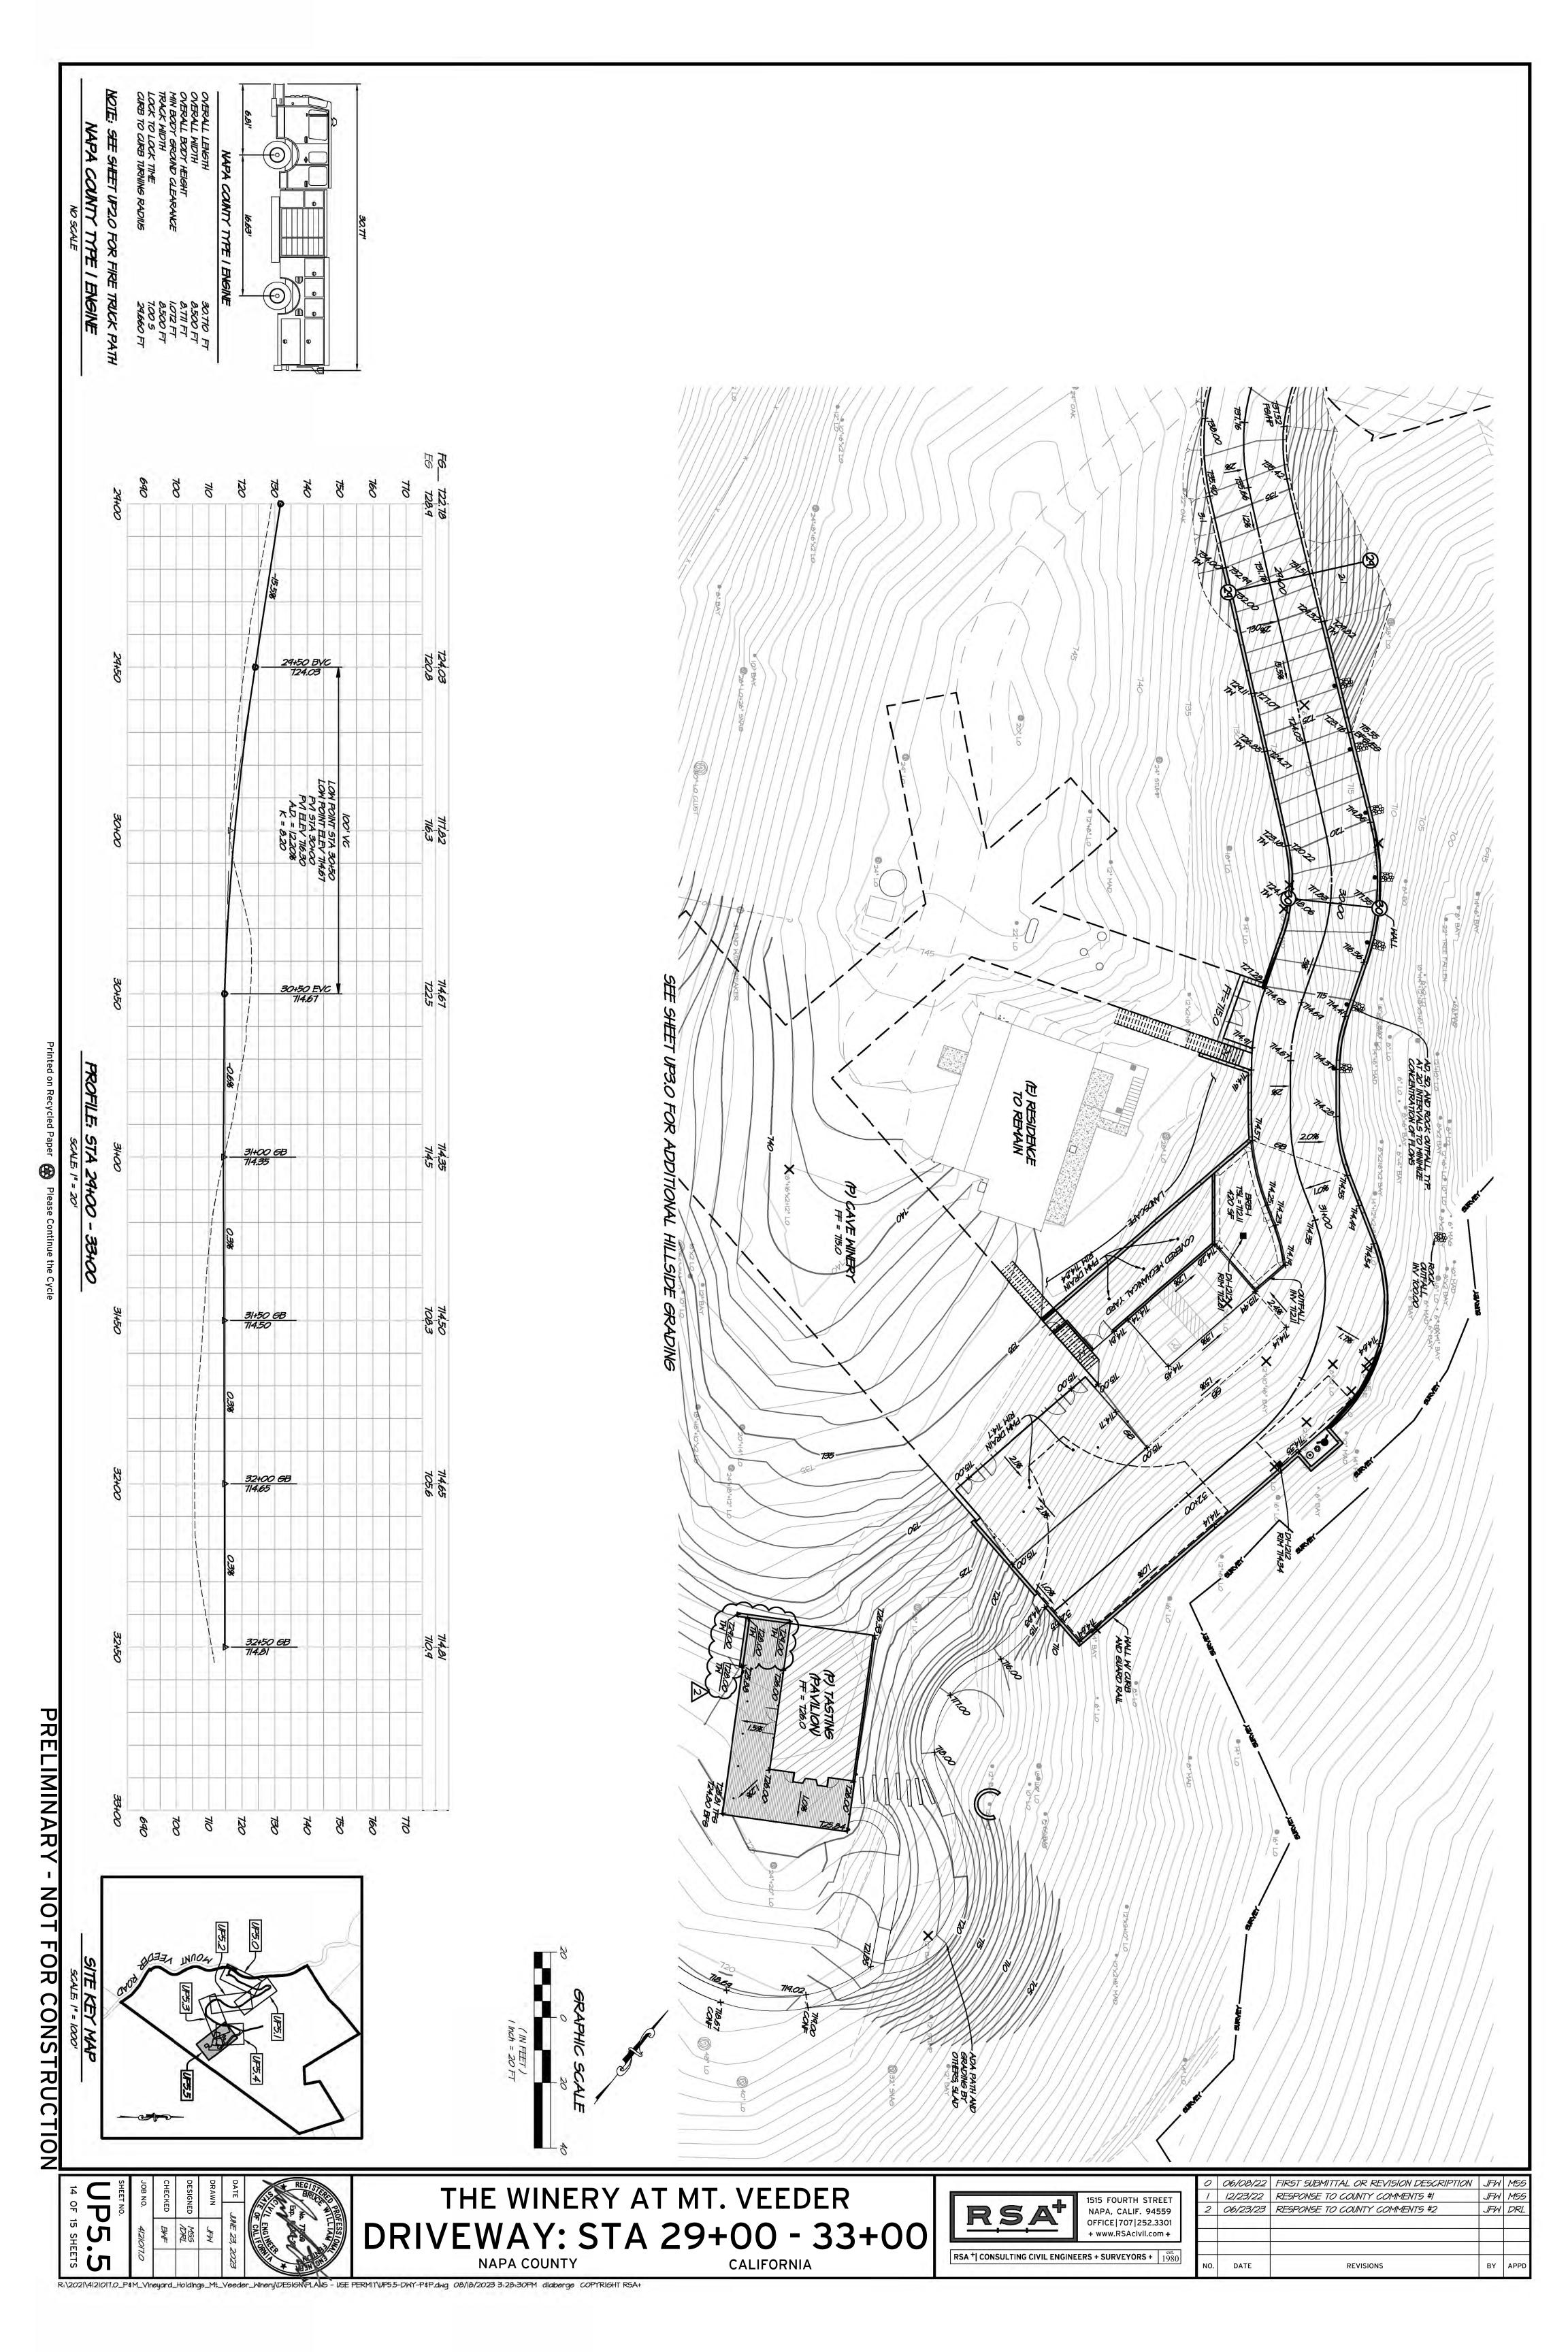

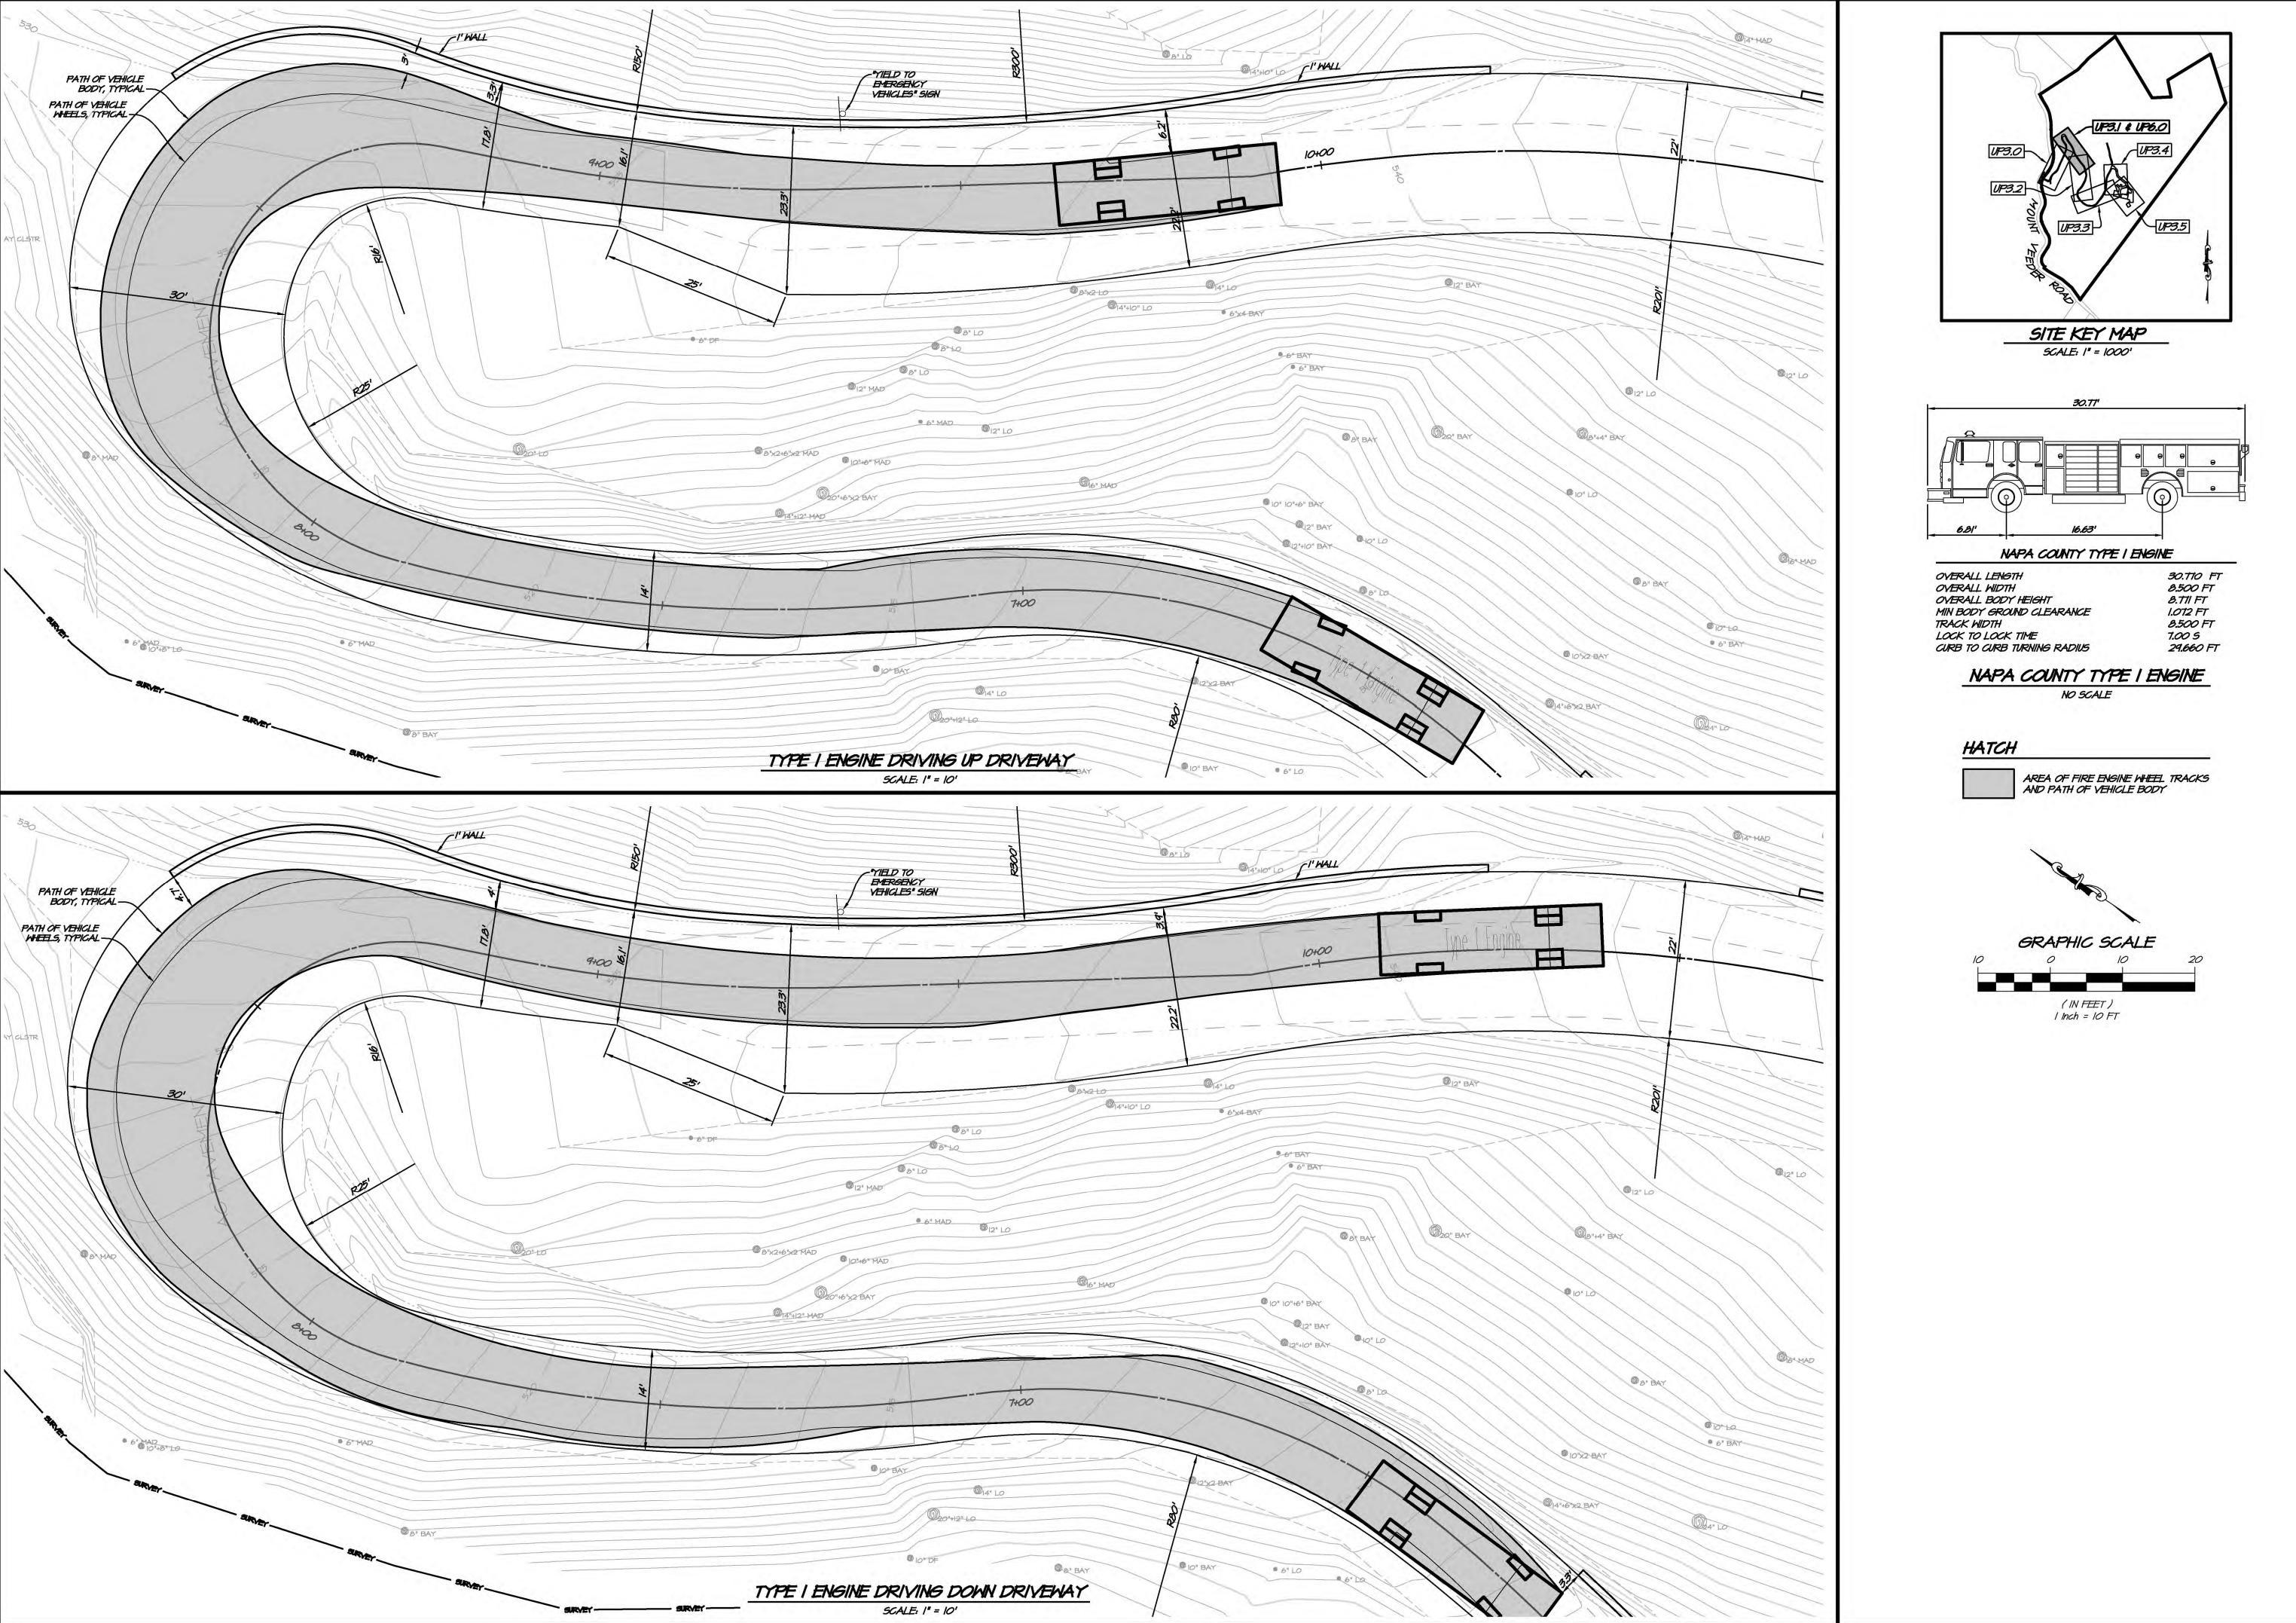

Printed on Recycled Paper Please Continue the Cycle

0

S S S

V


ST


THE

DESIGNED

CHECKED BWF

15 OF 15 SHEETS

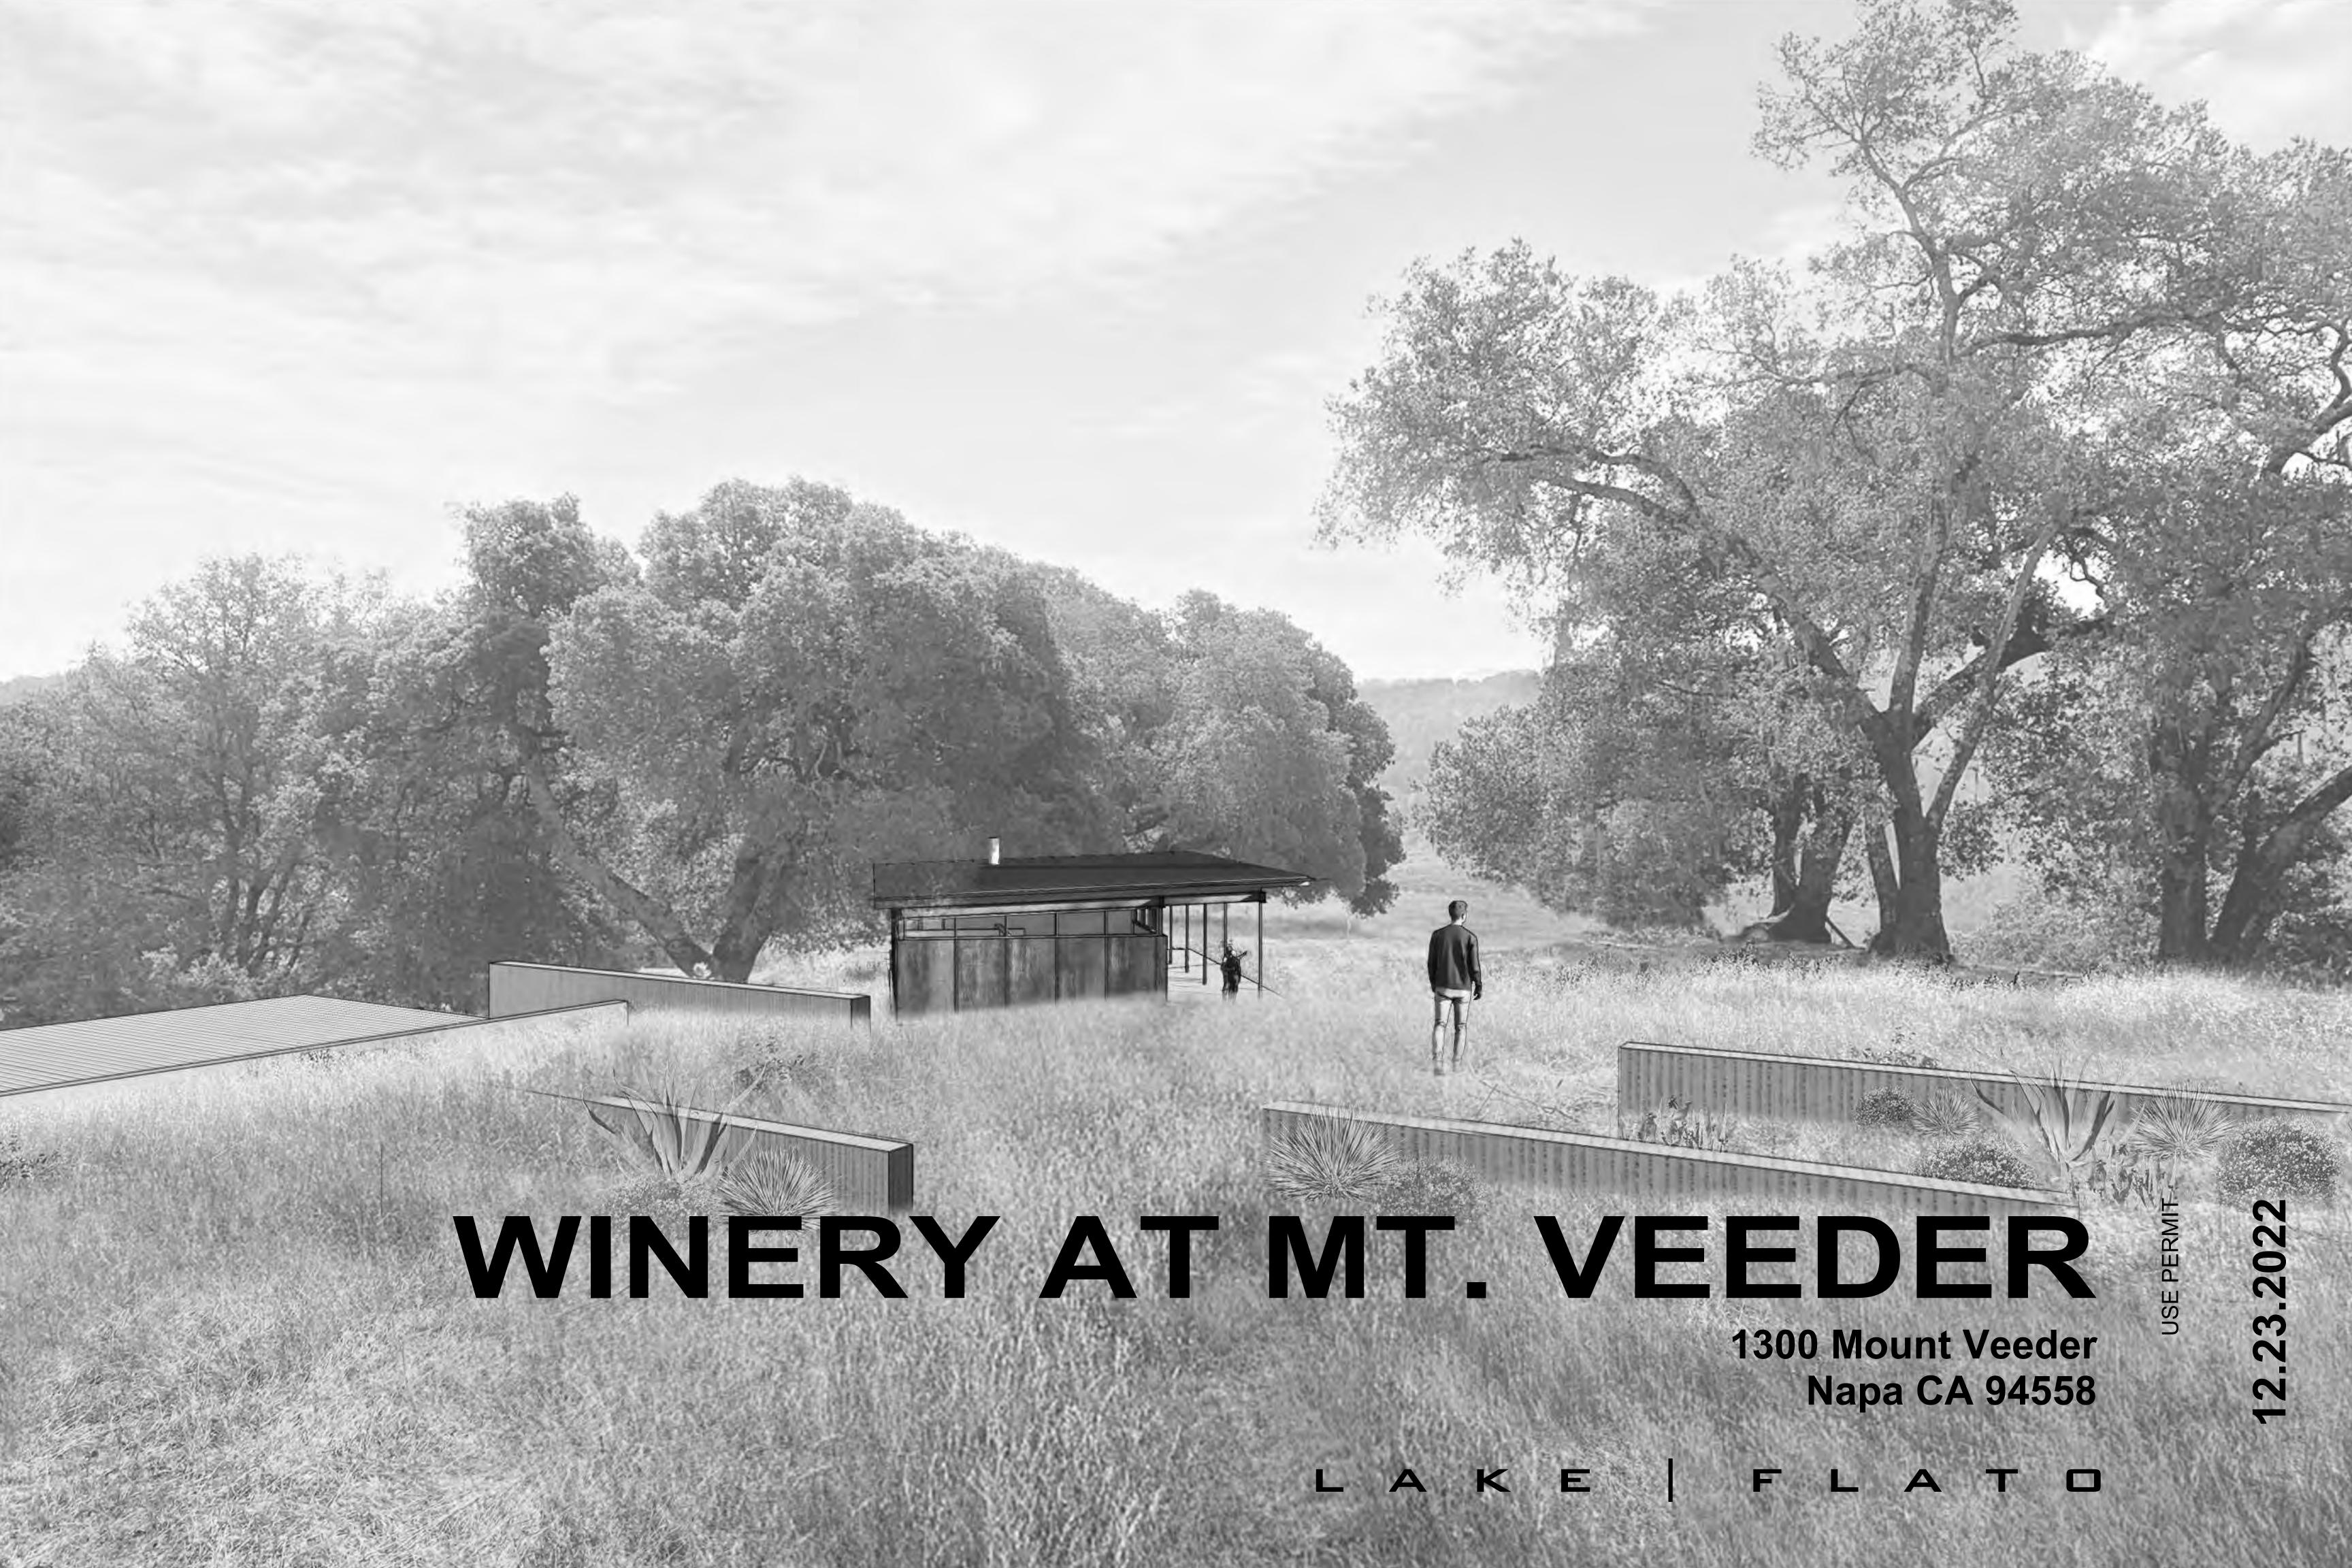

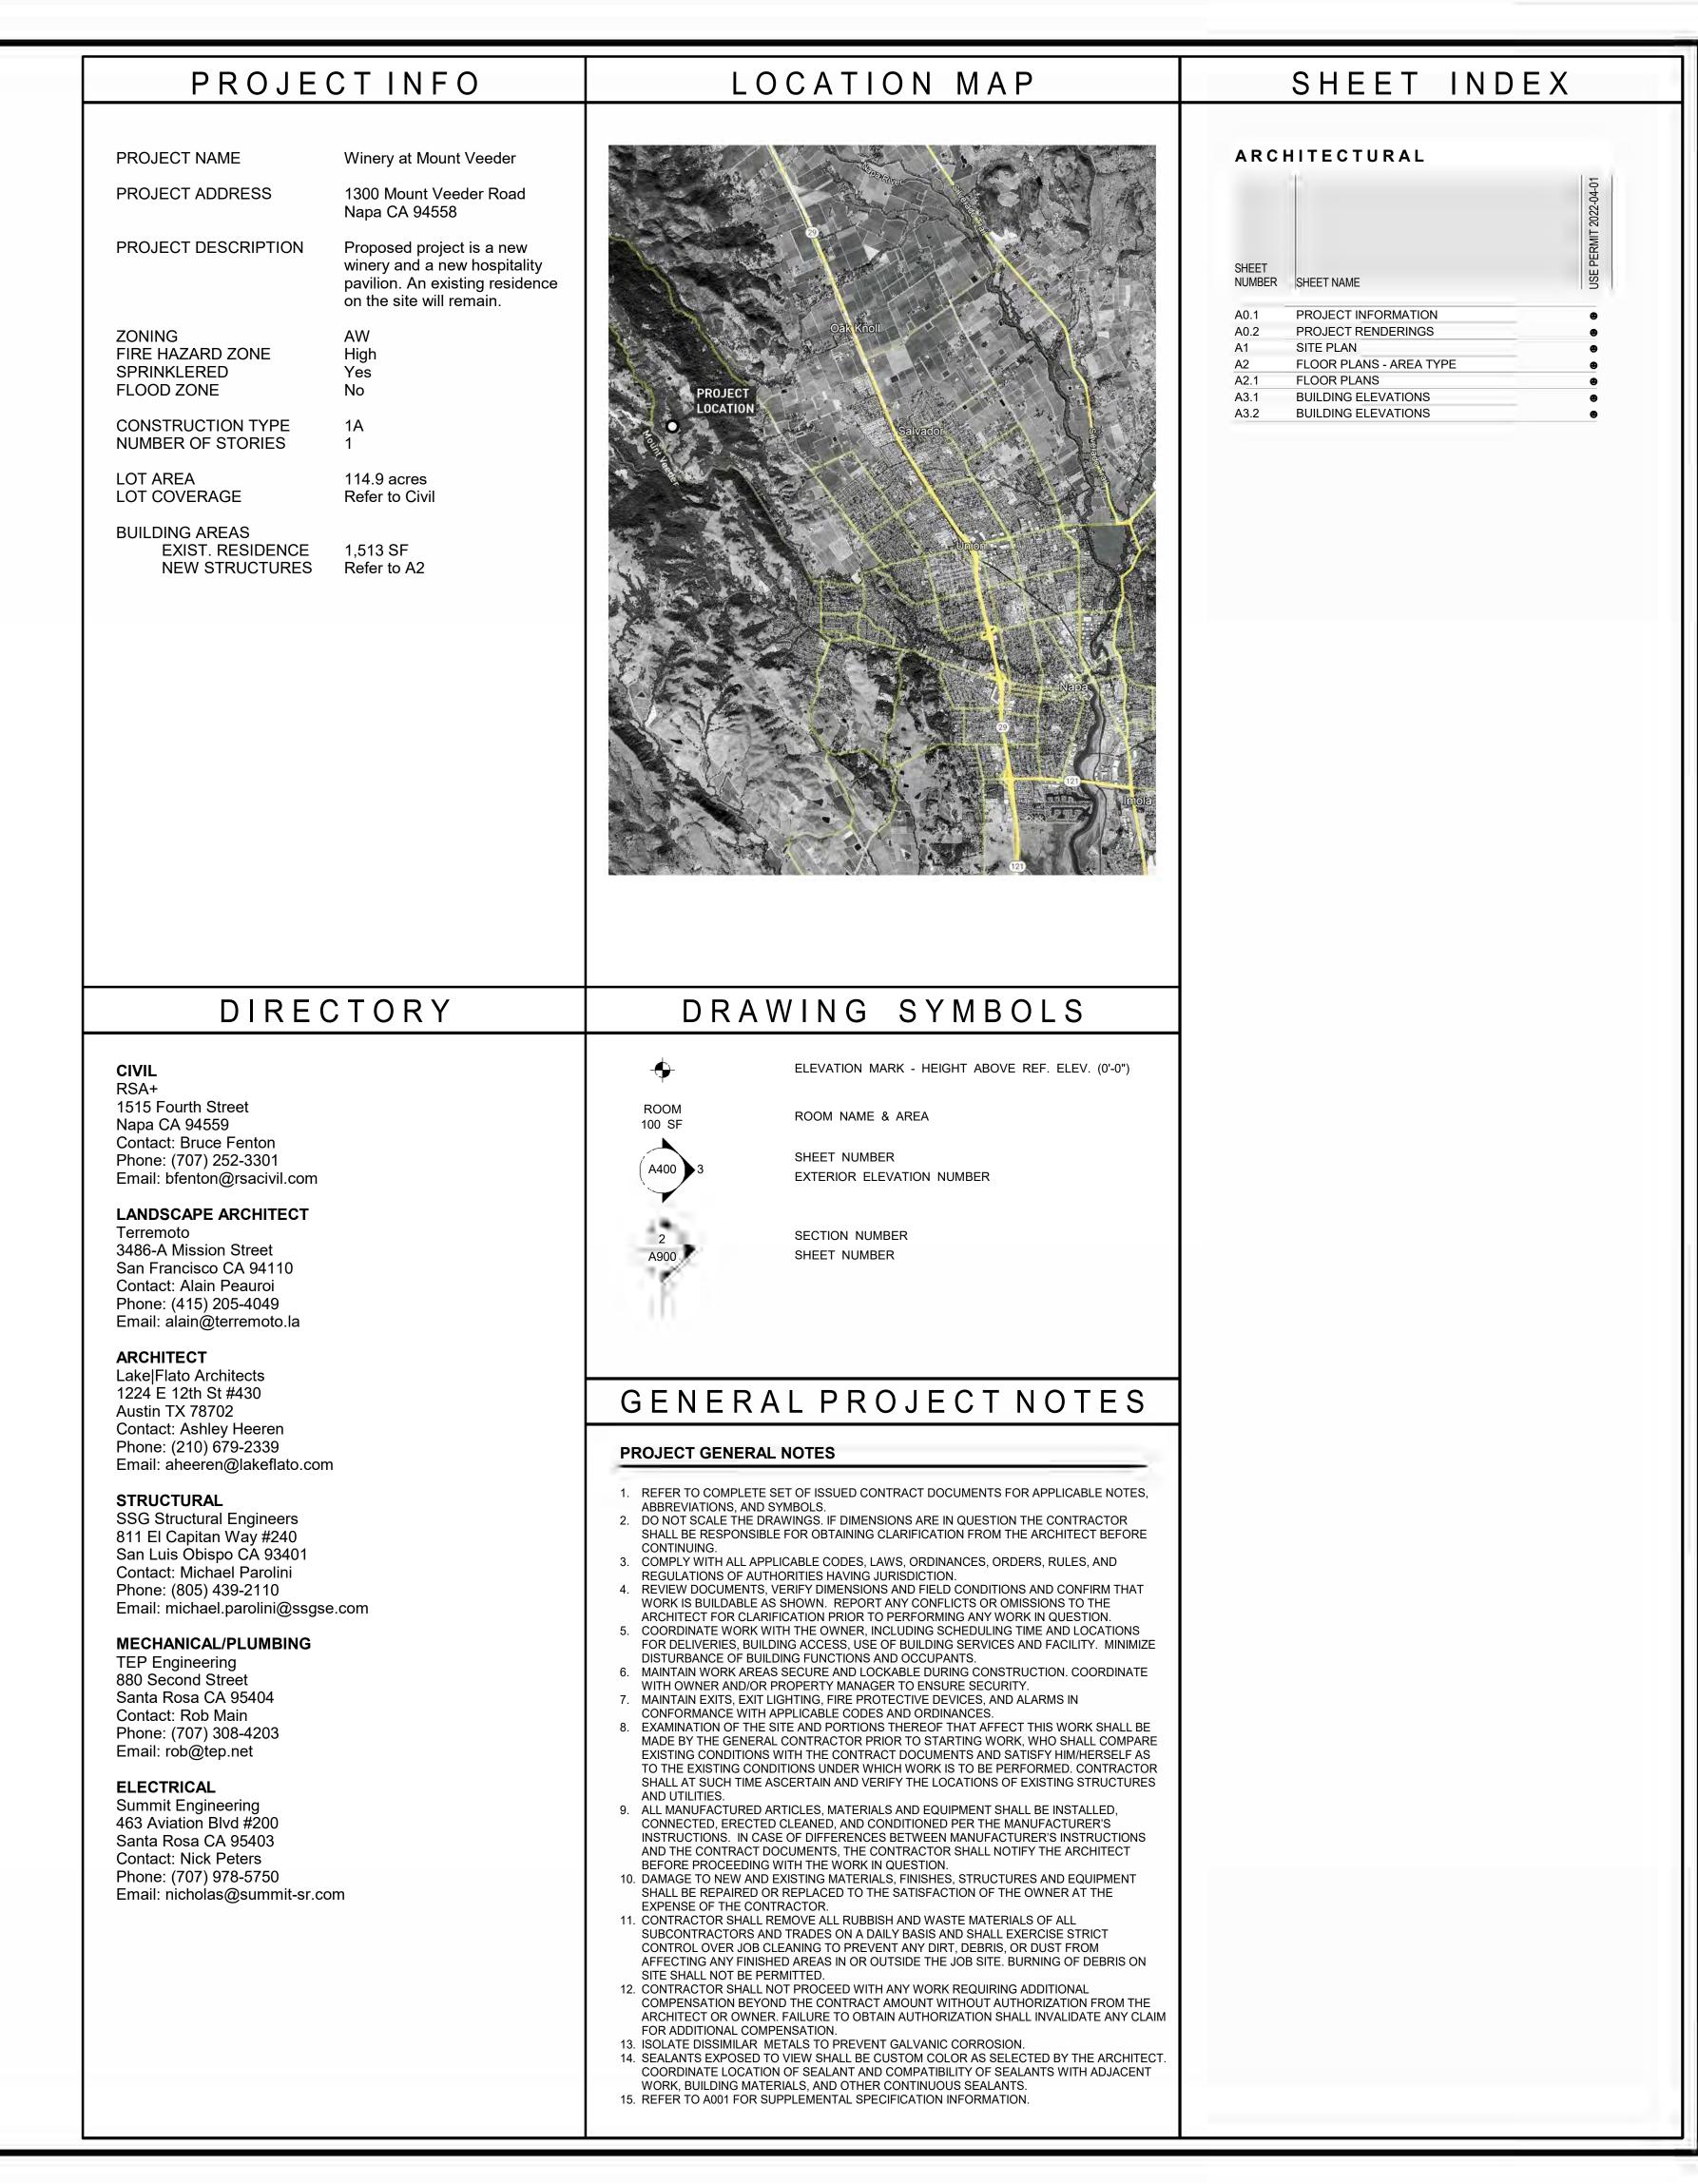

© 2021 Lake|Flato Architects, Inc.

311 THIRD STREET

SAN ANTONIO, TEXAS 78205
P210.227.3335 F210.224.9515
www.lakeflato.com

NOT FOR CONSTRUCTION

WINERY AT MT. VEEDER

1300 Mount Veeder Napa CA 94558

> THIS SQUARE APEARS 1/2"x1/2" ON FULL SIZE SHEETS

 12.23.2022
 L|F PROJ. NO.
 21002

 PROJ. ARCHITECT
 DRAWN BY:
 Author

SET ISSUE DATES

DATE ISSUE

05.31.2022 USE PERMIT

REVISIONS

NO. DATE DESCRIPTION

USE PERMIT


PROJECT INFORMATION

A0.1

12/23/2022 11:08:09 AM



3 RENDERING - PAVILION

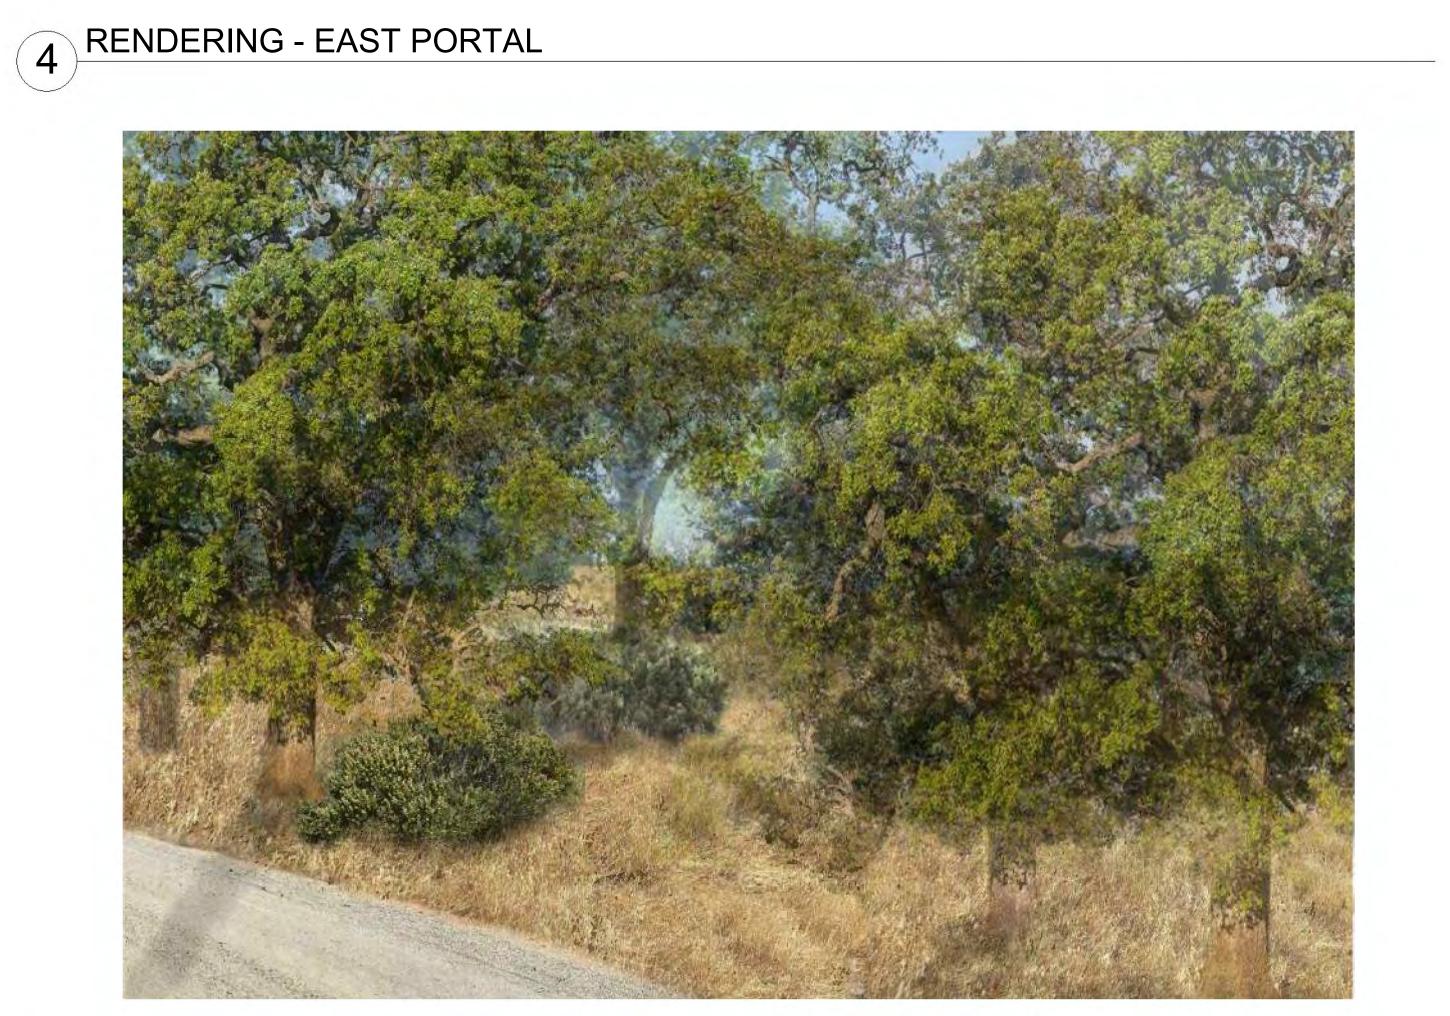



1 RENDERING - WEST PORTAL VIEW FROM REDWOOD ROAD

© 2021 Lake | FLATO
© 2021 Lake | Flato Architects, Inc.

311 THIRD STREET
SAN ANTONIO, TEXAS 78205
P210.227.3335 F210.224.9515
www.lakeflato.com

NOT FOR CONSTRUCTION

WINERY AT MT. VEEDER

1300 Mount Veeder Napa CA 94558

> THIS SQUARE APEARS 1/2"x1/2" ON FULL SIZE SHEETS

> > CHITECT - DRAWN BY:

DATE ISSUE DATES

05.31.2022 USE PERMIT


DESCRI

USE PERMIT

PROJECT RENDERINGS

A0.2

2 RENDERING - WEST PORTAL

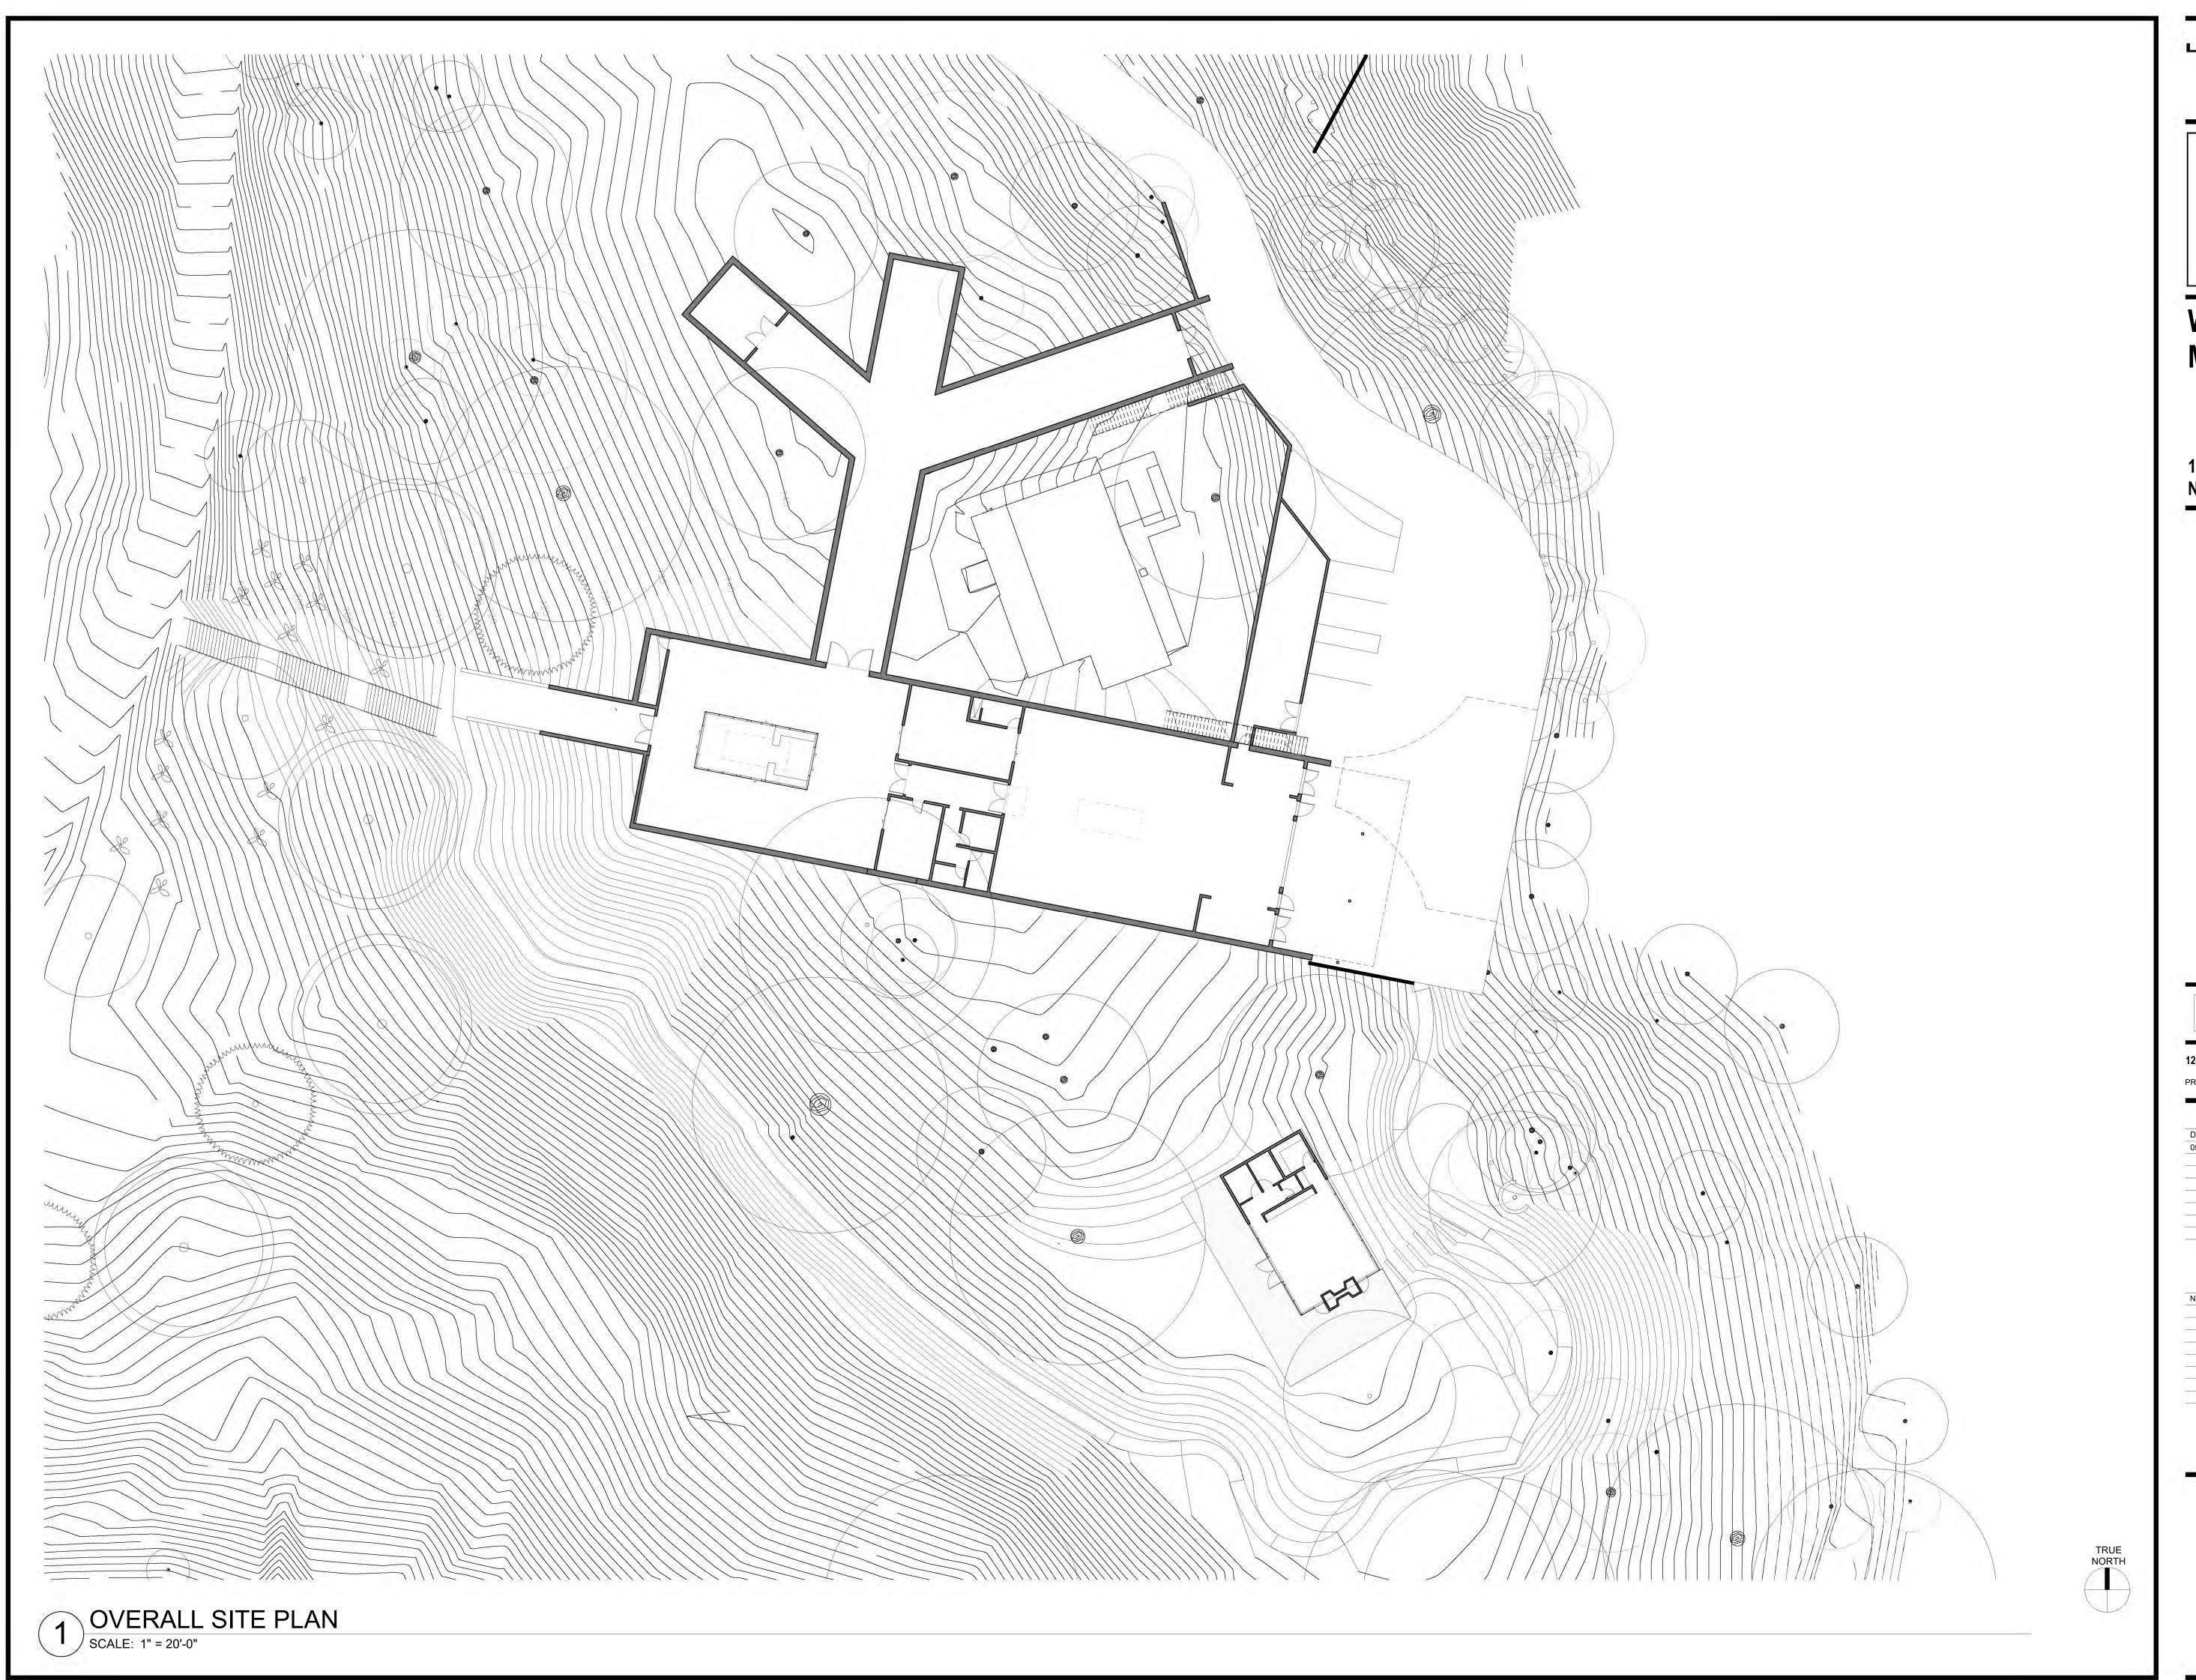

CAKE FLATO

© 2021 Lake|Flato Architects, Inc.

311 THIRD STREET

SAN ANTONIO, TEXAS 78205
P210.227.3335 F210.224.9515

www.lakeflato.com

NOT FOR CONSTRUCTION

WINERY AT MT. VEEDER

1300 Mount Veeder Napa CA 94558

> THIS SQUARE APEARS 1/2"x1/2" ON FULL SIZE SHEETS

 12.23.2022
 L|F PROJ. NO.
 21002

 PROJ. ARCHITECT DRAWN BY:
 Author

DATE ISSUE DATES

DATE ISSUE

05.31.2022 USE PERMIT

REVISIONS


NO. DATE DESCRIPTION

USE PERMIT

SITE PLAN

A1

12/23/2022 11:08:10 A

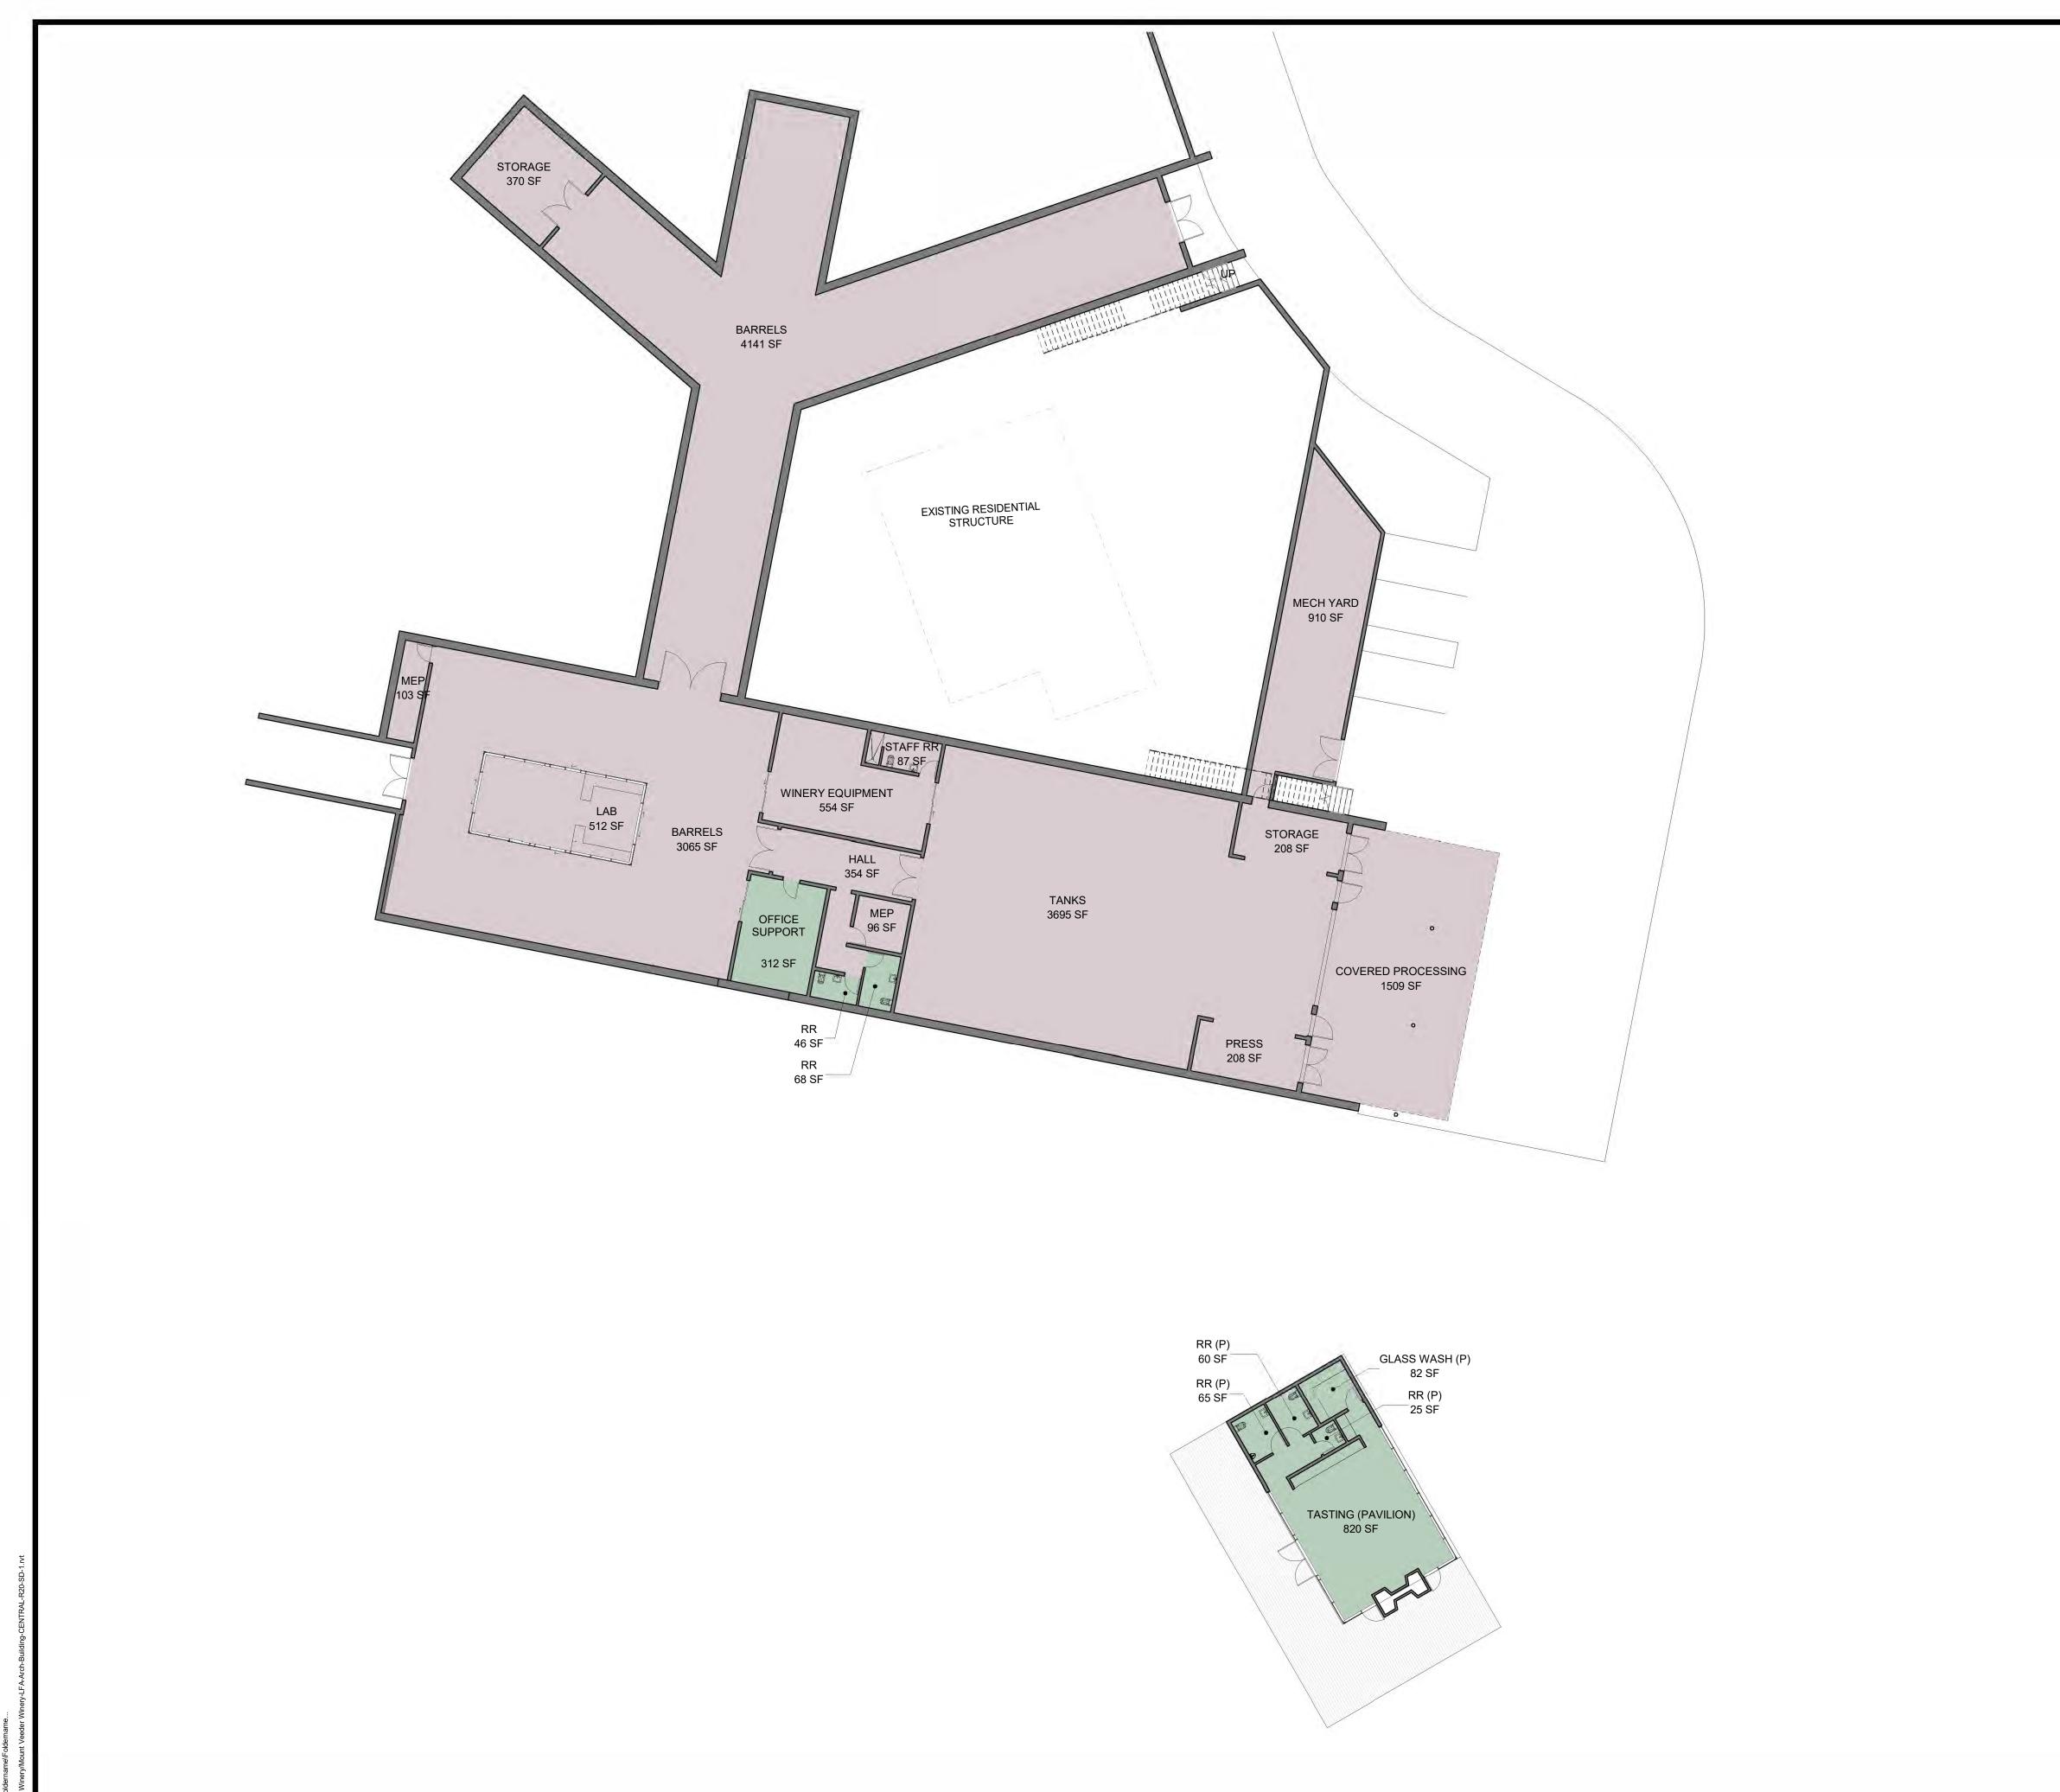

ACCESSORY AREA SUMMARY

OFFICE SUPPORT	312
RR	68
RR	46
GLASS WASH (P)	82
RR (P)	25
RR (P)	60
RR (P)	65
TASTING (PAVILION)	820
ACCESSORY CONDITIONED	1479

TOTAL ACCESSORY AREA:

1,479 SF

PRODUCTION AREA SUMMARY

BARRELS	3065 SF
BARRELS	4141 SF
HALL	354 SF
LAB	512 SF
MEP	103 SF
MEP	96 SF
PRESS	208 SF
STAFF RR	87 SF
STORAGE	208 SF
STORAGE	370 SF
TANKS	3695 SF
WINERY EQUIPMENT	554 SF
PRODUCTION CONDITIONED	13393 SF

PRODUCTION UNCONDITIONED	
COVERED PROCESSING	1509 S
MECH YARD	910 S
PRODUCTION UNCONDITIONED	2419 S

TOTAL PRODUCTION AREA: 15,812 SF

LEGEND - AREA TYPE

ACCESSORY USE

PRODUCTION USE

TRUE NORTH 12.23.2022 LJF PROJ. NO. 21002

THIS SQUARE APEARS 1/2"x1/2" ON FULL SIZE SHEETS

© 2021 Lake|Flato Architects, Inc.

311 THIRD STREET
SAN ANTONIO, TEXAS 78205
P210.227.3335 F210.224.9515
www.lakeflato.com

NOT FOR

CONSTRUCTION

WINERY AT

MT. VEEDER

1300 Mount Veeder

Napa CA 94558

PROJ. ARCHITECT - DRAWN BY: Author

SET ISSUE DATES

DATE ISSUE

05.31.2022 USE PERMIT

REVISIONS

NO. DATE DESCRIPTION


USE PERMIT

FLOOR PLANS -AREA TYPE

A2

1 FLOOR PLAN - AREA TYPE

SCALE: 1/16" = 1'-0"

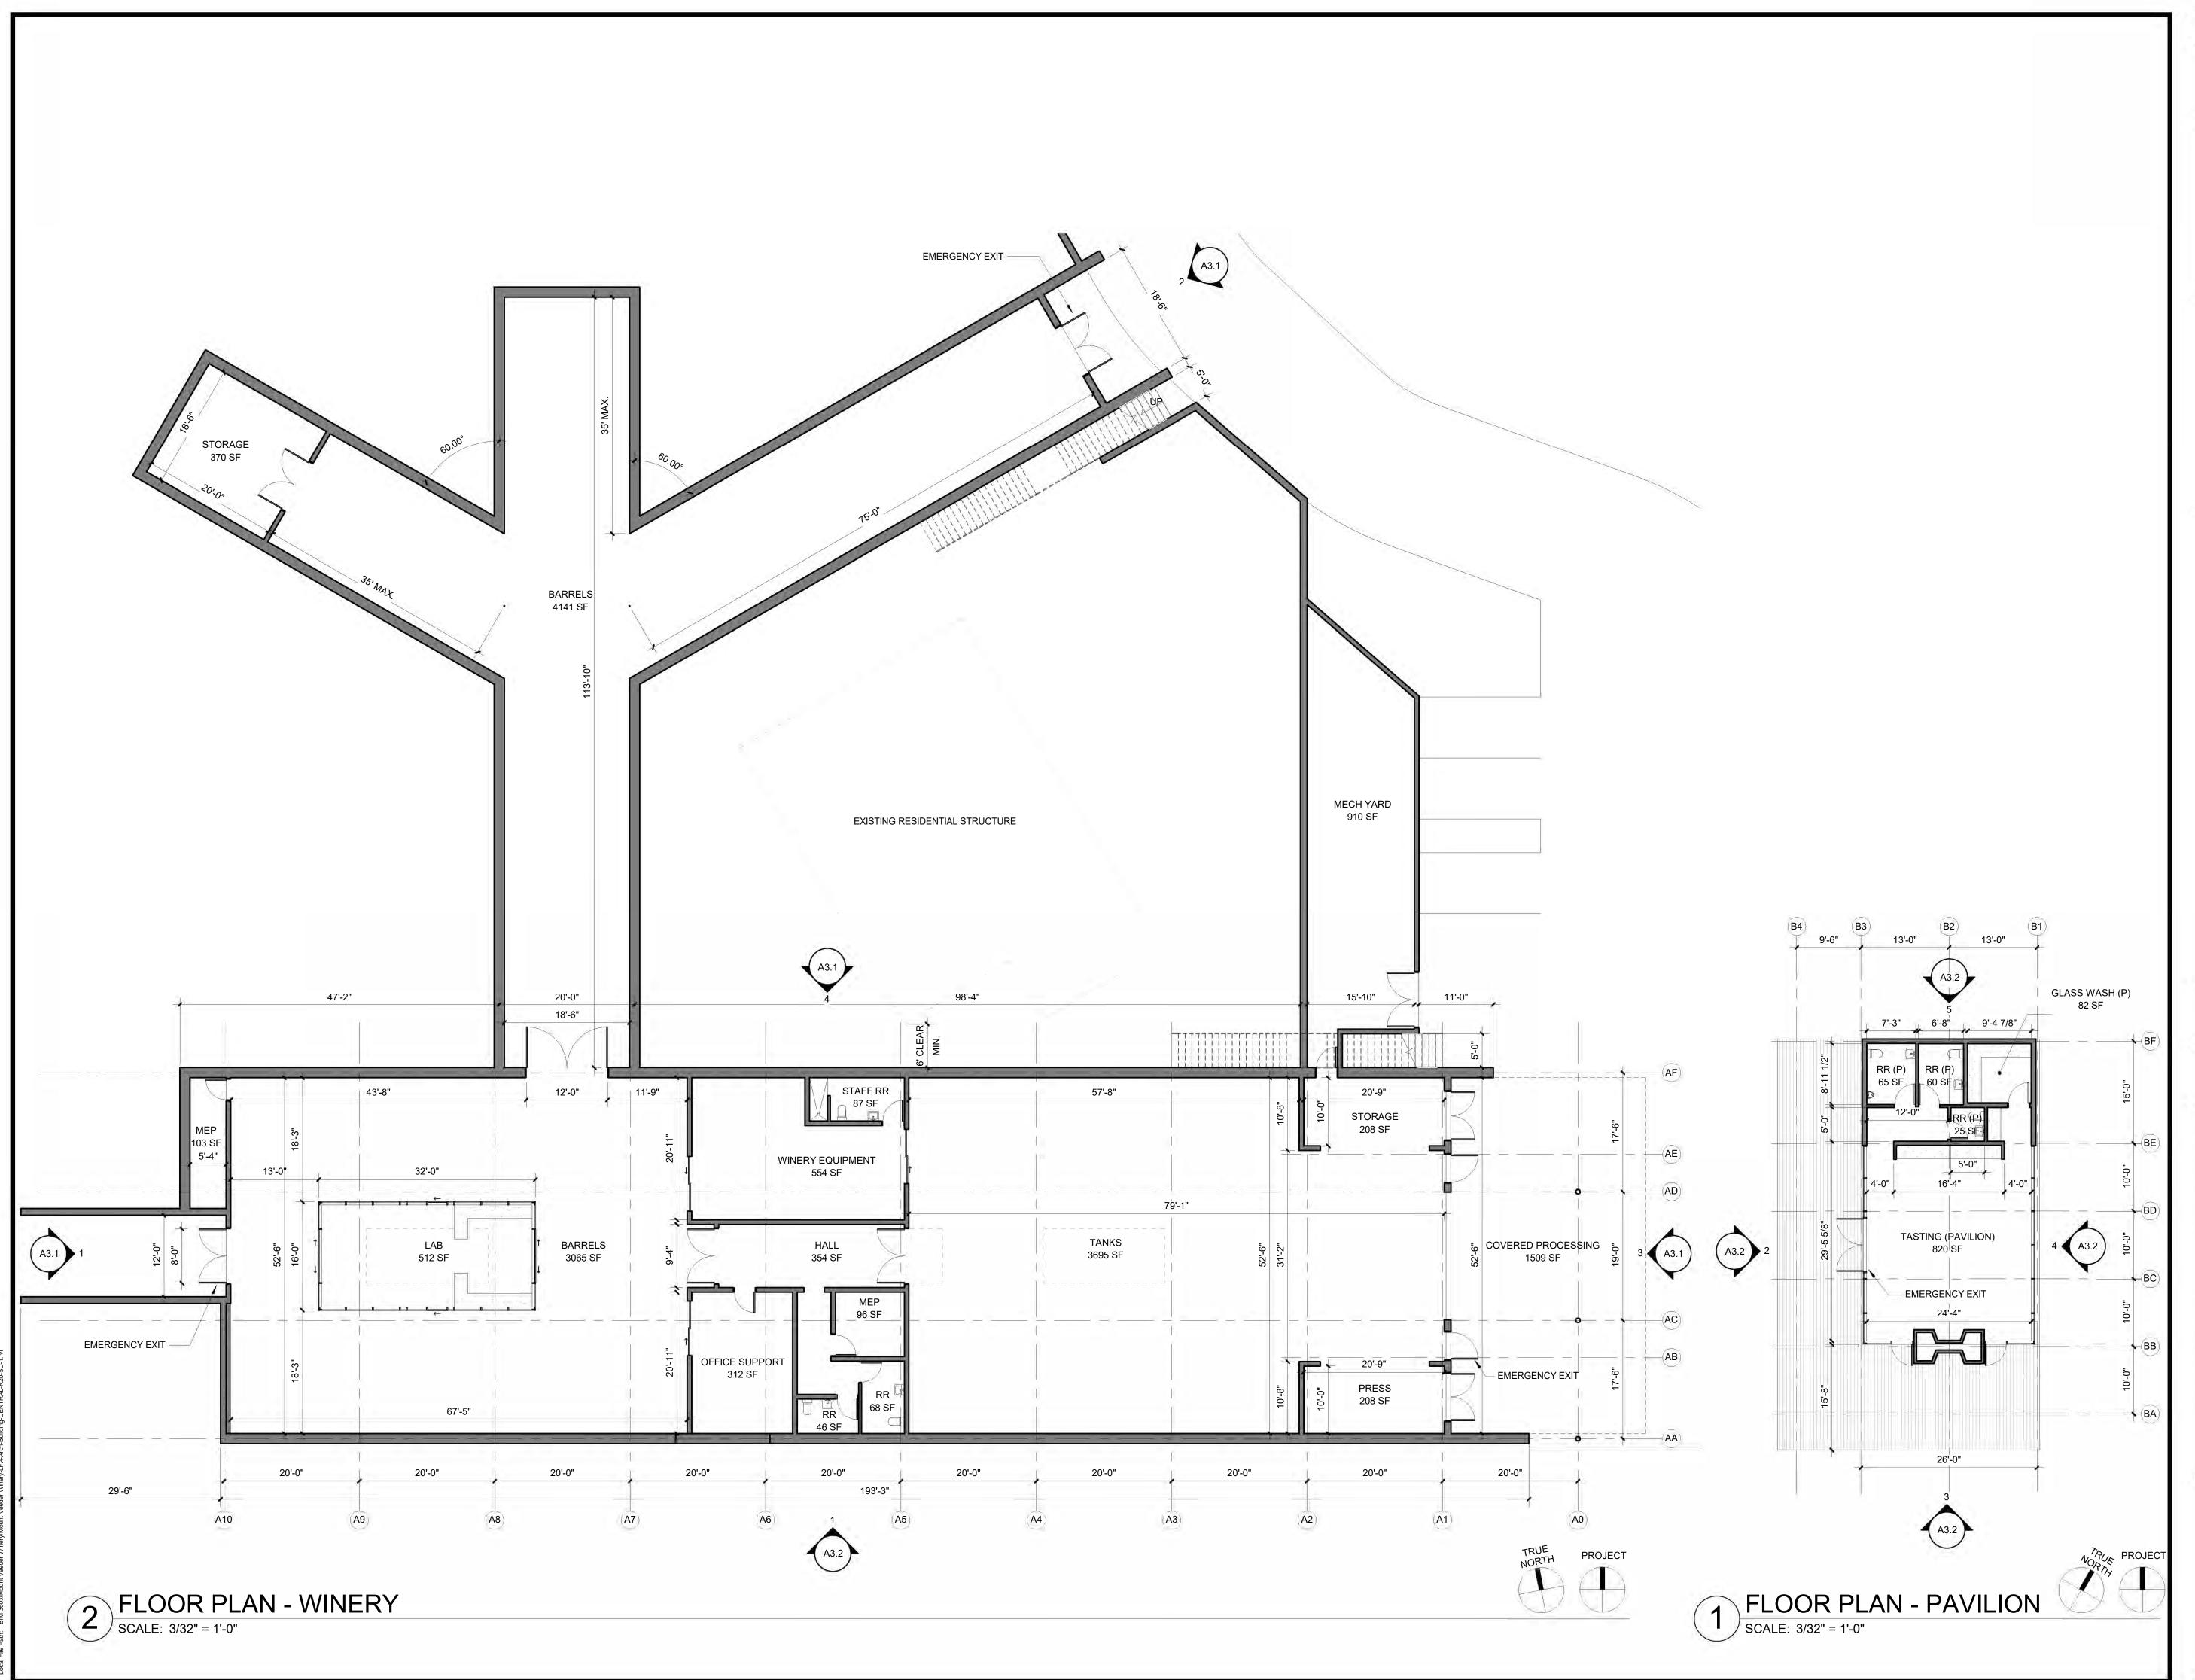

CAKE FLATO
© 2021 Lake|Flato Architects, Inc.

311 THIRD STREET
SAN ANTONIO, TEXAS 78205
P210.227.3335 F210.224.9515
www.lakeflato.com

NOT FOR CONSTRUCTION

WINERY AT MT. VEEDER

1300 Mount Veeder Napa CA 94558

> THIS SQUARE APEARS 1/2"x1/2" ON FULL SIZE SHEETS

 12.23.2022
 LJF PROJ. NO.
 21002

 PROJ. ARCHITECT DRAWN BY:
 Author

SET ISSUE DATES ATE ISSUE

05.31.2022 USE PERMIT

REVISIONS

NO. DATE DESCRIPTION

USE PERMIT

FLOOR PLANS

Δ21

12/23/2022 11:08:14



© 2021 Lake|Flato Architects, Inc.

311 THIRD STREET
SAN ANTONIO, TEXAS 78205
P210.227.3335 F210.224.9515
www.lakeflato.com

NOT FOR CONSTRUCTION

WINERY AT MT. VEEDER

1300 Mount Veeder Napa CA 94558

> THIS SQUARE APEARS 1/2"x1/2" ON FULL SIZE SHEETS

12.23.2022LJF PROJ. NO.21002PROJ. ARCHITECT-DRAWN BY:Author

SET ISSUE DATES

DATE ISSUE


05.31.2022 USE PERMIT

NO. DATE DESCRIPTION

USE PERMIT

BUILDING ELEVATIONS

A3.1

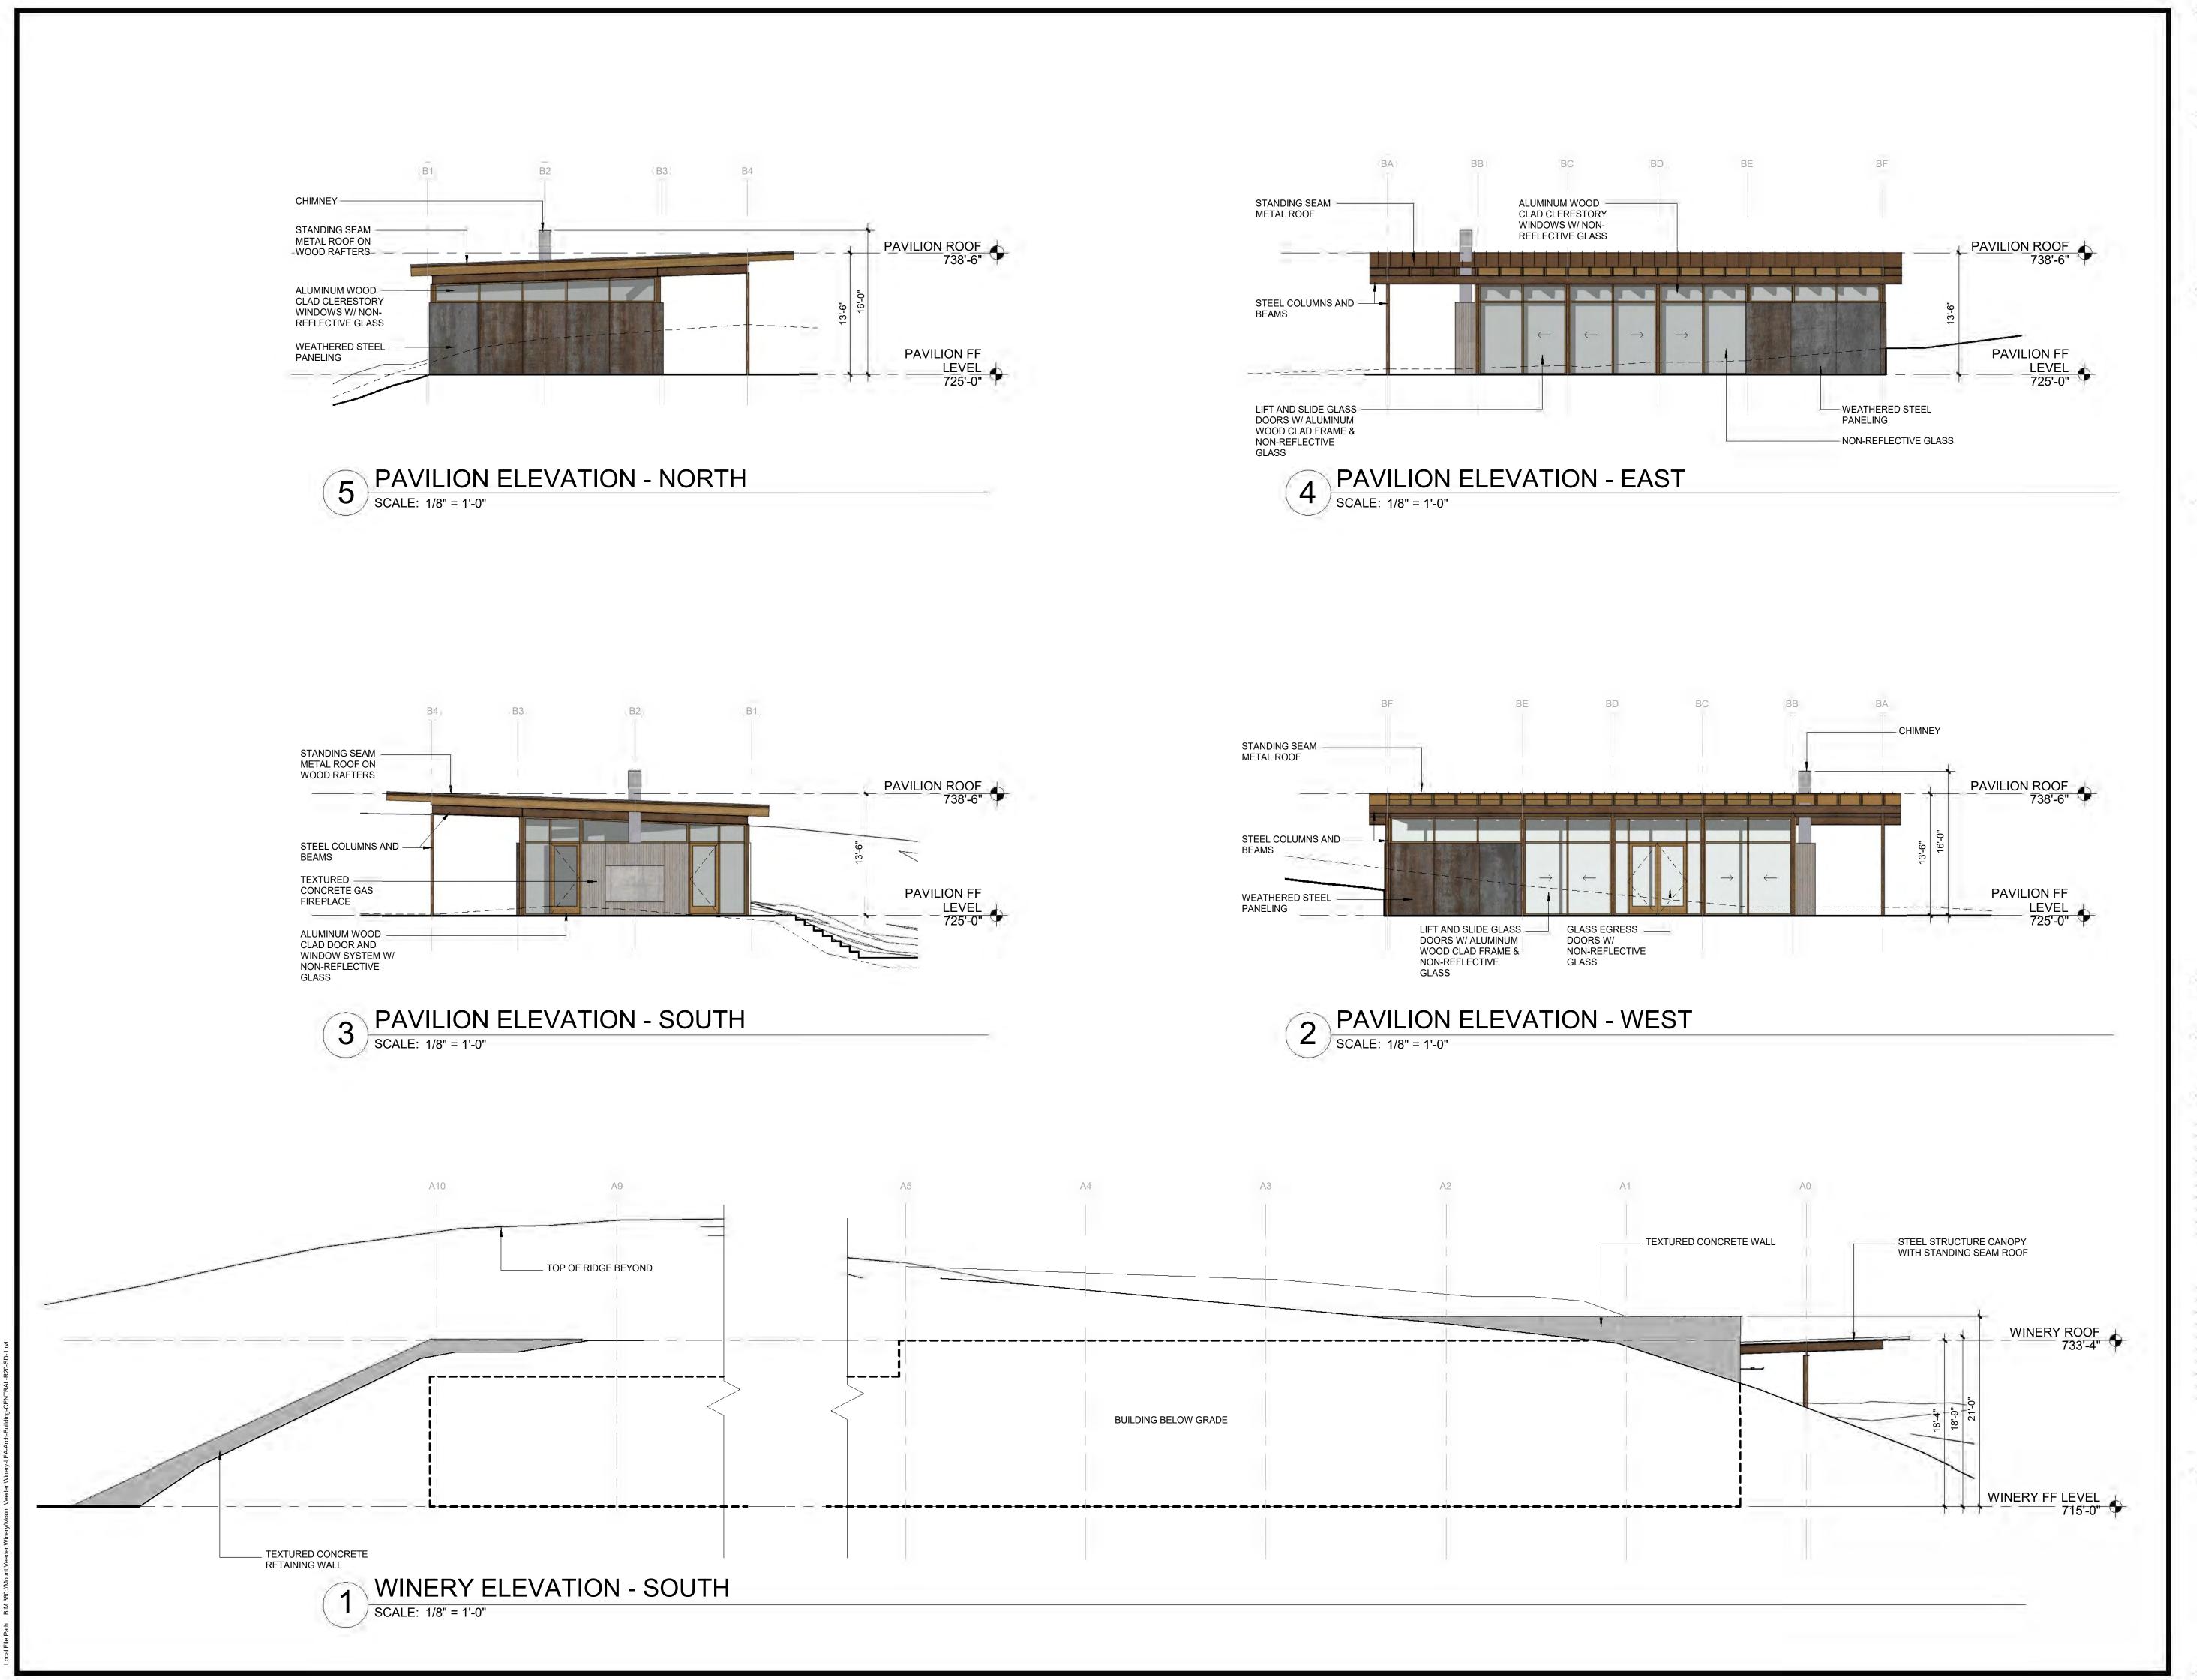

© 2021 Lake|Flato Architects, Inc.

3 11 THIRD STREET
SAN ANTONIO, TEXAS 78205
P 210. 2 27. 3 3 3 5 F 2 1 0. 2 2 4. 9 5 1 5
www.lakeflato.com

NOT FOR CONSTRUCTION

WINERY AT MT. VEEDER

1300 Mount Veeder Napa CA 94558

> THIS SQUARE APEARS 1/2"x1/2" ON FULL SIZE SHEETS

 12.23.2022
 LJF PROJ. NO.
 21002

 PROJ. ARCHITECT DRAWN BY:
 Author

SET ISSUE DATES

DATE ISSUE

05.31.2022 USE PERMIT

REVISIONS

NO. DATE DESCRIPTION

USE PERMIT

BUILDING ELEVATIONS

A3.2

12/23/2022 11:08:15