






Appendix G


Project Plans

Steeno Designs

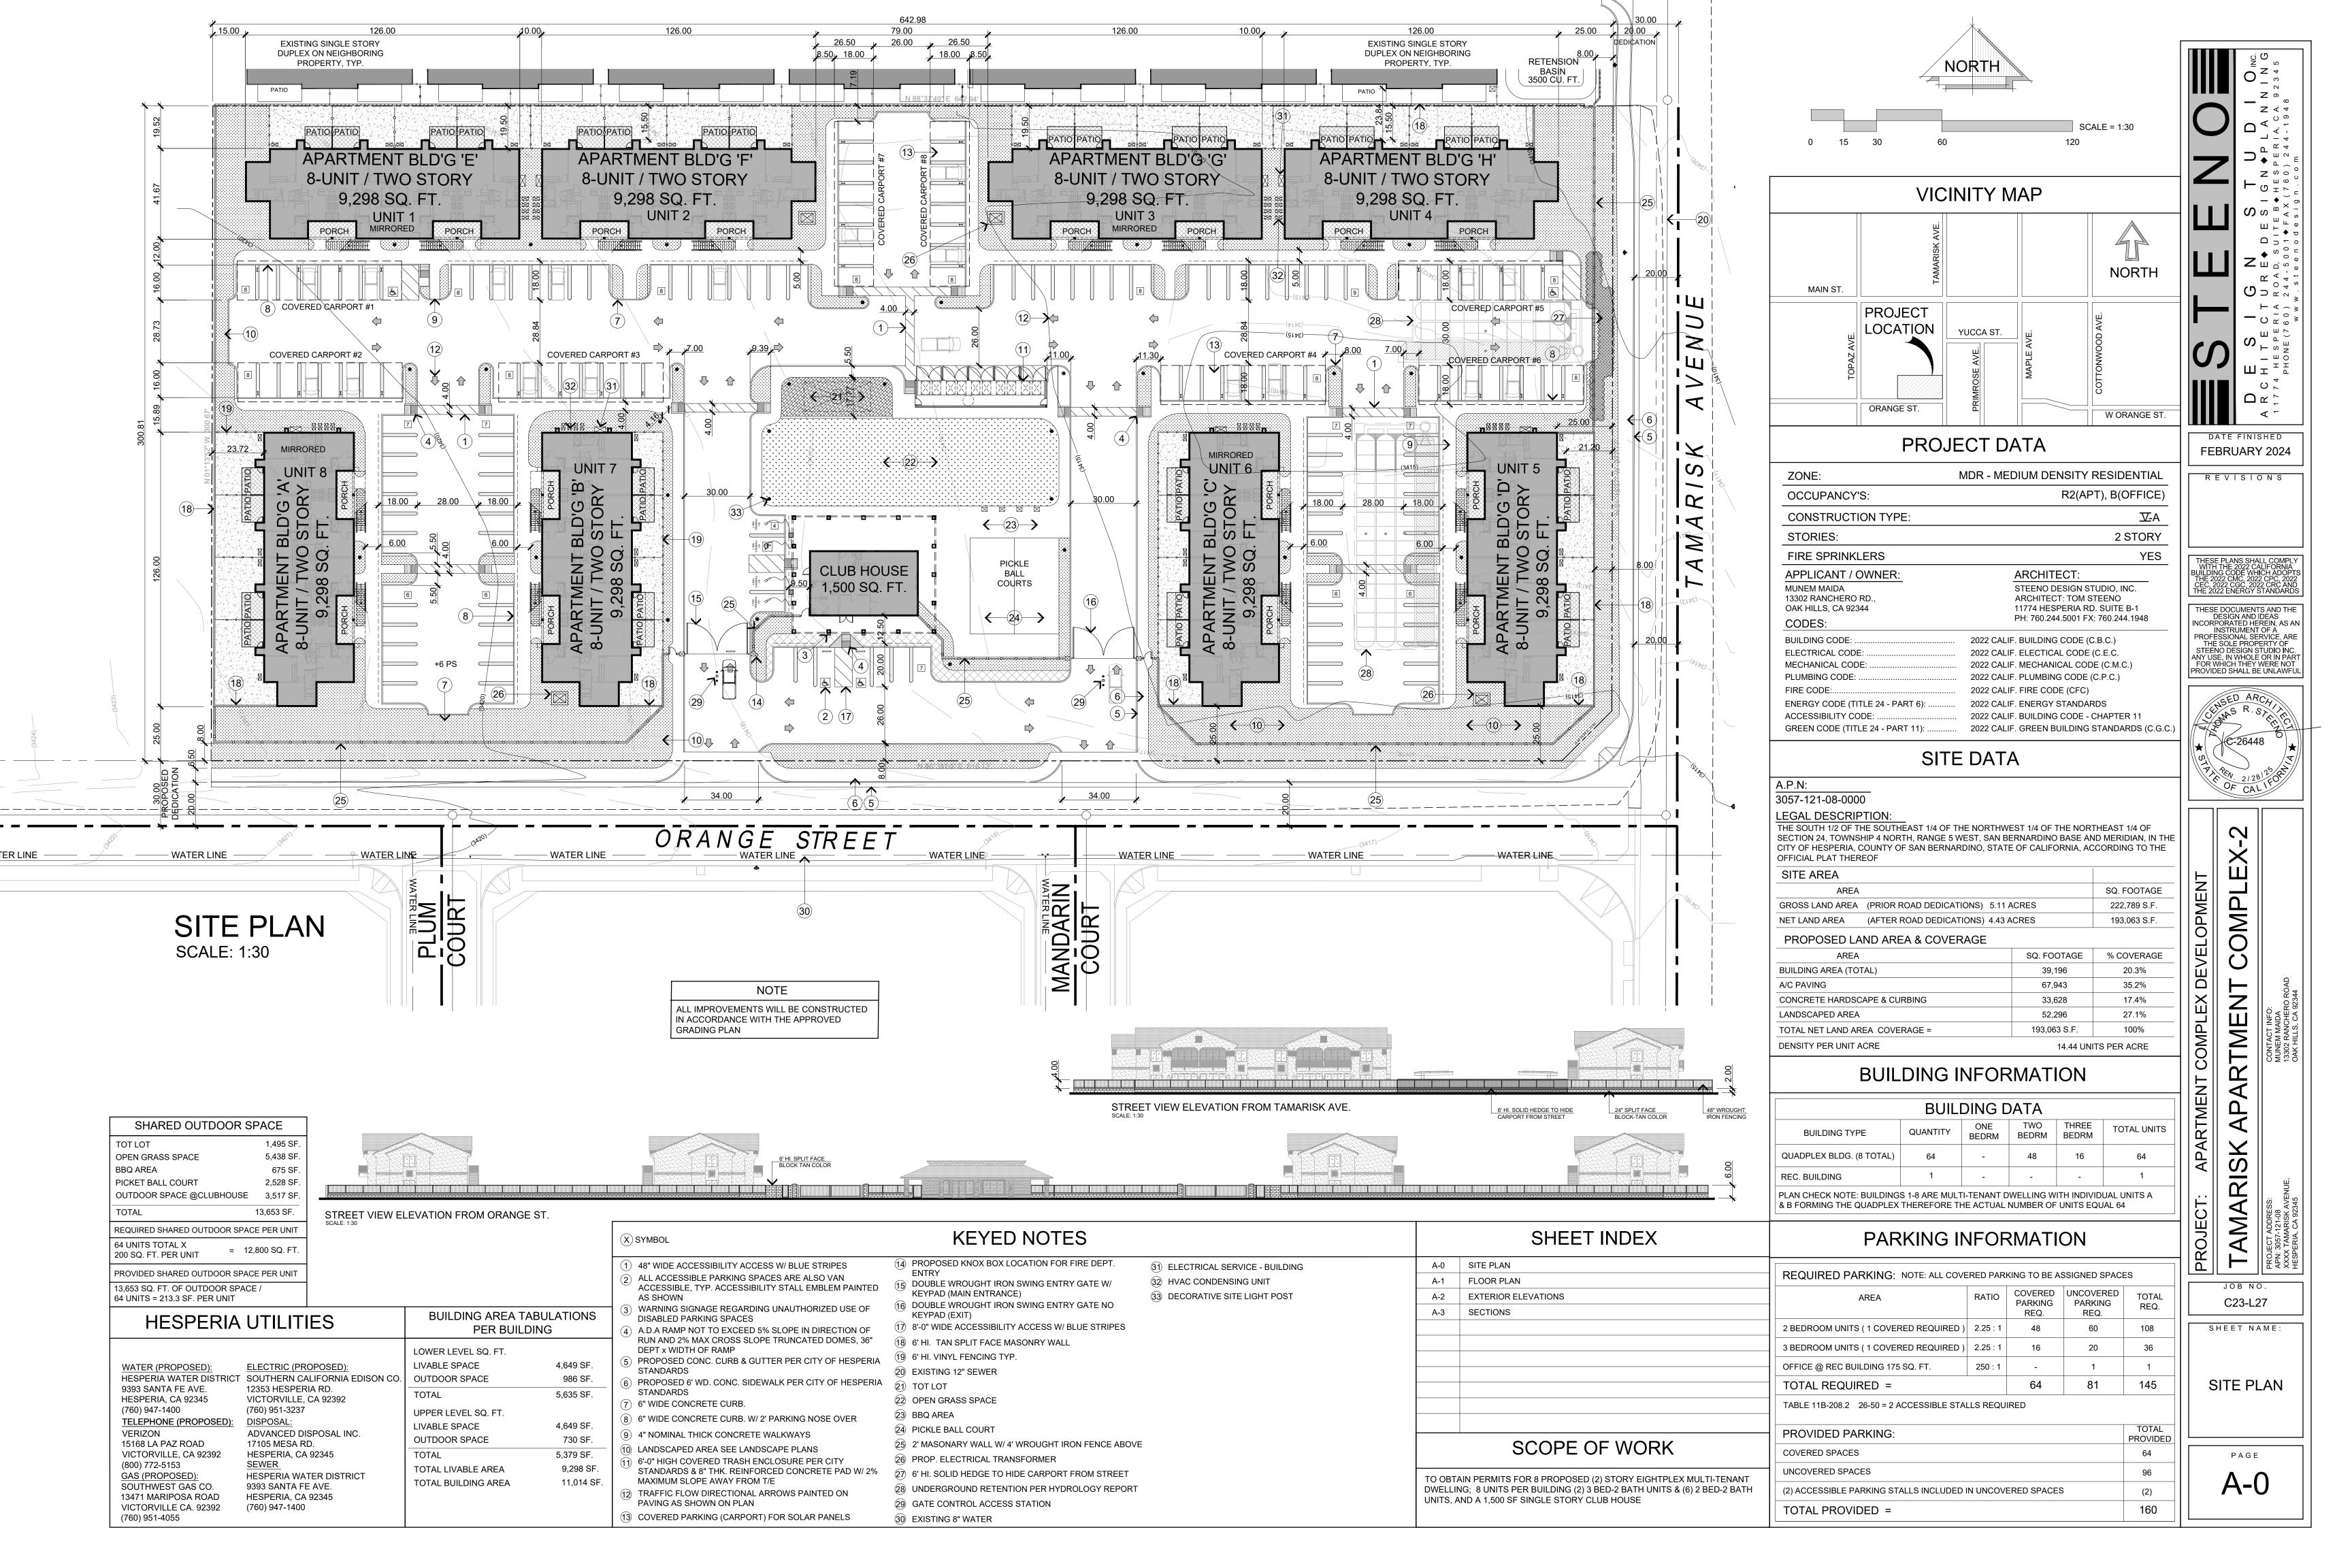

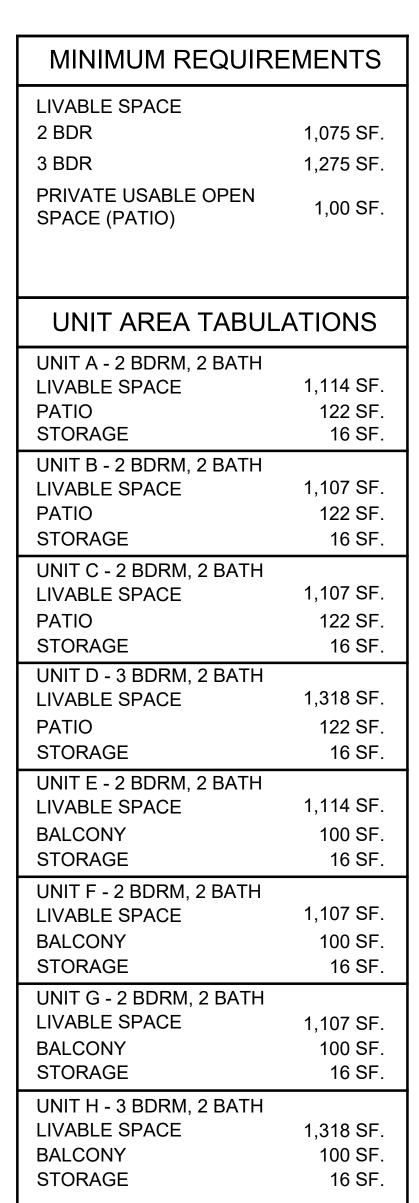

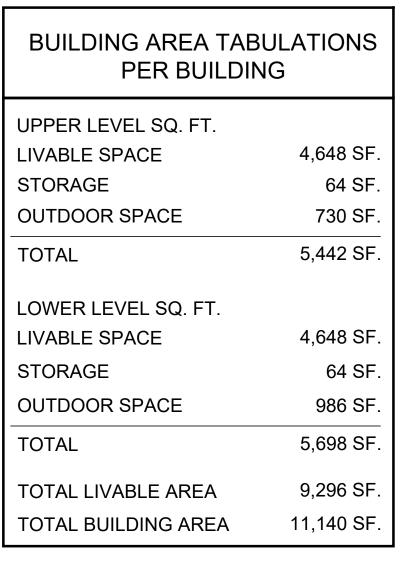

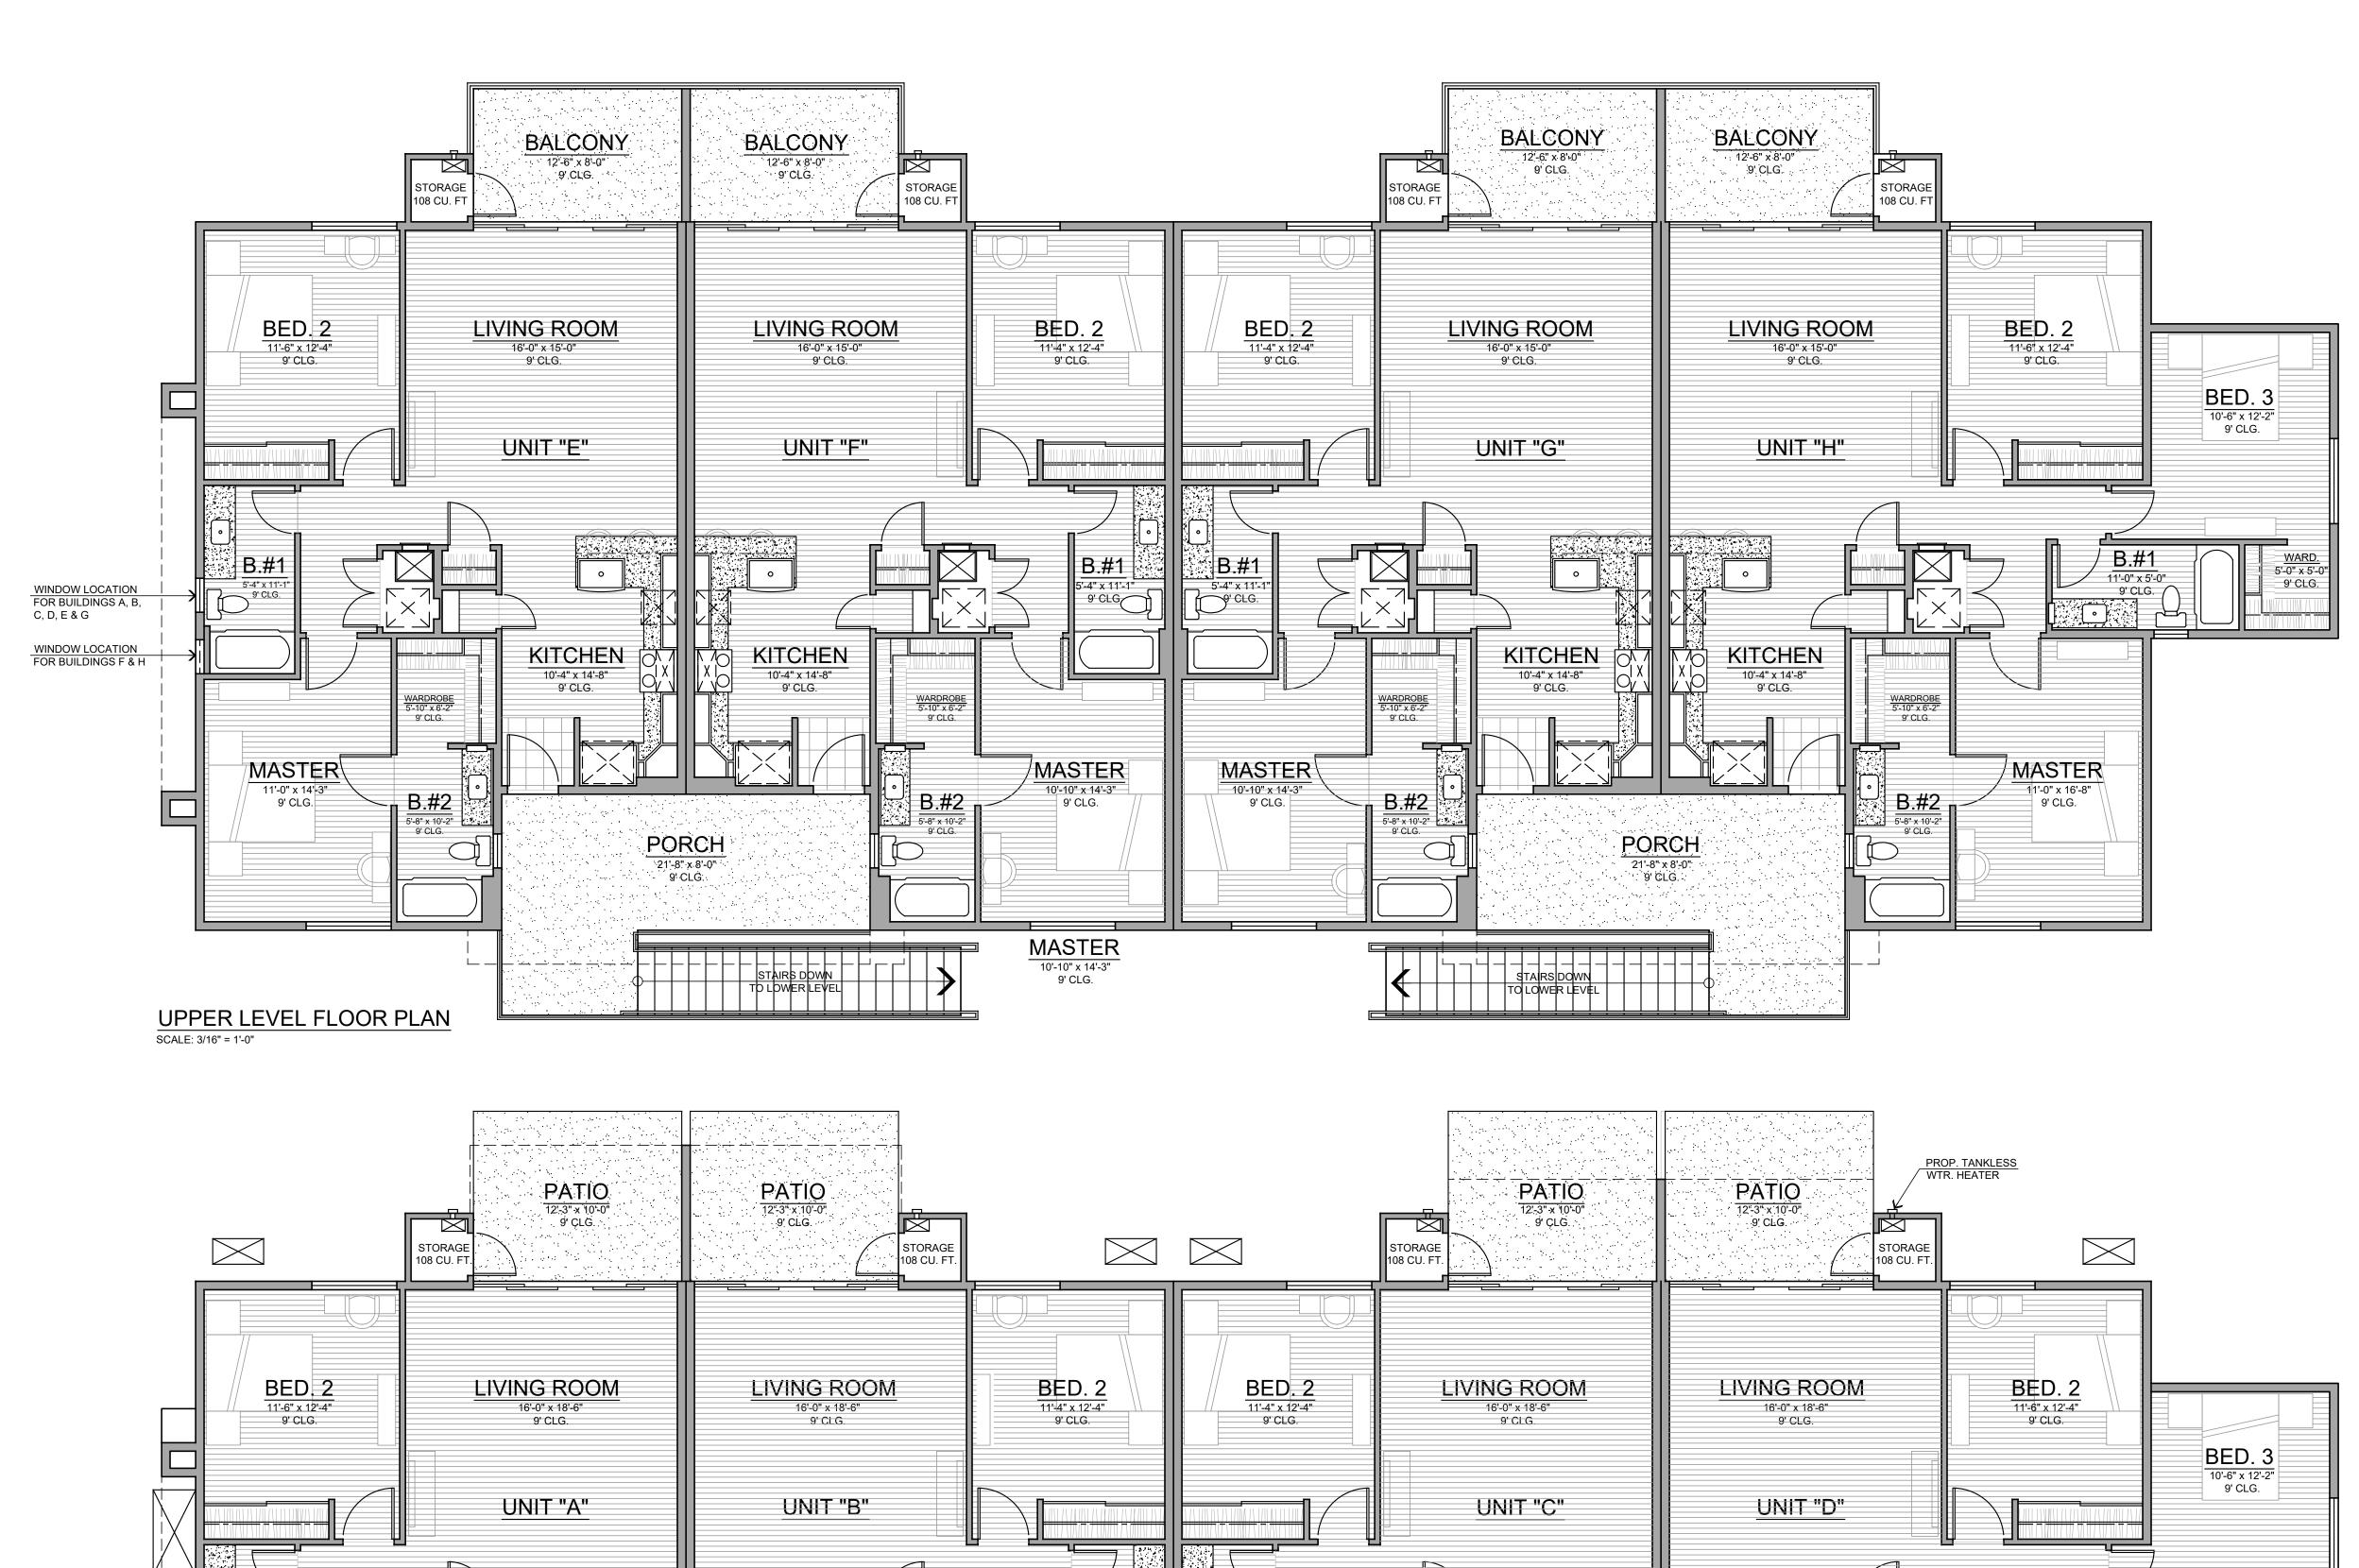

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DATE FINISHED

FEBRUARY 2024

REVISIONS

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COMPLE

ARTMENT

TAMARISK

C21-L25


SHEET NAME:

FLOOR PLAN

PAGE

A-1



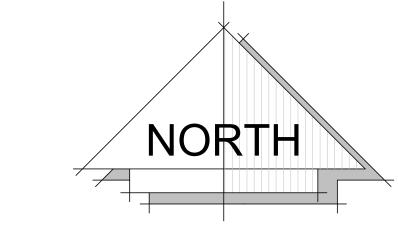


FEBRUARY 2024

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C23-L27

FLOOR PLAN

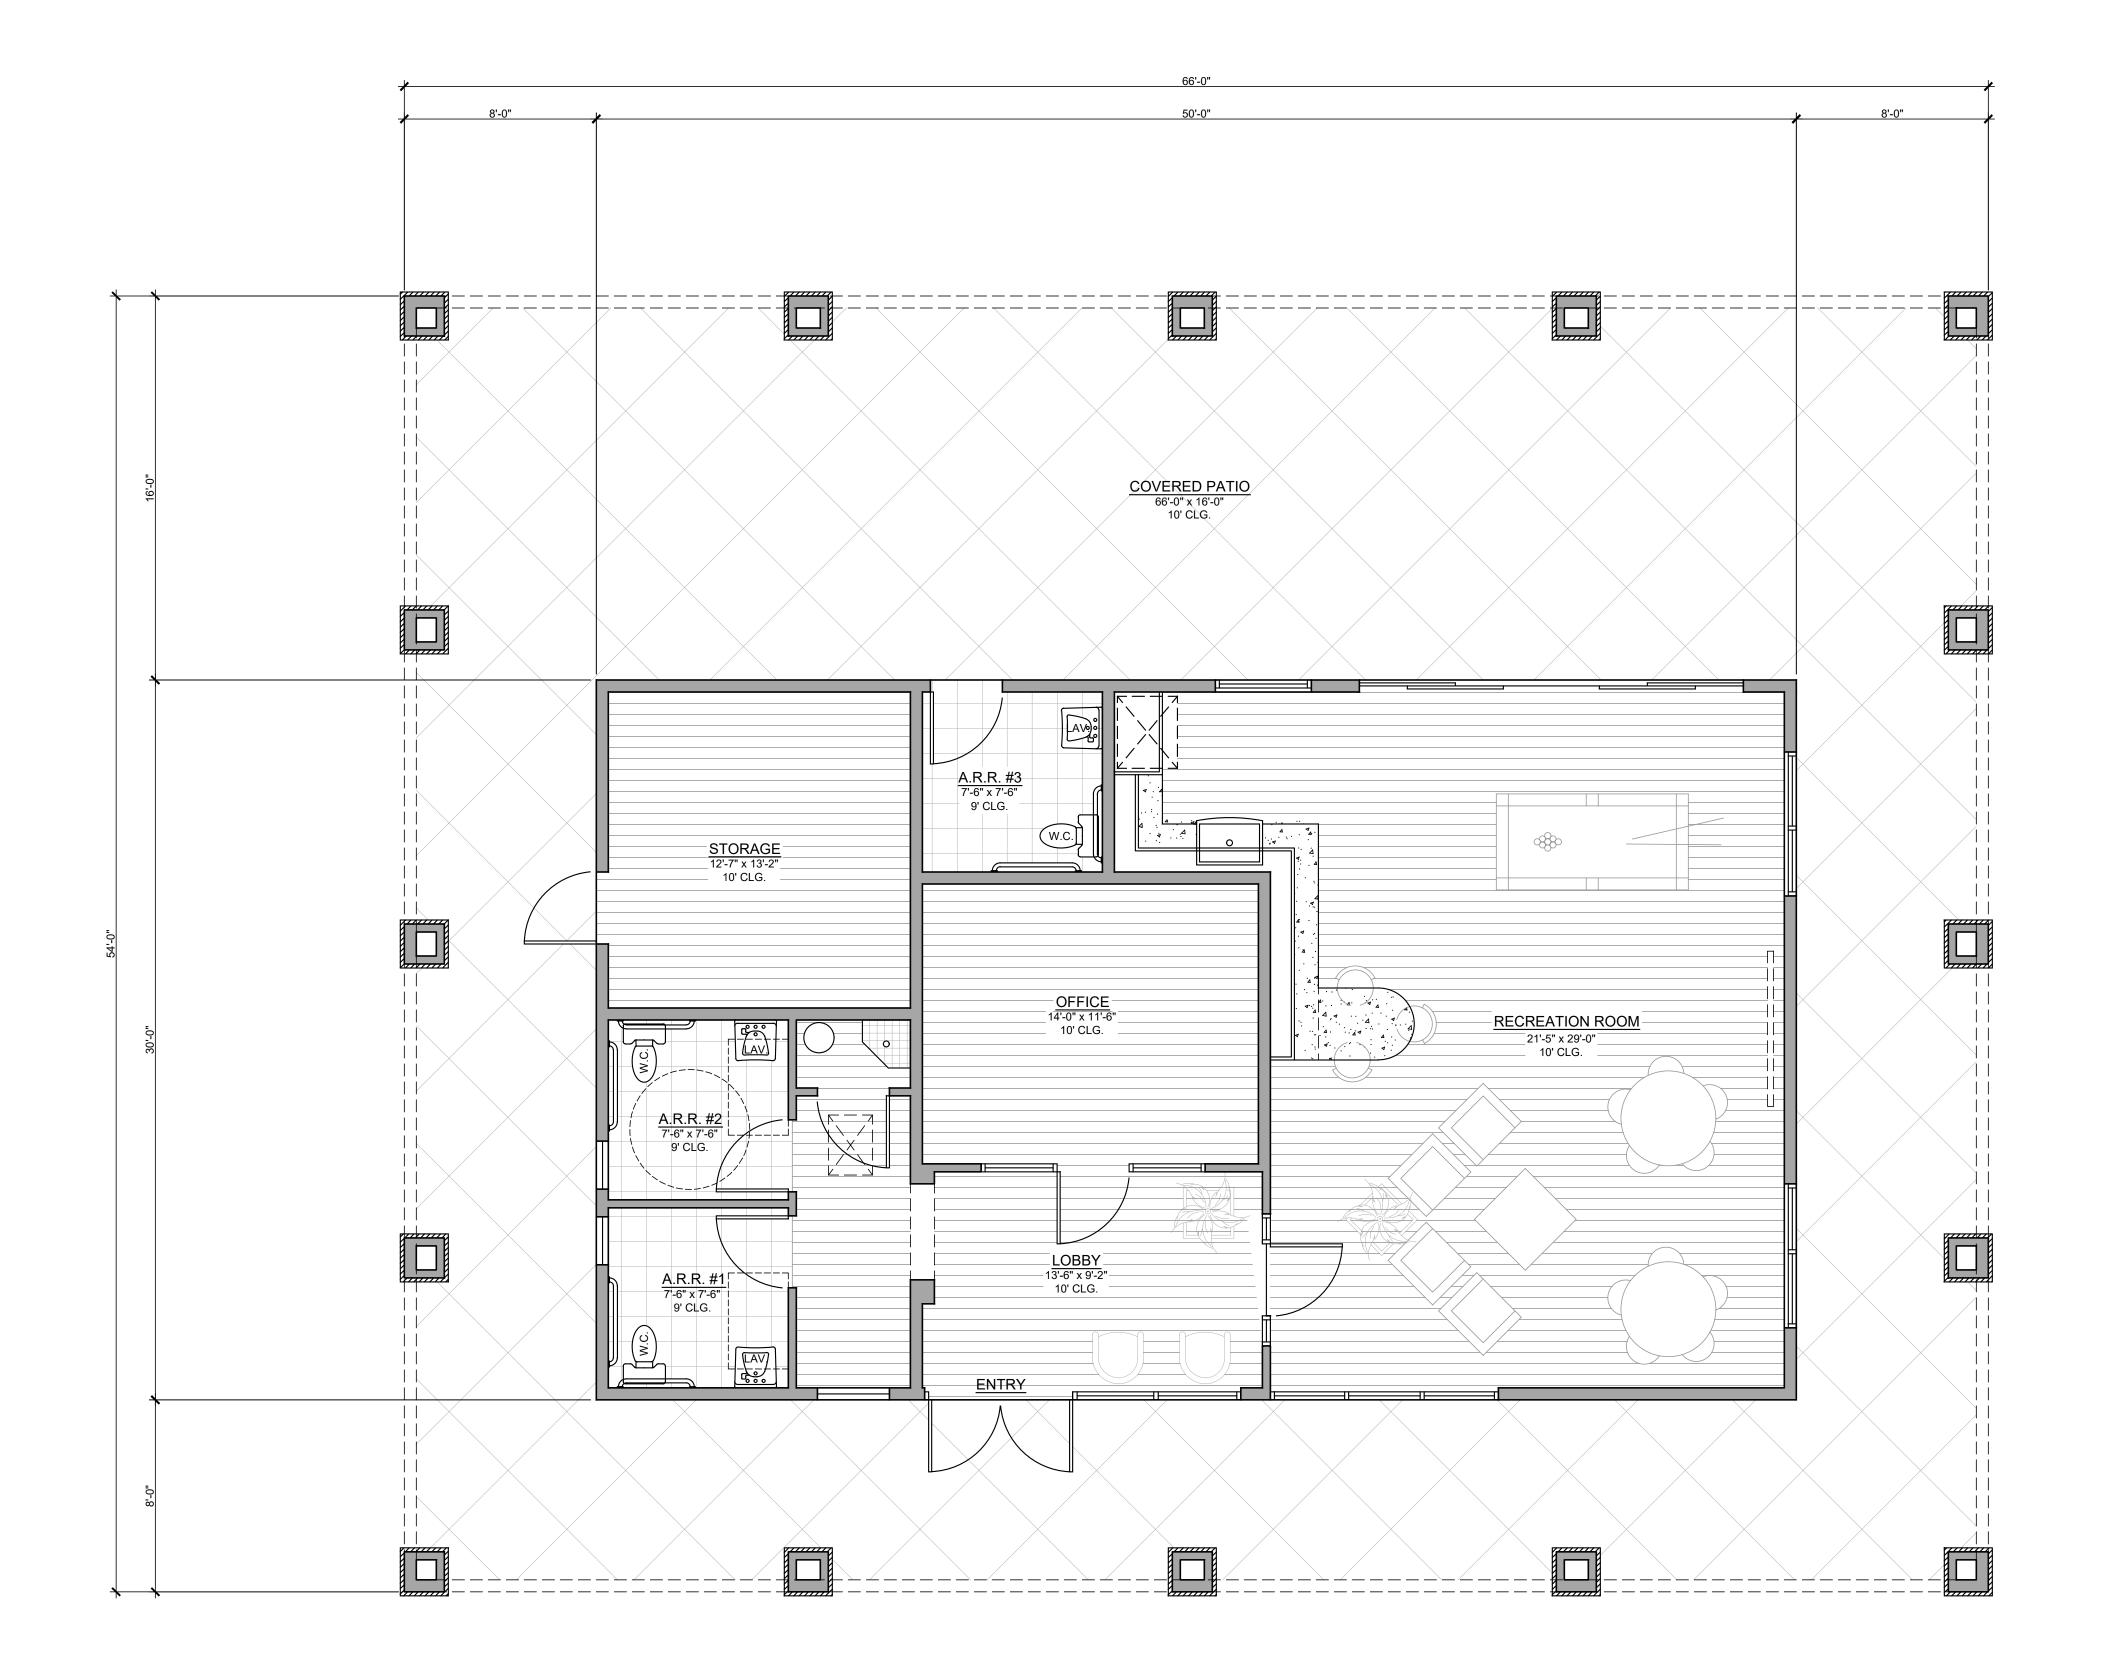

CLUB HOUSE FLOOR PLAN - 1,500 SQ. FT. SCALE: 1/4" = 1'-0"


CLUB HOUSE

TAMARISK APARTMENT COMPLEX

AREA TABU	LATION
RECREATION ROOM	= 716 SQ.FT.
OFFICE	= 175 SQ.FT.
LOBBY	= 141 SQ. FT
STORAGE	= 186 SQ.FT
A.R.R. 1	= 67 SQ. FT
A.R.R. 2	= 65 SQ.FT.
A.R.R. 3	= 68 SQ.FT.
HALLWAY	= 66 SQ.FT.
JANITOR CLOSET	= 16 SQ.FT.
TOTAL BUILDING	= 1,500 SQ.FT
COVERED PATIO	= 2,064 SQ.FT
GROSS BLDG.	= 3,564 SQ.FT



LASER CUT METAL SCREEN PANEL COLOR: BLUE

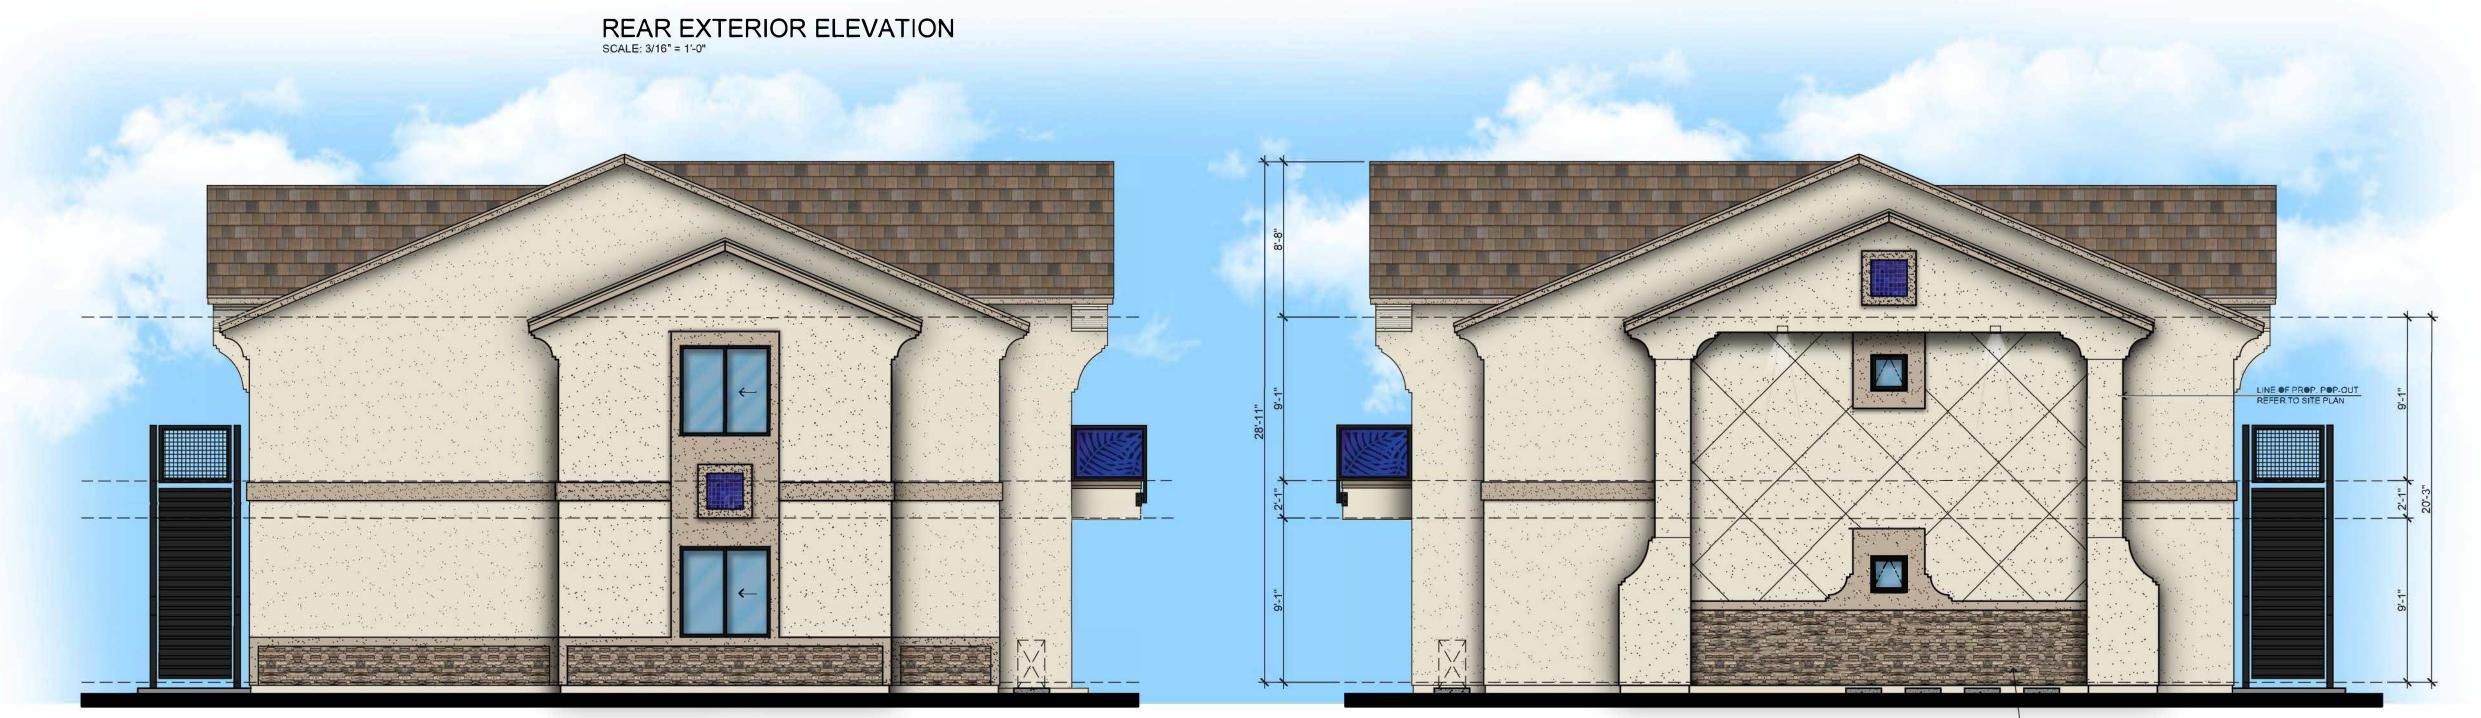

LEFT EXTERIOR ELEVATION SCALE: 3/16" = 1'-0"

STONE VENEER W/ 2X6
STUCCOED TRIM

FEBRUARY 2024

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APARTMENT COMPLEX - MULTI STORY - 8 UNIT TAMARISK APARTMENT COMPLEX-2

PROJECT ADDRESS:
APN: 3057-121-08

XXXX TAMARISK AVENUE,
HESPERIA, CA 92345

OAK HILLS, CA 92344

C21-L25

EXTERIOR ELEVATIONS


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SCALE: 3/16" = 1'-0"






REAR -NORTH ELEVATION SCALE: 1/4" = 1'-0"

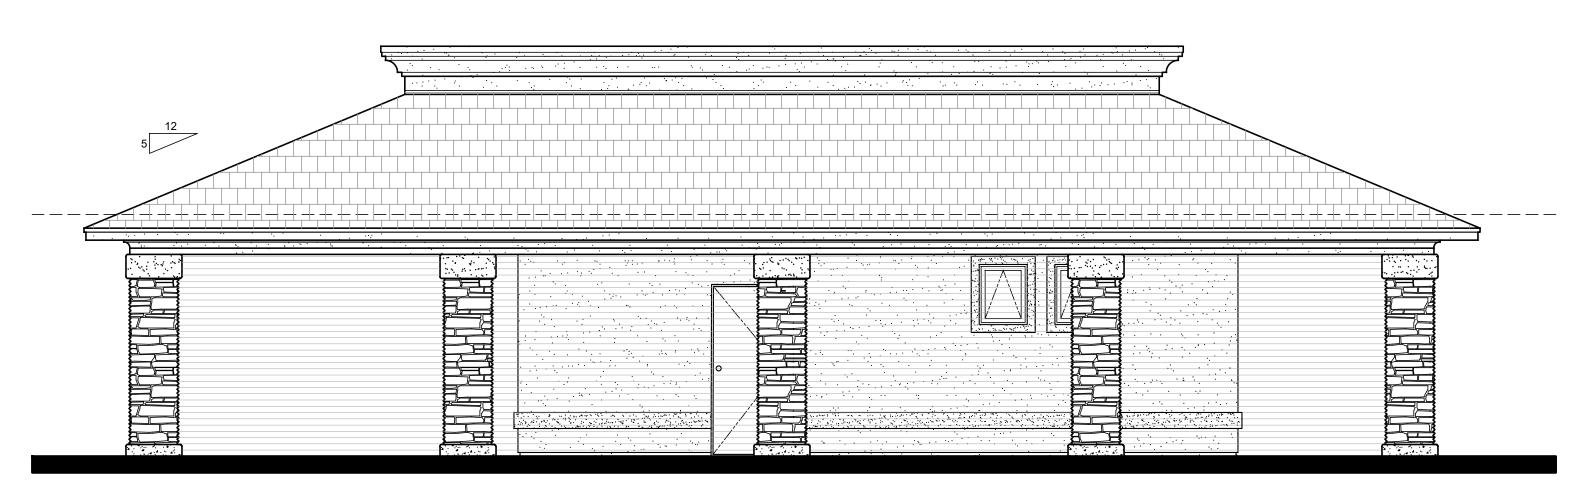

LEFT - WEST ELEVATION

SCALE: 1/4" = 1'-0"

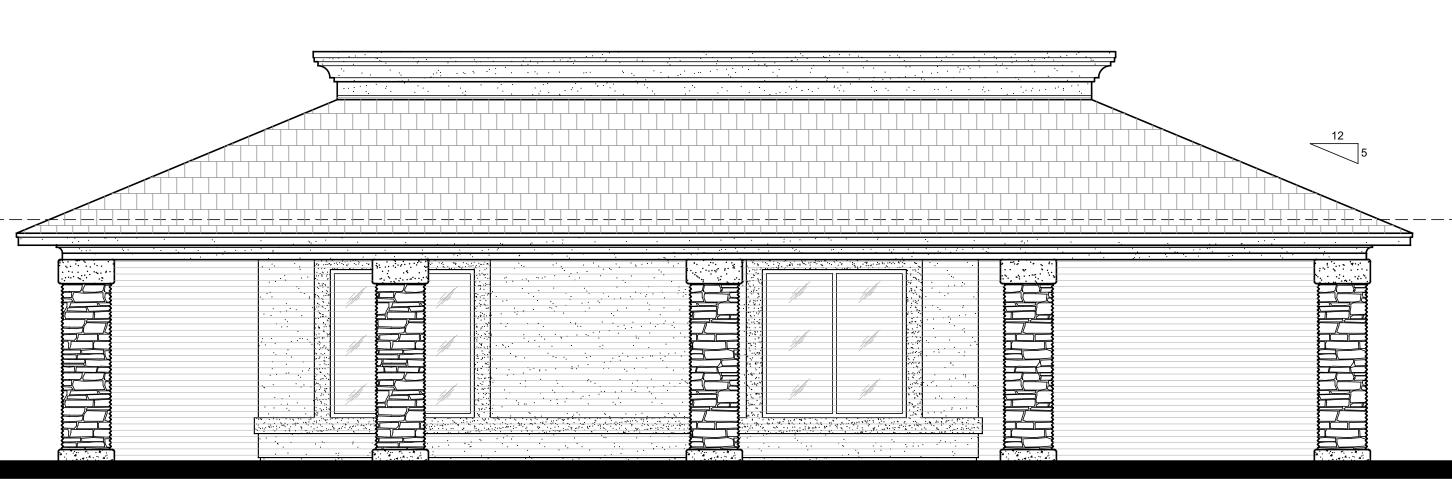

RIGHT - EAST ELEVATION

SCALE: 1/4" = 1'-0"

ES-GN-PLANNIN

FEBRUARY 2024

JULY 2024

THESE PLANS SHALL COMPLY WITH THE 2022 CALIFORNIA BUILDING CODE WHICH ADOPTS THE 2022 CMC, 2022 CMC, 2022 CCC, 2022 CGC, 2022 CGC, 2022 CMC, 2022 CMC AND THE 2022 ENERGY STANDARDS

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MPLEX-2 MPL

APARTMENT COMPLEX-2

TAMARISK APA

PROJECT ADDRESS:
APN: 3057-121-08
XXXX TAMARISK AVENUE,
HESPERIA, CA 92345

JOB NO.
C23-L27

EXTERIOR ELEVATIONS

A-2.1


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FEBRUARY 2024 REVISIONS JULY 2024 THESE DOCUMENTS AND THE
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PROVIDED SHALL BE UNLAWFUL APARTMENT COMPLEX-2


CONTACT INFO:
MUNEM MAIDA
13302 RANCHERO ROAD
OAK HILLS, CA 92344 APARTMENT COMPLEX DEVELOPMENT TAMARISK PROJECT ADDRESS:
APN: 3057-121-08
XXXX TAMARISK AVENUE,
HESPERIA, CA 92345 C23-L27


> CARPORT PLAN/ **ELEVATIONS**

> > PAGE

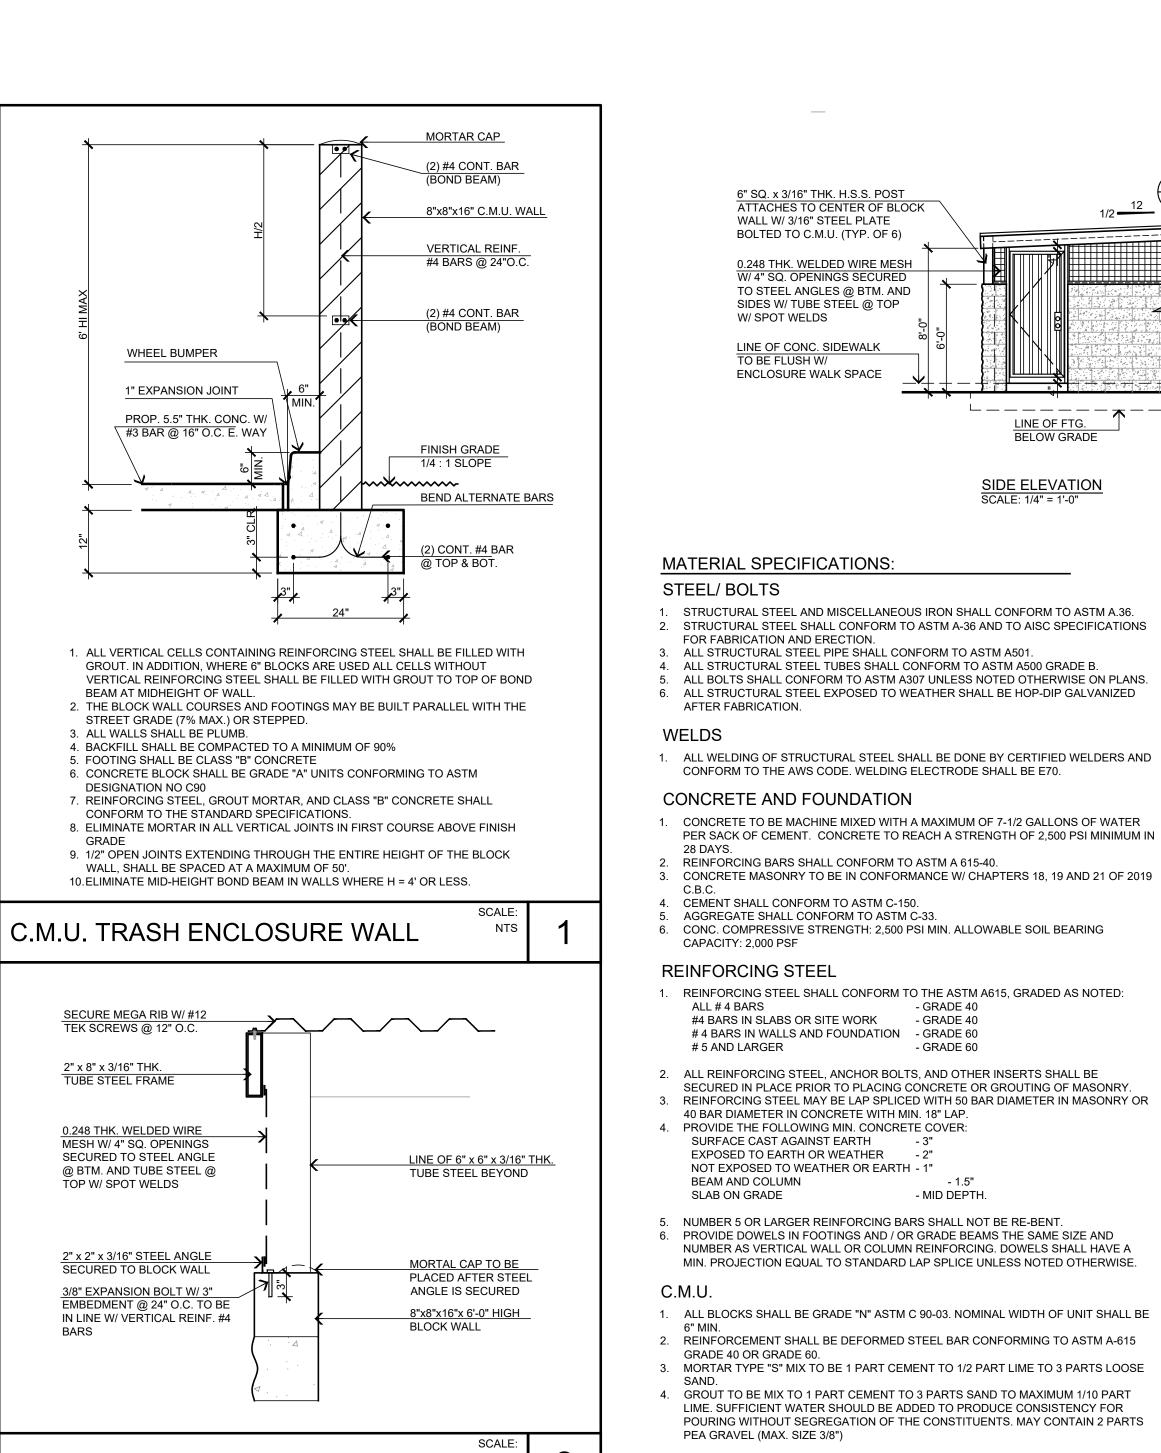

BELOW GRADE

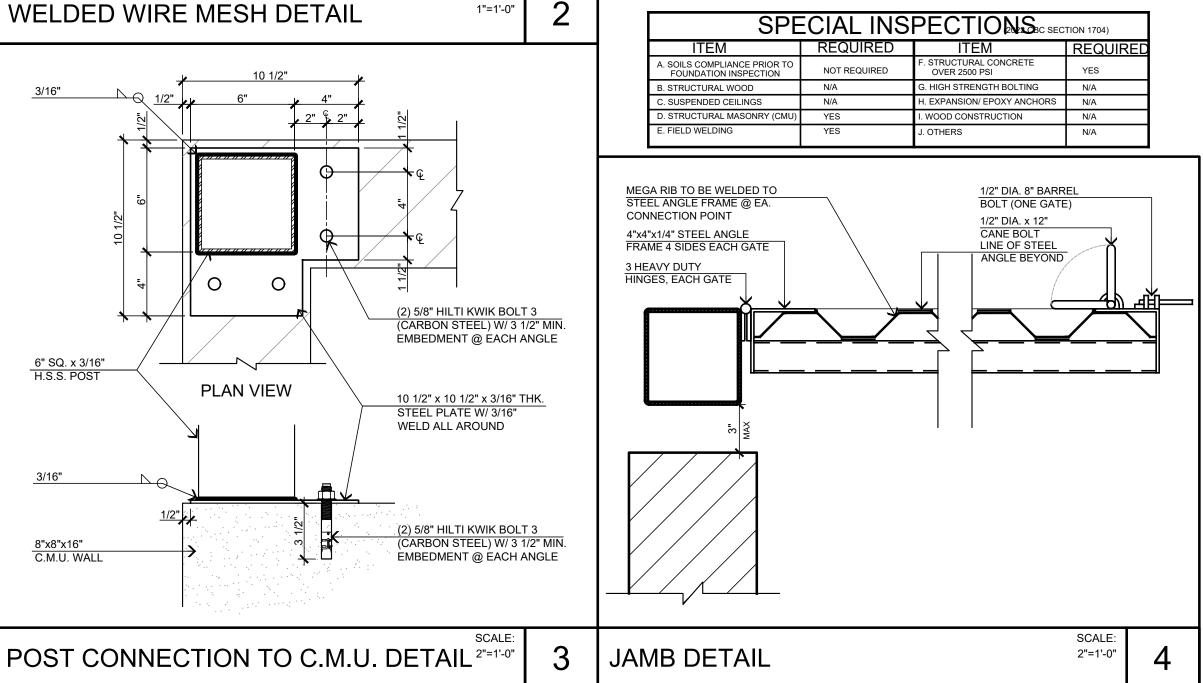

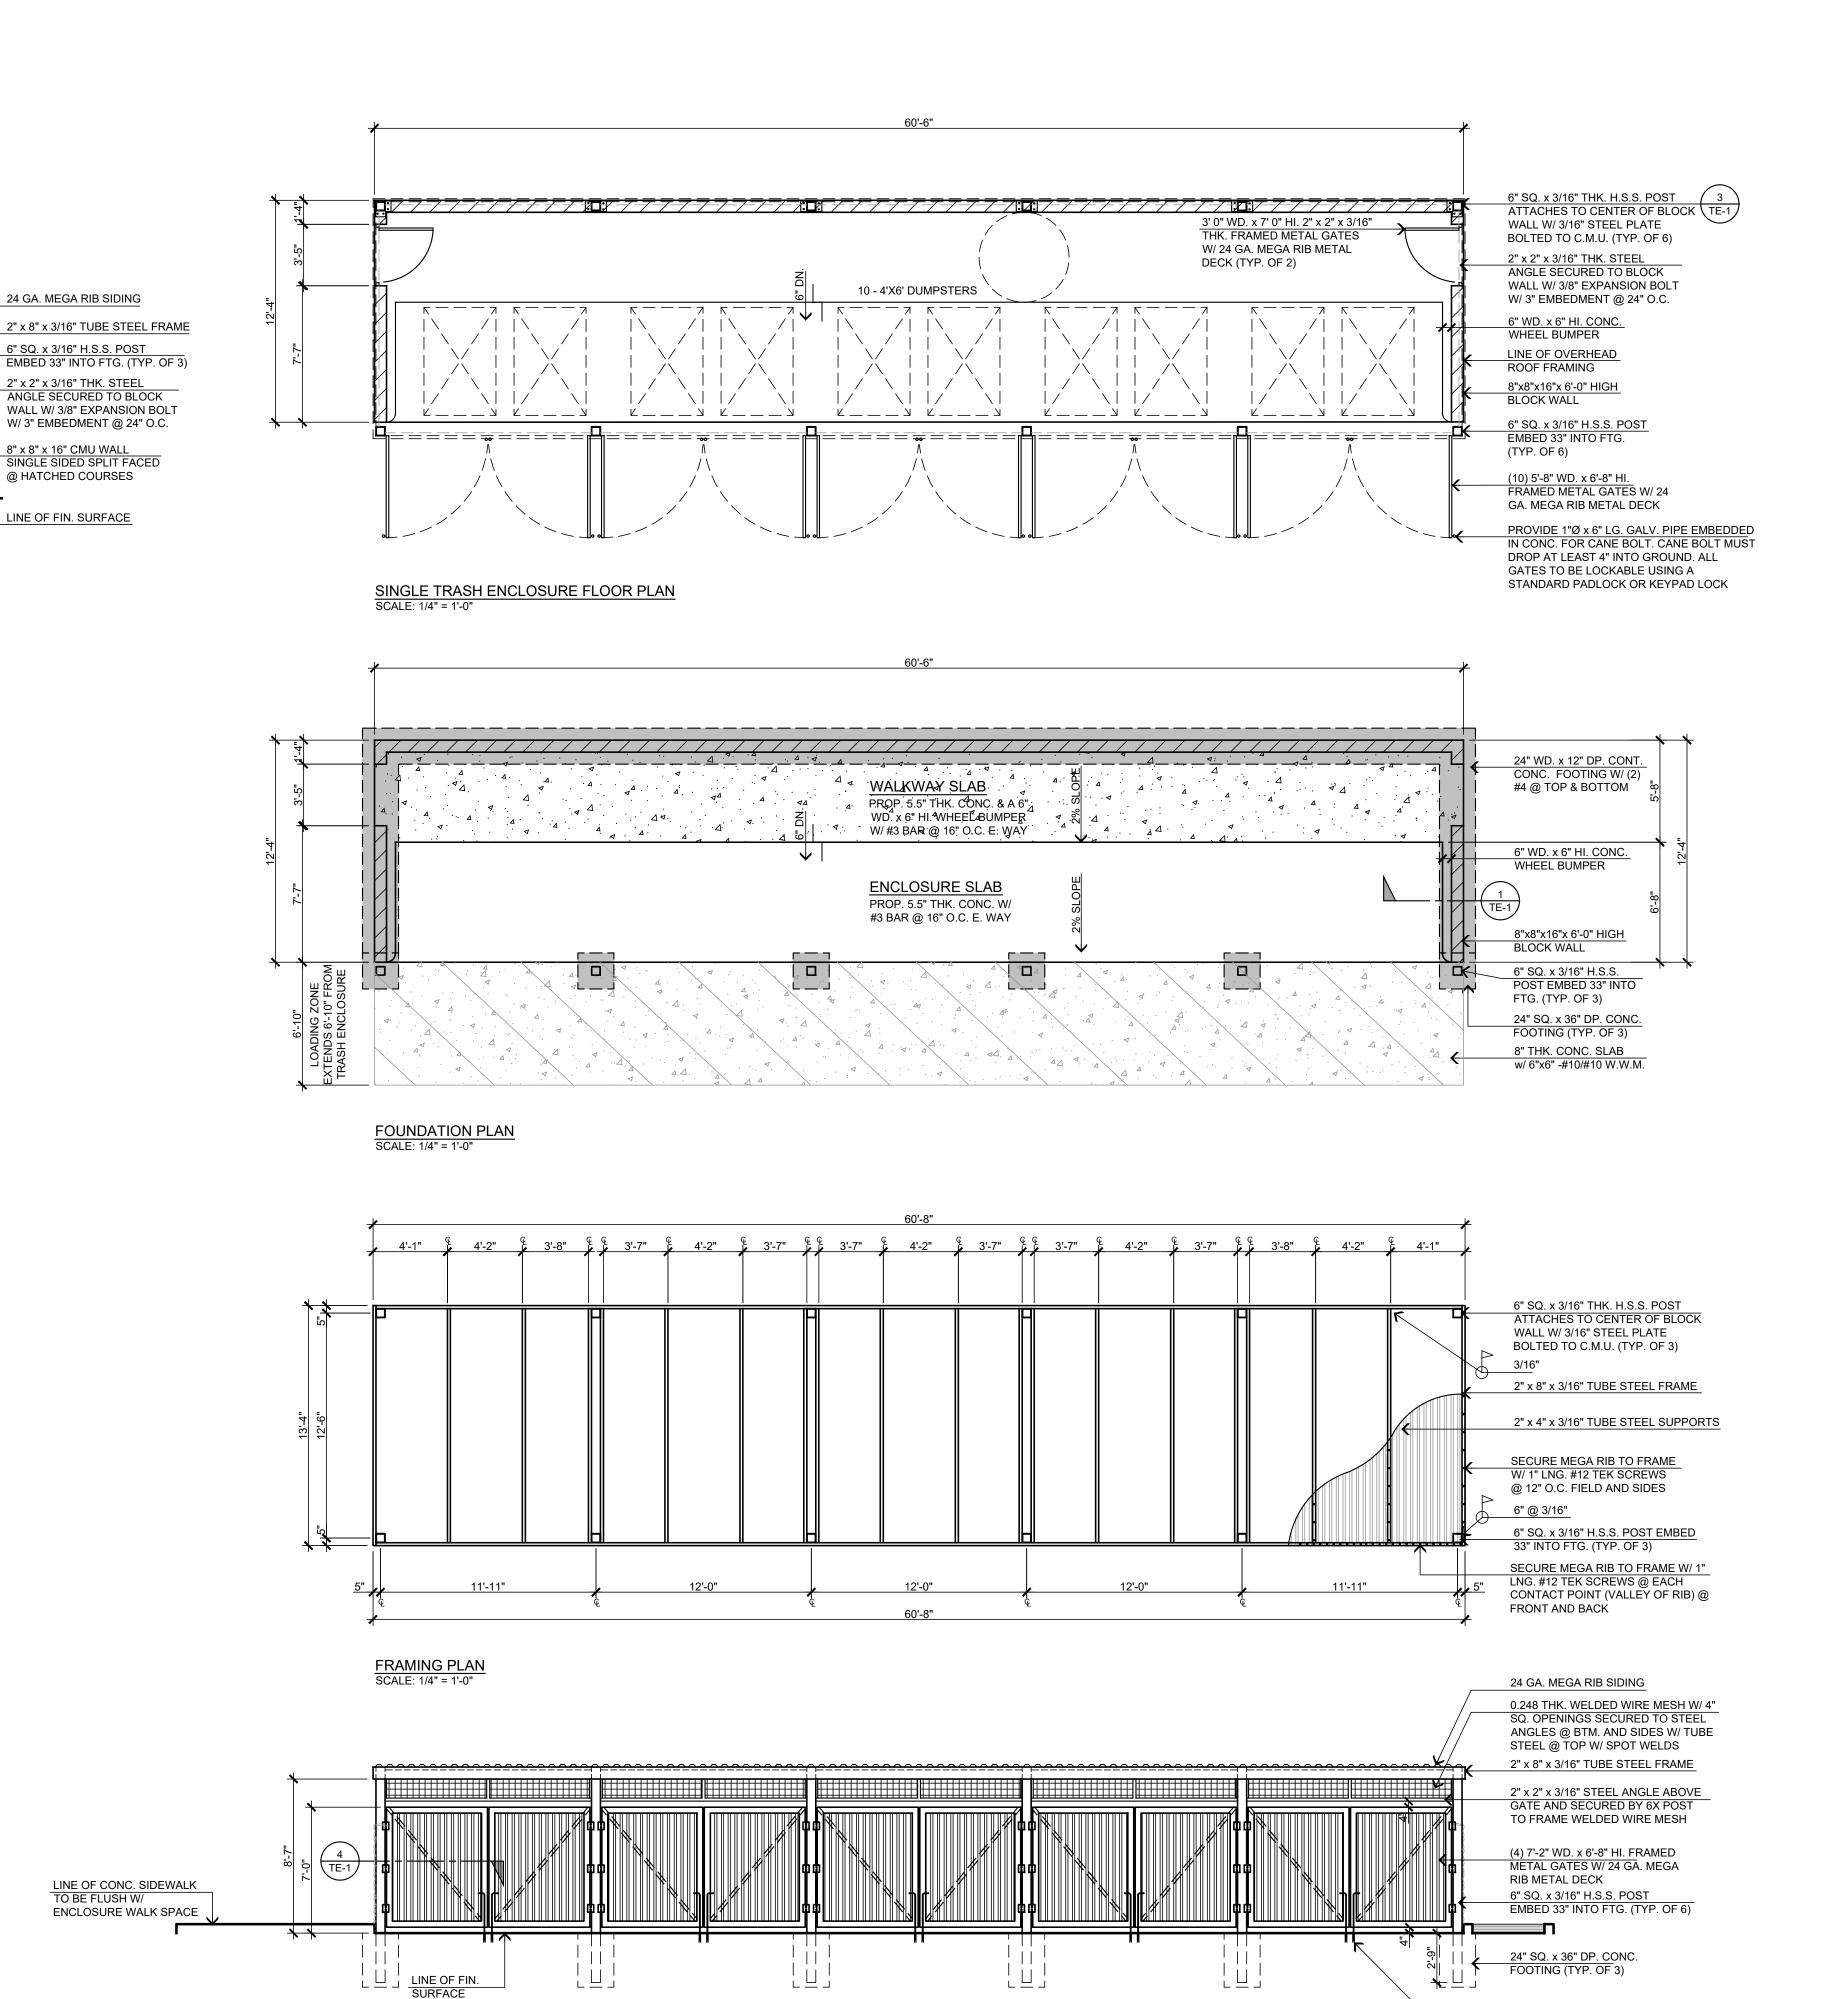

FRONT ELEVATION

П | ф р \Box \supset $^{\prime}$ ≅⋖ $\mathbb{Q} \supset \mathbb{R}^{\,\,\prime}_{\,\,2}$ O , □ ~ ′_ DATE FINISHED FEBRUARY 2024 REVISIONS THESE DOCUMENTS AND THE
DESIGN AND IDEAS
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PROFESSIONAL SERVICE, ARE
THE SOLE PROPERTY OF
STEENO DESIGN STUDIO INC.
ANY USE, IN WHOLE OR IN PART
FOR WHICH THEY WERE NOT
PROVIDED SHALL BE UNLAWFUL OMPL **APARTMENT** TAMARISK PROJECT ADDRESS:
APN: 3057-121-08
XXXX TAMARISK AVENUE,
HESPERIA, CA 92345 ЈОВ МО. C21-L25 SHEET NAME: TRASH **ENCLOSURE** PAGE

PROVIDE 1"Ø x 6" LG. GALV. PIPE EMBEDDED IN CONC. FOR CANEBOLT

OWNER:

MUNEM MAIDA 13302 RANCHERO ROAD OAK HILLS, CA 92344

ARCHITECT:

STEENO DESIGN STUDIO, INC. 11774 HESPERIA ROAD #B2 HESPERIA, CA 92345 (760) 244-5001

ENGINEER:

HIGH DESERT MAPPING 16704 NEENACH ROAD APPLE VALLEY, CA 92307

RAYMOND J. ALLARD, RCE 36052

LEGAL DESCRIPTION:

THE S 1/2, SE 1/4, NW 1/4, NE 1/4, SECTION 24, T4N,

UTILITY SUPPLIERS:

HESPERIA WATER DISTRICT 9700 SEVENTH AVENUE HESPERIA, CA 92345 (760) 947-1840 CITY OF HESPERIA PUBLIC WORKS 9700 SEVENTH AVENUE HESPERIA, CA 92345 (760) 947-1400 SOUTHERN CALIFORNIA EDISON 16938 BEAR VALLEY ROAD VICTORVILLE, CA (760) 241-3805 TELEPHONE 15055 LA PAZ DRIVE VICTORVILLE, CA **CHARTER COMMUNICATIONS** VICTORVILLE, CA TRASH SERVICE __ ADVANCE DISPOSAL CO.

17150 MESA STREET

HESPERIA, CA 92345

(760) 244-9773

SOUTHWEST GAS CORPORATION 13471 MARIPOSA ROAD VICTORVILLE, CA (760) 245-9321

LIST OF DRAWINGS:


1	TITLE SHEET	_ T-1
2	NOTES & DETAILS	. N-1
3	TAMARISK AVENUE IMPROVEMENT PLAN	ST-
4	ORANGE STREET IMPROVEMENT PLAN	ST-
5	GRADING PLAN (WEST)	G-1
6	GRADING PLAN (EAST)	G-2
7	UTILITY PLAN	_ U-1
8	DETAILS	_ D-1
9	DETAILS	D-2
10	DETAILS	D-3
11	STORMTECH DETAILS (BED 1)	SD-
12	STORMTECH DETAILS (BED 2)	SD-
13	CROSS SECTIONS	CS-


ESTIMATED EARTHWORK:

CUT: 1,700 CU. YDS FILL: 5,420 CU. YDS.

TAMARISK APARTMENTS

APN 3057-121-08 TAMARISK AVENUE HESPERIA, CA 92345

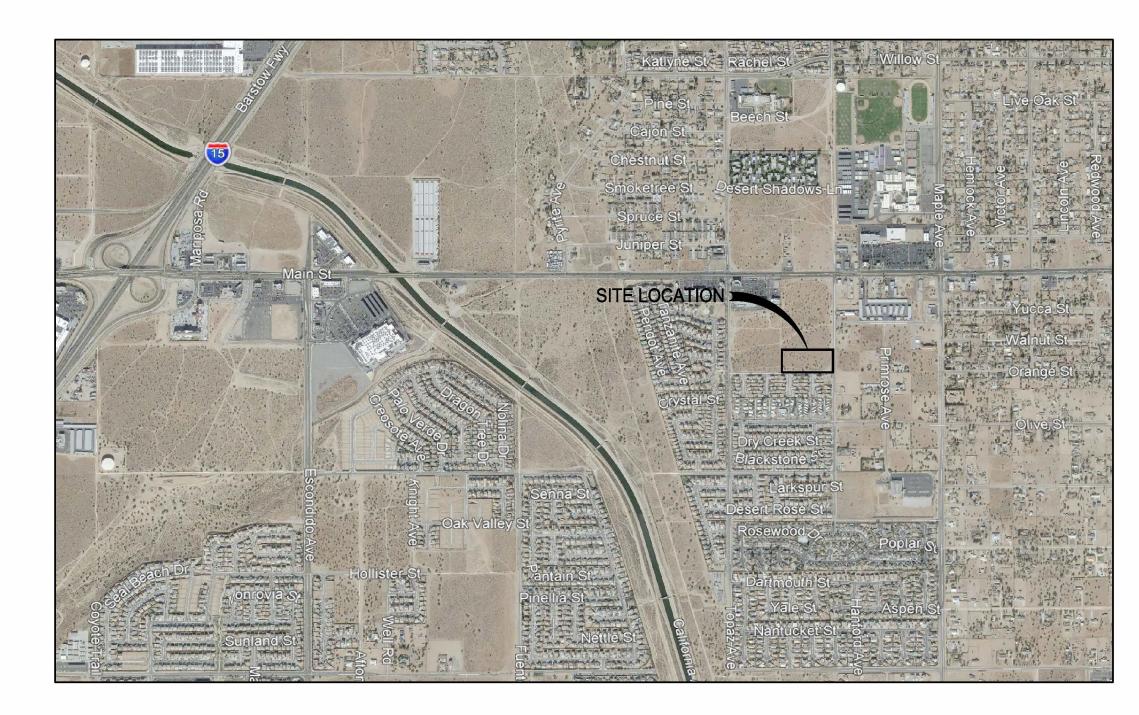

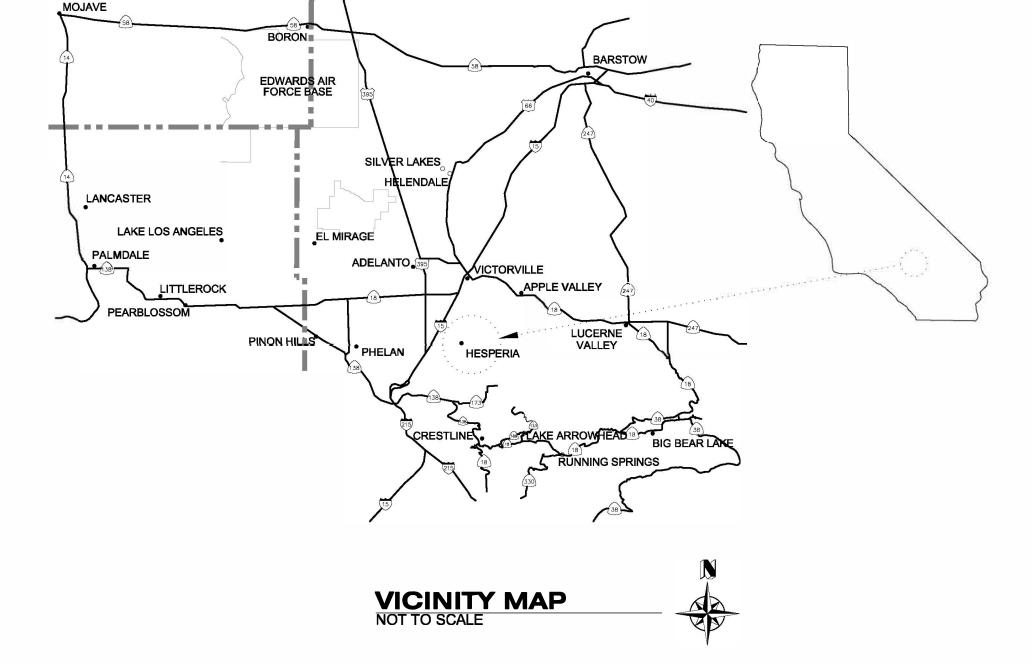



LOCATION MAP NOT TO SCALE

LEGEND:


INDICATES PAD ELEVATION INDICATES FINISHED FLOOR ELEVATION INDICATES TOP OF CURB INDICATES FINISHED SURFACE ELEVATION INDICATES FLOWLINE ELEVATION **INDICATES HIGH POINT** INDICATES GRADE BREAK INDICATES TOP OF GRATE **INDICATES INVERT ELEVATION** INDICATES TOP OF WALL INDICATES TOP OF FOOTING INDICATES EXISTING ELEVATION **INDICATES EXISTING 1-FOOT CONTOUR** INDICATES EXISTING 5-FOOT CONTOUR INDICATES EXISTING POWER POLE INDICATES EXISTING GUY WIRE INDICATES EXISTING JOSHUA TREE INDICATES PROPOSED FLOWLINE INDICATES PROPOSED A.C. PAVEMENT INDICATES EXISTING IMPROVEMENTS TO BE REMOVED

DECLARATION OF ENGINEER OF RECORD

I HEREBY DECLARE THAT IN MY PROFESSIONAL OPINION, THE DESIGN OF THE IMPROVEMENTS AS SHOWN ON THESE PLANS COMPLIES WITH THE CURRENT PROFESSIONAL ENGINEERING STANDARDS AND PRACTICES. AS THE ENGINEER IN RESPONSIBLE CHARGE OF THE DESIGN OF THESE IMPROVEMENTS, I ACCEPT FULL RESPONSIBILITY FOR SUCH DESIGN. I UNDERSTAND AND ACKNOWLEDGE THAT THE LIMITED PURPOSE OF ENSURING THAT THESE PLAN COMPLY WITH CITY PROCEDURES AND OTHER APPLICABLE CODES AND ORDINANCES. THE PLAN REVIEW PROCESS IS NOT A DETERMINATION OF THE TECHNICAL ADEQUACY OF THE DESIGN OF THE IMPROVEMENTS. SUCH PLAN CHECK DOES NOT THEREFORE RELIEVE ME OF MY DESIGN

LICENSE No. ____36052__



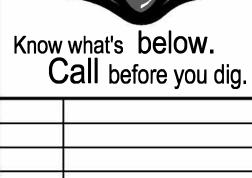

			DENIC
			BENCI
			"H-18"
38			BRASS DISK IN C
			22 FEET NORTH
			SIDEWALK AT TH ST.
-			
DEV	DESCRIPTION DATE	BV	ELEV=3376.492

DESCRIPTION

BENCHMARK:

BRASS DISK IN CONCRETE, LOCATED APPROXIMATELY 2 FEET NORTH OF THE NE ECR, BEHIND THE SIDEWALK AT THE INTERSECTION OF MAIN ST. & MAPLE

DESIGNED BY: D.B.W. _D.B.W. CHECKED BY: R.J.A. SUBMITTED BY:

RAYMOND J. ALLARD RCE No. 36052



DATE

HIGH DESERT MAPPING

Land Surveying - Civil Design 16704 Neenach Road Apple Valley, CA 92307 (760) 508-8555

dbw.hdm@gmail.com

CITY OF HESPERIA ENGINEERING DEPARTMENT			
RECOMMENDED FOR APPROVAL BY:	APPROVED BY:		
DATE	CASSANDRA SANCHEZ DATE R.C.F. 74776 FXP. DATE 12/31/25		

AUTHORIZED SIGNATURE

CITY ENGINEER

CITY OF HESPERIA TITLE SHEET **TAMARISK APARTMENTS**

MUNEM MAIDA APN 3057-121-08

	•
SHEET	-
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GENERAL CONSTRUCTION NOTES

- 1. ALL WORK SHALL BE DONE IN ACCORDANCE WITH THESE PLANS AND THE CITY OF HESPERIA STANDARDS AND SPECIFICATIONS.
- 2. PRIOR TO CONSTRUCTION, THE CONTRACTOR SHALL CONTACT ALL UTILITY COMPANIES TO DETERMINE THE EXACT LOCATION OF ALL UNDERGROUND FACILITIES WHETHER SHOWN OR NOT SHOWN. IT SHALL BE THE CONTRACTOR'S RESPONSIBILITY TO PROTECT ALL EXISTING FACILITIES FROM DAMAGE DURING CONSTRUCTION.
- 3. CALL UNDERGROUND SERVICE ALERT TWO WORKING DAYS BEFORE ANY TRENCHING, ETC. AT 811. THE FOLLOWING AGENCIES SHALL BE CONTACTED BEFORE ANY CONSTRUCTION OR EXCAVATION BEGINS.

HESPERIA WATER DISTRICT (760) 947-1840 CITY OF HESPERIA PUBLIC WORKS DEPT (760) 947-1400 CITY OF HESPERIA POLICE DEPT (760) 947-1500 CITY OF HESPERIA FIRE PREVENTION (760) 947-1641 SOUTHWEST GAS CORP. (760) 241-9321 VERIZON TELEPHONE (800) 483-3000 (800) 248-0133 VERIZON FIBER OPTIC CHARTER COMMUNICATIONS (866) 499-8080 SOUTHERN CALIFORNIA EDISON (800) 684-8123 UNDERGROUND SERVICE ALERT POST OFFICE (760) 244-3897 HESPERIA SCHOOL DISTRICT (760) 244-4411 VICTOR VALLEY TRANSIT (760) 948-4021 ADVANCED DISPOSAL (760) 244-9773

- 4. THE CONTRACTOR IS RESPONSIBLE FOR THE COORDINATION OF THE REMOVAL OR RELOCATION OF ANY AND ALL EXISTING UTILITIES WITH THE RESPECTIVE UTILITY COMPANY. COST OF THIS COORDINATION IS TO BE INCLUDED IN THE PRICE BID FOR THE VARIOUS IMPROVEMENTS TO COMPLETE THE PROJECT.
- 5. A CERTIFICATE OF COMPACTION SIGNED BY A REGISTERED ENGINEER SHALL BE SUBMITTED FOR ALL TRENCH BACKFILLS.
- 6. THE CONTRACTOR SHALL BE HELD RESPONSIBLE FOR ANY FIELD CHANGES MADE WITHOUT PRIOR WRITTEN AUTHORIZATION FROM THE UNDERSIGNED ENGINEER, DEVELOPER AND THE CITY OF HESPERIA.
- 7. THE CONTRACTOR IS RESPONSIBLE FOR PROTECTING ALL SURVEY MONUMENTS. ANY SURVEY MONUMENTS DISTURBED DURING THE COURSE OF CONSTRUCTION SHALL BE REPLACED BY A LICENSED SURVEYOR AND AT THE CONTRACTOR'S EXPENSE.
- 8. THE CONTRACTOR AGREES THAT HE SHALL ASSUME SOLE AND COMPLETE RESPONSIBILITY FOR JOB SITE CONDITIONS DURING THE COURSE OF CONSTRUCTION OF THIS PROJECT. INCLUDING SAFETY OF ALL PERSONS AND PROPERTY; THAT THIS REQUIREMENT SHALL APPLY CONTINUALLY AND NOT BE LIMITED TO NORMAL WORKING HOURS; AND THAT THE CONTRACTOR SHALL DEFEND, INDEMNIFY AND HOLD THE OWNER AND THE ENGINEER HARMLESS FROM ANY AND ALL LIABILITY, REAL OR ALLEGED, IN CONNECTION WITH THE PERFORMANCE OF WORK ON THIS PROJECT EXCEPTING FOR LIABILITY ARISING FROM THE SOLE NEGLIGENCE OF THE OWNER OR THE ENGINEER.
- 9. AN ENCROACHMENT PERMIT FROM THE CITY OF HESPERIA SHALL BE OBTAINED PRIOR TO THE BEGINNING OF ANY WORK OR CONSTRUCTION WITHIN THE STREET RIGHT-OF-WAY.
- 10. ADEQUATE STAKING SHALL BE SET BY THE ENGINEER OF RECORD OR LICENSED SURVEYOR TO ENABLE THE CONTRACTOR TO CONSTRUCT IMPROVEMENTS PER THE SIGNED IMPROVEMENT PLANS.
- 11. ALL STATIONING IS BASED ON THE CENTER LINE OF THE STREET.
- 12. ALL EXCAVATIONS SHALL BE BACKFILLED AT THE END OF EACH WORKING DAY AND ROADS OPEN TO VEHICULAR TRAFFIC UNLESS OTHERWISE APPROVED BY THE CITY ENGINEER.
- 13. ALL TRAFFIC CONTROL SHALL BE PER 2012 CA. M.U.T.C.D. "MANUAL OF UNIFORM TRAFFIC CONTROL DEVICES".
- 14. THE ENGINEER OF RECORD SIGNING THESE PLANS IS RESPONSIBLE FOR THE ACCURACTY AND ACCEPTABILITY OF THE WORK. THE ENGINEER OF RECORD IS REQUIRED TO STAMP AND SIGN THE "DECLARATION OF ENGINEER OF RECORD" HEREON.
- 15. CULTURAL RESOURCES: IF CULTURAL RESOURCES ARE FOUND DURING GRADING THEN GRADING ACTIVITIES SHALL CEASE AND THE APPLICANT SHALL CONTRACT WITH A CITY APPROVED ARCHAEOLOGIST OR PALEONTOLOGIST TO MONITOR GRADING PRIOR TO RESUMING GRADING. ALL CULTURAL RESOURCES DISCOVERED SHALL BE HANDLED IN ACCORDANCE WITH STATE AND FEDERAL LAW. A REPORT OF ALL RESOURCES DISCOVERED AS WELL AS THE ACTIONS TAKEN SHALL BE PROVIDED TO THE CITY PRIOR TO ISSUANCE OF A CERTIFICATE OF OCCUPANCY.

GRADING PLANS NOTES

Know what's below.

Call before you did

- 1. ALL GRADING SHALL CONFORM TO CHAPTER 15.06 OF THE CITY OF HESPERIA MUNICIPAL CODE.
- 2. ALL PROVISIONS OF THE PRELIMINARY SOILS REPORT PREPARED BY: ALR ENGINEERING & TESTING PROJECT NUMBER 1711356, DATED DECEMBER 20, 2017, SHALL BE COMPLIED WITH DURING GRADING OPERATIONS.
- 3. THIS PLAN IS FOR GRADING PURPOSES ONLY. APPROVAL OF THIS PLAN DOES NOT CONSTITUTE APPROVAL OF DRIVEWAY LOCATIONS OR SIZES, PARKING LOT LAYOUT, BUILDING LOCATIONS, OFFSITE DRAINAGE FACILITIES OR OTHER ITEMS NOT RELATED DIRECTLY TO THE BASIC GRADING OPERATIONS.
- 4. CERTIFICATION FROM THE ENGINEER OF RECORD STATING THAT THE GRADING HAS BEEN COMPLETED PER THE APPROVED PLAN AND THE COMPACTION REPORT FROM THE SOILS ENGINEER ON ANY FILL AREAS THAT ARE REQUIRED SHALL BE PROVIDED PRIOR TO BUILDING PERMITS BEING ISSUED.
- 5. CONTRACTOR IS RESPONSIBLE FOR EROSION, DUST, AND DRAINAGE CONTROL PER SWPPP AND NPDES CRITERIA UNTIL PROJECT COMPLETION.
- 6. ANY ONSITE RETAINING WALLS SHOWN ON THIS PLAN THAT ARE UNDER THREE (3) FEET IN HEIGHT AND SUPPORT A SURCHARGE OR THAT ARE OVER THREE (3) FEET IN HEIGHT REQUIRE SEPARATE REVIEW AND APPROVAL FROM THE BUILDING OFFICIAL AT (760) 947-1300. ANY NECESSARY RETAINING WALLS ON THE PERIMETER OF THIS SITE SHALL BE IN PLACE AND APPROVED BY THE BUILDING OFFICIAL PRIOR TO THE START OF GRADING. APPROVED SEQUENCED GRADING WITH 1-1/2:1 MAXIMUM SLOPES TO WITHIN TWO (2) FEET OF THE ADJACENT PROPERTY LINE MAY BE ACCEPTABLE TO ALLOW FOR START OF GRADING PRIOR TO COMPLETION OF ANY NECESSARY PERIMETER RETAINING WALLS
- 7. ANY IMPROVEMENTS CONSTRUCTED IN THE PUBLIC RIGHT-OF-WAY WILL REQUIRE SEPARATE PLAN APPROVAL, ENCROACHMENT PERMIT, AND INSPECTION FROM THE ENGINEERING OFFICE AT (760) 947-1477.
- 8. ANY WALLS, FENCES, STRUCTURES AND / OR APPURTENANCES ADJACENT TO THIS PROJECT SHALL BE PROTECTED IN PLACE. IF GRADING OPERATIONS DAMAGE OR ADVERSELY AFFECT SAID ITEMS IN ANY WAY, THE CONTRACTOR AND/OR DEVELOPER ARE RESPONSIBLE FOR WORKING OUT AN ACCEPTABLE SOLUTION TO THE SATISFACTION OF THE AFFECTED PROPERTY OWNER(S).
- 9. THE CONTRACTOR AND / OR DEVELOPER ARE RESPONSIBLE FOR ENSURING THAT RETAINING WALLS DO NOT INTERFERE WITH PROVISION OF UTILITIES.
- 10. IT IS THE SOILS ENGINEER'S RESPONSIBILITY TO ENSURE THAT ADEQUATE COMPACTION HAS BEEN ATTAINED ON THE ENTIRE GRADING SITE, INCLUDING FILL AREAS OUTSIDE THE BUILDING PADS AND ON ALL FILL SLOPES.
- 11. IT SHALL BE THE CONTRACTOR'S RESPONSIBILITY TO CALL THE BUILDING AND SAFETY DEPARTMENT AT (760) 947-1300 FOR INSPECTION TWO (2) WORKING DAYS PRIOR TO PERFORMING ANY WORK. WORK PERFORMED WITHOUT CALLING FOR INSPECTION SHALL BE REJECTED AND SHALL BE REMOVED SOLELY AT THE CONTRACTOR'S EXPENSE.

STREETS AND STORM DRAIN NOTES


- ALL WORK SHALL BE DONE IN ACCORDANCE WITH THESE PLANS AND THE 2012 CA. M.U.T.C.D. "MANUAL ON UNIFORM TRAFFIC CONTROL DEVICES" AND S.P.P.W.C. "GREEN BOOK" STANDARD PLANS AND SPECIFICATIONS TOGETHER WITH ANY MODIFICATIONS THERETO ADOPTED BY THE CITY OF HESPERIA.
- 2. IT SHALL BE THE RESPONSIBILITY OF THE CONTRACTOR TO FAMILIARIZE HIMSELF WITH THE JOB SITE AND THE LOCATION OF ALL UNDERGROUND FACILITIES SHOWN OR NOT SHOWN ON THESE PLANS. NEITHER THE CITY OF HESPERIA NOR THE CITY ENGINEER WILL BE RESPONSIBLE FOR ANY DAMAGE TO UNDERGROUND FACILITIES.
- 3. IT SHALL BE THE CONTRACTOR'S RESPONSIBILITY TO OBTAIN ALL NECESSARY PERMITS.
- 4. IT SHALL BE THE CONTRACTOR'S RESPONSIBILITY TO CALL THE CITY ENGINEERING OFFICE AT (760) 947-1477 FOR INSPECTION 24 HOURS PRIOR TO PERFORMING ANY WORK. WORK PERFORMED WITHOUT CALLING FOR INSPECTION SHALL BE REJECTED AND SHALL BE REMOVED SOLELY AT THE CONTRACTOR'S EXPENSE.
- 5. UTILITY CONTRACTORS SHALL BE RESPONSIBLE OR OBTAINING COMPACTION TESTS OF ALL TRENCH BACKFILL AND STREET SUBGRADES AND SUBMITTING THEM TO THE CITY ENGINEERING OFFICE. NOTIFY THE CITY ENGINEERING OFFICE AT (760) 947-1477 24 HOURS PRIOR TO TEST.
- 6. THE STRUCTURAL SECTIONS SHOWN ON THESE PLANS ARE BASED ON R-VALUE TESTS OR CITY MINIMUM STRUCTURAL STANDARDS, WHICHEVER IS GREATER. IN THE EVENT FIELD CONDITIONS VARY FROM INITIAL TEST RESULTS, ADDITIONAL TESTS, MATERIAL REPORTS AND REVISED STRUCTURAL SECTIONS MAY BE REQUIRED TO BE PREPARED AND SUBMITTED BY THE PROJECT ENGINEER OF RECORD TO THE ENGINEERING OFFICE FOR REVIEW AND EVALUATION. APPROVAL WILL BE GIVEN WHEN ALL STRUCTURAL SECTION REQUIREMENTS HAVE BEEN MET. R-VALUE TESTS ARE REQUIRED AND SHALL BE SUBMITTED IN ALL CASES. STRUCTURAL SECTIONS SHALL BE DESIGNED IN ACCORDANCE WITH CALTRANS HIGHWAY DESIGN MANUAL CHAPTER 600.
- 7. STAKING CUT SHEETS SHALL BE PREPARED BY THE DEVELOPER'S ENGINEER AND SUBMITTED TO THE CITY ENGINEERING OFFICE. NO CONSTRUCTION SHALL BE ALLOWED PRIOR TO THE CITY ENGINEER'S APPROVAL OF THE CUT SHEETS.
- 8. THE CONTRACTOR SHALL VERIFY THAT ESTIMATED QUANTITIES SHOWN ARE CORRECT BEFORE BIDDING ON ANY ITEM.
- 9. THE CONTRACTOR SHALL MAINTAIN DUST CONTROL AT ALL TIMES.
- 10. ALL EXISTING PAVEMENT TO BE REMOVED SHALL BE SAWCUT OR WHEELCUT AND REMOVED TO CLEAN STRAIGHT LINES PER THE CITY INSPECTOR.
- 11. AT ALL LOCATIONS WHERE NEW PAVEMENT JOINS EXISTING, THE EXISTING PAVEMENT SHALL BE COATED WITH AN ASPHALTIC EMULSION.
- 12. THE CONTRACTOR IS RESPONSIBLE FOR THE PROTECTION OF ALL UTILITY VALVES, BOXES AND COVERS, AND ADJUSTING OF ALL UTILITY VALVE BOXES AND COVERS TO FINISH GRADE.
- 13. THE CONTRACTOR SHALL SET MANHOLE RINGS PER CITY STANDARDS.
- 14. THE CONTRACTOR SHALL CALL IN A LOCATION REQUEST TO UNDERGROUND SERVICE ALERT (USA) PHONE NUMBER 811, TWO WORKING DAYS BEFORE DIGGING. NO INSPECTION WILL BE PROVIDED BY THE CITY ENGINEER'S OFFICE AND NO CONSTRUCTION PERMIT ISSUED INVOLVING EXCAVATION FOR UNDERGROUND FACILITIES WILL BE VALID UNLESS THE APPLICANT HAS BEEN PROVIDED AN INQUIRY IDENTIFICATION NUMBER BY USA
- 15. CITY APPROVAL OF PLANS DOES NOT RELIEVE THE DEVELOPER FROM THE RESPONSIBILITY FOR THE CORRECTION OF ERRORS AND OMISSIONS DISCOVERED DURING CONSTRUCTION. UPON REQUEST, THE REQUIRED PLAN REVISIONS SHALL BE PROMPTLY SUBMITTED TO THE CITY ENGINEER FOR APPROVAL.
- 16. CONTRACTOR IS RESPONSIBLE FOR PROVIDING A TRAFFIC CONTROL PLAN TO BE REVIEWED AND APPROVED BY THE CITY ENGINEER PRIOR TO CONSTRUCTION. ALL TRAFFIC CONTROL SHALL BE PER 2012 CA. M.U.T.C.D. "MANUAL ON UNIFORM TRAFFIC CONTROL DEVICES".
- 17. ALL UTILITIES OR SUBSTRUCTURES OF ANY KIND, AND TELEPHONE POWER POLES, WATER METERS, VALVES, HYDRANTS, ETC., SHOWN OR NOT SHOWN ON THESE PLANS WITHIN THE LIMITS OF THIS DEVELOPMENT OR IN ADJACENT AREAS WHERE IMPROVEMENT WORK IS TO BE DONE SHALL BE REMOVED OR RELOCATED AT DEVELOPER'S EXPENSE, AND AT NO COST TO THE CITY OF HESPERIA. IT SHALL BE THE OWNER'S RESPONSIBILITY TO NOTIFY ALL AGENCIES CONCERNED.
- 18. ALL CONSTRUCTION TO BE IN CONFORMANCE WITH THE REGULATIONS OF CAL-OSHA.


WATER LINE INSTALLATION

- 1. MATERIALS AND INSTALLATION SHALL CONFORM TO THE CITY OF HESPERIA STANDARDS AND CURRENT MATERIALS LIST.
- 2. IT IS THE CONTRACTOR'S RESPONSIBILITY TO MAINTAIN A CURRENT AND APPROVED SET OF CITY OF HESPERIA STANDARDS AND MATERIALS LIST ON THE JOB SITE AT ALL TIMES. CITY STANDARDS AND MATERIAL LISTS ARE AVAILABLE AT THE CITY OF HESPERIA ENGINEERING DEPARTMENT.
- 3. DISTRIBUTION WATER MAINS SHALL HAVE A MINIMUM OF 48" OF COVER FOR 8" MAIN AND 42" MINIMUM COVER FOR 12" AND LARGER MAINS FROM TOP OF PIPE TO FINAL GRADE. TRANSMISSION WATER MAINS SHALL HAVE A MINIMUM OF 72" OF COVER. RECLAIMED WATER MAINS SHALL HAVE A MINIMUM OF 60" OF COVER.
- 4. HYDRO TEST AT 200 PSI MINIMUM FOR 2 HOUR DURATION AT LOWEST POINT IN THE WATER LINE.
- 5. SERVICE LINES TO BE INSTALLED PER STANDARD DWG. W-7.
- 6. METERS SHALL BE PLACED WITHIN 2 FEET MINIMUM, 5 FEET MAXIMUM, FROM ADJACENT PROPERTY LINE. METER BOXES IN THE SIDEWALK SHALL BE IN TRAFFIC RATED BOXES.
- 7. 14 GUAGE COPPER COATED WIRE TO BE TAPED TO TOP OF PIPE. ALL SPLICES TO BE MADE WITH 3M CONNECTORS.
- 8. ALL NEW FIRE HYDRANTS INSTALLED ARE TO BE COVERED AT TIME OF INSTALLATION, UNTIL THE WATER LINE IS ACTIVATED.
- 9. RESILIENT WEDGE VALVES TO BE MUELLER, AFC, CLOW OR AMERICAN AVK WITH SS STEM AND BUTTERFLY VALVES TO BE MUELLER OR PRATT AS PER CITY OF HESPERIA STANDARDS.
- 10. ALL NEW FIRE HYDRANTS SHALL BE MUELLER, AFC AMERICAN DARLING, CLOW OR AMERICAN AVK #2780 WITH (1) 4" NOZZLE, (2) 2-1/2" NOZZLES AND 5-1/4" MINIMUM VALVE OPENINGS, AS PER CITY OF HESPERIA STANDARDS AND MATERIALS LIST.
- 11. ALL VALVES INSTALLED BY THE CONTRACTOR SHALL BE ACCESSIBLE FOR OPERATION WITH COMPLETE VALVE CAN TO GRADE DIRECTLY FOLLOWING CONNECTION TO EXISTING WATER SYSTEM (SEE STD. DWG. W-1).
- 12. ALL HYDRANTS TO BE OF THE SAME MANUFACTURER AS THE SELECTED VALVES.
- 13. THE CONTRACTOR SHALL BE RESPONSIBLE FOR ADEQUATE SIZING OF THRUST BLOCKS BASED ON FIELD CONDTIONS (SEE STD. DWG. W-4).
- 14. ALL 3-WAY FIRE HYDRANTS TO BE REMOVED SHALL BE SALVAGED AND RETURNED TO CITY OF HESPERIA PUBLIC WORK'S YARD.
- 15. CONTRACTOR TO CAP EXISTING WATER MAINS AS PER CITY OF HESPERIA INSPECTOR WHEN REQUIRED.
- 16. BACKFILL COMPACTION AND RESURFACING IN EXISTING STREETS SHALL CONFORM TO CITY STANDARDS OR LATEST REVISION THEREOF. A CERTIFICATION OF COMPACTION SIGNED BY A REGISTERED CIVIL ENGINEER SHALL BE SUBMITTED FOR ALL TRENCH BACKFILLS
- 17. ALL SERVICE CHANGEOVERS TO BE THE RESPONSIBILITY OF THE CONTRACTOR. EXISTING SERVICE LINES TO BE REMOVED AT THE TIME OF NEW CONNECTION FROM METER TO MAIN.

SEWER LINE INSTALLATION

- 1. ALL MATERIALS AND INSTALLATION OF SEWER FACILITIES TO BE CONSTRUCTED SHALL BE IN ACCORDANCE WITH THESE PLANS, MANUFACTURER'S SPECIFICATIONS, CITY OF HESPERIA STANDARDS, AND MATERIAL LISTS.
- 2. IT IS THE CONTRACTOR'S RESPONSIBILITY TO MAINTAIN A CURRENT AND APPROVED SET OF CITY OF HESPERIA STANDARDS AND MATERIALS LIST ON THE JOB SITE AT ALL TIMES. CITY STANDARDS AND MATERIAL LISTS ARE AVAILABLE AT THE CITY OF HESPERIA ENGINEERING DEPARTMENT.
- 3. SEPARATION OF WATER AND SEWER FACILITIES SHALL CONFORM TO THE RULES AND REGULATIONS OF THE CITY OF HESPERIA STANDARDS (SEE STD. DWG. S-1).
- 4. ALL SEWER PIPE (UNLESS OTHERWISE NOTED) SHALL BE POLYVINYL CHLORIDE (PVC) S.D.R. 35.
- 5. SEWER PROFILE ELEVATIONS ARE TO THE INVERT OF THE PIPE.
- 6. SEWER LATERALS SHALL BE CONSTRUCTED IN ACCORDANCE WITH STANDARD LOCATIONS OF WYES AND LATERALS. WHERE NOT SHOWN ON THE PLANS LOCATION IS TO BE DETERMINED IN THE FIELD PRIOR TO CONSTRUCTION. CLEANOUT LOCATIONS SHALL NOT BE INSTALLED IN DRIVEWAY WHERE APPLICABLE. ALL LATERALS ARE TO BE 6" DIAMETER UNLESS OTHERWISE NOTED ON THE PLANS.
- 7. PRIOR TO CONSTRUCTION OF SEWER, CONTRACTOR SHALL EXPOSE EXISTING SEWER AND VERIFY ITS EXISTING ELEVATION AND LOCATION BEFORE CONNECTING TO EXISTING MANHOLE OR STUB. CONTRACTOR IS RESPONSIBLE TO NOTIFY THE CITY ENGINEER IF ELEVATIONS ARE NOT PER PLAN AND REQUIRE ADJUSTMENTS IN THE FIELD.
- 8. IT SHALL BE THE SEWER CONTRACTOR'S RESPONSIBILITY TO SET CLEAN-OUTS TO FINISH GRADE.
- 9. SEWER PIPE ZONE AND TRENCH BACKFILL SHALL BE PLACED IN ACCORDANCE WITH THE CITY OF HESPERIA STANDARDS. (SEE STD. DWG. S-1).
- 10. MANHOLES SHALL BE ADJUSTED TO GRADE AFTER PLACING SURFACE COURSE ASPHALT CONCRETE.
- 11. MANHOLE COVERS TO BE LOCK-DOWN TYPE. (SEE STD. DWG. S-8).
- 12. SEWER LATERALS SHALL BE CONNECTED TO THE MAIN WITH GASKETED WYES.
- 13. SEWER LINES SHALL BE TESTED PRIOR TO MAKING PERMANENT SERVICE CONNECTION. SEWER TESTING SHALL INCLUDE BALL AND MANDREL, PRESSURE TEST AND VIDEO BEFORE PERMANENT PAVING IS COMPLETED. ALL TRACTS WILL BE REQUIRED TO VIDEO AGAIN PRIOR TO THE RELEASE OF BONDS.

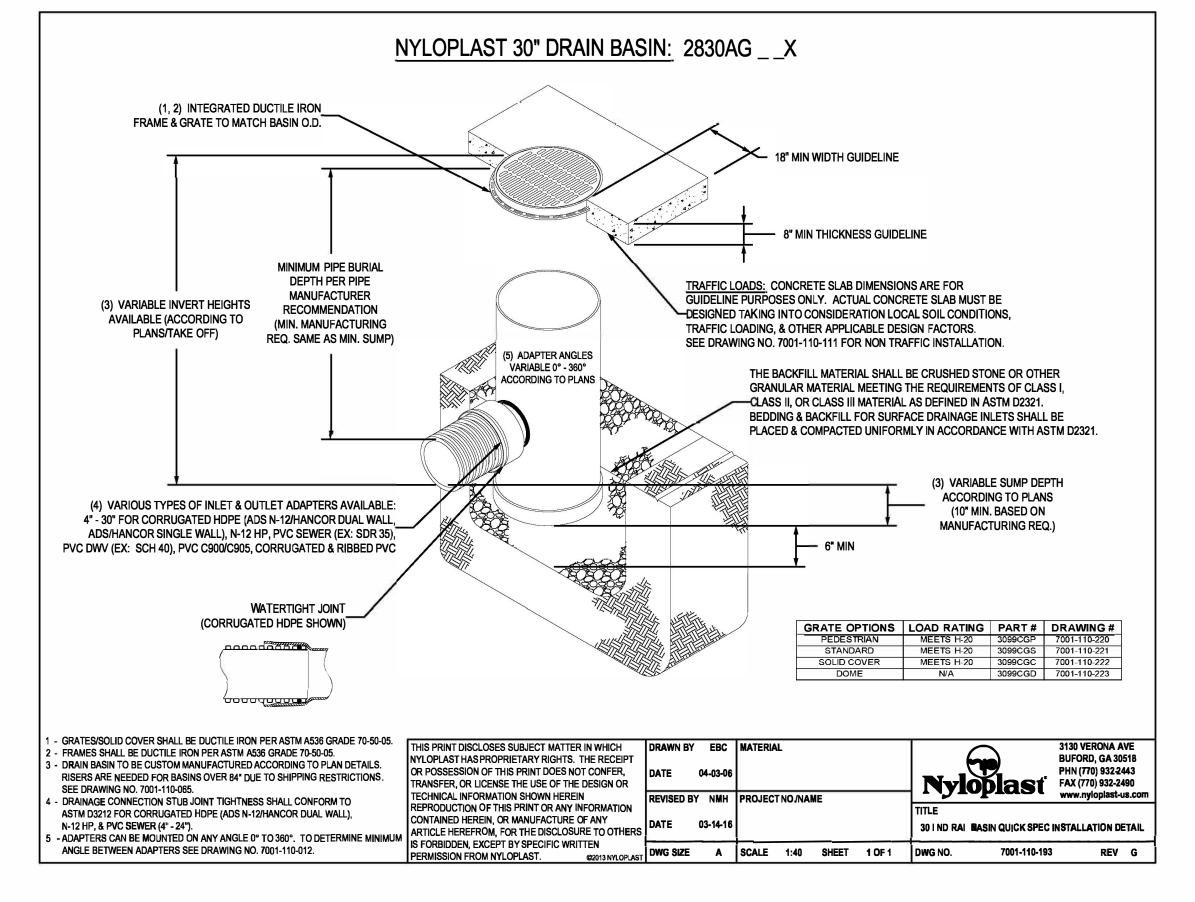

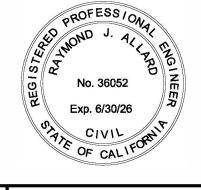

	dir bololo you dig.				
				BENCHMARK:	DESIGNED BY: D.B.W.
				DENCI IMAKK.	BEOIGNES ST
				"H-18"	DRAWN BY:D.B.W
9 (4			,	BRASS DISK IN CONCRETE, LOCATED APPROXIMATELY	
				22 FEET NORTH OF THE NE ECR, BEHIND THE	CHECKED BY: R.J.A.
				SIDEWALK AT THE INTERSECTION OF MAIN ST. & MAPLE ST.	SUBMITTED BY:
				3 11	
REV.	DESCRIPTION DATE	BY	Î	ELEV=3376.492	RAYMOND J. ALLARD RCE No. 36052 DATE
					RATIVIOND J. ALLAND ROE INC. 30032 DATE



HIGH DESERT MAPPING

Land Surveying - Civil Design 16704 Neenach Road Apple Valley, CA 92307 (760) 508-8555

dbw.hdm@gmail.com


CITY OF HESPERIA ENGINEERING DEPARTMENT					
RECOMMENDED FOR APPROVAL BY:	APPROVED BY:				
DATE	CASSANDRA SANCHEZ DATE				
AUTHORIZED SIGNATURE	R.C.E. <u>74776</u> EXP. DATE <u>12/31/25</u> CITY ENGINEER				


CITY OF HESPERIA
NOTES & DETAILS
TAMARISK APARTMENTS


MUNEM MAIDA

APN 3057-121-08

SHEET
2
OF
13
N-1

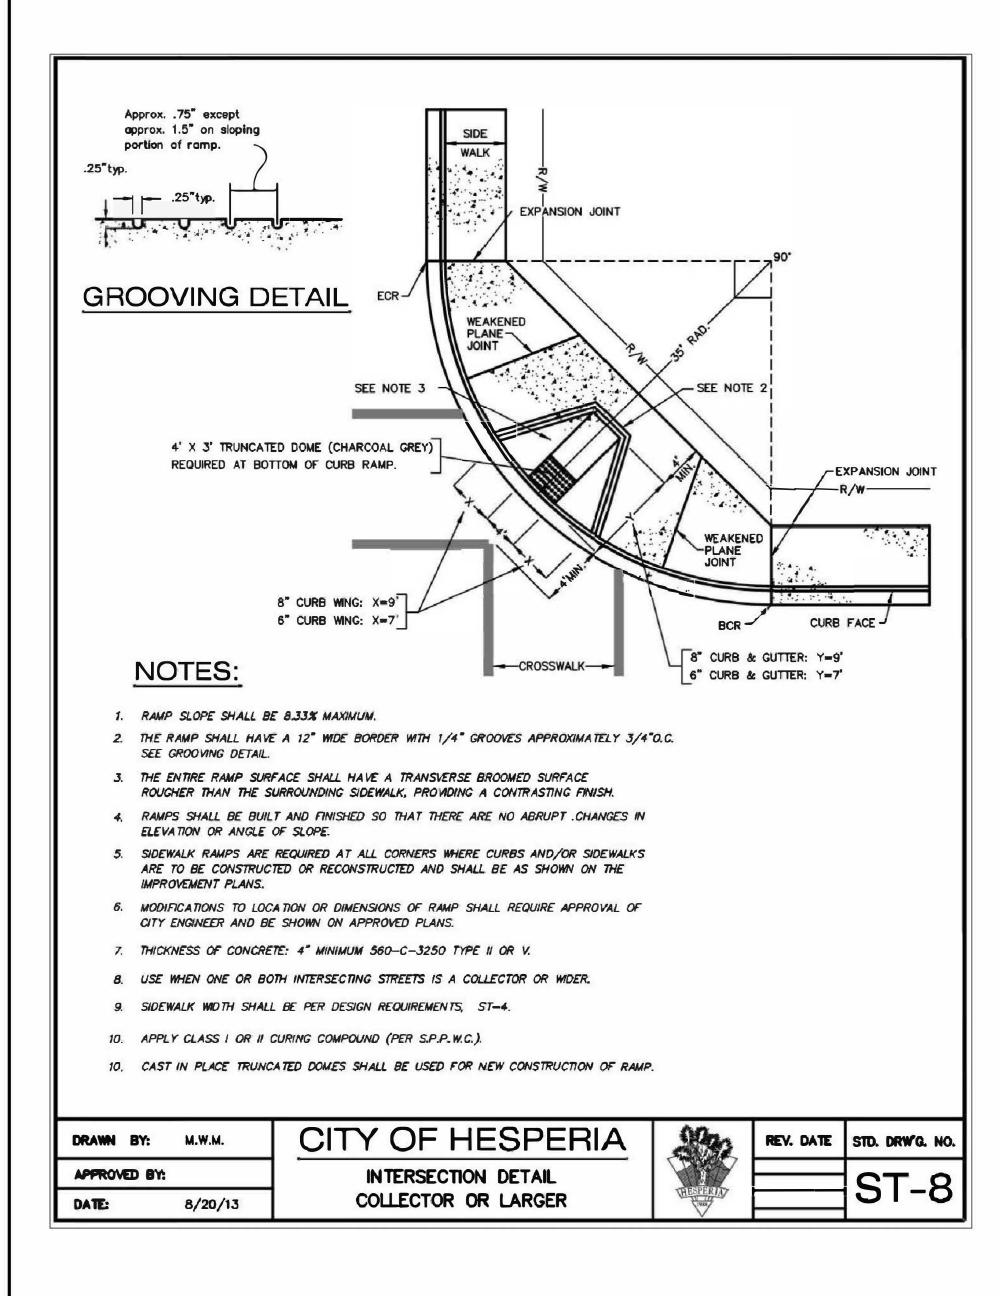

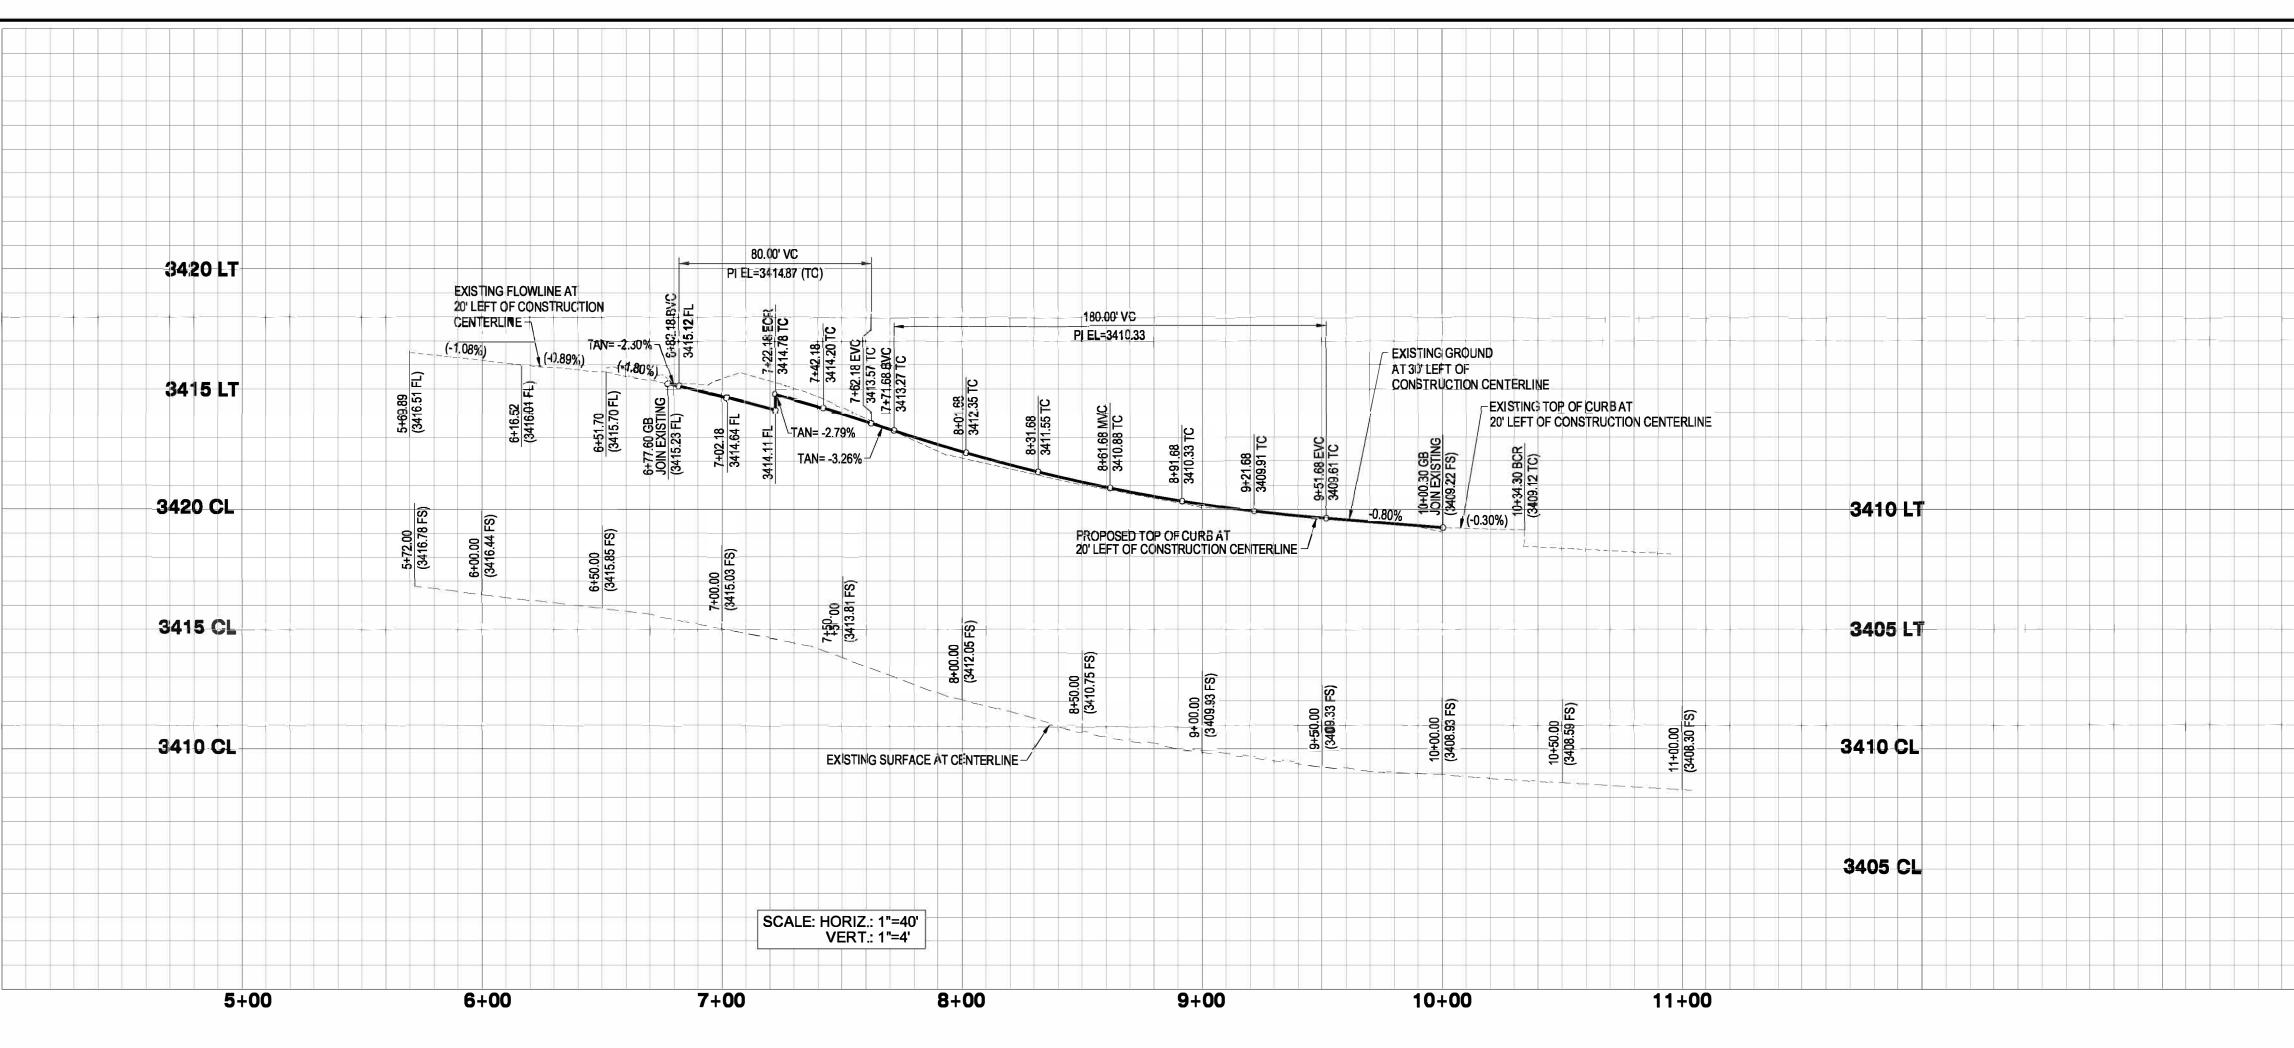

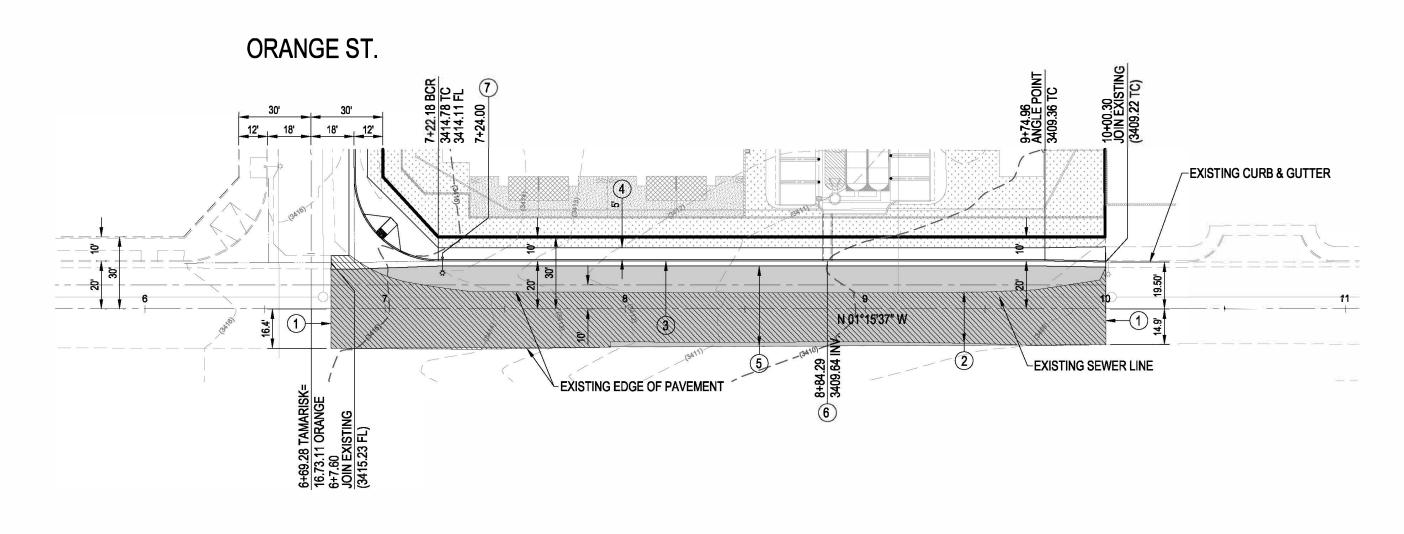



TAMARISK AVENUE

CONSTRUCTION NOTES:

SAWCUT EXISTING PAVEMENT TO A CLEAN STRAIGHT LINE, FEATHER EDGE OVER FOR A SMOOTH TRANSITION 2' MIN.	78 L.F.
REMOVE EXISTING IMPROVEMENTS TO THE LIMITS SHOWN	7,550 S.F.
CONSTRUCT 8" CURB AND GUTTER PER SPPWC 120-2 (A2-8)	278 L.F.
CONSTRUCT SIDEWALK PER CITY STD. ST-4, TYPE A	1,390 S.F.
CONSTRUCT 6.5" AC PAVEMENT OVER 9" CLASS II BASE	
CONSTRUCT PARKWAY DRAIN PER APWA STD. 151-2, W=3'0"	э гленията , 1 ЕА .
NSTALL STREET LIGHT PER CITY STD. ST-10	2 EA.



Know what's below.
Call before you dig.

			BENCHMARK:
			"H-18"
			BRASS DISK IN CONCRETE, LOCATED API
			22 FEET NORTH OF THE NE ECR, BEHIND
			SIDEWALK AT THE INTERSECTION OF MA ST.
REV.	DESCRIPTION DATE	BY	ELEV=3376.492

DESIGNED BY: D.B.W. __D.B.W. DRAWN BY: APPROXIMATELY CHECKED BY: R.J.A. ND THE MAIN ST. & MAPLE SUBMITTED BY:

RAYMOND J. ALLARD RCE No. 36052



DATE

HIGH DESERT MAPPING

Land Surveying - Civil Design 16704 Neenach Road Apple Valley, CA 92307 (760) 508-8555


dbw.hdm@gmail.com


	TESPERIA DEPARTMENT
RECOMMENDED FOR APPROVAL BY:	APPROVED BY:
DATE	CASSANDRA SANCHEZ DATE R.C.E. 74776 EXP. DATE 12/31/25
AUTHORIZED SIGNATURE	R.C.E. <u>74776</u> EXP. DATE <u>12/31/25</u> CITY ENGINEER


CITY OF HESPERIA
TREET IMPROVEMENT PLAN
TAMARISK APARTMENTS
MUNEM MAIDA

APN 3057-121-08

SHEET
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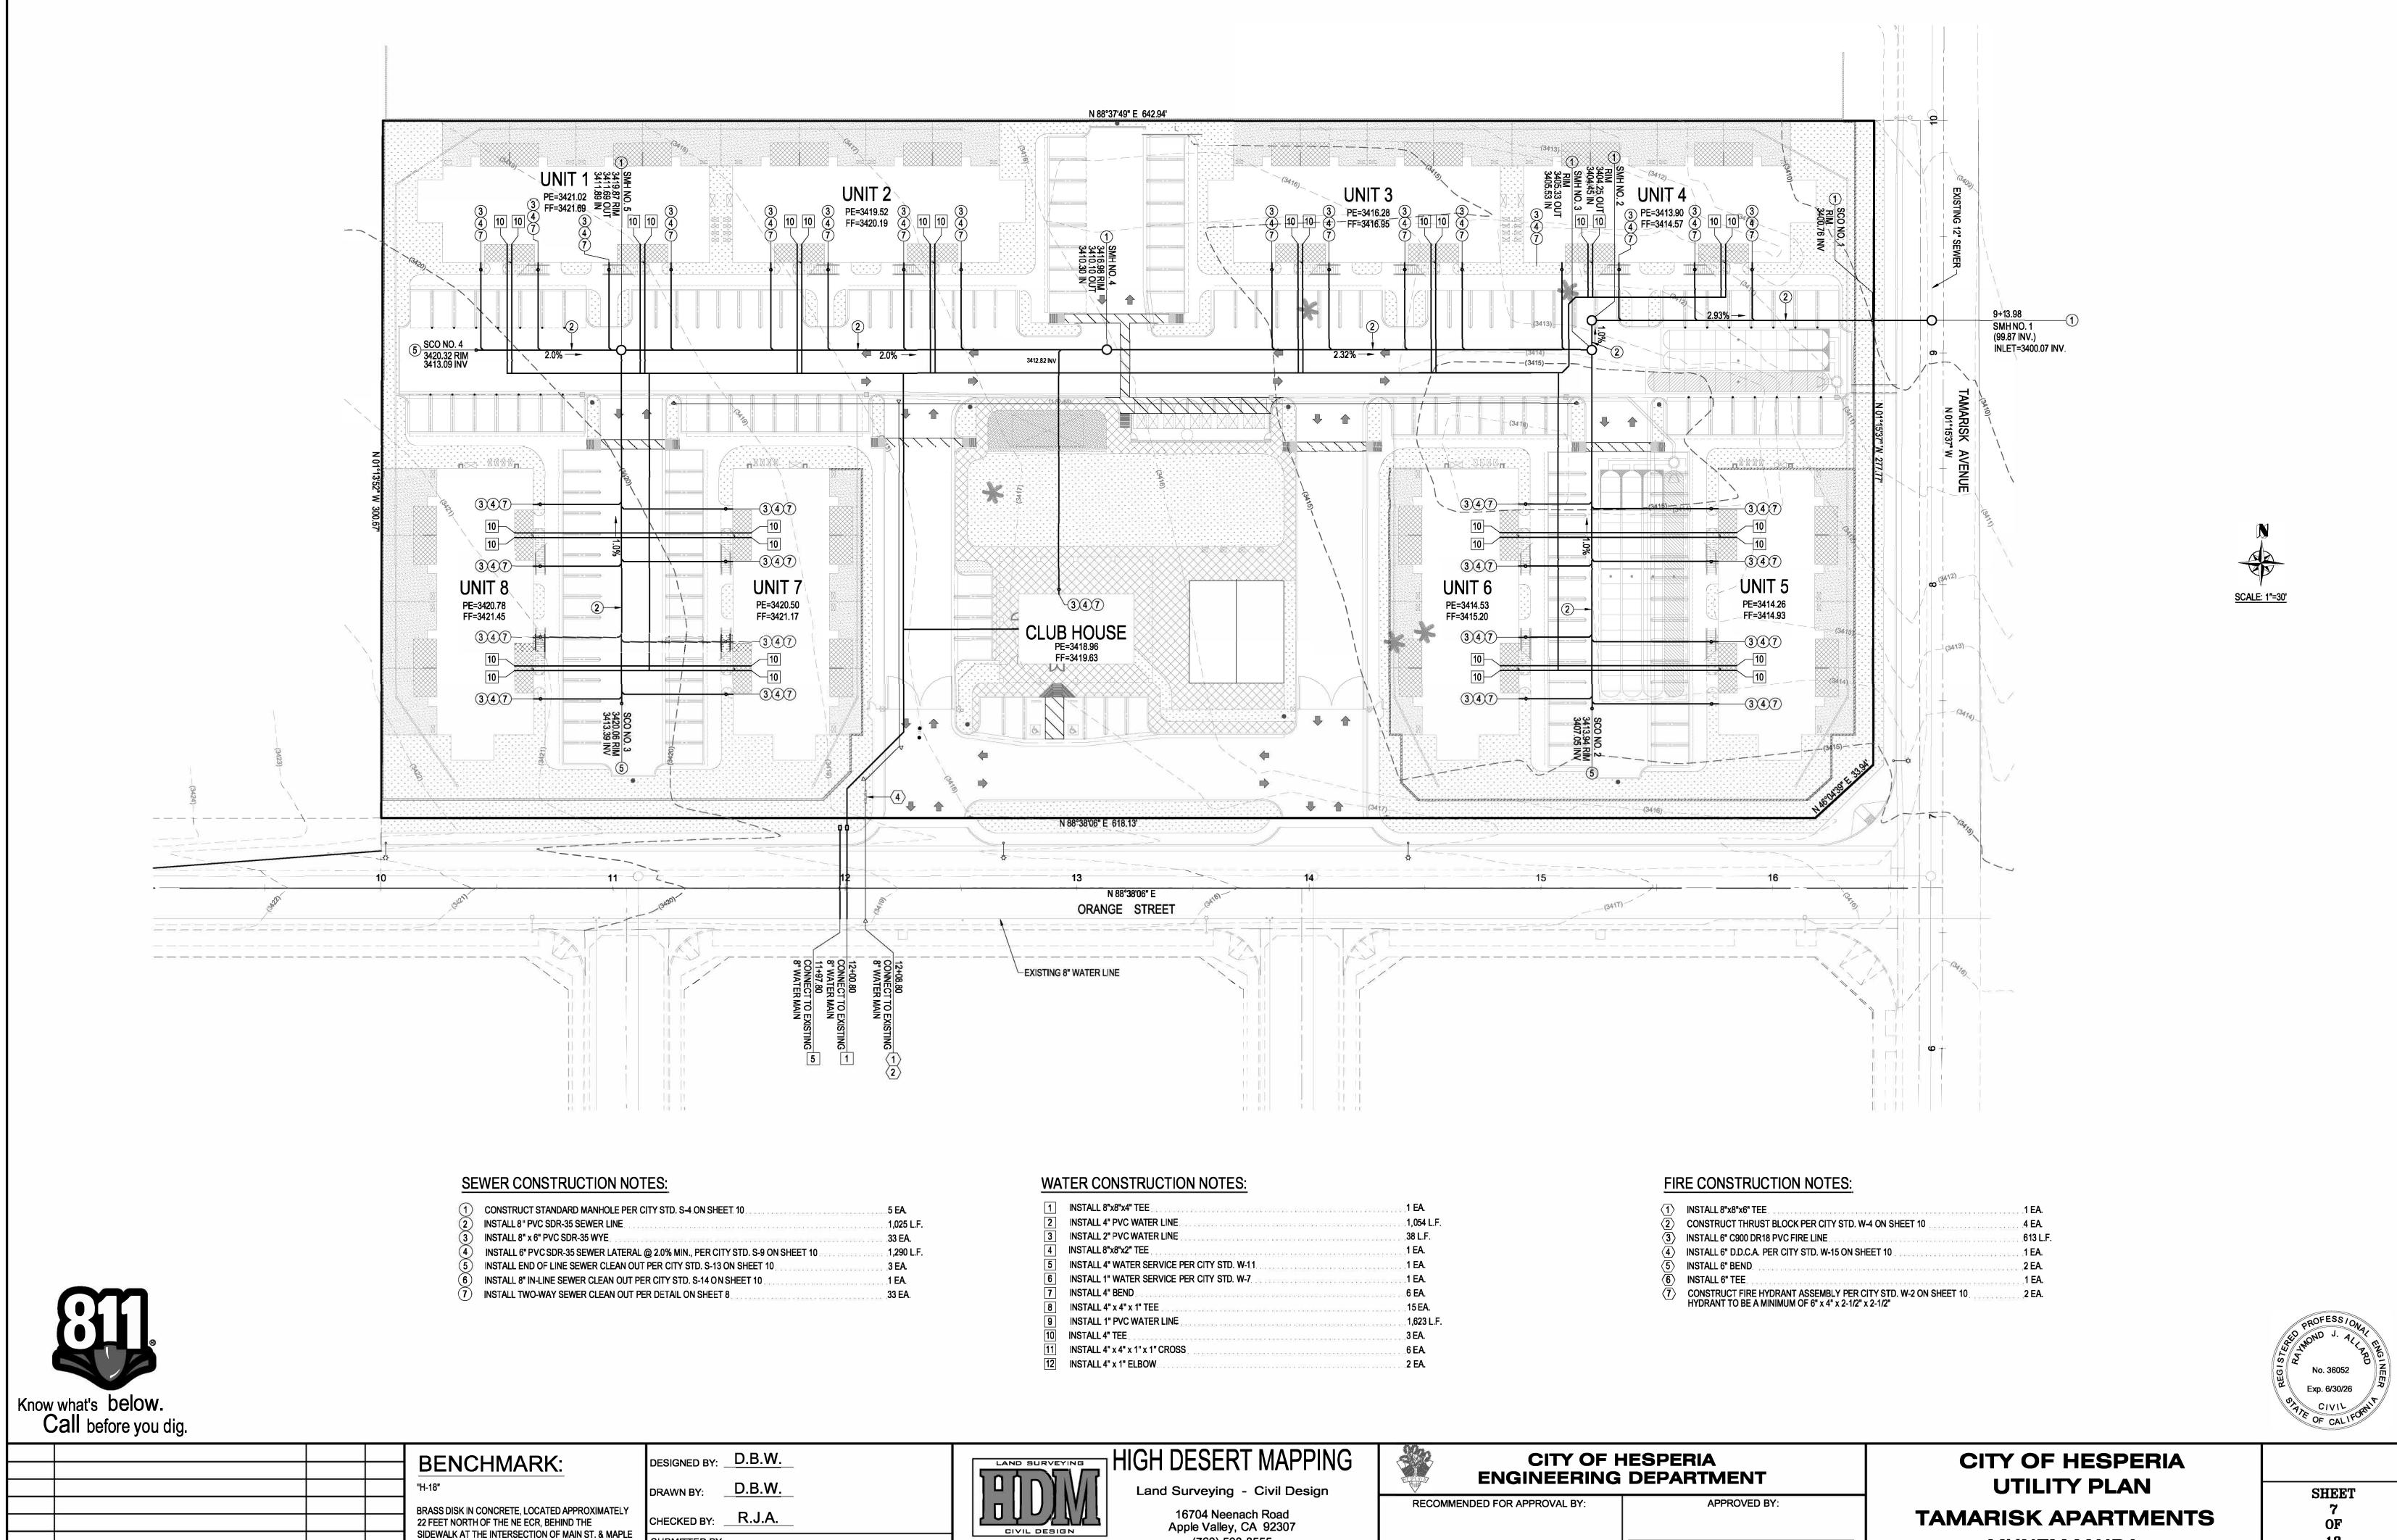


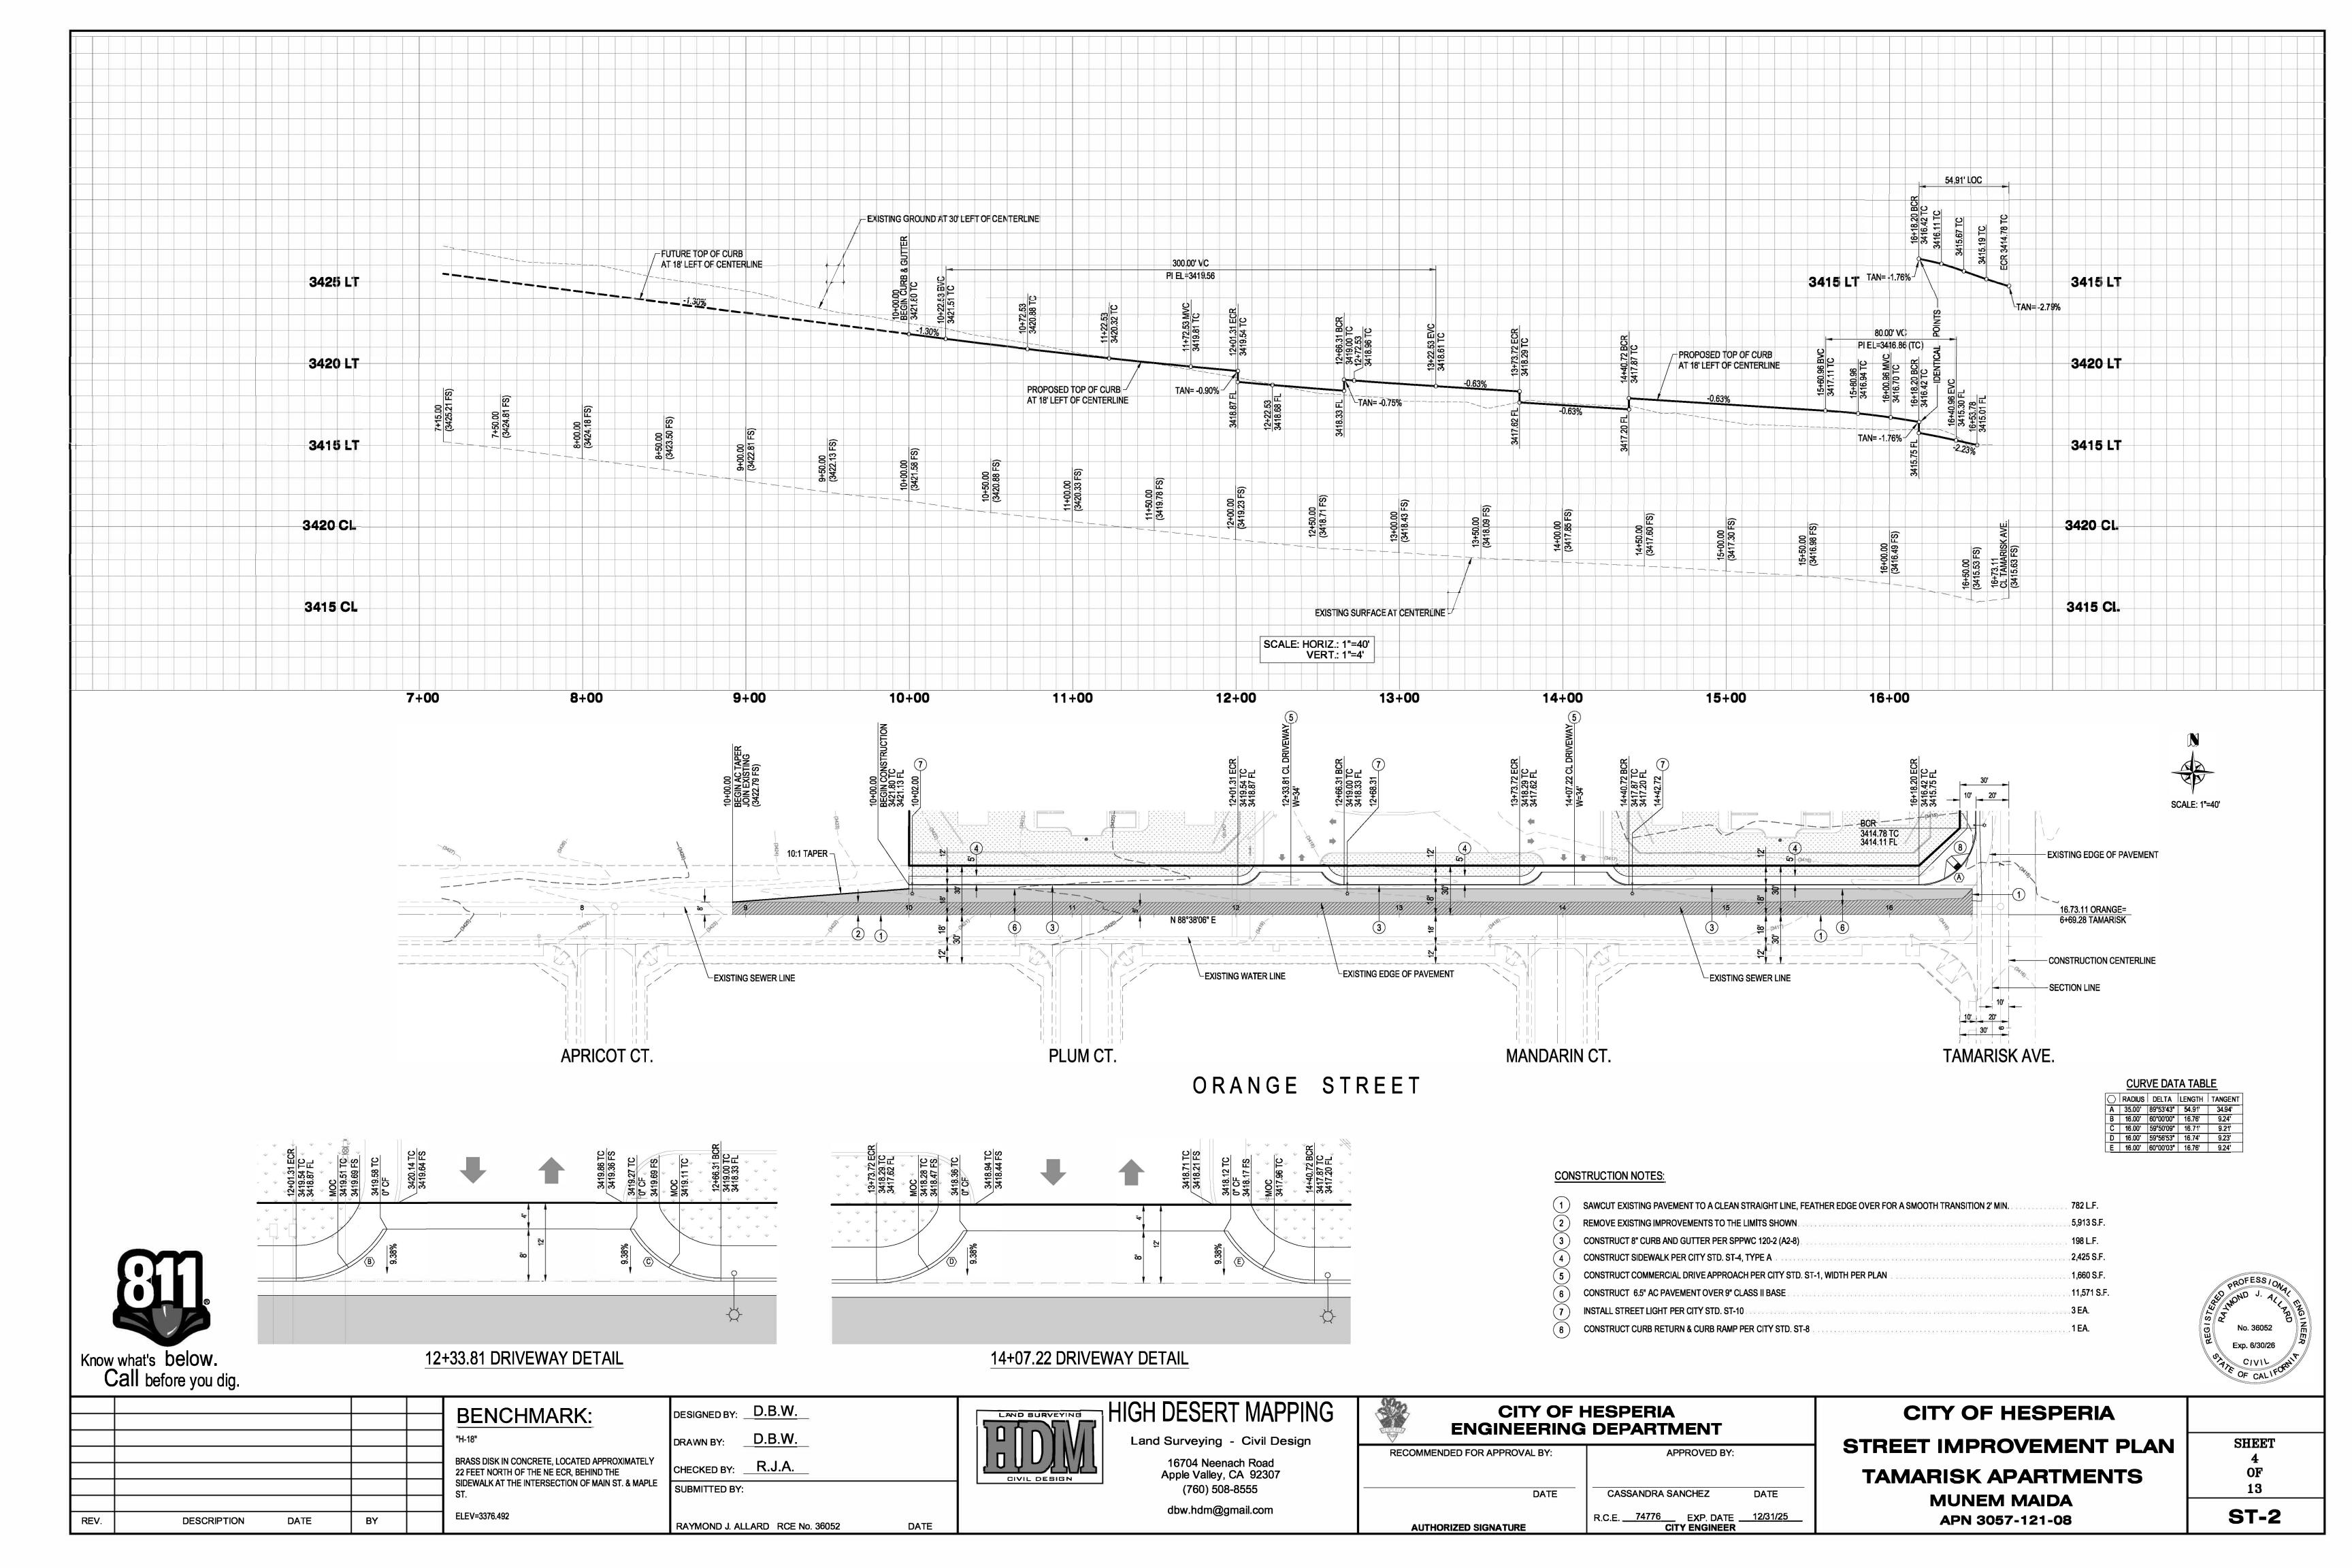

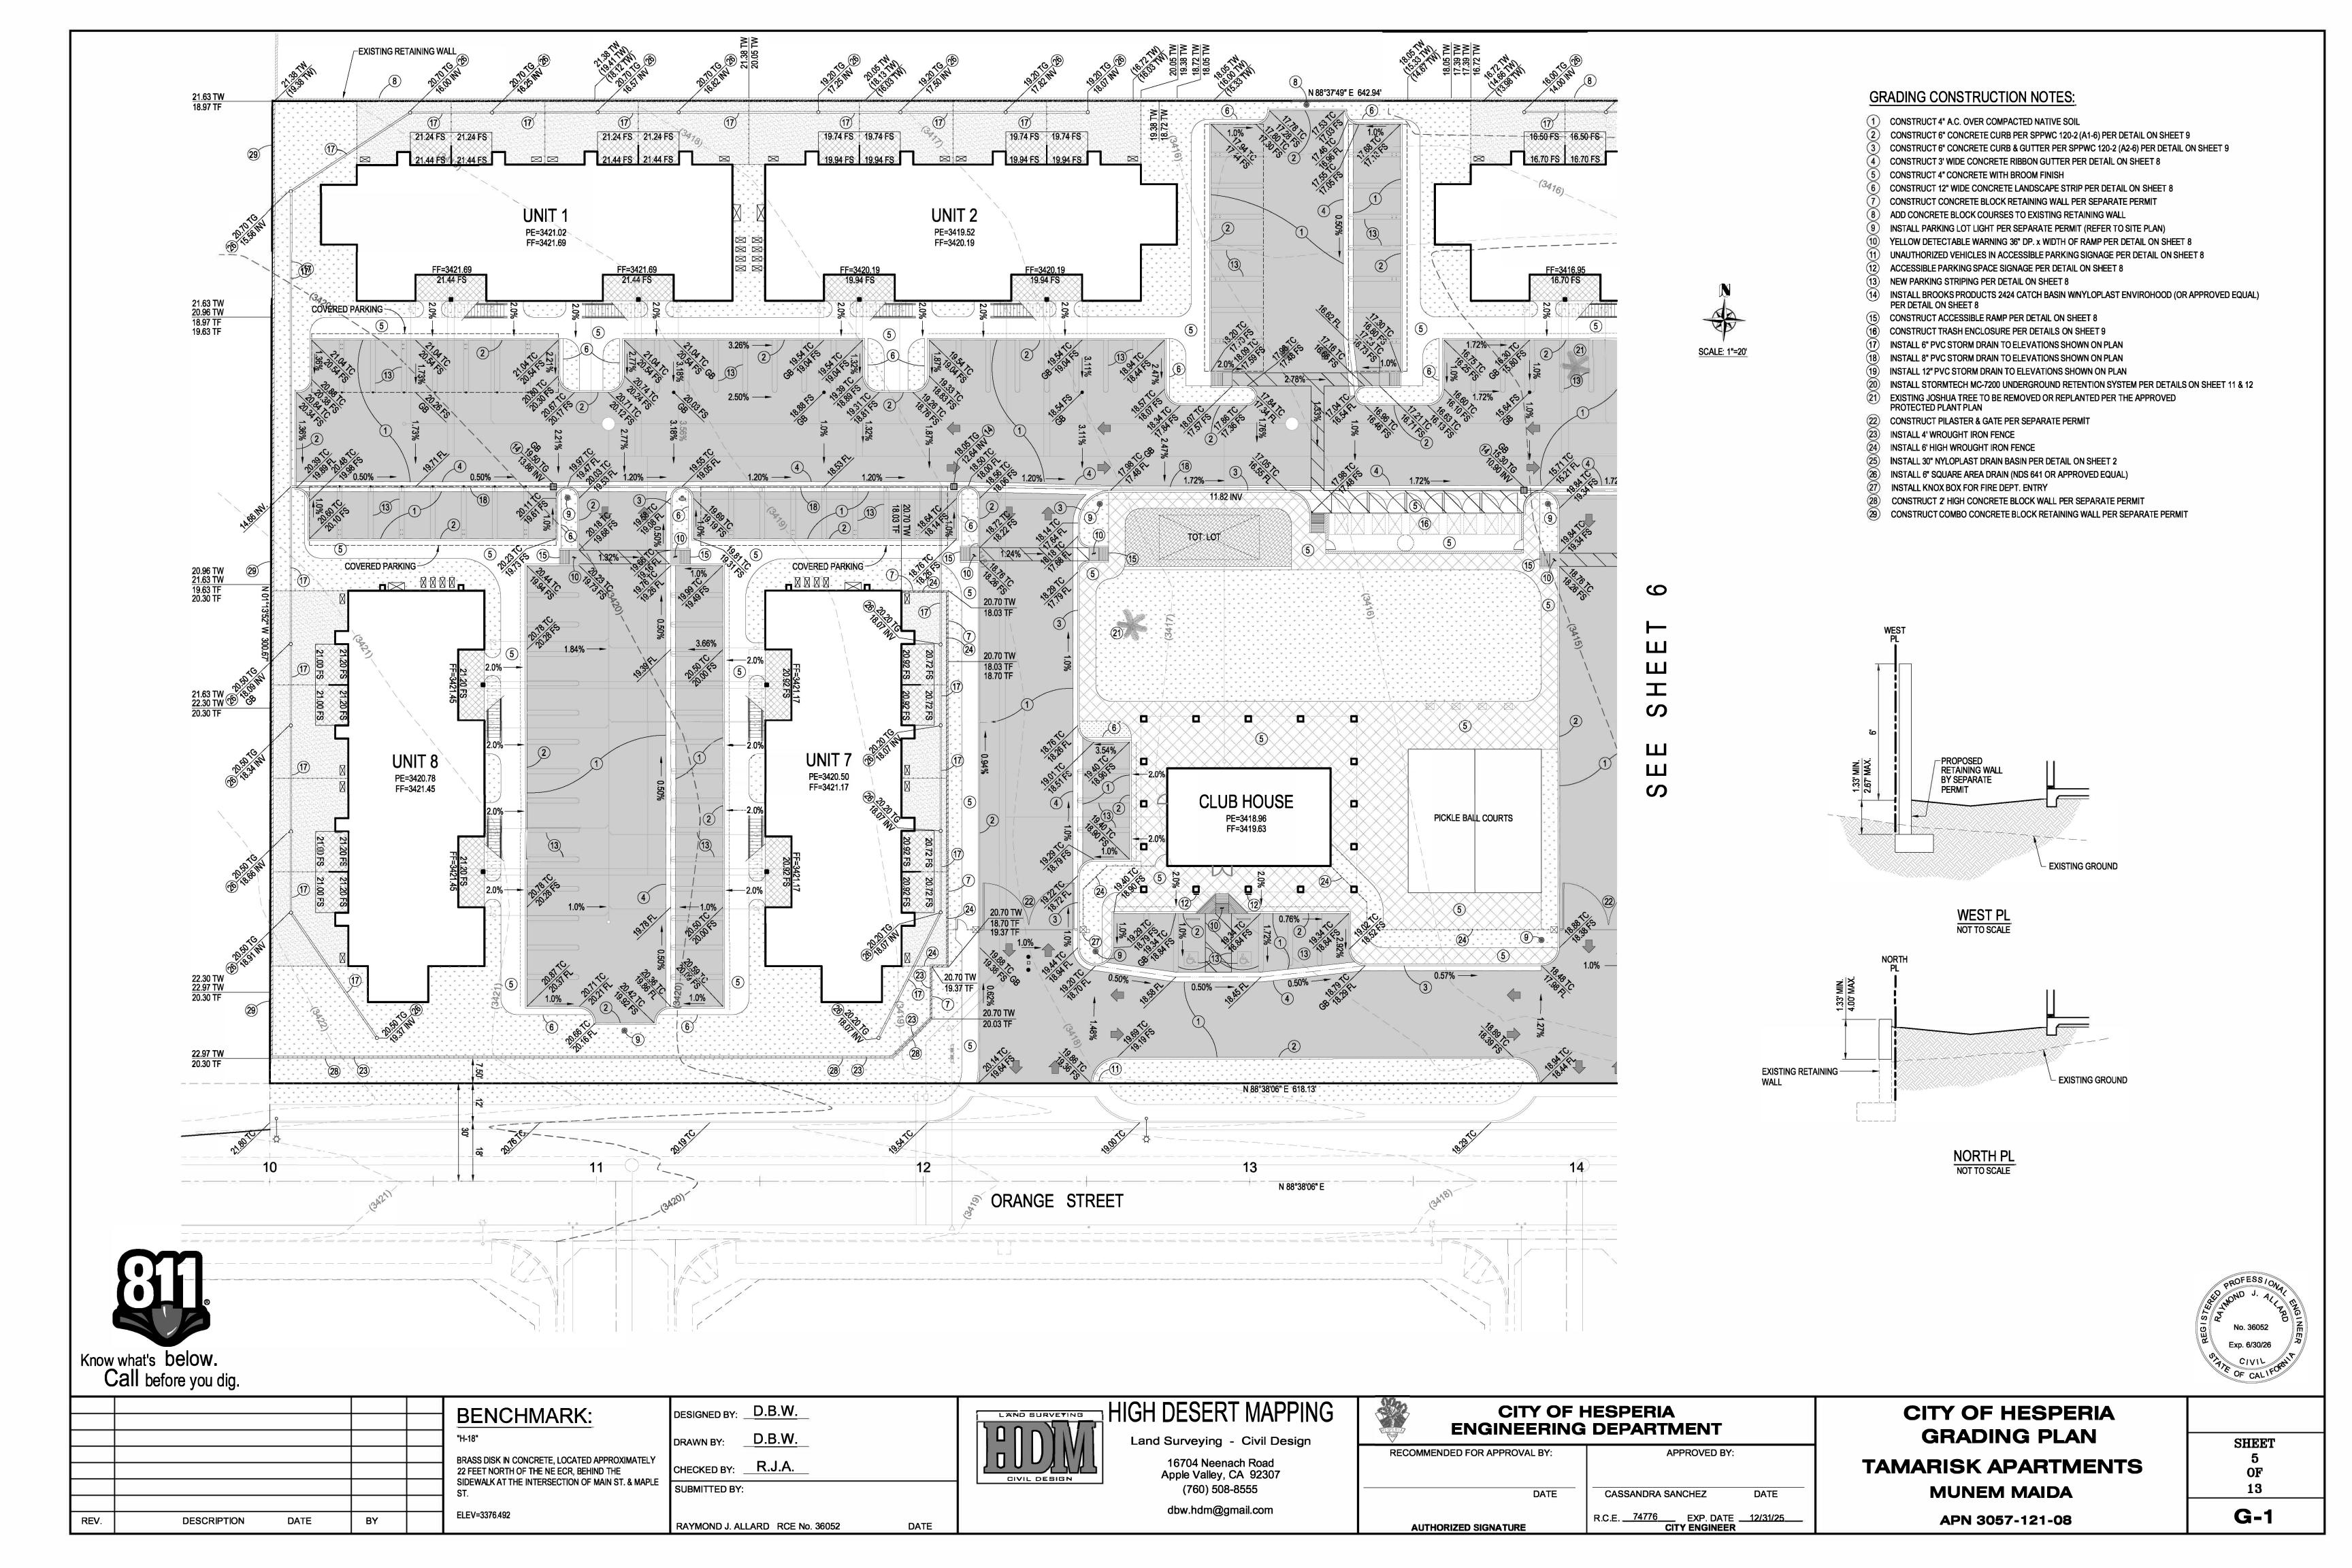		BENCHMARK:	DESIGNED BY:D.B.W		HIGH DESERT MAPPING		HESPERIA DEPARTMENT	CITY OF HESPERIA	
Q G		"H-18"	DRAWN BY:D.B.W		Land Surveying - Civil Design	RECOMMENDED FOR APPROVAL BY:	APPROVED BY:	GRADING PLAN	SHEET
		•	CHECKED BY: R.J.A.		16704 Neenach Road Apple Valley, CA 92307			TAMARISK APARTMENTS	OF
		SIDEWALK AT THE INTERSECTION OF MAIN ST. & MAPLE ST.	SUBMITTED BY:		(760) 508-8555	DATE	CASSANDRA SANCHEZ DATE	MUNEM MAIDA	13
REV.	DESCRIPTION DATE BY	ELEV=3376.492	RAYMOND J. ALLARD RCE No. 36052	DATE	dbw.hdm@gmail.com	AUTHORIZED SIGNATURE	R.C.E. <u>74776</u> EXP. DATE <u>12/31/25</u> CITY ENGINEER	APN 3057-121-08	G-2
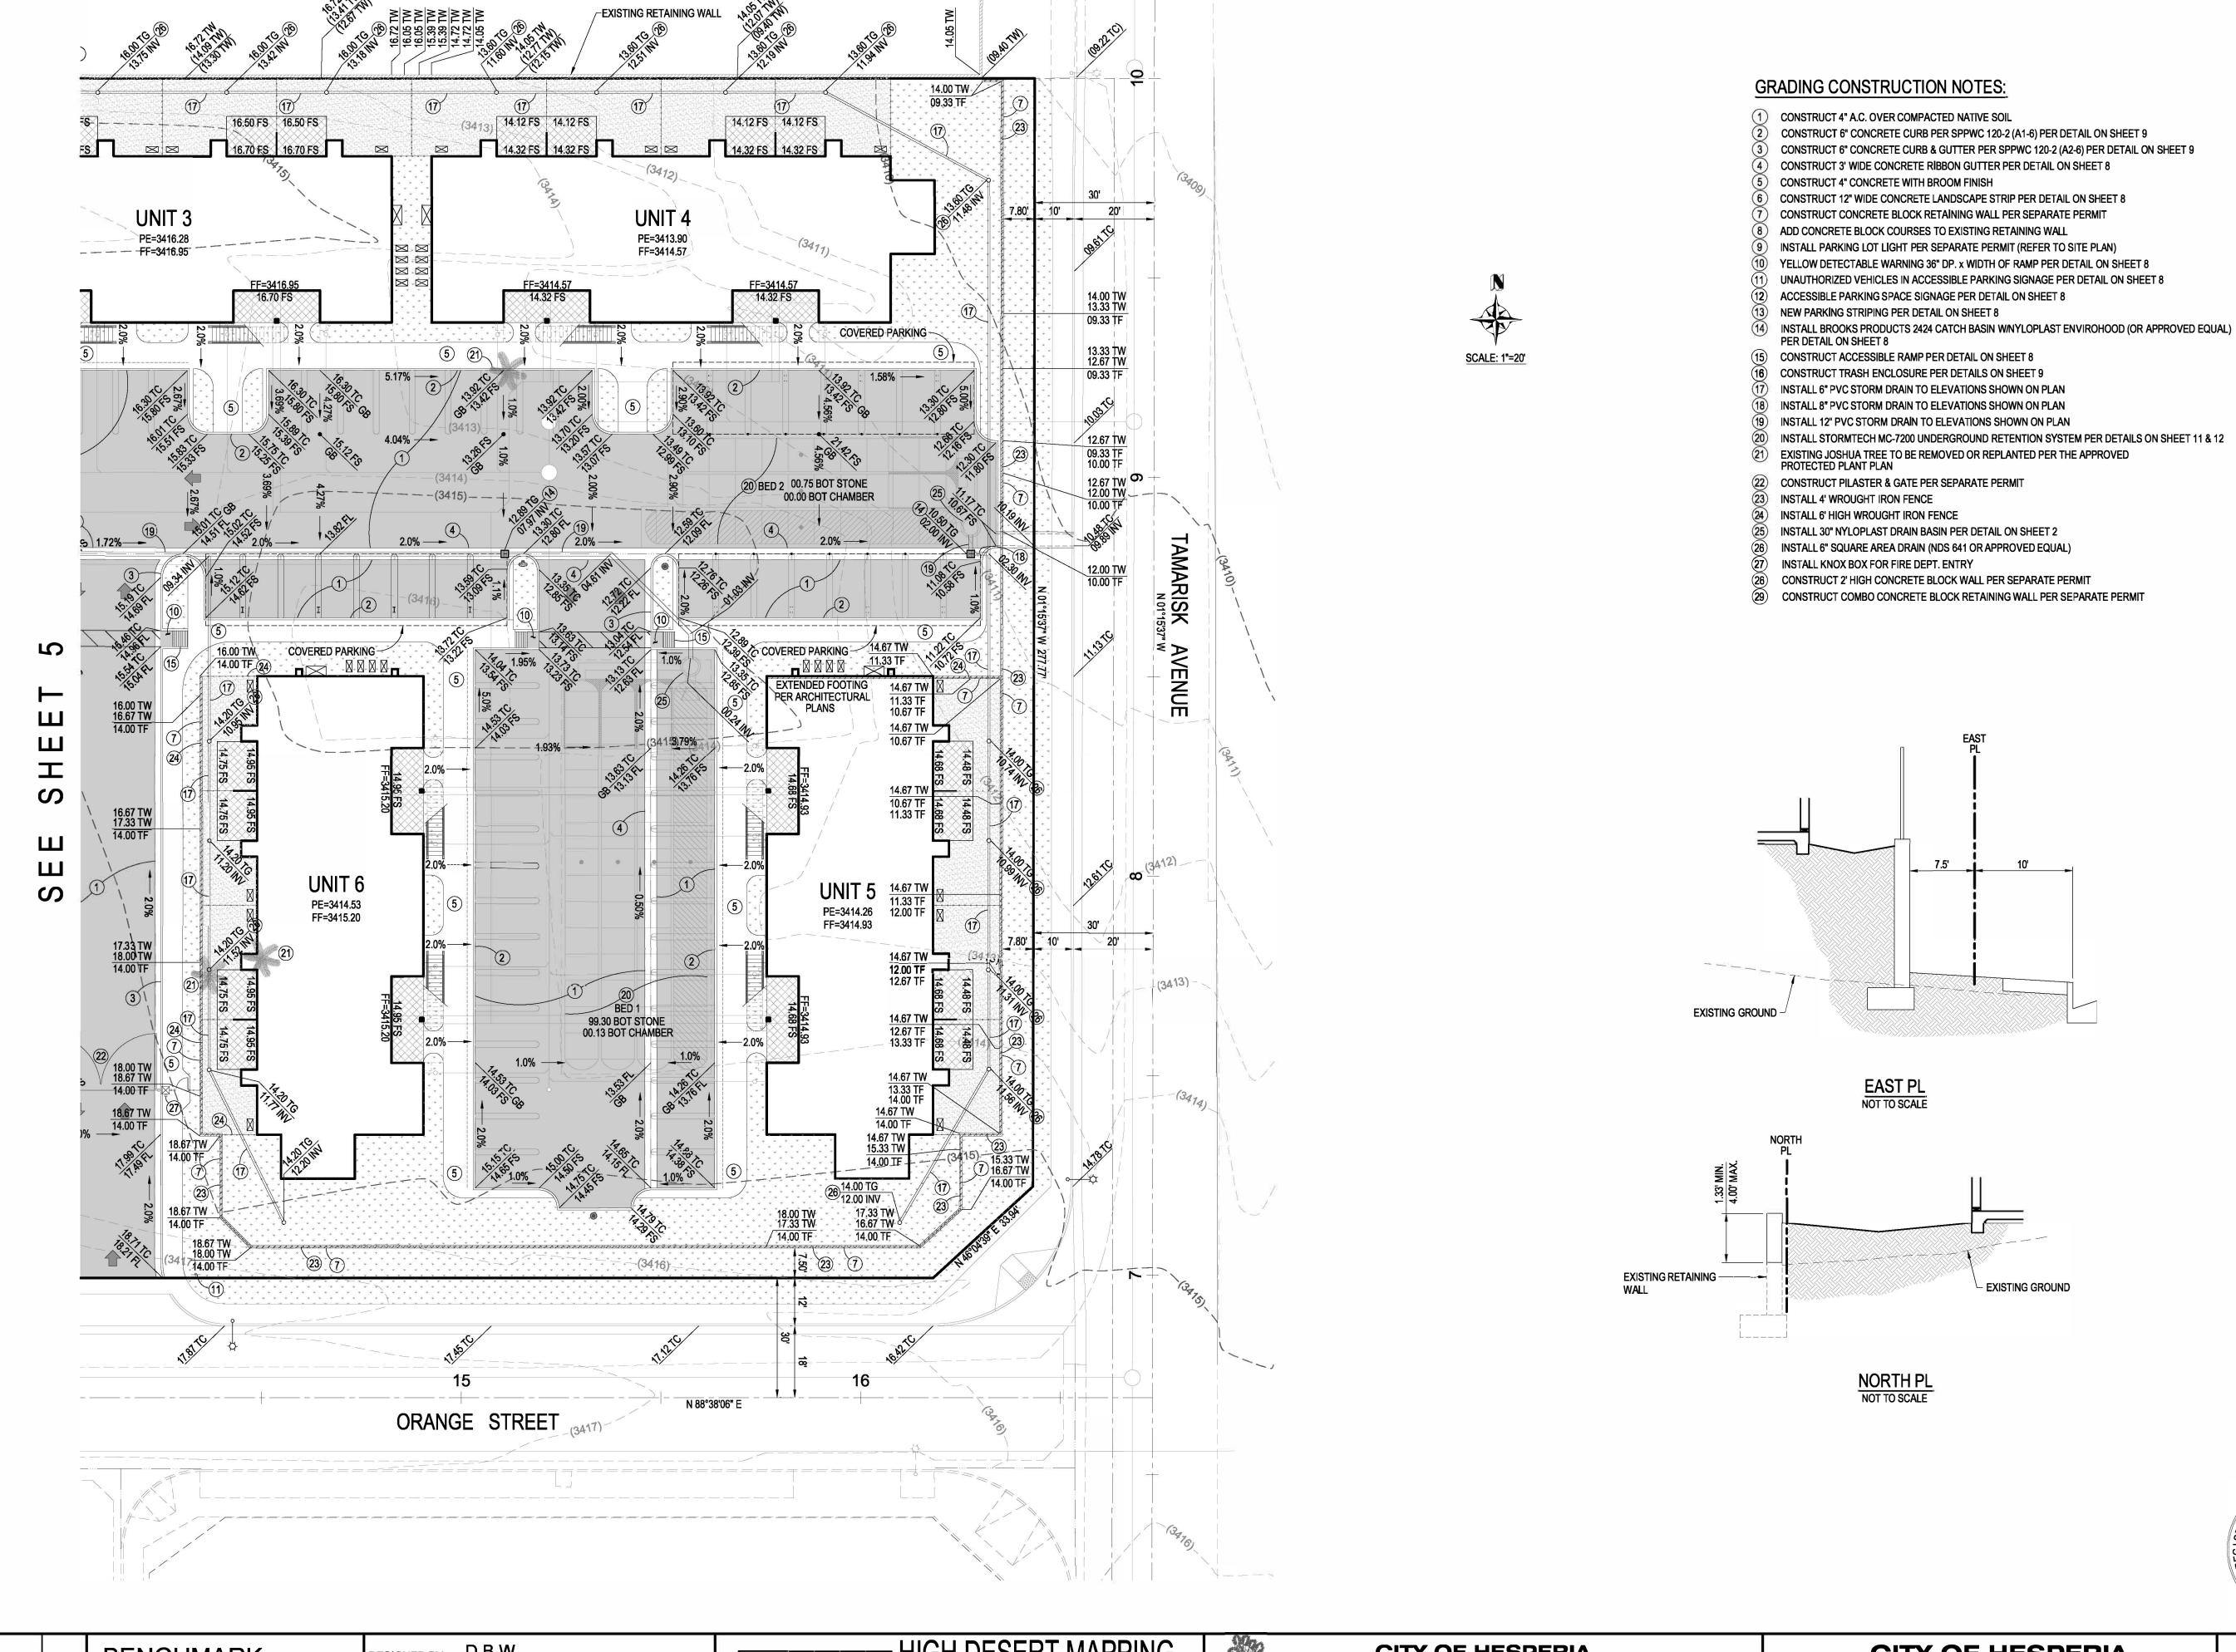
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(760) 508-8555

dbw.hdm@gmail.com

SUBMITTED BY:

RAYMOND J. ALLARD RCE No. 36052

ELEV=3376.492

DESCRIPTION

13 **U-1**

MUNEM MAIDA

APN 3057-121-08


CASSANDRA SANCHEZ


R.C.E. <u>74776</u> EXP. DATE <u>12/31/25</u> CITY ENGINEER


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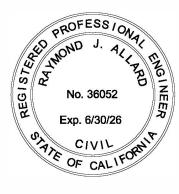
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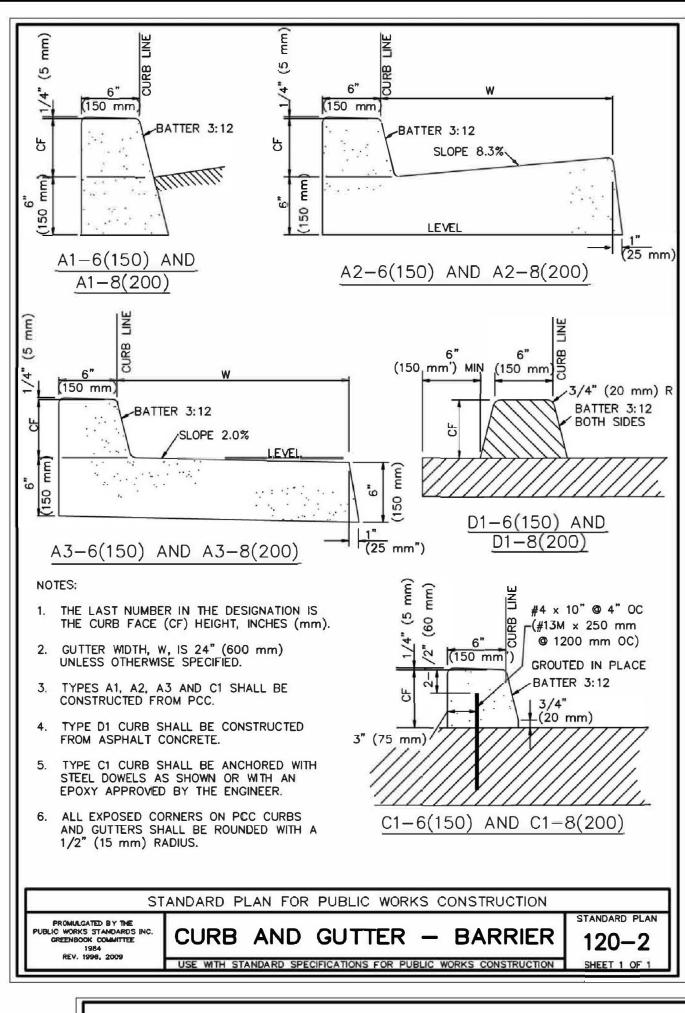








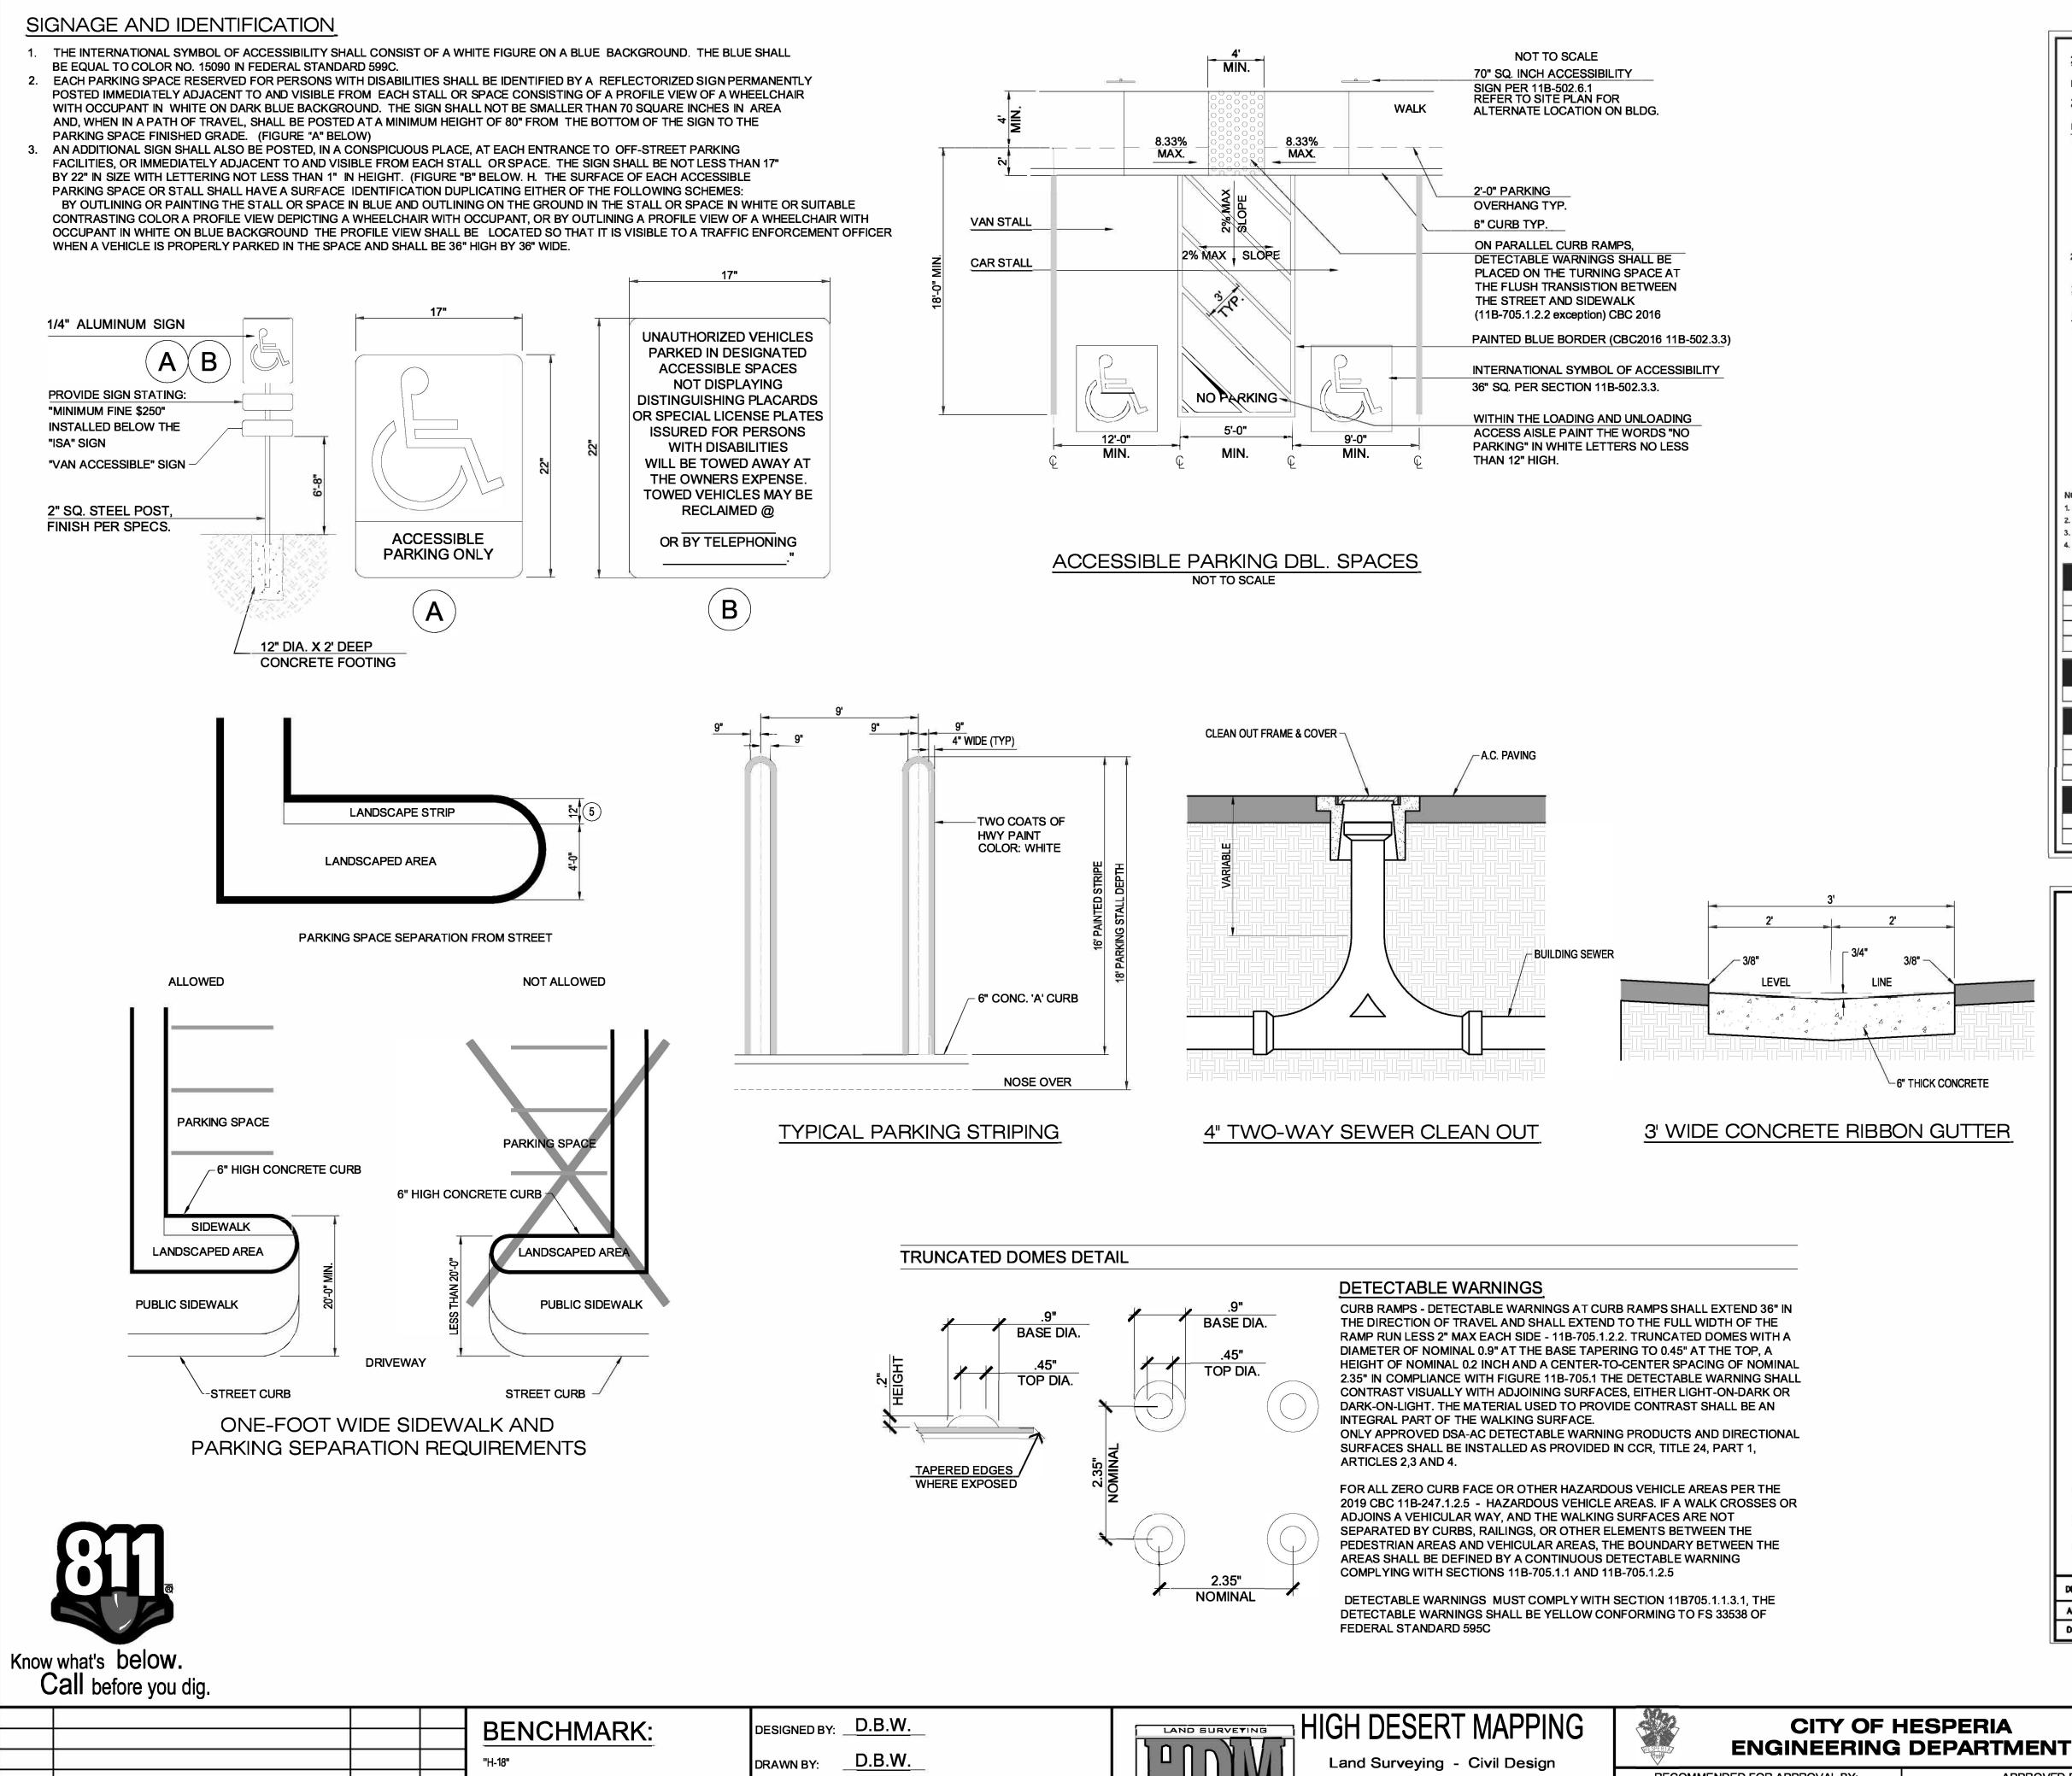


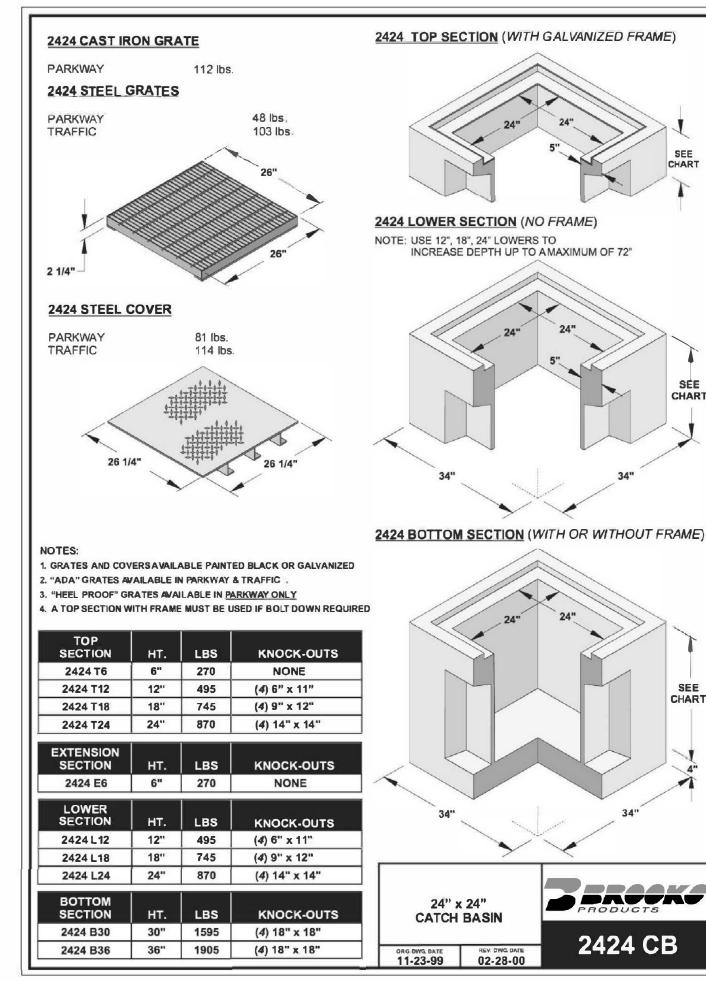
Call before you dig.									OF CALIFOR		
			BENCHMARK:	DESIGNED BY: D.B.W.		LAND SURVEYING	HIGH DESERT MAPPING		HESPERIA G DEPARTMENT	CITY OF HESPERIA	
5			"H-18" BRASS DISK IN CONCRETE, LOCATED APPROXIMATELY	DRAWN BY: D.B.W.			Land Surveying - Civil Design 16704 Neenach Road	RECOMMENDED FOR APPROVAL BY:	APPROVED BY:	DETAILS	SHEET 8
			22 FEET NORTH OF THE NE ECR, BEHIND THE SIDEWALK AT THE INTERSECTION OF MAIN ST. & MAPLE	CHECKED BY: R.J.A. SUBMITTED BY:		CIVIL DESIGN	Apple Valley, CA 92307 (760) 508-8555	DATE	CASSANDRA SANCHEZ DATE	TAMARISK APARTMENTS	OF 13
REV.	DESCRIPTION DATE	BY	ELEV=3376.492	RAYMOND J. ALLARD RCE No. 36052	DATE		dbw.hdm@gmail.com	AUTHORIZED SIGNATURE	R.C.E. 74776 EXP. DATE 12/31/25 CITY ENGINEER	MUNEM MAIDA APN 3057-121-08	D-1

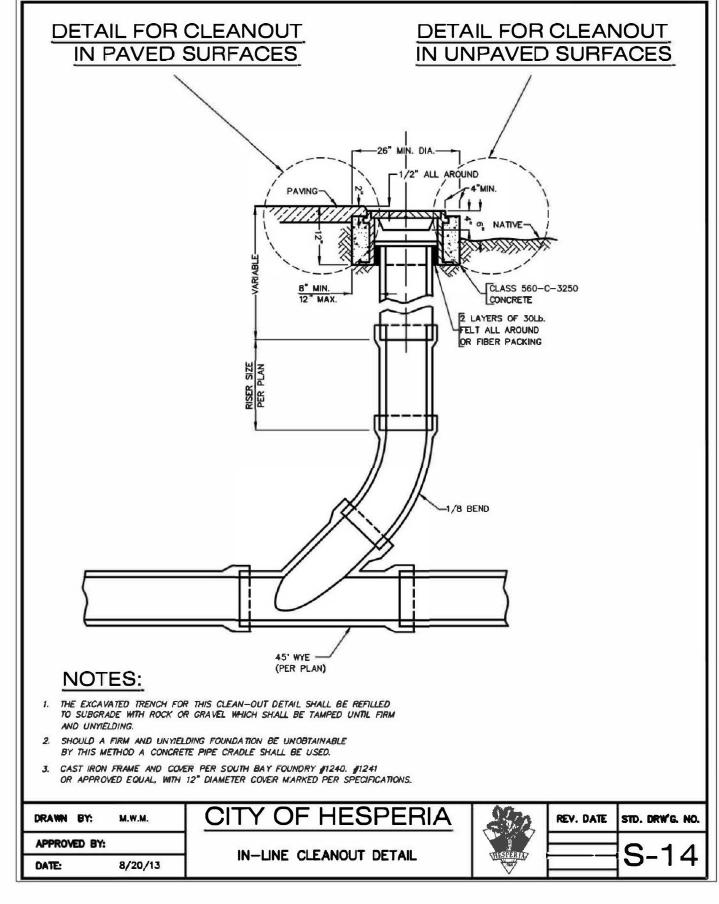

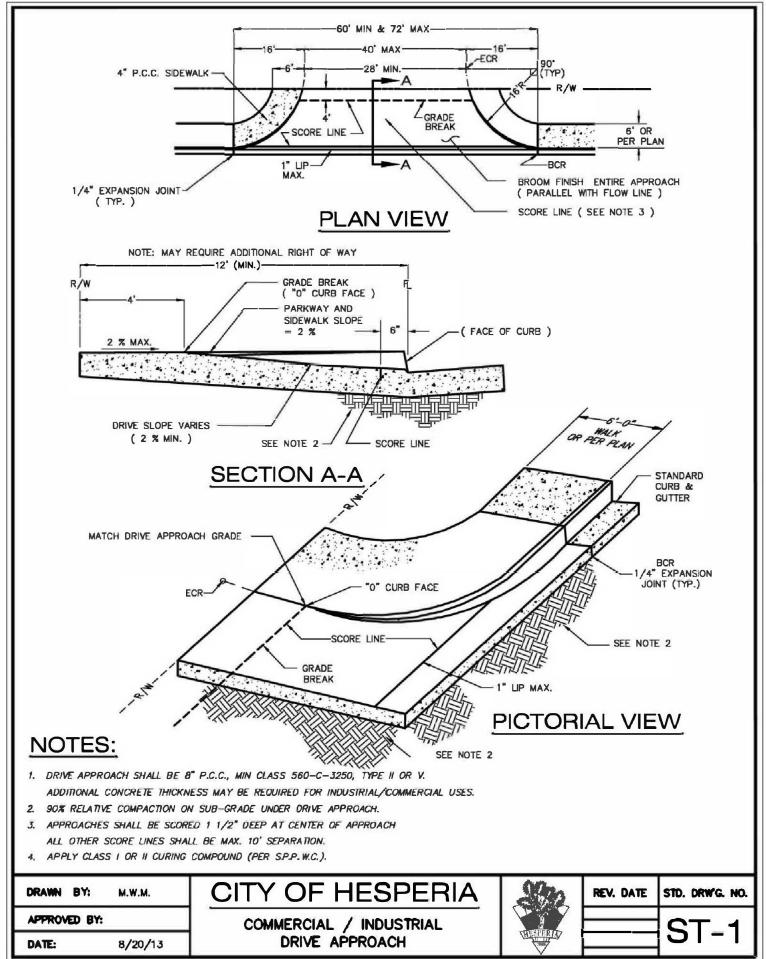


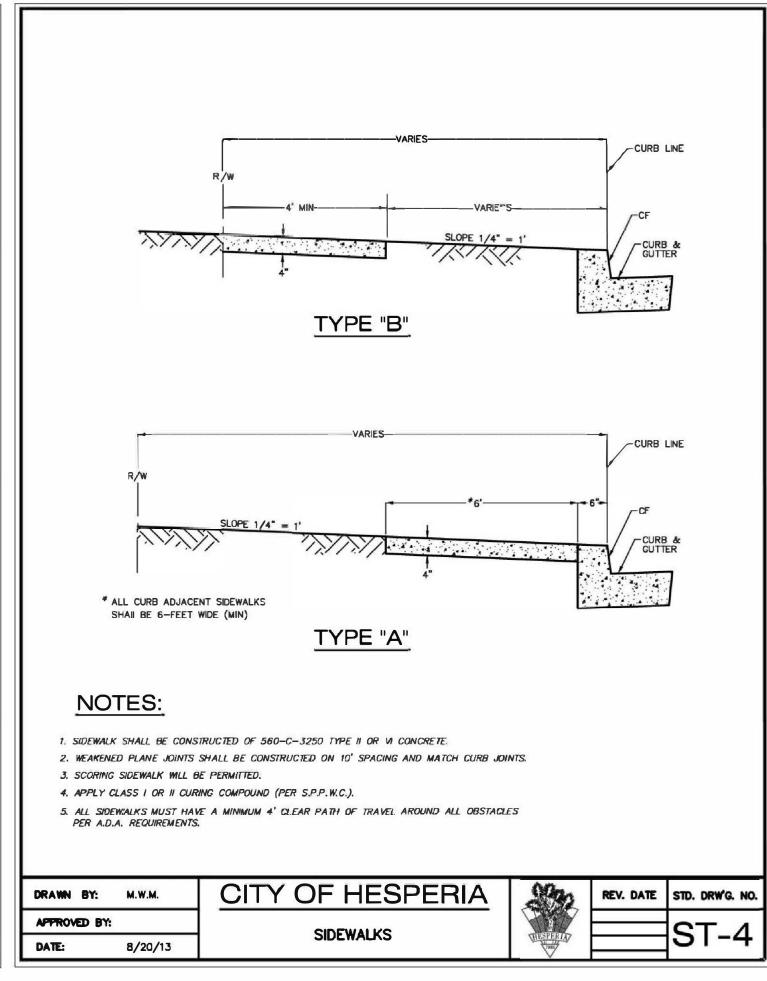

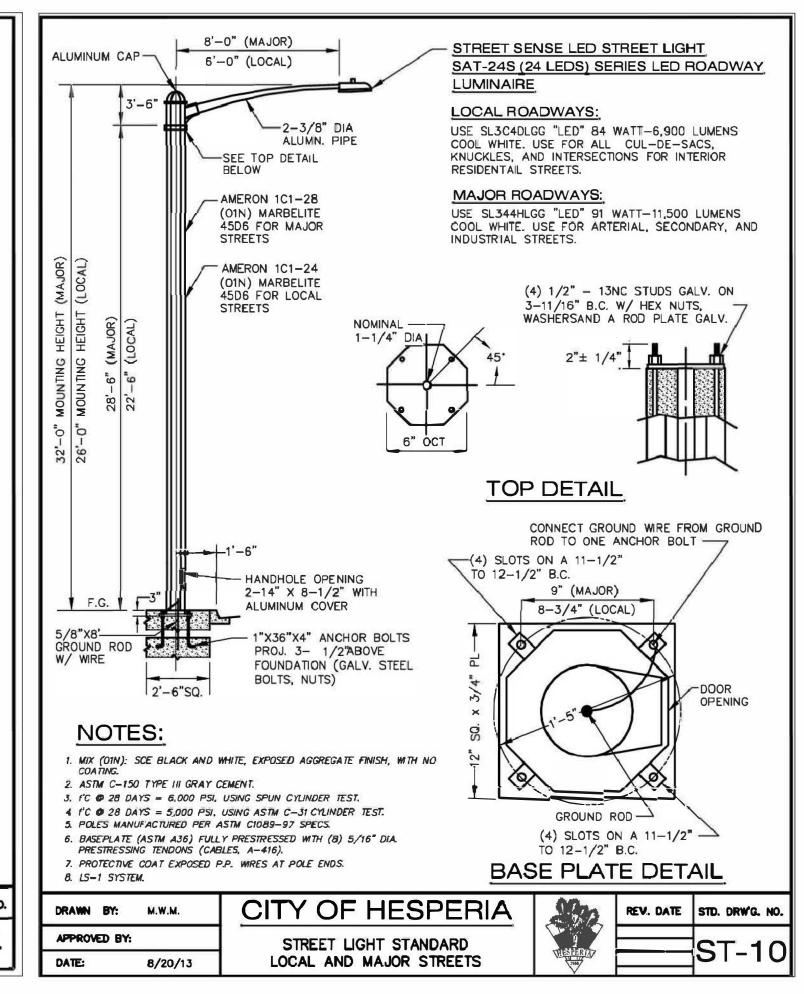


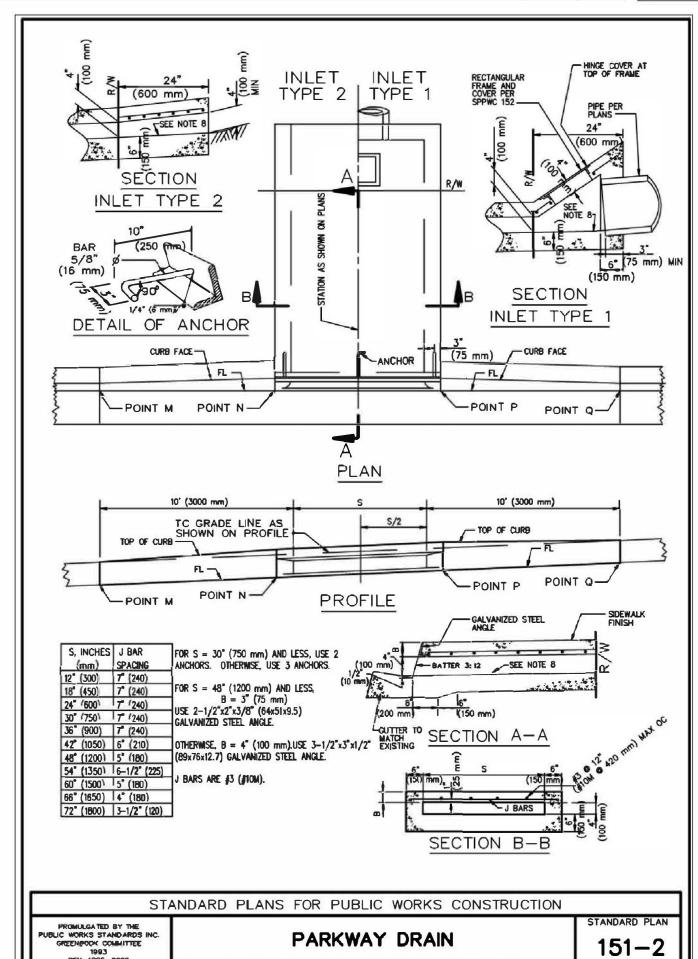

USE WITH STANDARD SPECIFICATIONS FOR PUBLIC WORKS CONSTRUCTION

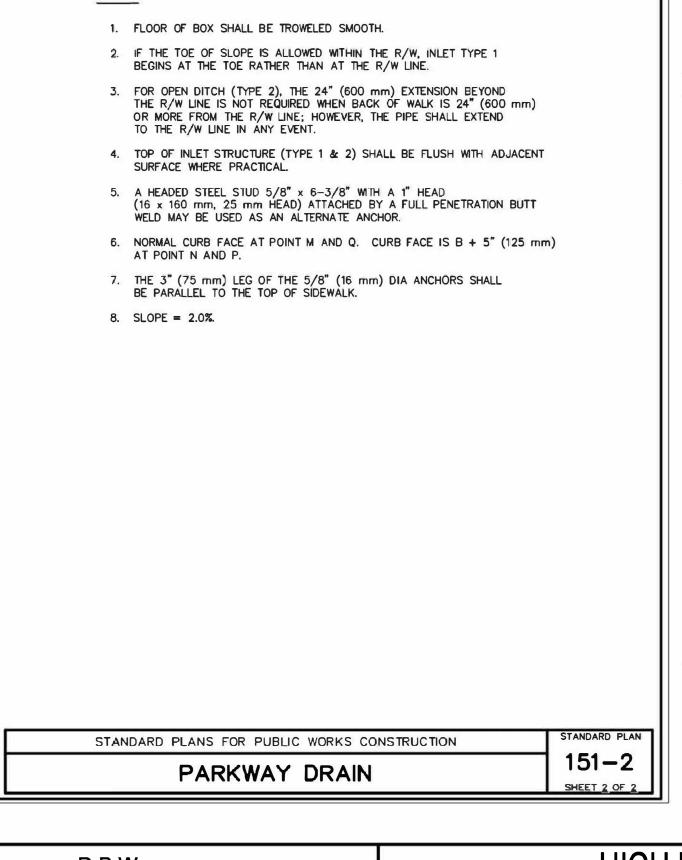


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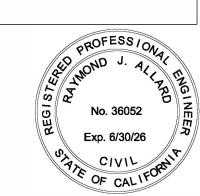
KEY NOTES:

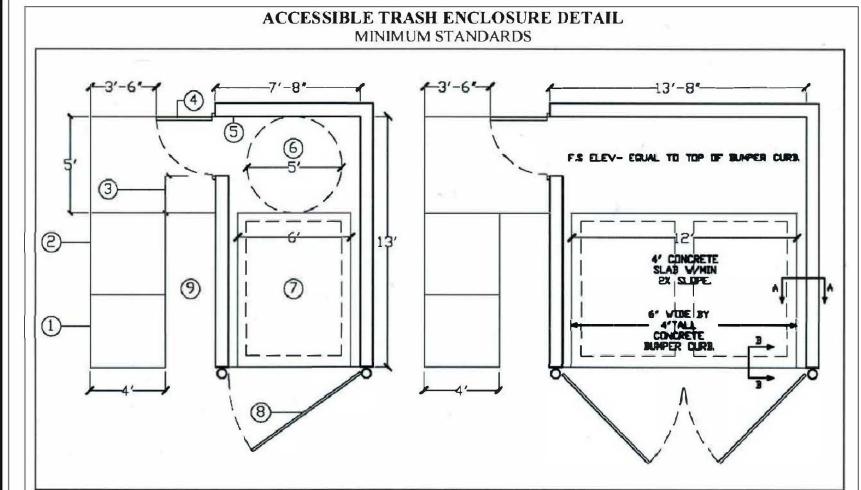- 1. Landing @ lower level (min. 6' L.)
- 2. Min 48" wide ramp @ max. 1:12 (8.33%) slope.
- 3. Min 2'strike-edge clearance.
- 4. Mesh gate (min. 36" wide w/ 32" clear opening) with accessible door hardware
- 5. Masonry walls shall be constructed of a 6" minimum Precision block with a split face block on the viewable side and with decorative cap. (Earth tone in color & a contrasting decorative cap)
- 6. Wheelchair turning circle (min 60" dia.)
- 7. Trash bins
- 8. Mesh gates
- 9. Area to be landscaped or paved



NOTES:

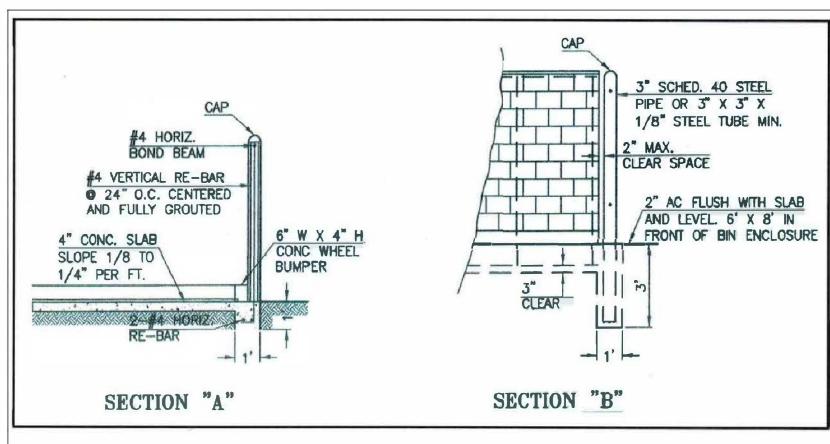- 1. Location to be indicated on planning department approval site plan.
- 2. Lap all re-bar splices 24 inches, minimum.
- 3. All cells contacting reinforcing steel are to be solidly grouted.
- 4. Cells required to be grouted are to be in vertical alignment and free from obstruction. Extreme care should be taken when using slump blocking to allow for a clear unobstructed cell.
- 5. Grout to be puddle, rodded or vibrated and consolidated.
- 6. Footing to be dug 12" minimum into undisturbed soil.
- 7. Request inspection for footing and obtain approval prior to pouring.
- 8. Request inspection for wall steel and obtain approval prior to grouting.



	, ,		
			BENCHMARK:
			"H-18"
3			BRASS DISK IN CONCRETE, LOCATED APPROXIMATE
			22 FEET NORTH OF THE NE ECR, BEHIND THE
			SIDEWALK AT THE INTERSECTION OF MAIN ST. & MA ST.
			GI.
REV.	DESCRIPTION DATE	BY	ELEV=3376.492

BY

Know what's below.

Call before you dig.

DESCRIPTION

DESIGNED BY: _D.B.W. D.B.W. DRAWN BY: CHECKED BY: R.J.A. IAPLE SUBMITTED BY:

RAYMOND J. ALLARD RCE No. 36052

SHEET 1 OF 2




HIGH DESERT MAPPING


Land Surveying - Civil Design 16704 Neenach Road Apple Valley, CA 92307 (760) 508-8555

dbw.hdm@gmail.com

CITY OF HESPERIA ENGINEERING DEPARTMENT						
RECOMMENDED FOR APPROVAL BY:	APPROVED BY:					
DATE	CASSANDRA SANCHEZ DATE					
AUTHORIZED SIGNATURE R.C.E. <u>74776</u> EXP. DATE <u>12/31/25</u> CITY ENGINEER						

	000 Account 40
CITY OF HESPERIA	
DETAILS	SHEET
TAMARISK APARTMENTS	9 OF
MUNEM MAIDA	13
APN 3057-121-08	D-2

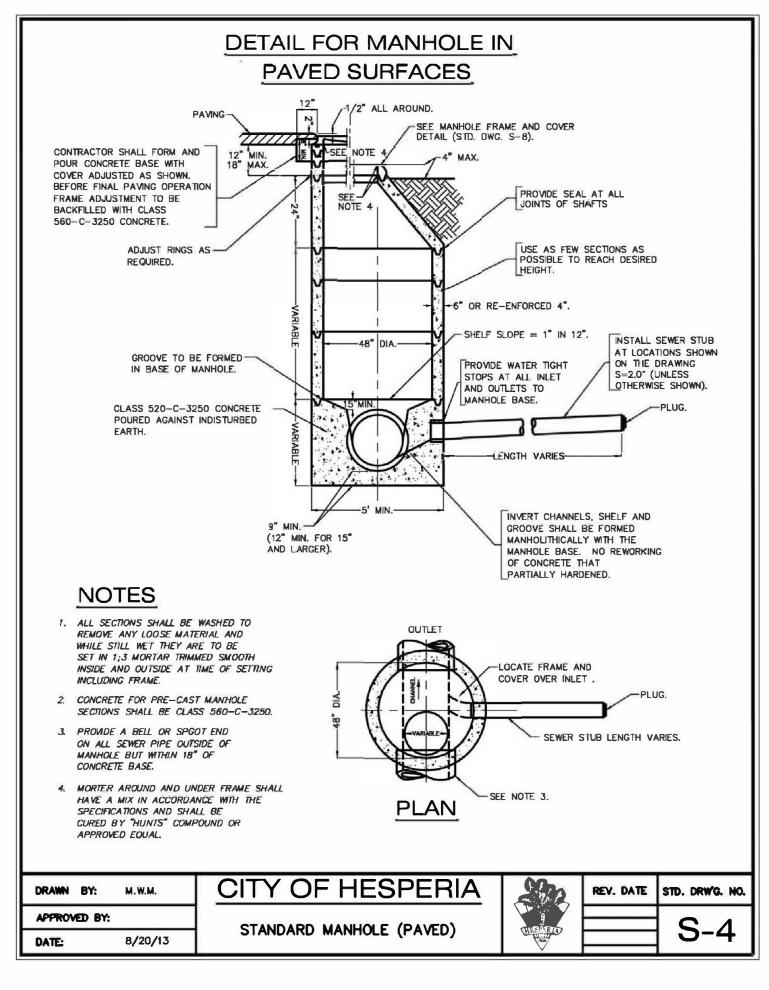

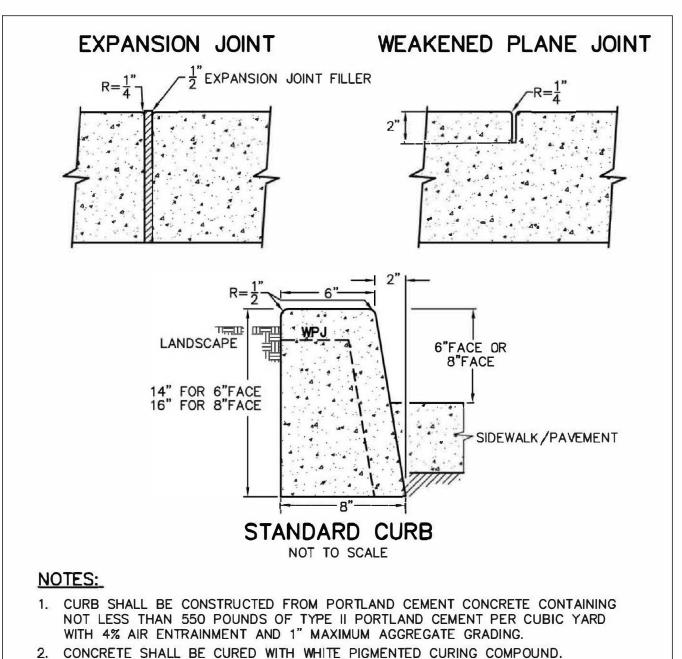

WHEN USED ADJACENT TO VEHICULAR TRAFFIC, CURB SHALL BE CONSTRUCTED ON

6. EXPANSION JOINTS SHALL BE CONSTRUCTED AT ALL CURB RETURNS, DRIVEWAY

EXPANSION JOINTS SHALL BE 1/2" WIDE AND FILLED WITH PLASTIC TYPE FILLERS.

IF EXISTING CURB IS TO BE REMOVED, IT SHALL BE SCORED AT LEAST 1" DEEP WITH A CONCRETE SAW PRIOR TO REMOVAL. IF THE SAWCUT LINE IS CLOSER

THAN 2' TO A WEAKENED PLANE JOINT OR EXPANSION JOINT, THE CURB SHALL


WEAKENED PLANE JOINTS SHALL BE CONSTRUCTED AT 10' INTERVALS.


BE REMOVED TO THE WEAKENED PLANE JOINT OR EXPANSION JOINT.


5. WEAKENED PLANE JOINTS SHALL BE AT LEAST 2" DEEP.

APPROACHES AND AT 60' INTERVALS.


MINIMUM 4" CLASS 2 AGGREGATE BASE COMPACTED TO 95% RELATIVE COMPACTION.

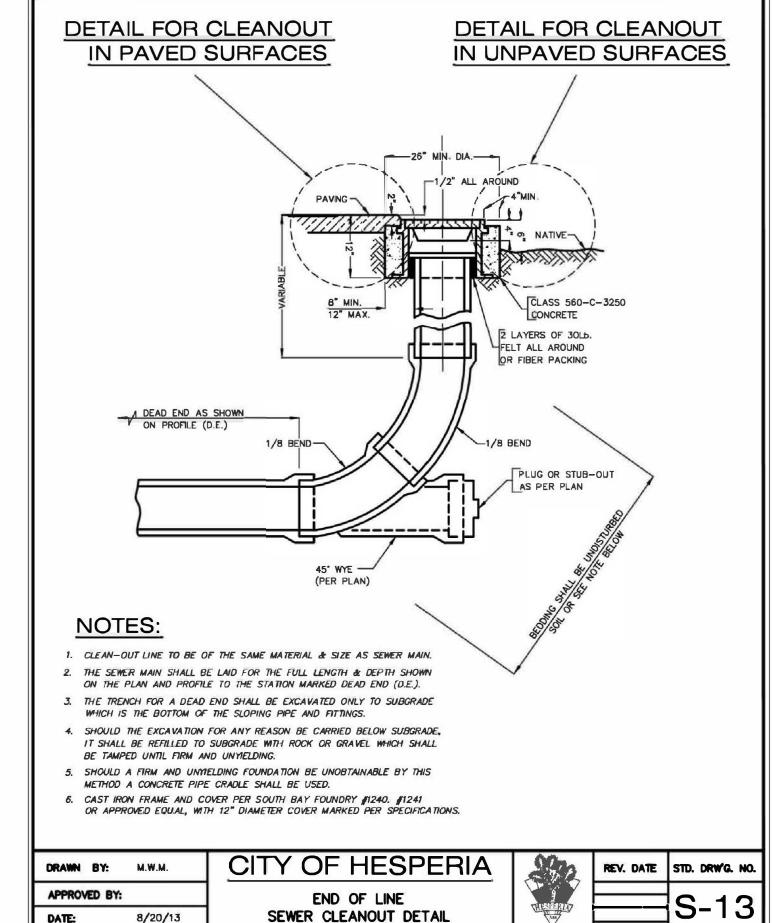


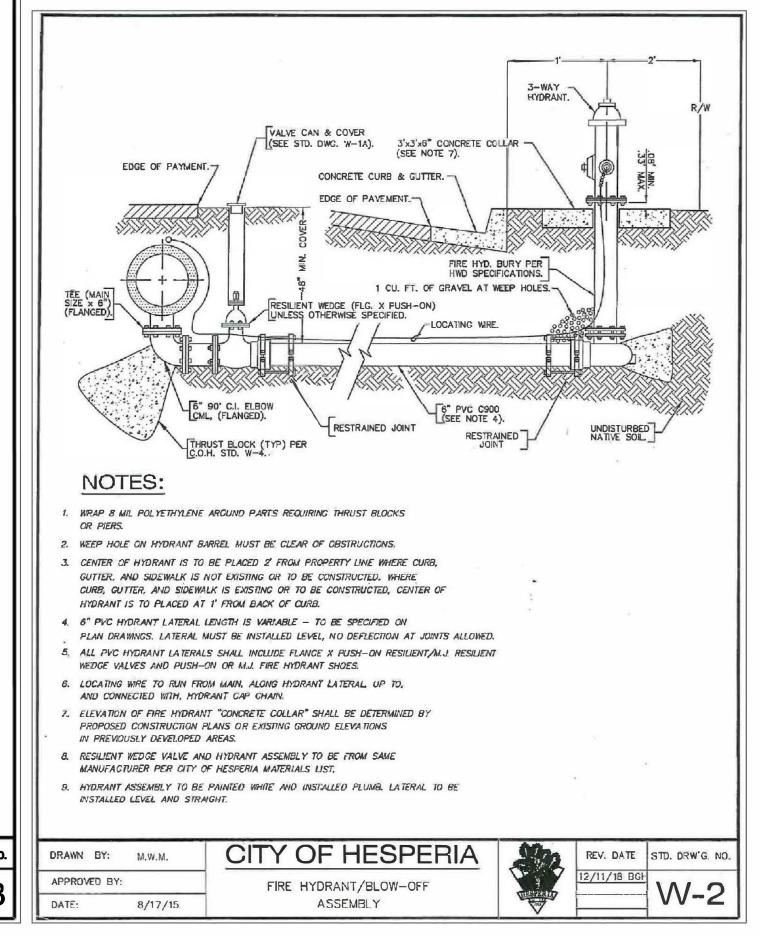

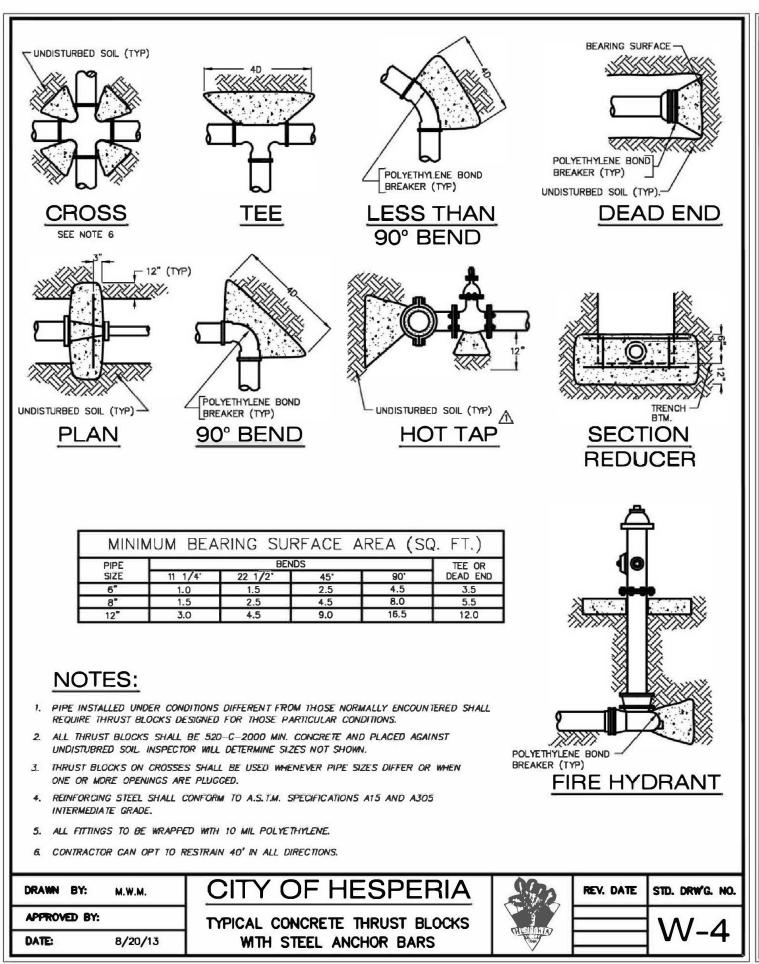


ELEV=3376.492

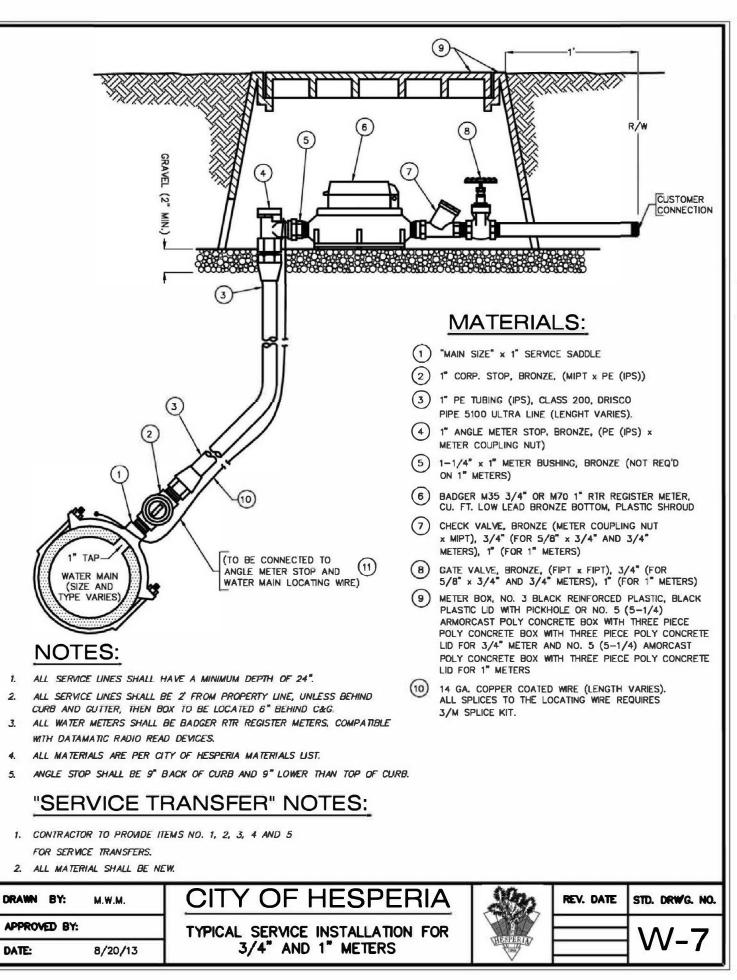

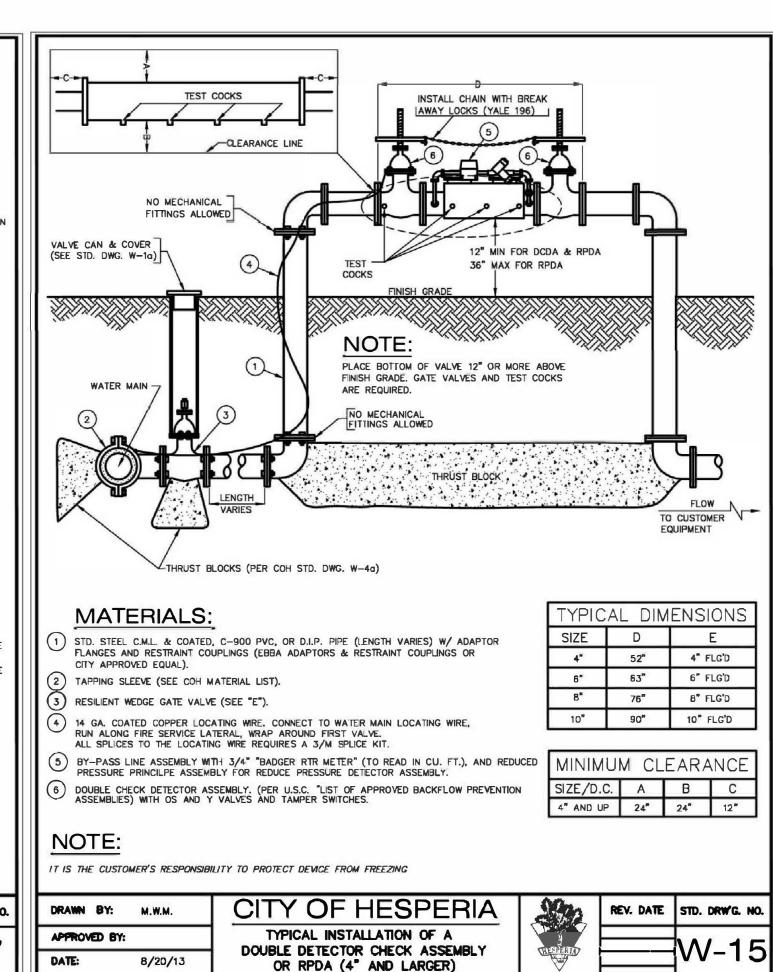

AUTHORIZED SIGNATURE

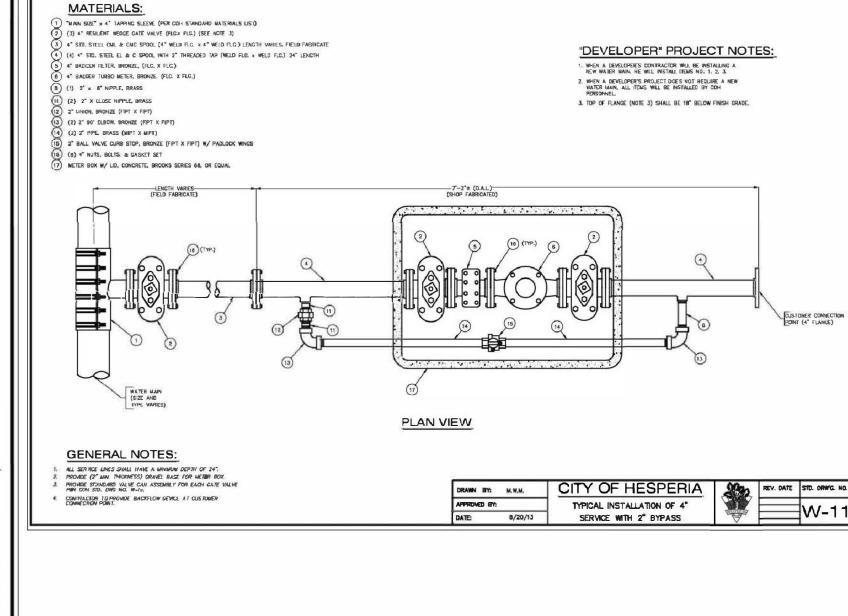



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DESCRIPTION

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BENCHMARK:

"H-18"

BRASS DISK IN CONCRETE, LOCATED APPROXIMATELY
22 FEET NORTH OF THE NE ECR, BEHIND THE
SIDEWALK AT THE INTERSECTION OF MAIN ST. & MAPLE
ST.

BY

DATE

DESIGNED BY: D.B.W.

DRAWN BY: D.B.W.

CHECKED BY: R.J.A.

SUBMITTED BY:

DATE

RAYMOND J. ALLARD RCE No. 36052



HIGH DESERT MAPPING

Land Surveying - Civil Design

16704 Neenach Road
Apple Valley, CA 92307

(760) 508-8555

dbw.hdm@gmail.com

CITY OF HESPERIA ENGINEERING DEPARTMENT							
RECOMI	MENDED FOR APPROVAL BY:	APPROVED BY:					
	DATE	CASSANDRA SANCHEZ	DATE				

R.C.E. <u>74776</u> EXP. DATE <u>12/31/25</u>

CITY ENGINEER

CITY OF HESPERIA


DETAILS

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TAMARISK APARTMENTS


MUNEM MAIDA

APN 3057-121-08

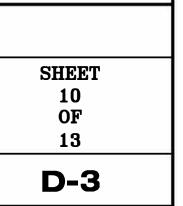

No. 36052

Exp. 6/30/26

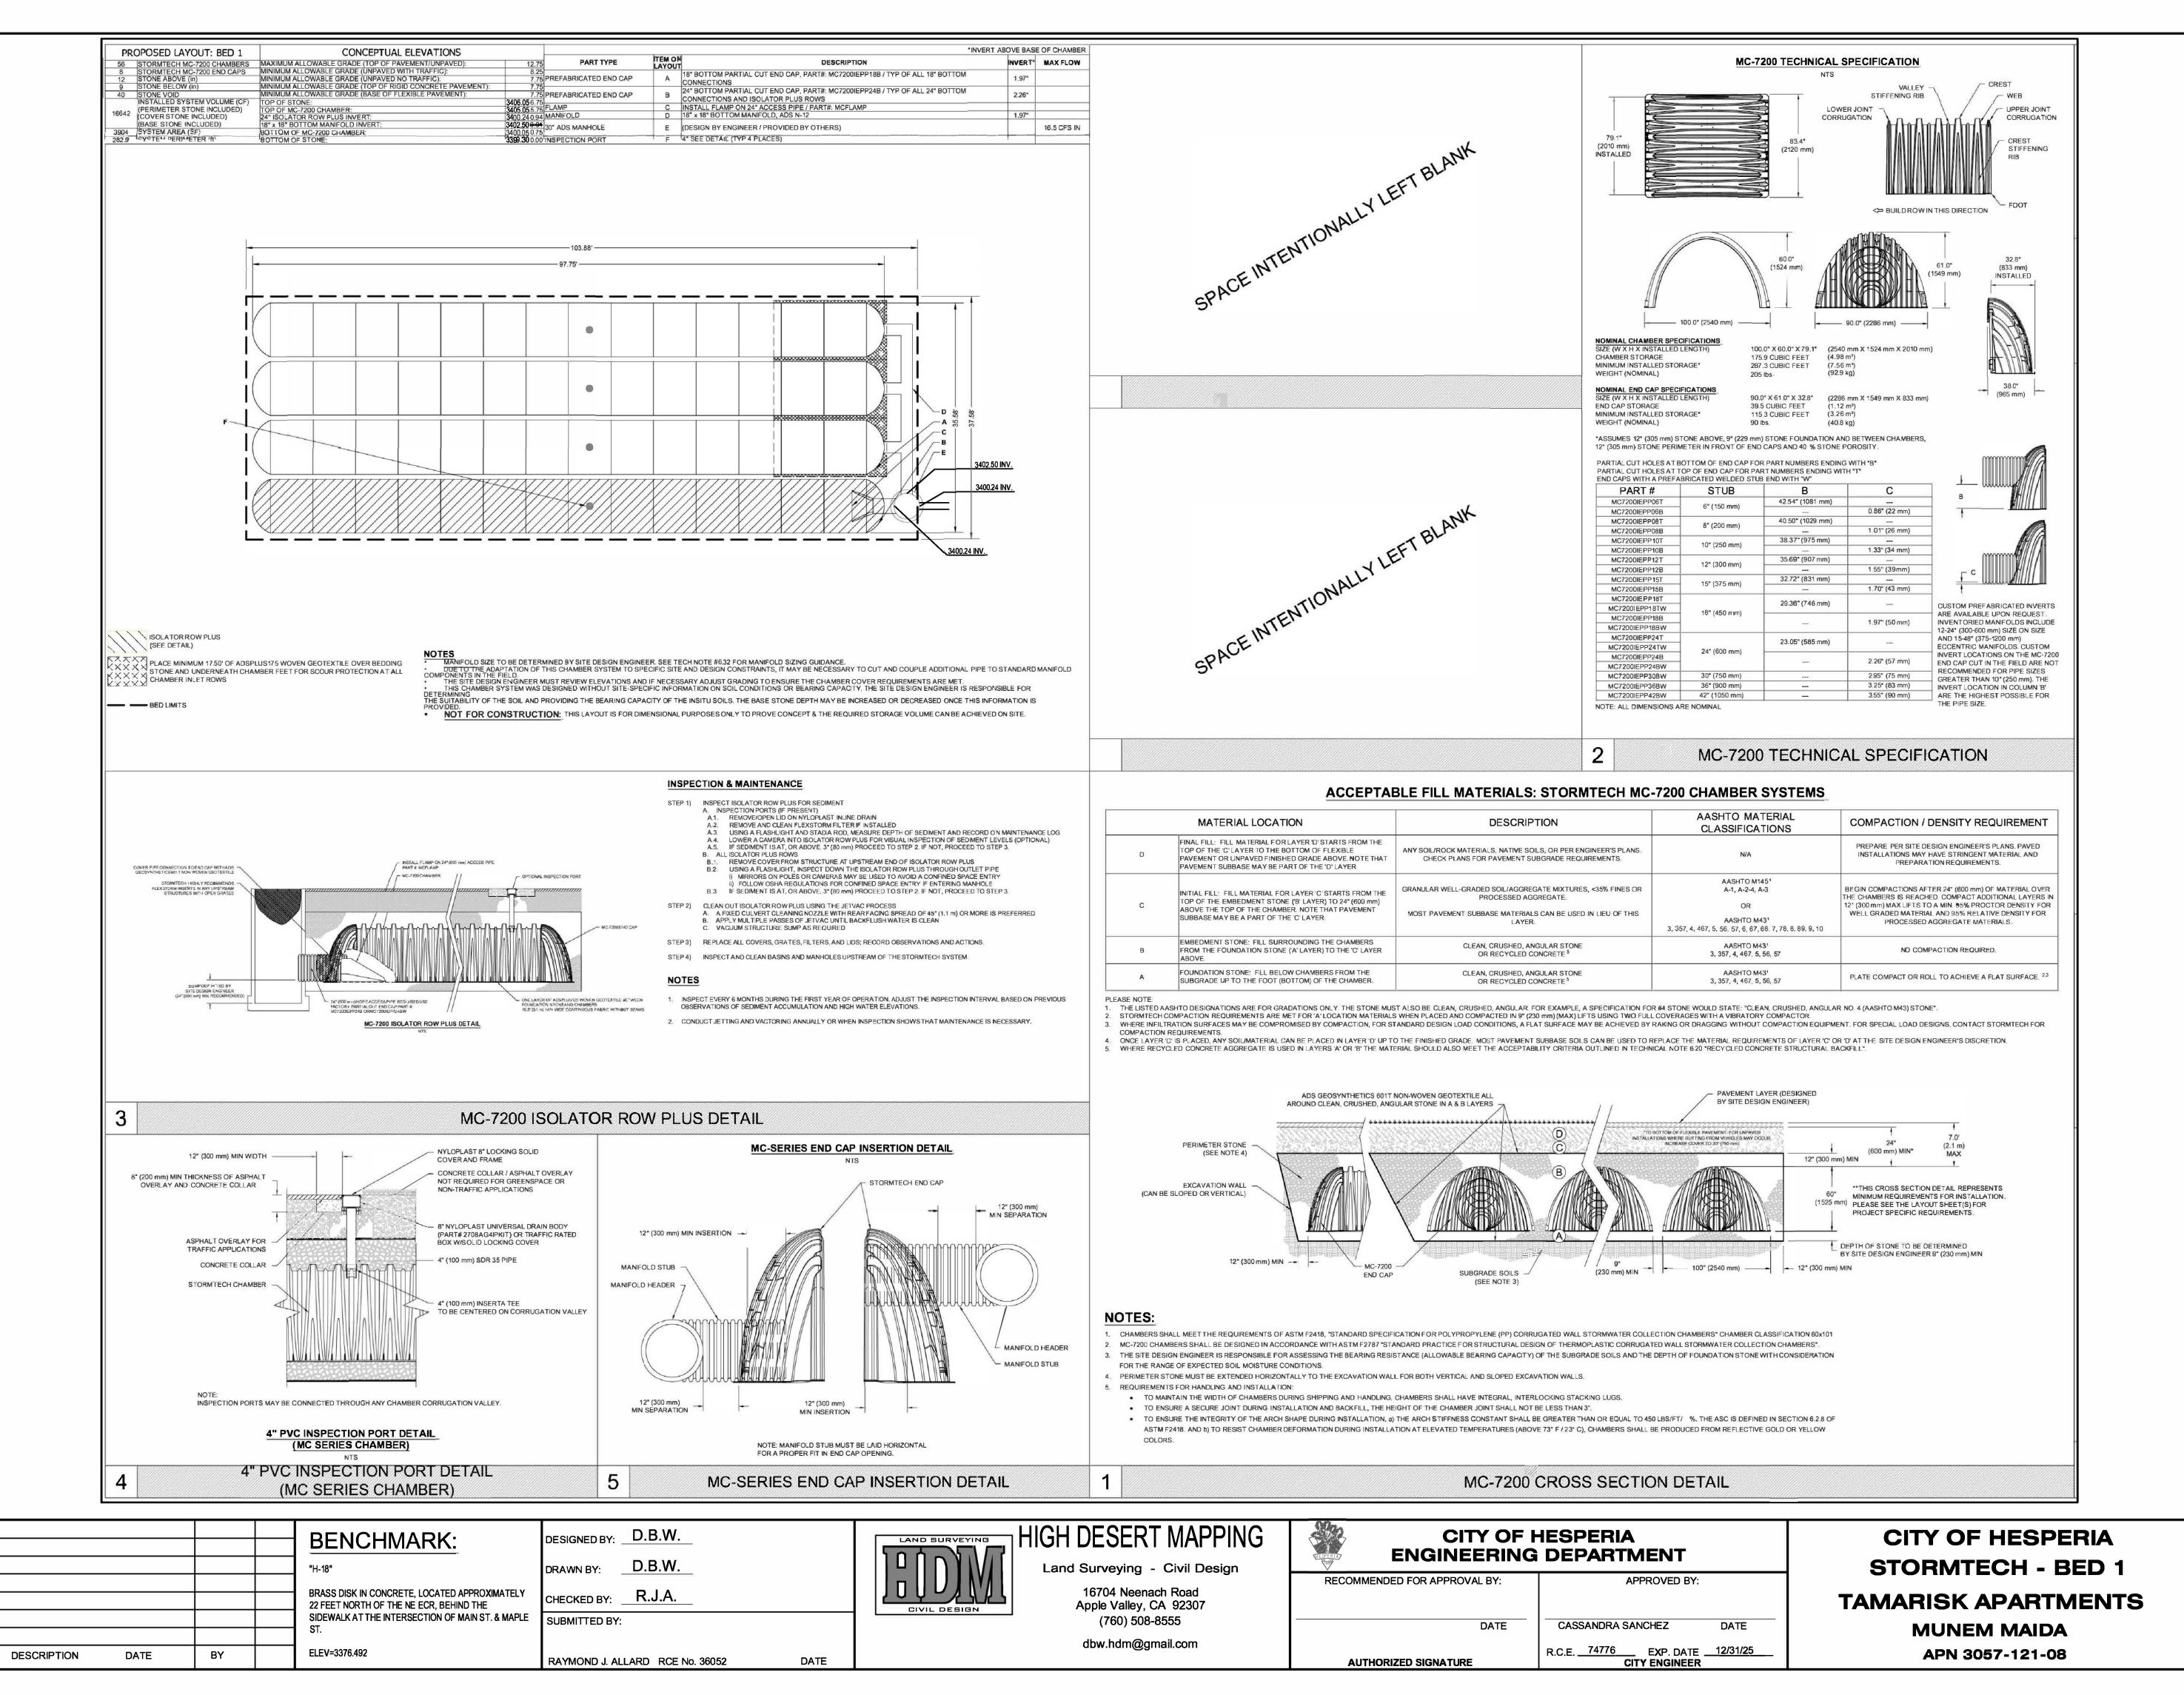

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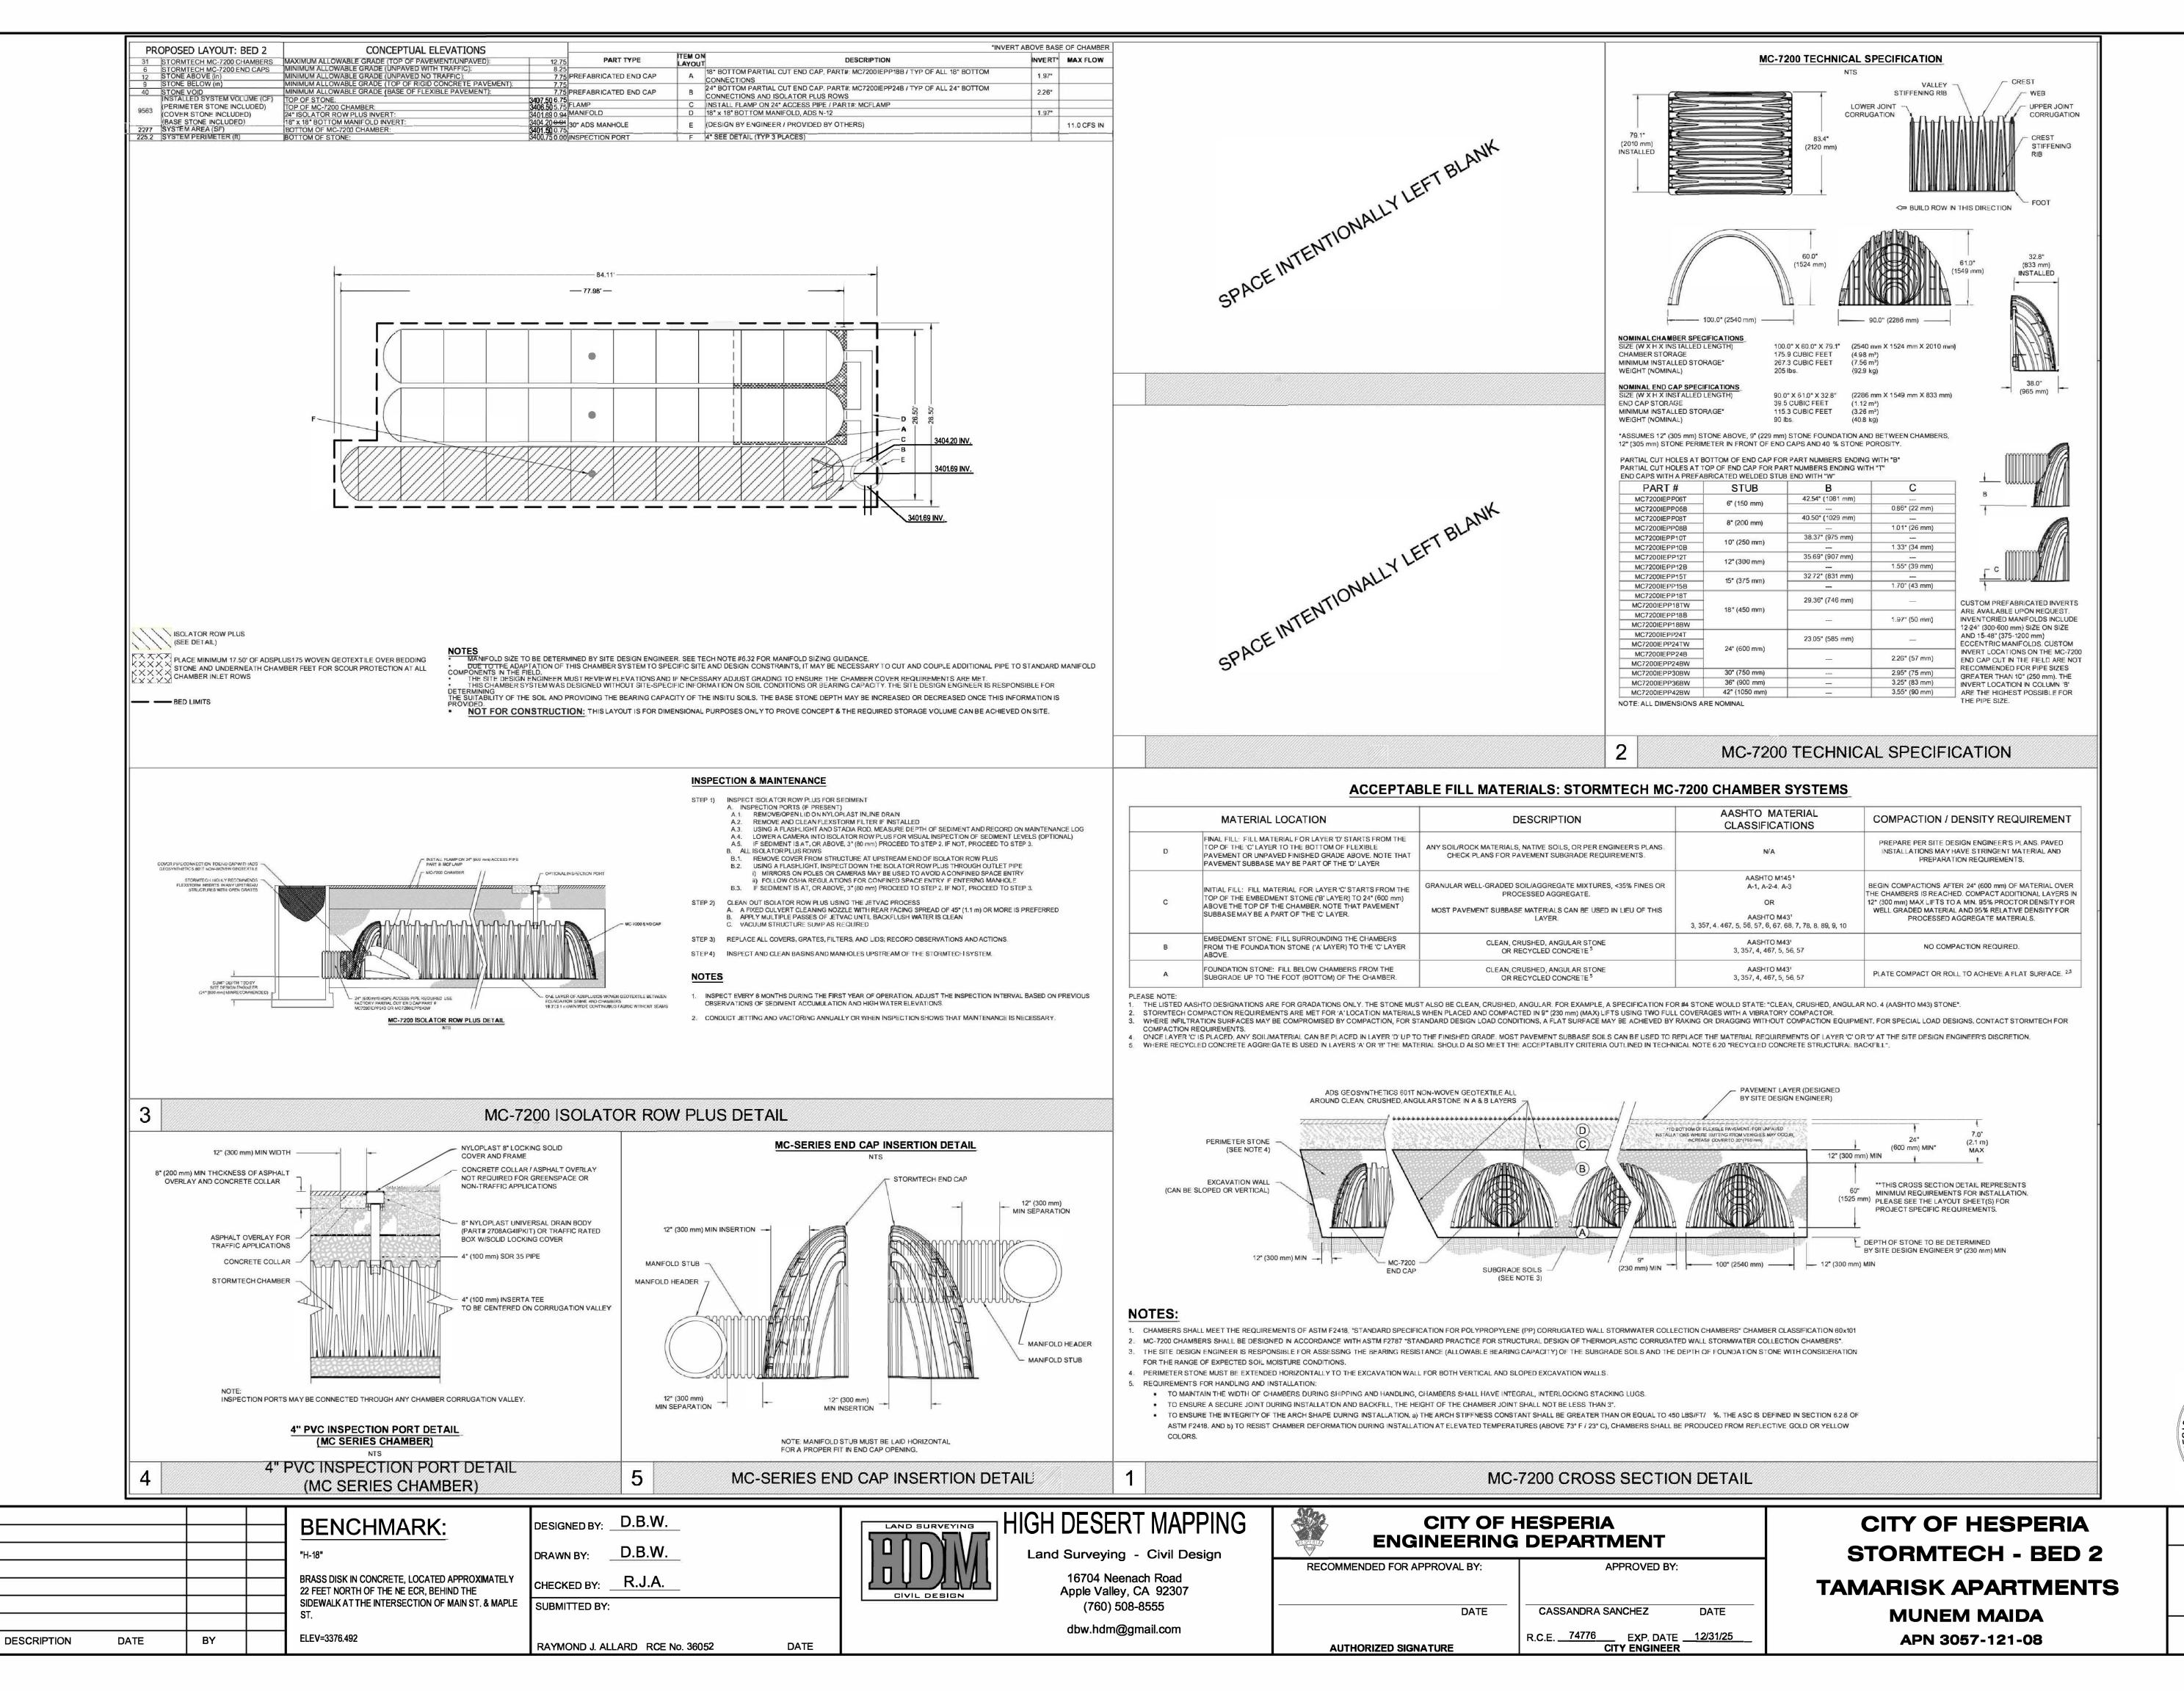
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OF

13

No. 36052

Exp. 6/30/26



SHEET

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OF

SD-2

