

Cultural Resources Technical Report

# Cultural Resources Technical Report East End Studios at 6<sup>th</sup> and Alameda

1206 East 6th Street Los Angeles, CA



June 2024

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#### I. INTRODUCTION AND EXECUTIVE SUMMARY

This technical report evaluates potential direct and indirect impacts of the proposed East End Studios Art District Los Angeles (proposed project) on historical resources. Encompassing nearly fifteen acres, the proposed project consists of twenty two new buildings the majority of which are intended to be used as motion picture and television production studio soundstages, as well as two office buildings and other support buildings. The proposed project is located at 1206 East 6<sup>th</sup> Street in downtown Los Angeles (hereinafter referred to as "subject properties" or collectively as "subject property"). The subject properties span three assessor parcels – 5164-010-003, 5164-010-004, and 5164-010-005 - and are bounded by East 6<sup>th</sup> Street to the north, Alameda Street to the west, Wholesale Street to the south (now private), and Mill Street to the east. Located at the southeast corner of East 6<sup>th</sup> and Alameda Streets, the properties are currently developed with two warehouse buildings constructed in 1963 and 1968. The subject properties are not included in the California Office of Historic Preservation maintained Built Environment Resource Directory. Furthermore, they were not identified in SurveyLA as appearing eligible for designation.

The report includes evaluation of whether or not the subject properties are eligible for listing in the National Register of Historic Places (National Register) and California Register of Historical Resources (California Register), as City of Los Angeles Historic-Cultural Monuments (HCMs) or contributors to any HPOZ. This evaluation relies heavily on the historic context statement prepared for SurveyLA for Industrial Development, specifically under theme "Agricultural Roots, 1850-1965" and subtheme "From Farm to Market, 1900-1960." The evaluation is based on written guidance produced by the National Park Service (NPS) for evaluating historic properties in National Register Bulletin #15, How to Apply the National Register Criteria for Evaluation, as well as on guidance provided by the California Office of Historic Preservation (OHP), accepted professional practices, and experience with similar properties.

The assessment concludes that the properties do not appear eligible for listing in the National or California Registers, nor for local designation under the City of Los Angeles Cultural Heritage or Historic Preservation Overlay Zone Ordinances. This determination is the result of a site inspection; site-specific and contextual research in primary and secondary sources; and application of the criteria of significance within the appropriate historic context.

Although the subject properties do not appear eligible for designation and are not historical resources, they are located adjacent to a potential historic district identified in SurveyLA, the City of Los Angeles' citywide historic resources survey. The Downtown Los Angeles Industrial Historic District received a California Historical Resource Status Codes 3S, 3CS, and 5S3, which means it appears eligible for listing in the National Register, California Register, and locally as a City of Los Angeles HPOZ.<sup>3</sup>

<sup>&</sup>lt;sup>1</sup> LSA Associates, Inc., "Los Angeles Citywide Historic Context Statement: Industrial Development, 1850-1980," prepared for the City of Los Angeles, Department of Planning, Office of Historic Resources, September 2011, revised February 2018.

<sup>&</sup>lt;sup>2</sup> Rebecca H. Shrimpton, ed., National Register Bulletin, #15, *How to Apply the National Register Criteria for Evaluation*, (National Park Service, 1990) revised 1997 by Patrick W. Andrus. This bulletin is available at the web site, http://www.nps.gov/history/nr/publications/bulletins/nrb15/.

<sup>&</sup>lt;sup>3</sup> Historic Resources Group, "Central City North Community Plan Area: Historic Districts, Planning Districts, and Multi-Property Resources," prepared for the City of Los Angeles, Department of City Planning, Office of Historic Resources, September 2016.

This technical report considers direct and indirect impacts of the proposed project on identified adjacent and nearby historical resources and concludes that no direct impacts to any adjacent buildings located within the Downtown Los Angeles Industrial Historic District are anticipated. In addition, it is not anticipated that the proposed project will have an indirect impact on the setting of the adjacent historic district as it will not destroy the setting of that identified historic district. Therefore, potential indirect impacts to historical resource are less than significant.

This report was prepared by Jenna Snow. Editorial support and peer review were provided by Kathryn McGee. Qualifications are included in Attachment F.

### II. METHODOLOGY

Jenna Snow visited and photographed the site and immediate surroundings on August 11, 2022. Jenna Snow also visited the site February 13, 2015 and April 26, 2017. Research included the following primary resources:

Sanborn Maps: Historic Sanborn fire insurance maps depict early building footprints, land uses, and property addresses. A Sanborn map report for the subject property and surrounding area was ordered from Environmental Data Resources, Inc. (EDR) and relevant maps are included in the attachments to this report. Coverage is available for 1954, 1967, and 1970.

Historic Photographs: Historic photograph databases are available online through the Los Angeles Public Library, University of Southern California, California State Library, and the Huntington Library. No historic photographs were located in any of the above repositories.

Aerial Photos: Historic aerial photographs showing early building footprints and patterns of urban development are digitized and available online through University of California Santa Barbara. Relevant aerials are included in the attachments to this report.

Newspaper articles: Historic newspapers, including the *Los Angeles Times*, are digitized and searchable at newspapers.com. Relevant articles are referenced in this report.

Secondary sources consulted include historic contexts presented in the following reports:

"Central City North Community Plan Area: Historic Resources Survey Report" and "Central City North Community Plan Area: Historic Districts, Planning Districts, and Multi-Property Resources," prepared by Historic Resources Group for the City of Los Angeles, Department of City Planning, Office of Historic Resources, September 2016.

"Los Angeles Citywide Historic Context Statement: Industrial Development, 1850-1980," prepared by LSA Associates, Inc. for the City of Los Angeles, Department of Planning, Office of Historic Resources, September 2011, revised February 2018.

### III. REGULATORY SETTING

### **Federal**

# National Register

The National Register of Historic Places is "an authoritative guide to be used by federal, state, and local governments, private groups, and citizens to identify the nation's cultural resources and indicate what properties should be considered for protection from destruction or impairment," Administered by the National Park Service, the National Register is the nation's official list of historic and cultural resources worthy of preservation. Properties listed in the National Register include districts, sites, buildings, structures, and objects that are significant in American history, architecture, archaeology, engineering, and culture. Resources are eligible for the National Register if they meet one or more of the following criteria for significance:

- A) Are associated with events that have made a significant contribution to the broad patterns of our history; or
- B) Are associated with the lives of significant persons in our past; or
- C) Embody the distinctive characteristics of a type, period, or method of construction, or that represent the work of a master, or that possess high artistic values, or that represent a significant and distinguishable entity whose components may lack individual distinction; or
- D) Have yielded or may be likely to yield, information important in history or prehistory.<sup>5</sup>

Once a resource has been determined to satisfy one of the above criteria, then it must be assessed for "integrity." Integrity refers to the ability of a property to convey its significance. Evaluation of integrity is based on "an understanding of a property's physical features and how they relate to its significance." The National Register recognizes seven aspects or qualities of integrity: location, design, setting, materials, workmanship, feeling, and association. To retain integrity, a property must possess several, and usually most, of these aspects.

### Relationship to Project

The subject properties are not listed in the National Register, and for the reasons stated in this report, do not appear to meet National Register eligibility requirements. The subject properties are adjacent to the Downtown Los Angeles Industrial Historic District, identified in SurveyLA as an historic district eligible for listing in the National Register. Therefore, potential indirect impacts of the proposed project to the setting of the district are studied in this report.

# State

### California Register

Based substantially on the National Register, the California Register is "an authoritative guide... used by state and local agencies, private groups, and citizens to identify the state's historical

<sup>&</sup>lt;sup>4</sup> National Register Bulletin #16A: How to Complete the National Register Registration Form (National Park Service, 1997).

<sup>&</sup>lt;sup>5</sup> National Register Bulletin #15, How to Apply the National Register Criteria for Evaluation (National Park Service, 1990, revised 2002).

<sup>&</sup>lt;sup>6</sup> National Register Bulletin #15, How to Apply the National Register Criteria for Evaluation (National Park Service, 1990, revised 2002).

<sup>&</sup>lt;sup>7</sup> Historic Resources Group, "Central City North Community Plan Area: Historic Districts, Planning Districts, and Multi-Property Resources," prepared for the City of Los Angeles, Department of City Planning, Office of Historic Resources, September 2016.

resources and to indicate what properties are to be protected." For a property to be eligible for listing in the California Register, it must be found by the State Historical Resources Commission to be significant under at least one of the following four criteria:

- 1) Is associated with events that have made a significant contribution to the broad patterns of California's history and cultural heritage; or
- 2) Is associated with the lives of persons important in our past; or
- 3) Embodies the distinctive characteristics of a type, period, region, or method of construction, or represents the work of an important creative individual or possesses high artistic values; or
- 4) Has yielded, or may be likely to yield, information important in prehistory or history.

Also included in the California Register are properties which have been formally determined eligible for listing in, or are listed in the National Register; are registered State Historical Landmark Number 770, and all consecutively numbered landmarks above Number 770; and Points of Historical Interest, which have been reviewed and recommended to the State Historical Resources Commission for listing.

# Relationship to Project

The subject properties are not listed in the California Register, and for the reasons stated in this report, do not appear to meet California Register eligibility requirements for individual listing. The subject properties are adjacent to the Downtown Los Angeles Industrial Historic District, identified in SurveyLA as an historic district eligible for listing in the California Register. Therefore potential impacts of the proposed project to the setting of the district are studied in this report.

# California Environmental Quality Act (CEQA)

The purpose of CEQA is to evaluate whether a proposed project may have an adverse effect on the environment and, if so, if that effect can be reduced or eliminated by pursuing an alternative course of action or through mitigation. The *Guidelines for California Environmental Quality Act* (CEQA Guidelines) are the regulations that govern the implementation of CEQA. The CEQA Guidelines are codified in the California Code of Regulations (CCR), Title 14, Chapter 3, § 15000 et seq. and are binding on state and local public agencies. The basic goal of CEQA is to develop and maintain a high-quality environment now and in the future.

### CEQA defines a historical resource as:

a resource listed in, or determined eligible for listing in, the California Register of Historical Resources. Historical resources included in a local register of historical resources..., or deemed significant pursuant to criteria set forth in subdivision (g) of Section 5024.1, are presumed to be historically or culturally significant for purposes of this section, unless the preponderance of the evidence demonstrates that the resource is not historically or culturally significant (California Public Resources Code, PRC §21084.1).

<sup>8</sup> California Public Resources Code §5024.1(a), <a href="http://codes.lp.findlaw.com/cacode/PRC/1/d5/1/2/s5024.1">http://codes.lp.findlaw.com/cacode/PRC/1/d5/1/2/s5024.1</a>.

<sup>&</sup>lt;sup>9</sup> Historic Resources Group, "Central City North Community Plan Area: Historic Districts, Planning Districts, and Multi-Property Resources," prepared for the City of Los Angeles, Department of City Planning, Office of Historic Resources, September 2016.

### Relationship to Project

Although the buildings at the subject properties are not currently designated nor do they appear eligible for listing in the National or California Registers, they are located adjacent to the identified Downtown Los Angeles Industrial Historic District, which is presumed to be a historical resource under CEQA.

### Local

# City of Los Angeles

§22.171.7 of the Los Angeles Administrative Code defines criteria for designation of a Historic-Cultural Monument (HCM). For ease in applying local eligibility, the following numbers are assigned to the criteria, which align, to a large degree, with National and California Register criteria. Resources eligible for HCM designation are:

- 1) Historic structures or sites in which the broad cultural, economic or social history of the nation, state or community is reflected and exemplified; identified with important events in the main currents of national, state, or local history; or
- 2) Historic structures or sites identified with personages in the main currents of national, state or local history; or
- 3) Historic structures or sites which embody the distinguishing characteristics of an architectural type specimen, inherently valuable for a study of a period style or method of construction or a notable work of a master builder, designer, or architect whose individual genius influenced his age.


While National and California register criteria apply to individual sites as well as districts, local historic district criteria are contained in separate legislation. According to §12.20.3 of the Los Angeles Municipal Code, which became effective on May 12, 2004, a Historic Preservation Overlay Zone (HPOZ) "is any area of the City of Los Angeles containing buildings, structures, landscaping, natural features or lots having historic, architectural, cultural or aesthetic significance and designated as a Historic Preservation Overlay Zone." Contributing resources must meet at least one of the following criteria:

- 1. Adds to the historic architectural qualities or historic associations for which a property is significant because it was present during the period of significance, and possess historic integrity reflecting its character at that time.
- 2. Owing to its unique location or singular physical characteristics, represents an established feature of the neighborhood, community, or City.
- 3. Retaining the structure would help preserve and protect an historic place or area of historic interest in the City. 10

# Relationship to Project

The subject properties are not individually listed as HCMs or contributors to any HPOZ and, for the reasons stated in this report, do not meet eligibility requirements for individual listing. The subject properties are adjacent to the Downtown Los Angeles Industrial Historic District, identified

<sup>&</sup>lt;sup>10</sup> Cultural Heritage Masterplan, 45. City of Los Angeles Cultural Affairs Department. Adopted 2000. Web. May 2016.

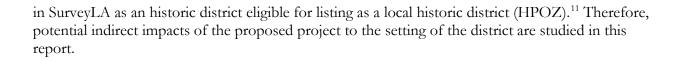

<sup>&</sup>lt;sup>11</sup> Historic Resources Group, "Central City North Community Plan Area: Historic Districts, Planning Districts, and Multi-Property Resources," prepared for the City of Los Angeles, Department of City Planning, Office of Historic Resources, September 2016.

#### IV. HISTORIC CONTEXT

The subject properties are surrounded on three sides by an area identified in SurveyLA as a potential historic district, the Downtown Los Angeles Industrial Historic District. Even though the subject properties are not included within the boundaries, it is appropriate to consider them within the same historic context. The following historic context is excerpted from the statement of that identified historic district included in "SurveyLA Citywide Historic Context Statement; Industrial Development, 1850-1980." <sup>12</sup>

The Downtown Los Angeles Industrial Historic District is significant for its role in the industrial history and development of Los Angeles. The district as a whole served as the city's primary industrial district from the late-19th century through World War II. The district's period of significance is 1900 to 1940, when most of the original buildings in the district were constructed. Contributors not only represent important industries and industrial building typologies, but also reflect significant examples of architectural styles of the day applied to industrial buildings and were often the work of noted architects and designers. Buildings in the district are also associated with the ethnic/cultural and labor histories of the area. Some contributors within the district have also been evaluated for individual significance.

The land comprising the district was first improved as part of a vineyard operated by Jean-Louis Vignes, who arrived in Los Angeles from France in 1831... However, the landscape of the district evolved during the last decades of the 19th century as rail lines and manufacturing plants emerged to serve the citrus industry's shipping needs. Soon the character of the district would be redefined by the presence of the railroad.

Until the 1870s, only local rail lines ran through Los Angeles. But in 1876, the opening of the Southern Pacific Railroad line from San Francisco linked the city with the transcontinental railroad. A depot for the Southern Pacific line was constructed at the southwest corner of Alameda and 5th streets, immediately adjacent to the district. The Atchison, Topeka, and Santa Fe Railroad (AT&SF) constructed a depot and freight yards south of 1st Street in 1885, on the northern edge of the district. In 1893, the company also constructed the distinctive Moorish Revival-style La Grande Station at 2nd and Santa Fe streets, in the northeastern part of the district. The Atchison, Topeka & Santa Fe Railway Outbound Freight House (known as the Santa Fe Freight Depot) was constructed in 1906 to accommodate the majority of goods shipped out of Los Angeles on rail by the AT&SF. Located on the eastern edge of the district, the building is now occupied by the Southern California Institute of Architecture (SCI-Arc) and is Los Angeles Historic-Cultural Monument No. 95). It was originally paired with the AT&SF Railway Inbound Freight House directly across Santa Fe Avenue. Today, the AT&SF Outbound Freight House stands as the last remaining historic reference to the Atchison, Topeka, and Santa Fe Railroad along Santa Fe Avenue in Los Angeles. While most of these early railroad buildings have been lost, their locations and relative proximity to one another motivated the

<sup>&</sup>lt;sup>12</sup> "Los Angeles Citywide Historic Context Statement: Industrial Development, 1850-1980," prepared by LSA Associates, Inc. for the City of Los Angeles, Department of Planning, Office of Historic Resources, September 2011, revised February 2018, 167-170.

development of the surrounding area as an industrial district. Within a few years, businesses had begun to capitalize on the convenience of locating their operations near the rail lines, and a small concentration of manufacturing and warehouse facilities had sprung up in the area between Alameda Street and Santa Fe Avenue.

By the turn of the 20th century, a range of manufacturers and processing companies had established themselves in the area. A 1909 map of the area notes a number of warehouses and storage facilities, as well as a wide variety of processing and manufacturing operations – including lumber yards, freight yards, ice and cold storage, slaughterhouses and meatpackers, produce companies and canneries, and blacksmiths, among others. As the railroads increased mobility, Los Angeles ceased to be simply a market for manufactured goods produced in San Francisco and the East, but began to support local industries as well. Similarly, as agricultural activities in other areas of the city supplanted those near the city center, the district evolved from simply a shipping hub to a processing and manufacturing center in its own right. In particular, businesses related to the building trades had expanded rapidly beginning in the 1880s when the first regional real estate boom spurred residential and commercial construction; as a result the district saw the opening of a number of lumber, construction, and even furniture trades.

In the early decades of the 20<sup>th</sup> century, many of the district's industrial buildings were one of two types: manufacturing or processing facilities, and warehouses. Many of the area's industrial buildings were constructed directly on a rail spur; these buildings often display curved facades that follow the tracks, with docks and large bay doors set several feet above the ground (to the height of a boxcar), to facilitate the loading and unloading of goods. Warehouses were built either as general storage facilities – with space that could be rented by a variety of companies or operators – or were purpose-built facilities associated with a particular company. Examples of general warehouses include the Pacific Commercial Warehouse (1910); the Bekins Van & Storage Co. warehouse (1923); and the Metropolitan Warehouse Company (1924). Purpose-built warehouses constructed during this period include those built for J. R. Newberry & Co. (1900); Barker Bros. Furniture (1920 and 1923); Cheeck Neal Coffee Co. (1924); and Hills Bros. Coffee Co. (1929)...

By the 1920s, the area now comprising the historic district was fully established as an industrial hub. This was aided in part by the pattern of development occurring outside the central city. As the City of Los Angeles continued to annex existing communities as well as available land in the San Fernando Valley, zoning was amended to eliminate residential housing in the Downtown area. By 1922, the City had officially re-zoned the Downtown area to accommodate the construction of more offices, retail, and manufacturing facilities. By the 1950s, the area was home to automotive manufacturing, trucking and transport, furniture manufacturing and storage, paint and chemical manufacturing, and paper and plastic production – as well as historically dominant industries such as food processing and lumber and woodworking operations. While industries evolved over time, the district maintained its character as an industrial center, with one processing or manufacturing operations simply replacing another. Over the course of the 20th century a single manufacturing facility might house the production of everything from dog food to pie.

By the 1960s, however, the character of the area within the district was evolving away from that of an industrial center. Industry on the whole struggled to adapt to the postwar challenges of containerization and new technologies in manufacturing and transport. Railroads had given way to the trucking industry, and businesses within the district were constrained by the physical demands such methods placed on their operations. Furthermore, outlying fledgling industrial centers such as Vernon and the City of Commerce were comparatively undeveloped and offered plentiful land at lower prices, presenting many companies with an opportunity to relocate and construct newer and more efficient facilities. As a result, by the 1970s many buildings within the district were vacant. However, the area found new life as artists and other creative types began to congregate amidst the vacant buildings and empty lots. Priced out of established artists' colonies in neighborhoods such as Venice and Hollywood, Los Angeles' industrial district provided many with an opportunity to live and work inexpensively in the vast and vacant warehouse buildings. Soon, the area was home to a number of avant-garde art galleries, giving rise to the group of early artists now called the "Young Turks." Many of the area's most prominent industrial buildings found new life as gallery space and underground hangouts for a burgeoning art scene as well as the punk-rock music scene. In 1981, the City of Los Angeles implemented the Artist-in-Residence Program, which legalized the residential use of formerly industrial buildings for artists, legitimizing their efforts. In the mid-1990s, the area was officially designated as the Arts District. A subsequent wave of development began in 1999 with the passing of the Adaptive Reuse Ordinance which relaxed zoning codes and allowed for the conversion of pre-1974 commercial and industrial buildings into residences for artists and non-artists alike. Today, the area continues to attract new commercial and residential development, and existing facilities are adapted to meet the needs of the growing community.

### V. IDENTIFICATION OF HISTORICAL RESOURCES

# **Subject Property**

# **Description**

Site

The subject properties are located at the southeast corner of 6<sup>th</sup> and Alameda Streets (Maps 1-2). Mill Street is located to the east, while the vacated right-of-way street, Wholesale Street, lines the properties to the south. The properties are located in an urban setting with a mix of commercial and industrial buildings. Alameda Street is a major north-south thoroughfare, connecting the I-10 Freeway with downtown Los Angeles. The little vegetation there is surrounding the site is limited to a few, short trees lining Alameda Street. The identified Downtown Los Angeles Industrial Historic District surrounds the subject properties on three sides but does not incorporate them within its boundaries.

The subject properties contain two buildings, arranged parallel to each other in an east-west orientation. Asphalt paving surrounds the buildings on all sides. There is an almost continuous driveway along East 6<sup>th</sup> Street and a metal fence lines the properties along Alameda Street. Two contemporary, freestanding signs are located along Alameda Street: one at corner of 6<sup>th</sup> and Alameda Streets and the other further south on Alameda Street.

#### Exterior

The two buildings at the subject properties are mirror images of each other with only minor differences. They have no discernible architectural style and no ornamentation. The buildings have a rectangular plan and are a high one story with an interior mezzanine. They are constructed of reinforced concrete with a very low-pitched hipped roof.

North building (Figures 1-8): Circular rotary vents are evident along the ridgeline of the roof of the north building. Multi-light, metal, awning windows are arranged in pairs along the mezzanine floor of east and west elevations. Truck loading docks with metal roll-up doors are regularly spaced along the north elevation. Warehouse floors are about four feet above exterior grade, at the height of adjacent dock. Entrances to individual warehouses are reached via short flights of contemporary, metal steps along this elevation, which are interspersed among truck loading docks. The east elevation has a projecting deck covered by a corrugated metal shed roof supported by thin metal piers. A continuous platform, covered by a corrugated metal canopy, runs almost the full length of the south elevation. Irregularly spaced, wide openings face the platforms. The platform ramps down to the ground level at both ends.

South building (Figures 15-19): The south building has no fenestration; east and west elevations have no articulation. Truck loading docks with metal roll-up doors are regularly spaced along the south elevation. Warehouse floors are about four feet above exterior grade, at the height of adjacent dock. Entrances to individual warehouses are reached via short flights of contemporary, metal steps along this elevation, which are interspersed among truck loading docks. The west portion of the south elevation is set back a few from the adjacent loading docks, creating a shallow "L." A continuous platform, covered by a corrugated metal canopy, runs almost the full length of the north elevation of south building.

# Interior (Figures 9-14 and 20-22)

The interiors of both buildings consist of large volume warehouse spaces with unfinished concrete exterior walls and floors. Ceilings have visible glulam beams while a line of regularly spaced metal columns steps down the center of the buildings. Partitions between warehouse spaces consist of drywall covered by unfinished plywood. Contemporary offices and interior partitions are constructed within the high-volume space using a variety of materials. Large, contemporary, metal refrigerators are also constructed within the high-volume spaces.

### Alterations

The north building was completed in 1963 as two separate buildings. The western portion, Building "B," was 440-feet long, while the eastern portion, Building "C," was 500-feet long. The two buildings were separated by 65 feet. 13 The two portions of the north building appear in a historic aerial photograph from 1965 (Map 10) and a historic Sanborn Fire Insurance map from 1967 (Map 11). The eastern portion of the south building was constructed in 1968 and measured 450-feet long by 202-feet wide. 14 This portion of the south building is evident in a historic Sanborn Fire Insurance map from 1970 (Map 12). Drawings dated March 23, 1973 show a proposed western addition to the south building. Drawings also indicate the two portions of the north building were joined at this date. Elevations of both buildings were also unified with regularly spaced openings and continuous canopies. Building permits from the 1970s and later were not available for this evaluation. It is unknown when contemporary metal stairs and entrances to individual warehouses were added. Many interior offices and refrigeration units appear to have been constructed within the last 20 years.

# Property History

Originally owned by Los Angeles Union Terminal, Inc., the buildings replaced a continuous series of one-story, small produce stalls that were located immediately adjacent to East 6<sup>th</sup> Street (Maps 6-9). A rail spur ran along the south side of the buildings along Produce Street, a private street. Another series of one-story stalls ran along the center of the properties, while a larger warehouse, owned by Los Angeles Public Market Company, was located along the south side of the properties. A second rail spur ran along the private Warehouse Street. L.A. Union Terminal had a small produce warehouse at the southwest corner of the site.

L.A. Union Terminal, Inc. and Los Angeles Public Market Company were "wholly owned facilities of the Southern Pacific Co." Drawings prepared in 1973 indicate the subject properties were a "warehouse extension for Los Angeles Union Terminal, Inc." who developed the Los Angeles Union Market located a short distance away at East 8th and Alameda Streets (described in more detail below). A chain of title was not available for this evaluation.

Southern Pacific Company, later known as Southern Pacific Transportation Company, started in the mid-nineteenth century and became a vertically integrated monopoly in California and throughout

<sup>13 &</sup>quot;1206 E 6th Street," Application to Construct New Building and for Certificate of Occupancy, City of Los Angeles, Department of Building and Safety, Permit No. 22741, 18 October 1962.

<sup>&</sup>quot;1206 E 6th Street," Certificate of Occupancy, City of Los Angeles, Permit No. 22741, 4 June 1963.
"1306 E 6th Street," Application to Construct New Building and for Certificate of Occupancy, City of Los Angeles, Department of Building and Safety, Permit No. 22742, 18 October 1962.

<sup>&</sup>quot;1306 E 6th Street," Certificate of Occupancy, City of Los Angeles, Permit No. 22742, 4 June 1963.

<sup>14 &</sup>quot;1321 Wholesale Street," Application for Inspection of New Building and for Certificate of Occupancy, City of Los Angeles, Department of Building and Safety, Permit No. 61529, 20 December 20, 1967.

<sup>&</sup>quot;1321 Wholesale Street," Certificate of Occupancy, City of Los Angeles, Permit No. 61529, 27 December 1968.

<sup>&</sup>lt;sup>15</sup> "Three Union Terminal Executives Advanced," Los Angeles Times, 7 April 1950, 28.

the country. Southern Pacific's Arcade Station, serving Los Angeles passengers, opened in 1888 at 4<sup>th</sup> and Alameda Streets, very close to the subject properties. The wood-frame Arcade Station operated for about 25 years, when it was replaced by Central Station in 1914, which was located at 5<sup>th</sup> Street and Central Avenue, also close to the subject properties. <sup>16</sup> All passenger trains were redirected to Los Angeles Union Station when it opened in 1939. However, Southern Pacific Company and its subsidiaries continued to use the rails and surrounding land for freight and warehousing.

As noted on the 1967 Sanborn Fire Insurance map, the north building was constructed as a "general merchandise warehouse" while the south building was constructed as a "building material warehouse." As outlined in the Table of Tenants below, early tenants included Montgomery Ward Co., Morton Salt Co., and Major Casket Co.

Original drawings were completed by the Office of the Chief Engineer of the Southern Pacific Transportation Company. Earlier drawings were completed in the Los Angeles office while later drawings were completed in the San Francisco office. It is not known who the chief engineer was during this period. Draftsmen of all drawings are indicated by initials, with the set completed through a collaboration of several different draftsmen.

Nathan Masters, "Lost Train Depots of Los Angeles," KCET SoCal Focus, 17 January, 2013, <a href="http://www.kcet.org/updaily/socal\_focus/history/la-as-subject/lost-train-depots-of-los-angeles.html">http://www.kcet.org/updaily/socal\_focus/history/la-as-subject/lost-train-depots-of-los-angeles.html</a>.

# Tenants

	1965	1969	1975	1980	1987
Address	Tenant	Tenant	Tenant	Tenant	Tenant
1206 6 <sup>th</sup>	Farley Terminal Co, Montgomery Ward Co	Morton Salt Co, Simoniz Co	Bayless Mkt., Donia Frank C., Pathfinder Trucking	Bayless Mkt., Donia Frank Co., Pathfinder Trucking, Pinks Prod., Ray's Prod., Westlake Dist., David Prell	Heath & LeJune, G&K Dist., Butler LD, Fruitworld, Blue Pacific, Direct Produce, Pathfinder Trucking, Mercedes Trucking, Donia
					Frank Co
1230 6 <sup>th</sup>		Wilson Mfgrs Agent			
1266 6 <sup>th</sup>		Progressive Produce	Progressive Produce	Progressive Produce	Progressive Produce
1306 6 <sup>th</sup>	Major Casket Co	Major Casket Co	Major Casket Co.		
1308 6 <sup>th</sup>	Wood Conversion Co	Conwed Corp.	Conwed Corp		
1318 6th	Mutual Wholesale Liquor				
1320 6 <sup>th</sup>	•				Davalan Sales Inc.
1330 6 <sup>th</sup>					California Watercress, Rocky Mtn Prod., Cent. Fruit & Prod., A&L Produce Dock
1338-B 6 <sup>th</sup>	Carlip	Carlip	Veltman Terminal	Veltman	
1205 Wholesale		•			Mrs. Gooches, Charter Produce Corp., United Food, Melissa's Fresh Herbs
1221 Wholesale		Cal Stores			Tranco Imports of LA, Kyo Trading
1225 Wholesale					Tavilla Sales Co
1247 Wholesale		Giardua Produce			
1305 Wholesale					Yu's Company
1317 Wholesale					Acme Trading Corp

#### Assessment

The subject properties have not been previously evaluated for historic or architectural significance and are evaluated in this section of the report.

# Individual Eligibility

Because eligibility criteria for local HCM designation align in large degree with eligibility criteria for National and California Registers, the following evaluation considers eligibility under each of the criteria at federal, state and local levels under a single heading.

Criterion A/1/1: Is associated with events that have made a significant contribution to the broad patterns of our history and cultural heritage.

The two buildings at the subject properties were developed in 1963 and 1968 primarily as general merchandise warehouses. Like earlier warehouses, space at the subject properties was rented by a variety of tenants, storing materials ranging from salt to caskets. As noted above, by the 1960s, the character of the surrounding area was evolving away from that as an industrial center. The period of significance for the identified Downtown Los Angeles Industrial Historic District begins in 1900 and ends in 1940. The subject properties were both constructed after the period of significance and clearly responded to a need for general warehouse space, even though the industrial character of the area was in decline when they were constructed. As general warehouses, the subject properties have not made any contribution to the broad range of our history or cultural heritage simply by temporarily housing a variety of items. In addition, due to significant alterations in 1973, specifically combining two buildings into one and constructing a major addition onto the south building, losses of integrity prevent the subject properties from conveying any meaning they may have once had. Therefore, the buildings at the subject properties are not eligible under Criterion A/1/1.

Criterion B/2/2: Is associated with the lives of persons important in our past.

Owned by a large conglomerate, few, if any, specific individuals can be associated with the subject properties and none rise to the level required to warrant consideration under Criterion B/2/2. There was a high turnover of tenants and it can be assumed that, as warehouse spaces, the subject properties were not the location of important work for any of the individuals connected with the tenants. Therefore, the subject properties are not eligible under Criterion B/2/2.

Criterion C/3/3: Embodies the distinctive characteristics of a type, period, region, or method of construction, or represents the work of an important creative individual or possesses high artistic values.

The buildings at the subject properties have no discernible architectural style and no ornamentation. As utilitarian warehouses, the subject properties are not distinctive of a type, period, region, or method of construction. In addition, as a collaboration between several different draftsmen, the buildings are not significant for an association with an important creative individual or group of individuals. No information on specific draftsmen responsible for the buildings is available. Furthermore, because of alterations in the 1970s, the buildings no longer retain integrity. Therefore, the subject properties are not eligible under Criterion 3/C.

Criterion D/4: Has yielded, or may be likely to yield, information important in prehistory or history. The subject properties cannot be reasonably expected to yield information important in prehistory or history; therefore, they are not eligible under Criterion D/4.

# **Integrity**

In addition to meeting one of the four criteria, National and California Register-eligible properties must also retain sufficient integrity to convey historic significance from their period of significance. A property either retains its integrity, the physical and visual characteristics necessary to convey its significance, or it does not. Evaluation of integrity is founded on "an understanding of a property's physical features and how they relate to its significance." The seven aspects of integrity are Location, Design, Setting, Materials, Workmanship, Feeling, and Association. The two buildings on the subject properties have been significantly altered and do not retain integrity of design, materials, workmanship, or feeling.

Location: The subject properties retain their integrity of location, as they have not been moved or moved to the site.

Design: Integrity of design has been compromised at the subject properties. Originally three buildings, Buildings B and C were combined into one building in 1973. The same year, the west portion of the south building was constructed.

Setting: The subject property retains integrity of setting, which is defined in part as relationships between buildings and other features, or open space.

*Materials*: Integrity of materials at the building at the subject properties was compromised by alterations to the design, as well as by construction of individual warehouse entrances.

Workmanship: Due to losses of integrity of design and materials, the subject properties do not retain integrity of workmanship, or evidence of artisans' labor and skill in constructing or altering a building.

Feeling: Integrity of feeling is defined as a property's expression of the aesthetic or historic sense of a particular period of time resulting from the presence of physical features that, taken together, convey the property's historic character. The subject properties lack integrity of feeling as the original character is no longer present.

Association: Integrity of association requires the presence of physical features that would convey the historic character of a property. As the subject properties were constructed primarily as produce warehouses and they continue to function in that capacity, they retain integrity of association.

### Historic District Eligibility

As noted above, the subject properties are surrounded on three sides by the potential Downtown Los Angeles Industrial Historic District. The buildings at the subject properties were likely excluded from the boundaries due to their construction over two decades after the end of the period of significance. Not only were the buildings constructed well outside of the period of significance, they never represented an important industry nor do they reflect an industrial building typology. The buildings at the subject property are not eligible as contributing buildings to the potential historic

<sup>&</sup>lt;sup>17</sup> Rebecca H. Shrimpton, editor, *How to Apply the National Register Criteria for Evaluation* (Washington, DC: National Park Service, Department of the Interior, 1998) 44, <a href="http://www.nps.gov/history/nr/publications/bulletins/nrb15/">http://www.nps.gov/history/nr/publications/bulletins/nrb15/</a>>.

district. Furthermore, there is not any other potential historic district in the vicinity to which the subject properties could contribute.

# Adjacent and Nearby Historical Resources

### Study Area

This report evaluates potential impacts of the proposed project on identified historical resources that are adjacent and nearby the subject properties (see photographs, Attachment D). For purposes of this analysis, a study area surrounding the subject properties has been defined, outlined in black on the below map, with the subject properties at center highlighted in yellow. While there are no properties in the study area that are individually designated or determined eligible as historical resources, a portion of the boundary of the Downtown Los Angeles Industrial Historic District is located in the study area. The boundary of the historic district is shown on the below map as a blue dashed line, while parcels that have been shaded blue are proposed contributors to the historic district. With the exception of the subject properties, all other properties in the study area are located within the proposed historic district. The subject properties are also located close to the Los Angeles Union Terminal Market, which is outlined in red. The Los Angeles Union Terminal Market is located south and on the opposite side of Alameda Street of the subject properties and proposed historic district. It is therefore not included within the boundaries of the study area.

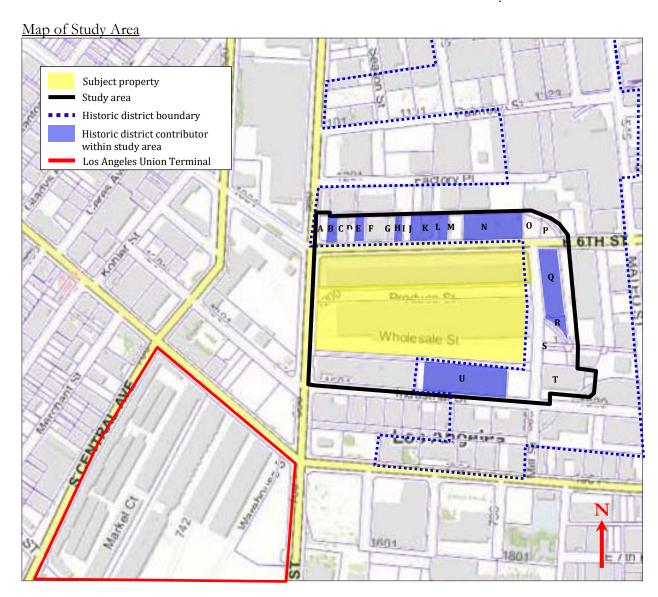


Table of Study Area

Letter	Address	APN	Dates of	Contributor to district?	Figure #
			Construction		
A	1201 E 6 <sup>th</sup> Street	5164-009-041	1985	No	
В	1205 E 6 <sup>th</sup> Street	5164-009-012	1912	Yes	25-26
С	1217 E 6 <sup>th</sup> Street	5164-009-013	1921	No	27
D	1225 E 6 <sup>th</sup> Street	5164-009-014	1958	No	28
Е	1235 E 6 <sup>th</sup> Street	5164-009-015	1901	Yes	29
F	1239 E 6 <sup>th</sup> Street	5164-009-024	1912	No	30
G	1261 E 6 <sup>th</sup> Street	5164-009-018	1909	No	31
Н	1269 E 6 <sup>th</sup> Street	5164-009-019	1906	Yes	32
I	1271 E 6th Street	5164-009-025	N/A	No	33
J	1275 E 6th Street	5164-009-022	1911	Yes	34
K	1281 E 6th Street	5164-009-023	1922	Yes	35
L	1291 E 6th Street	5164-008-003	1923	Yes	36
M	1301 E 6th Street	5164-008-004	2009	No	37
N	1309 E 6 <sup>th</sup> Street	5164-008-005	1923	Yes	38-39
О	1337 E 6 <sup>th</sup> Street	5164-008-006	N/A	No	40
P	No address	5164-008-013	N/A	No	40
Q	1340 E 6 <sup>th</sup> Street	5164-011-001	1924	Yes	41-42
R	1340 E 6 <sup>th</sup> Street	5164-011-002	1945	Yes	42
S	No address	5164-011-003	N/A	No	43
Т	1809 Industrial Street	5164-012-022	1967	No	44
U	1567 Industrial Street	5164-010-002	1905, 1906,	Yes	45-50
			1913, 1919,		
			1971		

### Downtown Los Angeles Industrial Historic District

As noted above, the Downtown Los Angeles Industrial Historic District was identified in SurveyLA as appearing eligible for listing in the National Register, California Register, and locally as a City of Los Angeles HPOZ. As described more fully below, the subject properties were excluded from the historic district boundaries to improve the ratio of contributing resources to noncontributing resources.

The draft survey record for the historic district provides the following description:<sup>18</sup>

The Downtown Los Angeles Industrial Historic District is an industrial area situated between the Alameda Street corridor and the Los Angeles River, just east of downtown Los Angeles. The district occupies flat terrain generally bounded by E. 1st Street on the north, Santa Fe Avenue and Mateo Street on the east, E. 7th Street on the south, and S. Alameda Street on the west. Interior streets are arranged in a generally orthogonal grid, with 4th Street traversing the district diagonally from the northwest to the southeast. Development in the district is almost exclusively industrial in nature, with a handful of commercial and institutional uses. Properties within the district vary widely in size, from modest industrial buildings to massive warehouses spanning full city blocks. Original buildings were constructed primarily from 1900 to 1940 and are predominantly vernacular or utilitarian in design. Today, these early buildings share the block[s] with more recent construction.

The district contains 196 individual buildings. Of these, 104 have been evaluated as district contributors, or approximately 53 percent; 92 properties have been evaluated as non-contributors due to alterations or construction outside the period of significance. Additional distinguishing features of the district include its location in relation to the Alameda Street industrial corridor and the Los Angeles River; the interior circulation pattern (including streets, alleys, and rail spur rights-of-way); the nearly exclusive industrial use; extensive surface parking areas, often designed to accommodate large trucks; the absence of sidewalks and street lighting in some areas; the absence of landscaping throughout the district; evidence of former rail lines (such as remnant tracks, and a rail stop); and remnant granite infrastructure (including curbs, swales, and rail beds).

# History of Contributing Properties

The study area contains a mix of properties identified as contributing and non-contributing to the historic district. Of the 21 properties within the study area, 10 are contributing resources. All can generally be described as having an industrial or utilitarian character. The segment of East 6<sup>th</sup> Street, located north of the subject properties, contains buildings one- to two-stories in height and constructed to the property line. There is the sense of a continuous street wall of similarly scaled, early buildings, even though there are a few breaks for surface parking lots. While most were constructed prior to 1925, there is a mix of contributing and non-contributing properties. East of the subject properties, along Mill Street, the buildings are more varied in height and size. Rising to six-stories, Property R is a warehouse substantially taller and larger than the buildings along East 6<sup>th</sup> Street, although the building has a rear addition to the south, Property S, which is a low-scale, one-story building. South of Property S there is a roadway, Conway Place, and a contemporary two-story building, Property U. Thus, there is no sense of a continuous street wall along Mill Street, but rather

<sup>&</sup>lt;sup>18</sup> Central City North, Historic Districts, Planning Districts, and Multi-Property Resources, draft findings for Downtown Los Angeles Industrial Historic District, City of Los Angeles Office of Historic Resources, 4 Sept 2016: 1.

of separate buildings. Finally, south of the subject properties is a segment of Industrial Street containing buildings one- to two-stories in height. Property V comprises the east half of this segment and contains a row of early contributing buildings constructed to the property lines, offering the sense of a continuous street wall in this location. However, this street wall is interrupted to the west by a row of similarly scaled, non-contributing, buildings located outside the district boundary (Property W).

The following provides a brief developmental history of each contributing property in the study area. Information is based on historic Sanborn maps (included in Attachment B) and building permits. Properties are keyed to the map above and Map 5 (included in Attachment A).

- Property B, 1205 E 6<sup>th</sup> Street (1912): In 1911, a permit was issued to owner Philip L. Wilson for construction of a 3-story, 54-room brick rooming house at 1211 E 6<sup>th</sup> Street. <sup>19</sup> The building was 50x125-feet on a lot of the same size. The architect was R.B. Young and Son. The contractor was Pozzo Construction Company. Valuation of the permit was \$22,000. Historic Sanborn maps show that in 1950 the building was used as a lumber and metal warehouse, in 1953 and 1954 it was used as a hotel, and in 1959-1970 it was used as a Chinaware warehouse and hotel. <sup>20</sup> The building currently functions as low income/homeless housing.
- Property E, 1235 E 6<sup>th</sup> Street (1901): Despite the Los Angeles County Assessor's date of construction of 1901, there are no permits available for this property prior to 1910. In 1910, a permit was issued to owner Mrs. Pearl Vollmer Mines for construction of a 1-story, 1-room brick warehouse at 1235 E 6<sup>th</sup> Street.<sup>21</sup> The building was 50x115-feet on a 50x150-foot lot. The architect was not listed on the permit. The contractor was LA Planing Pill Company. Valuation of the permit was \$43,000. Historic Sanborn maps show that in 1950 the building was used for fish curing, in 1959 it was a smoked fish warehouse, in 1960 it was a metal warehouse; Sanborn maps dated 1967 and 1970 simply label it as a warehouse.<sup>22</sup>
- Property H, 1269 E 6<sup>th</sup> Street (1906): There is no original permit available documenting construction of this property. The earliest available building permit is an alteration permit from 1935, issued to owner A. Pellagrina to add a mezzanine floor for the purpose of storing empty cases and wine bottles.<sup>23</sup> The building was used for the California Wine and Brandy Company at the time. No architect was listed on the permit. The contractor was Albert Claster. Historic Sanborn maps show the building was used for wines and bottling through at least 1953; from 1954 through at least 1970 it was used for old cloth sorting.<sup>24</sup>

1206 East 6th Street, Los Angeles, California

<sup>&</sup>lt;sup>19</sup> "1211 E. 6<sup>th</sup> Street," Application for the Erection of Building, Class D. City of Los Angeles, Board of Public Works, Department of Buildings. Permit No. 9587, 11 October 1911.

<sup>&</sup>lt;sup>20</sup> Sanborn Maps, 1950, 1953, 1954, 1960, 1967, and 1970. City of Los Angeles, Volume 2, Sheets 191-204. Certified Sanborn Map Report for 6th and Alameda Streets, Environmental Data Resources, Inc., 10 May 2017.

<sup>&</sup>lt;sup>21</sup> "1235 E 6th Street," Application for Erection of "Class B & C" Buildings. City of Los Angeles, Board of Public Works, Department of Buildings. Permit No. 5203, 27 June 1910.

<sup>&</sup>lt;sup>22</sup> Sanborn Maps, 1950, 1959, and 1960, 1967, and 1970. City of Los Angeles, Volume 2, Sheets 201-205. Certified Sanborn Map Report for 6th and Alameda Streets, Environmental Data Resources, Inc., 10 May 2017.

<sup>&</sup>lt;sup>23</sup> "1269 E 6th Street," Application to Alter, Repair, Move or Demolish." City of Los Angeles, Department of Building and Safety, Building Division." Permit No. 22228, 25 November 1935.

<sup>&</sup>lt;sup>24</sup> Sanborn Maps, 1950, 1953, 1954, 1970. City of Los Angeles, Volume 2, Sheets 201-205. Certified Sanborn Map Report for 6<sup>th</sup> and Alameda Streets, Environmental Data Resources, Inc., 10 May 2017.

• Property J, 1275 E 6<sup>th</sup> Street (1911):

In 1910, a permit was issued to owner E.M. Weyl and M. Zuckerman for construction of a 2-story brick wholesale produce building at 1275-1277 E 6<sup>th</sup> Street.<sup>25</sup> The building was 50x125-feet on a lot of the same size and valued at \$12,500. The building was designed by the architectural partnership of Edelman and Barnett. Abraham A. Edelman was a prolific and prominent Los Angeles architect who practiced for over 50 years. His "greatest achievement" was his design of Wilshire Boulevard Temple in 1929.<sup>26</sup> Historic Sanborn maps show that the building was used for furniture manufacturing from at least 1950 until at least 1970.<sup>27</sup>

# • Property K, 1281 E 6<sup>th</sup> Street (1922):

In 1922, a building permit was issued to owner Pacific Provision Company to construct a 1-story plus basement brick cold storage warehouse at 1281 E 6<sup>th</sup> Street.<sup>28</sup> The building was 50x125-feet on a 100x135-foot lot, designed by the owner and constructed by contractor Lynch Cannon Engineering Company. Later the same year, a permit was issued to the same owner to add a cooling tower to the roof of the existing building.<sup>29</sup> Historic Sanborn maps show that by 1950 the building was used as a food warehouse, by 1953 it was used as a fresh dairy products warehouse, and by 1959 through at least 1970 it was used as a smoked fish warehouse.<sup>30</sup>

# • Property L, 1291 E 6<sup>th</sup> Street (1923):

In 1922, a building permit was issued to owner Mc. Cunniff Brothers for construction of a 2-story, brick, 3-room warehouse at 1291 E 6<sup>th</sup> Street.<sup>31</sup> The 50x125 foot building was designed by architect F.D. Harrington. The contractor was Mc. Cuniff Brothers. Valuation of the permit was \$20,000. Historic Sanborn maps show that by 1950 the building was used as a "stationary warehouse," by 1959 it was used as a rag warehouse, and by 1967 it was used for parking on the first floor and offices on the second.<sup>32</sup>

# • Property N 1309 E 6<sup>th</sup> Street (1923):

Historic Sanborn maps show this property historically included addresses 1309-1331 E 6<sup>th</sup> Street. In 1922 a permit was issued to owner Los Angeles Gas and Electric Corporation for construction of a 134x134-foot, 1-story, 3-room garage building of brick.<sup>33</sup> The owner is

<sup>&</sup>lt;sup>25</sup> "1275-1277 E 6th Street," Application for Erection of "Class B & C" Buildings. City of Los Angeles, Board of Public Works, Department of Buildings. Permit No. 2009, 12 March 1910.

<sup>&</sup>lt;sup>26</sup> Henry F. Withey and Elise Rathburn Withey, *Biographical Dictionary of American Architects (Deceased)*, (Los Angeles: Hennessey & Ingalls, Inc., 1970), 189-190.

 $<sup>^{27}</sup>$  Sanborn Maps, 1950 and 1970. City of Los Angeles, Volume 2, Sheets 201-205. Certified Sanborn Map Report for  $^{6th}$  and Alameda Streets, Environmental Data Resources, Inc., 10 May 2017.

<sup>&</sup>lt;sup>28</sup> "1281 E 6<sup>th</sup> Street," Application for Erection of Buildings, Class C. City of Los Angeles, Board of Public Works, Department of Buildings. Permit No. 31842, 14 September 1922.

<sup>&</sup>lt;sup>29</sup> "1281 E 6th Street," Application to Alter, Repair or Demolish. City of Los Angeles, Board of Public Works, Department of Buildings. Permit No. 46912, 27 December 1922.

<sup>&</sup>lt;sup>30</sup> Sanborn Maps, 1950, 1953, 1959, and 1970. City of Los Angeles, Volume 2, Sheets 201-205. Certified Sanborn Map Report for 6th and Alameda Streets, Environmental Data Resources, Inc., 10 May 2017.

<sup>&</sup>lt;sup>31</sup> "1291 E 6th Street," Application for the Erection of Buildings, Class C. City of Los Angeles, Board of Public Works, Department of Buildings. Permit No. 47077, 27 December 1922.

<sup>&</sup>lt;sup>32</sup> Sanborn Maps, 1950, 1959, and 1967. City of Los Angeles, Volume 2, Sheets 201-205. Certified Sanborn Map Report for 6<sup>th</sup> and Alameda Streets, Environmental Data Resources, Inc., 10 May 2017.

<sup>&</sup>lt;sup>33</sup> "1317 E 6th Street," Application for the Erection of Buildings, Class C. City of Los Angeles, Board of Public Works, Department of Buildings. Permit No. 40924, 13 November 1922.

listed as the architect. Valuation of the permit was \$30,000. Historic Sanborn maps show that by 1950 the property was occupied by Gas Appliances, Inc., by 1959 it was occupied by Affiliated Metal Products and included sheet metal storage, and by 1976 it was occupied by Universal Titanium Company, Inc. <sup>34</sup>

- Properties Q and R, 1340 E 6<sup>th</sup> Street (1924, 1945):
  In 1924, a permit was issued to owner Western Improvement Company for construction of a 6-story reinforced concrete warehouse building built to the parcel boundaries at 1340 E 6<sup>th</sup> Street.<sup>35</sup> There is no architect listed on the permit. The engineer was O.G. Boweil. The contractor was C. A. Fellows. Valuation of the permit was \$85,000. In 1945, a permit was issued to owner Metropolitan Warehouse Company for addition of a new 5,300 square foot building.<sup>36</sup> The architect was Harry T. Miller. The contractor was William P. Neil Company, Ltd. Valuation of the permit was \$16,000. Historic Sanborn maps show that from 1950-1970 the building was identified as the Metropolitan warehouse, used as a general storage warehouse.<sup>37</sup> The 1945 addition is referred to as the "annex" on these maps.
- Property U, 1567 Industrial Street (circa 1900-1905, 1914, 1971): This property includes a long rectangular parcel encompassing addresses 1555-1719 Industrial Street, comprised of five building with multiple dates of construction. While there are no building permits documenting construction of the earliest buildings at the property, the 1906 Sanborn map shows the property developed with two of the existing buildings, located in its east half; the buildings were used for cement storage at the time. 38 In 1914, a permit was issued for construction of an additional 1-story, 80x68-foot, steel storage warehouse at 1575 Industrial Street.<sup>39</sup> The owner's name is illegible on the permit. There is no architect listed and the contractor was the owner. In 1917, a permit was issued to owner California Sanitary Canning Company for erection of a 25x100-foot loading platform at 1583-1593 Industrial Street. 40 Historic Sanborn maps show that by 1950 the buildings at the property were used for industrial operations including: building materials and cement storage, paper products warehouse, bottle closure warehouses, bottle stopper manufacturing, and for a private garage and auto repair facility; from 1960-1970, uses remained industrial and had changed slightly to include metal furniture assembly and warehouse space. 41 In 1971, an addition was made to the property incorporating new construction at its west end; a Certificate of Occupancy was issued to owner American Bonded Fiber for a 1-story, 59x149-

<sup>&</sup>lt;sup>34</sup> Sanborn Maps, 1950, 1959, and 1976. City of Los Angeles, Volume 2, Sheets 201-205. Certified Sanborn Map Report for 6th and Alameda Streets, Environmental Data Resources, Inc., 10 May 2017.

<sup>&</sup>lt;sup>35</sup> "1340 E 6th Street," Application for the Erection of Buildings, Class A. City of Los Angeles, Board of Public Works, Department of Buildings. Permit No. 30401, 24 July 1924.

 $<sup>^{36}</sup>$  "1340 E 6th Street," Application to Alter, Repair, Move or Demolish. City of Los Angeles, Department of Building and Safety, Building Division. Permit No. 10512, 18 July 1945.

<sup>&</sup>lt;sup>37</sup> Sanborn Maps, 1950, 1960, and 1970. City of Los Angeles, Volume 2, Sheets 203-209. Certified Sanborn Map Report for 6<sup>th</sup> and Alameda Streets, Environmental Data Resources, Inc., 10 May 2017.

 $<sup>^{38}</sup>$  Sanborn Map, 1906. City of Los Angeles, Volume 2, Sheets 201-205. Certified Sanborn Map Report for  $6^{th}$  and Alameda Streets, Environmental Data Resources, Inc., 10 May 2017.

<sup>&</sup>lt;sup>39</sup> "1575 Industrial Street," Application for Erection of Frame Building, Class D." City of Los Angeles, Board of Public Works, Department of Buildings. Permit No. 23819, 16 December 1914.

<sup>&</sup>lt;sup>40</sup> "1583-1593 Industrial Street," Application for Erection of Frame Building, Class D. City of Los Angeles, Board of Public Works, Department of Buildings. Permit No. 4405, 23 August 1917.

<sup>&</sup>lt;sup>41</sup> Sanborn Maps, 1950, 1960, and 1970. City of Los Angeles, Volume 2, Sheets 201-209. Certified Sanborn Map Report for 6<sup>th</sup> and Alameda Streets, Environmental Data Resources, Inc., 10 May 2017.



<sup>&</sup>lt;sup>42</sup> "1601 Industrial Street," Certificate of Occupancy. City of Los Angeles, Department of Building and Safety. Permit No. 23366, 8 September 1971.

### VI. THRESHOLDS FOR DETERMINING SIGNIFICANCE OF IMPACTS

# California Environmental Quality Act (CEQA) Guidelines

According to the CEQA Guidelines, a project would result in a significant impact to historical resources if it would cause a *substantial adverse change* in the significance of an historical resource. A substantial adverse change is defined in CEQA Guidelines §15064.5(4)(b)(1), as "physical demolition, destruction, relocation, or alteration of the resource or its immediate surroundings such that the *significance of an historical resource would be materially impaired.*" The significance of an historical resource is materially impaired, according to CEQA Guidelines §15064.5(4)(b)(2), when a project:

- (A) Demolishes or materially alters in an adverse manner those physical characteristics of an historical resource that convey its historical significance and that justify its inclusion in, or eligibility for, inclusion in the California Register of Historical Resources; or
- (B) Demolishes or materially alters in an adverse manner those physical characteristics that account for its inclusion in a local register of historical resources pursuant to \$5020.1(k) of the Public Resources Code or its identification in an historical resources survey meeting the requirements of \$5024.1(g) of the Public Resources Code, unless the public agency reviewing the effects of the project establishes by a preponderance of the evidence that the resource is not historically or culturally significant; or
- (C) Demolishes or materially alters in an adverse manner those physical characteristics of an historical resource that convey its historical significance and that justify its eligibility for inclusion in the California Register of Historical Resources as determined by a lead agency for purposes of CEQA.

The CEQA Guidelines also specify a means of evaluating the relative significance of project impacts on historical resources. CEQA Guidelines §15064.5(b)(3) state:

Generally, a project that follows the Secretary of the Interior's Standards for the Treatment of Historic Properties (Secretary's Standards, Weeks and Grimmer, 1995), shall be considered as mitigated to a level of less than a significant impact on the historical resource. 43

Under CEQA, the key issue relates to how a proposed development may impact the potential eligibility of a structure(s) or a site for designation as an historic resource. The Secretary's Standards were developed by the U.S. Department of the Interior as a means to evaluate and approve work for federal grants for historic buildings and then for the federal rehabilitation tax credit (see 36 Code of Federal Regulations Section 67.7). Similarly, the City's Cultural Heritage Ordinance provides that compliance with the Secretary's Standards is part of the process for review and approval by the Cultural Heritage Commission of proposed alterations to Historic-Cultural Monuments (see Los Angeles Administrative Code Section 22.171.14. a.1). Therefore, the Secretary's Standards are used for regulatory approvals for designated resources but not for resource evaluations. Similarly, CEQA recognizes the value of the Secretary's Standards by using them to demonstrate that a project may be approved without an Environmental Impact Report (EIR). In effect, CEQA has a "safe harbor" by providing either a categorical exemption or a negative declaration for a project which meets the Secretary's Standards (see State CEQA Guidelines Section 15331 and 15064.S(b)(3)).

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<sup>&</sup>lt;sup>43</sup> CEQA Guidelines §15604.5(b)(3).

In summary, the definition of substantial adverse change is whether a project demolishes or materially alters in an adverse manner the physical characteristics that convey historical significance of the resource or that justify its eligibility for the California Register or a local register such as the list of Historic-Cultural Monuments. In other words, if a project would render an eligible historic resource ineligible then there would be a significant adverse effect under CEQA.

# Secretary of the Interior's Standards for Treatment of Historic Properties

As noted above, projects in conformance with the Secretary's Standards generally have a less than significant environmental impact on historical resources. The Secretary's Standards consist of four treatments, the most common of which is rehabilitation, which is defined as "the act or process of making possible a compatible use for a property through repair, alterations, and additions while preserving those portions or features which convey its historical, cultural, or architectural values." The rehabilitation standards are:

- 1. A property will be used as it was historically or be given a new use that requires minimal change to its distinctive materials, features, spaces, and spatial relationships.
- 2. The historic character of a property will be retained and preserved. The removal of distinctive materials or alteration of features, spaces, and spatial relationships that characterize a property will be avoided.
- 3. Each property will be recognized as a physical record of its time, place, and use. Changes that create a false sense of historical development, such as adding conjectural features or elements from other historic properties, will not be undertaken.
- 4. Changes to a property that have acquired historic significance in their own right will be retained and preserved.
- 5. Distinctive materials, features, finishes, and construction techniques or examples of craftsmanship that characterize a property will be preserved.
- 6. Deteriorated historic features will be repaired rather than replaced. Where the severity of deterioration requires replacement of a distinctive feature, the new feature will match the old in design, color, texture, and, where possible, materials. Replacement of missing features will be substantiated by documentary and physical evidence.
- 7. Chemical or physical treatments, if appropriate, will be undertaken using the gentlest means possible. Treatments that cause damage to historic materials will not be used.
- 8. Archeological resources will be protected and preserved in place. If such resources must be disturbed, mitigation measures will be undertaken.
- 9. New additions, exterior alterations, or related new construction will not destroy historic materials, features, and spatial relationships that characterize the property. The new work will be differentiated from the old and will be compatible with the historic materials, features, size, scale and proportion, and massing to protect the integrity of the property and its environment.
- 10. New additions and adjacent or related new construction will be undertaken in such a manner that, if removed in the future, the essential form and integrity of the historic property and its environment would be unimpaired.

The Secretary's Standards are intended to be flexible and adaptable to specific project conditions to balance change while retaining historic building fabric to the maximum extent feasible. The National Park Service has created a substantial amount of written guidance, most of it available

online, including Illustrated Guidelines for Rehabilitating Historic Buildings, Preservation Briefs, Preservation Tech Notes, and Interpreting the Standards Bulletins (ITS).

# VII. ASSESSMENT OF PROJECT IMPACTS

# **Description of Proposed Project**

The proposed project is described in a drawing set prepared by Grimshaw, Inc, dated June 12, 2023 (see Attachment E). The proposed project involves demolition of both existing buildings at the subject properties and construction of a new production studio campus for movies, television and commercials. The campus will consist of 16, tall, one-story studios (53-feet), assembled into five groups and associated three production support areas. In addition, the campus will include two, five-story office buildings (74-feet), and a five-story parking structure (57-feet).

The office buildings will be located at the northwest corner of the site at 6<sup>th</sup> and Alameda Streets and northeast corner of the site at 6<sup>th</sup> and Mills Streets. Two groups of three studios each will be separated by a production support area along the 6<sup>th</sup> Street property line to the north. Along the southern property line, a pair of large studios will be flanked by a production support area on either side with two additional groups of four studios creating a symmetrical composition. The parking structure will be roughly centered along the east side of the property facing Mill Street. All buildings are proposed to be constructed nearly to the property lines with a minimal set-back.

In addition to the parking structure, surface parking will also be located at ground level between the rows of studios. Two driveways for vehicle access will be provided along 6<sup>th</sup> Street between each of the office buildings and studio buildings. An additional entrance to the parking structure will be located along Mill Street. Pedestrian access will be granted through gates at the east and west sides of the property.

All buildings are rectangular in plan with flat roofs and designed in a contemporary style. The studios will be constructed of tilt-up concrete wall panels. In contrast to the solid mass of the studios, the two office buildings will be divided nearly in half. Both halves will have regularly spaced fenestration, although windows on one side will be larger and placed closer together than the other half. The more open portion of the office building will be finished in bronze color cladding. Floor plates will project slightly from the face of the building, emphasizing a horizontal axis. The more solid portion of the office building will be clad in light colored panels. A fin will be placed vertically alongside each window, emphasizing a vertical axis. Ground floors of the office buildings will be primarily glazed, providing access to the office lobby as well as possible retail tenants. Along Mill Street, ground floors will be finished in a painted concrete masonry unit. Some panels of CMU may be painted with a mural. The rooftops of both office buildings will serve as a landscaped terrace.

# **Evaluation of Direct Impacts**

Since existing buildings at the subject property do not appear eligible for listing in the National or California Registers or for local designation, there is no potential for direct impacts to historical resources at the project site.

Potential direct impacts caused by construction activities, including excavation, impaction, shoring, etc. were considered for Property V, located at 1567 Industrial Street, the only contributing property to the Downtown Los Angeles Industrial Historic District that is immediately adjacent to the subject properties. As discussed in Section G of the Environmental Impact Report analyzing potential noise and vibration impacts, given the distance to Property V and method of construction planned for the proposed project, no vibration impacts are anticipated.

### **Evaluation of Indirect Impacts**

In general, CEQA describes an *indirect* impact as one that results from the "...alteration of the resource or *its immediate surroundings* such that the significance of an historical resource would be materially impaired" (CEQA Guidelines §15064.5(b)(1)(emphasis added). The proposed project consists of new construction in close proximity to an identified historical resource: the Downtown Los Angeles Industrial Historic District. While the project site is outside the proposed historic district, there is nevertheless the potential for indirect impacts to the setting of the district. Therefore, the following analysis considers indirect impacts to the setting of the district, specifically those properties within the study area, as identified above. Although outside of the historic district, the *Secretary's Standards* are a useful tool for assessing potential indirect impacts, specifically Secretary's Standard 9, which deals with compatibility of new additions.

While proposed project is located outside of the boundary of the historic district, it can still impact integrity of the district's setting, which is defined in part as relationships between buildings and other features, or open space. As described above, the district is historically significant for its vernacular-and utilitarian-style industrial buildings constructed from 1900-1940. The setting of the district consists of buildings that range in scale and include buildings of low-mid- and high-rise construction, with some areas incorporating "in-between spaces," such as public or private alleys. While some of the existing buildings are modestly sized, encompassing only a single assessor parcel, others consume entire city blocks. The range of variation in building types reflects the multitude of unique industrial uses inhabiting the area over time.

The proposed project is in conformance with Standard 9 as it will not destroy any spatial relationships that characterize adjacent and nearby historical resources. Specifically, the proposed project is designed in a contemporary style and is distinct from the surrounding buildings in the historic district. While some of the adjacent buildings within the historic district are one-story, Property Q, located at 1340 East 6<sup>th</sup> Street immediately south of the proposed project is five-stories, a similar height as the office buildings at the proposed project. In addition, the proposed project is comprised of a campus of multiple buildings, not dissimilar to Property U at 1567 Industrial Street, which consists of five separate buildings. As the proposed project maintains a similar size, scale, proportion and massing to the surrounding historic district, it will conform with Secretary's Standard 9 and not destroy the historic district's integrity of setting.

### **Evaluation of Cumulative Impacts**

There are a total of 21 related projects in the vicinity of the proposed project at the subject properties, based on information obtained primarily from Los Angeles Department of Transportation and the Department of City Planning. Six of the related projects are located within the identified Downtown Los Angeles Industrial Historic District while five are located within one city block of the identified boundaries. The six related projects within the boundaries of the identified Downtown Los Angeles Industrial Historic District are:

- Related Project #2, Mixed-Use, 1340 E. 6<sup>th</sup> St.: Six-story industrial warehouse building identified as a contributing resource to the historic district in SurveyLA. A proposed project will convert the building to live/work units. No historical resource impacts were identified in a Categorical Exemption processed in 2018.
- Related Project #4, Palmetto, 527 Colyton St.: Proposed construction of a mixed-use development that includes residential and commercial space. 527 Colyton St. is currently developed with one building that was identified in SurveyLA as a non-

- contributing resource to the historic district. The Initial Study (IS) describes that possible impacts to the identified historic district will be studied in the EIR, which has not yet been published.
- Related Project #5, Mixed-Use (Revised), 1800 E. 7<sup>th</sup> St.: Construction of a new, 7-story mixed-use project on a surface parking lot. No historical resource impacts were identified in an IS/MND certified in 2019 and addendum published in 2020.
- Related Project #9, Arts District Center, Mixed-Use, 1129 E. 5<sup>th</sup> St.: Construction of a 12-story, mixed use building was studied in an EIR published in 2019. Although SurveyLA identified the existing building at the site as a contributing resource to the identified historic district, the technical report accompanying the EIR found that it did not retain sufficient integrity. Therefore, no historical resource impacts were identified in the EIR that was certified in 2019.
- Related Project #10, 400 S. Alameda St.: Conversion of an identified contributing resource to hotel, restaurant, and retail use. The 1908 building's exterior walls are proposed to be retained while adding a single-story rooftop addition. No historical impacts were identified in an IS/MND prepared in 2017.
- Related Project #13, 4th & Hewitt, 405 S. Hewitt St.: The proposed project includes demolition of existing non-contributing buildings and construction of an 18-story building. An EIR was published in 2002. The accompanying Historic Resource Technical Report did not identify any potential impacts to historical resources.

The five projects located immediately adjacent to the identified historic district are:

- Related Project #1, Camden Arts Mixed-Use, 1525 Industrial St.: Studied in a MND dated 2016, the project involves demolition of existing building and construction of a new, seven-story, mixed-use project. The existing building was found not to be a historical resource and no cultural resource impacts were identified.
- Related Project #3, 668 Alameda St. Mixed-Use, 668 S. Alameda St.: New, 7-story, mixed-use development, replacing an existing, contemporary building. No indirect impacts were identified on nearby historical resources, including the identified Downtown Industrial Historic District.
- Related Project #6, 1100 5<sup>th</sup> Mixed-Use, 1100 E 5<sup>th</sup> St.: Proposed new 8-story building to replace three, existing warehouses. The IS, published in February 2018, identified potential historical resource impacts as one of the existing warehouse buildings was constructed in 1928. No additional environmental review has been published in the past five years elaborating on possible historic resource impacts.
- Related Project #7, 676 Mateo Mixed-Use, 676 S. Mateo St.: Demolition of the existing building on the site, which dates from 1978, and construction of a new, eight-story, mixed-use development. An EIR, published in January 2021, did not identify any potential indirect impacts to historical resources located across Mateo St.
- Related Project #8, 520 Mateo Project, 520 Mateo St.: Demolition of an existing building that is approximately 30 years old and not identified as a historical resource and construction of a new, 35-story tower. The Draft EIR did not identify impacts to any nearby historical resources. Potential impacts to the identified Downtown Industrial Historic District were not studied in the Draft EIR.

No direct or indirect impacts to historic resources were identified for the six related projects located within the Los Angeles Industrial Downtown Historic District. Of the five related projects adjacent to and nearby the Los Angeles Industrial Downtown Historic District, only one identified possible historic resources impacts that will be studied in a future environmental document. At this point in time, none of the related projects have recognized impacts to historical resources. Specifically, none identify historical resource impacts, either direct or indirect, to the setting of the identified historic district.

CEQA §15355 defines a cumulative impact as "two or more individual effects which, when considered together, are considerable or which compound or increase other environmental impacts." The proposed project has not been shown to have either a direct or an indirect impact on historical resources, specifically, it will not indirectly impact the setting of the historic district. As the proposed project will not on its own indirectly impact the setting of the identified historic district, when considered with the other 11 related projects described above, there would not be a compounded impact to the setting of the identified historic district.

### VIII. CONCLUSION

This report evaluates existing buildings at the subject properties, finding they are not eligible as historical resources under CEQA. However, the subject properties are immediately adjacent to an identified historical resource: the Downtown Los Angeles Industrial Historic District. This district is significant for its grouping of early industrial buildings. The proposed project entails construction of a nearly fifteen acre site with a production soundstage, office and other studio support buildings. The proposed project was evaluated for potential direct and indirect impacts on the historic district. Given the method of construction and distance from Property V, located at 1567 Industrial Street, direct impacts due to damage from vibration or other construction activities, are not anticipated While the proposed project could cause direct impacts to Property V, located at 1567 Industrial Street, that these impacts will be less than significant with precautions taken during planning, excavation, and construction. Finally, the proposed project will not materially impair the setting of the identified historic district and will not result in an indirect impact to its setting. The proposed project was also evaluated for cumulative impacts along with 27 other development projects in the area and does not appear that it will result in any cumulative impacts to historical resources.

### IX. BIBLIOGRAPHY

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- "Handling Farm Produce for a Great City," Los Angeles Times, 8 February 1925.
- "Huge Terminal Plans Are Announced," Los Angeles Times, 5 February 1916.
- "Modern Produce Plant Planned to Take Care of Expanding Business," Los Angeles Times, 21 March 1909.
- "Three Union Terminal Executives Advanced," Los Angeles Times, 7 April 1950, 28.
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# Reports


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- Henry F. Withey and Elise Rathburn Withey, *Biographical Dictionary of American Architects (Deceased)*, (Los Angeles: Hennessey & Ingalls, Inc., 1970), 189-190.

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  - <a href="http://www.chinatownremembered.com/index.php?option=com\_content&view=article&id=78&Itemid=112">http://www.chinatownremembered.com/index.php?option=com\_content&view=article&id=78&Itemid=112>.</a>
- Masters, Nathan. "Lost Train Deports of Los Angeles," KCET SoCal Focus, 17 January 2013, <a href="http://www.kcet.org/updaily/socal\_focus/history/la-as-subject/lost-train-depots-of-los-angeles.html">http://www.kcet.org/updaily/socal\_focus/history/la-as-subject/lost-train-depots-of-los-angeles.html</a>.

#### Attachment A: Maps




Map 1: Location map, subject properties circled (Source: Google map, 2015)

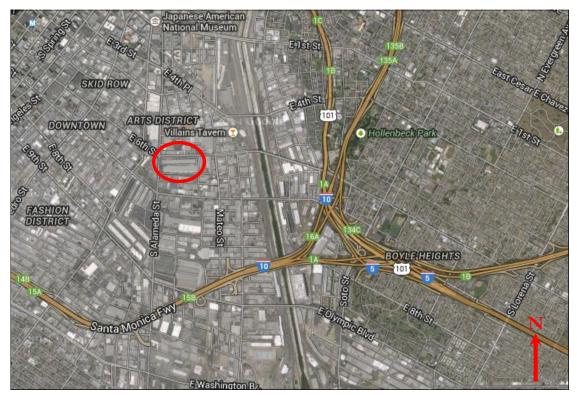

Map 2: Detail of location map, subject properties circled (Source: Google map, 2015)

# Attachment A: Maps

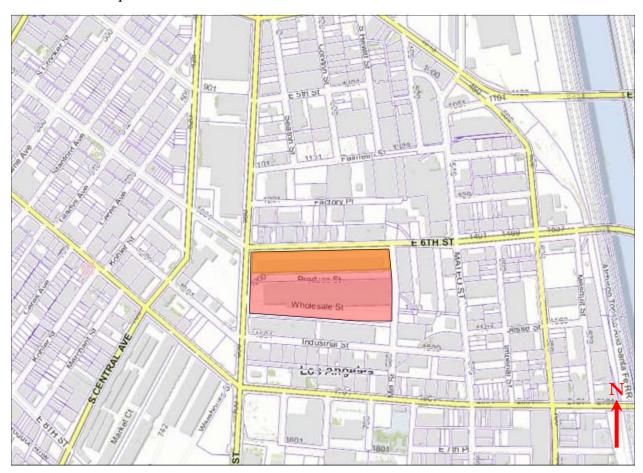


Map 3: Location map, subject property highlighted red (Source: Los Angeles County Assessor, 2015)




**Map 4:** SurveyLA map of Downtown Los Angeles Industrial Historic District, subject properties highlighted in yellow (Source: City of Los Angeles Office of Historic Resources, September 4, 2016)


#### Attachment A: Maps

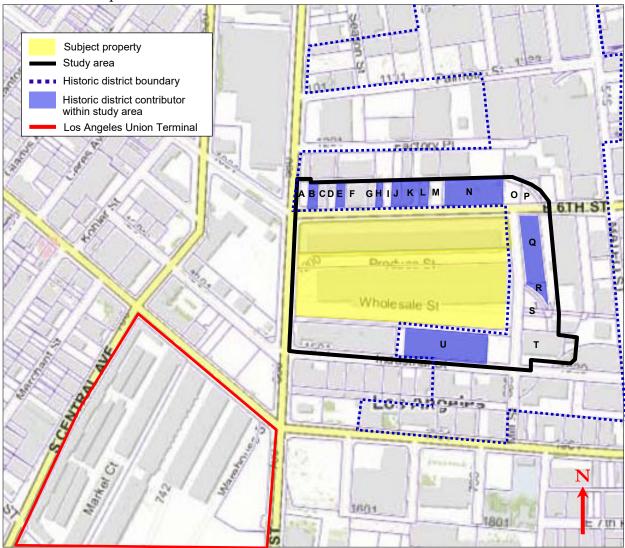

**Map 5:** Parcel map of study area, with subject property shaded yellow; study area outlined in black; boundary of Downtown Los Angeles Industrial Historic District outlined in blue dashed line; and contributors to the district shaded in blue. Also outlined is Los Angeles Union Terminal outlined in red (Source of base map: Los Angeles County Assessor)

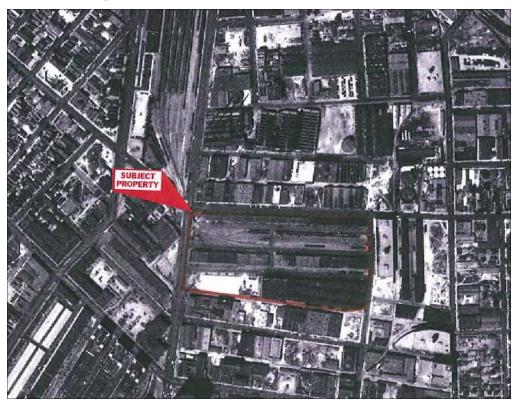

Map 6: Historic aerial photo, subject properties outlined in red (1928)

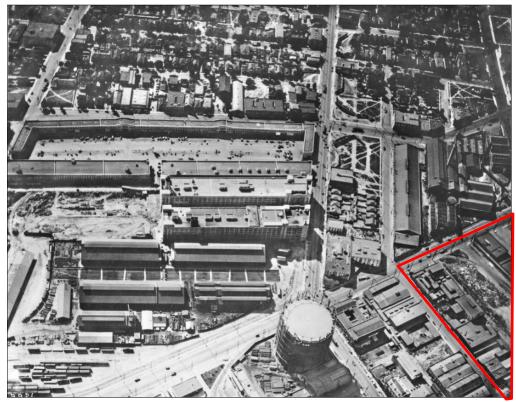


**Map 7:** View northwest showing a portion of subject property in 1928 (Source: USC Digital Library)

1206-1338East 6th Street & 1205-1321 Wholesale Street




Map 8: Historic aerial photo, subject properties outlined in red (1947)

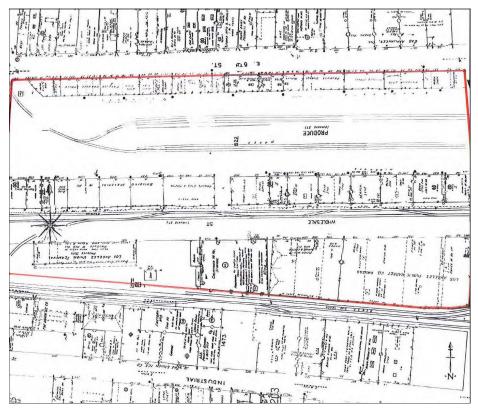


Map 9: Sanborn Fire Insurance map, subject properties outlined in red (1954)



Map 10: Historic aerial photo, subject properties outlined in red, note northern building extant (1965)

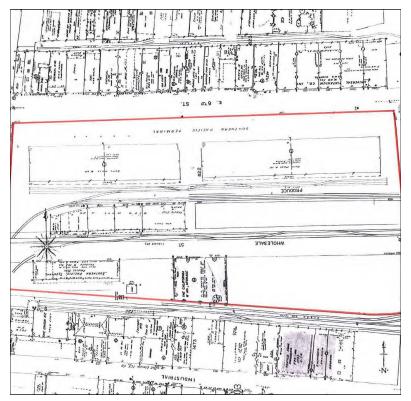

Map 11: Sanborn Fire Insurance map, subject properties outlined in red (1967)

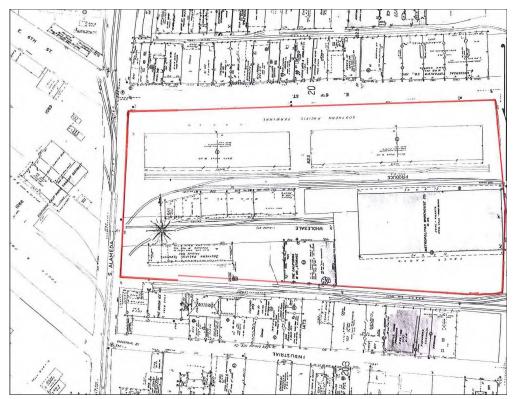


**Map 12:** Sanborn Fire Insurance map, subject properties outlined in red, note part of southern building extant (1970)




**Map 13:** Historic aerial photo, subject properties outlined in red, note both buildings extant as they currently appear (1976)


1206 – 1338 East 6th Street & 1205 – 1321 Wholesale Street

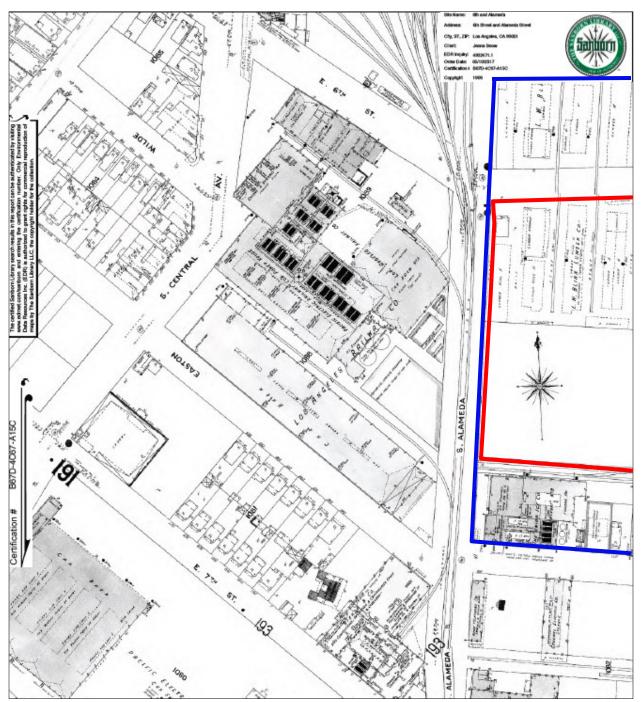


**Map 14:** Sanborn Map showing west portion of study area (outlined in blue) and subject properties (outlined in red), 1906 (Environmental Data Resources, Inc.)

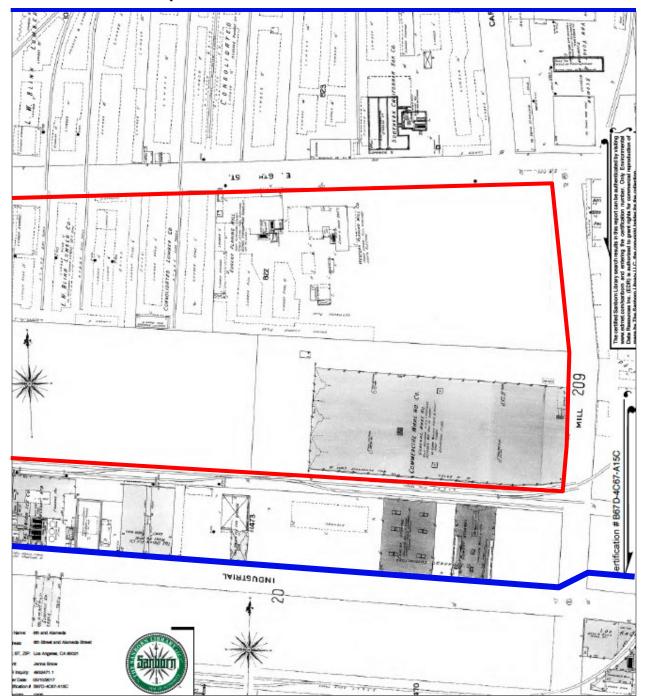


**Map 15:** Sanborn Map showing center portion of study area (outlined in blue) and subject properties (outlined in red), 1906 (Environmental Data Resources, Inc.)

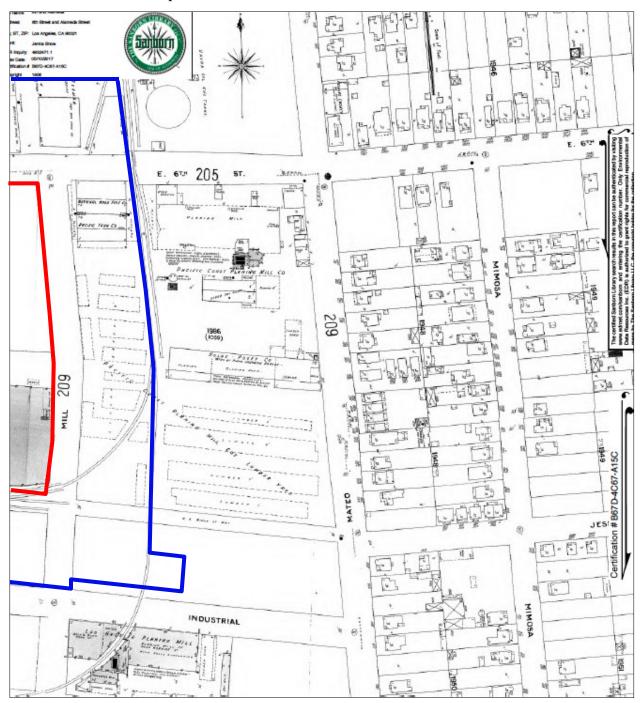


**Map 16:** Sanborn Map showing east portion of study area (outlined in blue) and subject properties (outlined in red), 1906 (Environmental Data Resources, Inc.)

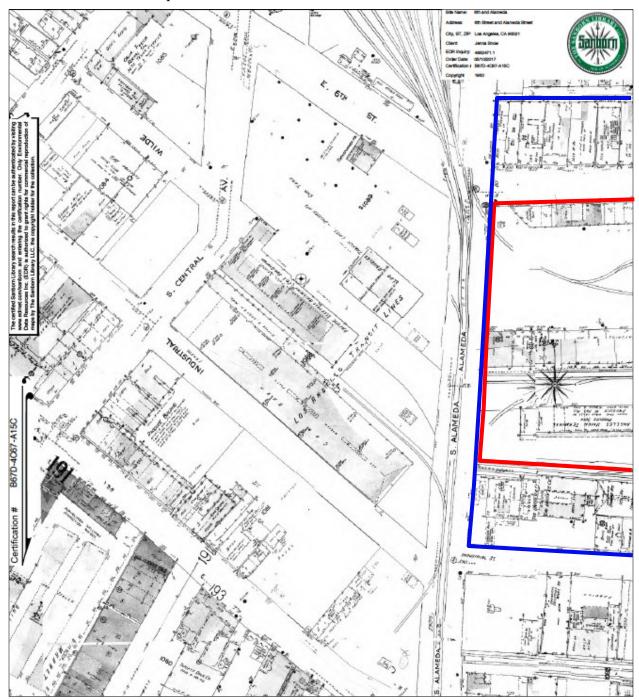


**Map 17:** Sanborn Map showing west portion of study area (outlined in blue) and subject properties (outlined in red), 1950 (Environmental Data Resources, Inc.)

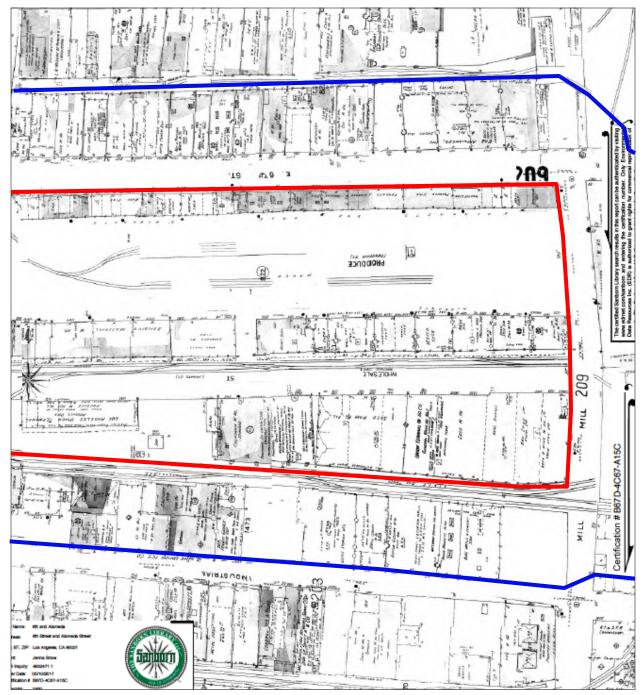


**Map 18:** Sanborn Map showing center portion of study area (outlined in blue) and subject properties (outlined in red), 1950 (Environmental Data Resources, Inc.)

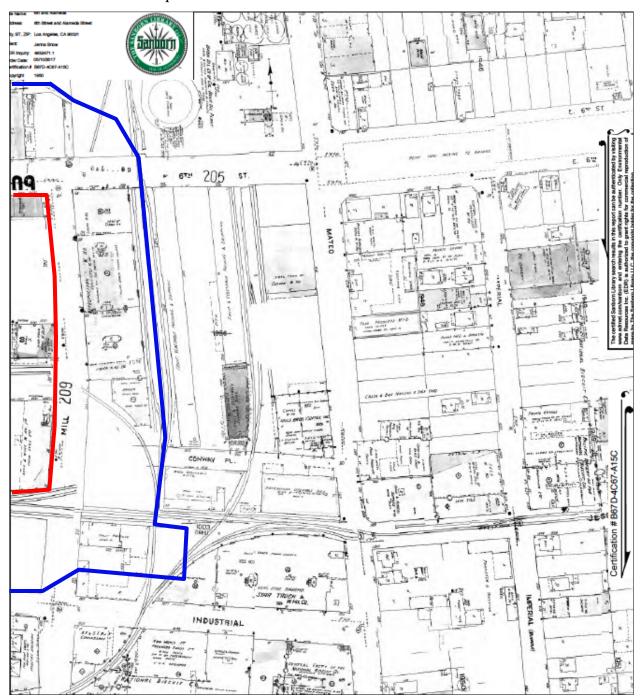


**Map 19:** Sanborn Map showing east portion of study area (outlined in blue) and subject properties (outlined in red), 1950 (Environmental Data Resources, Inc.)

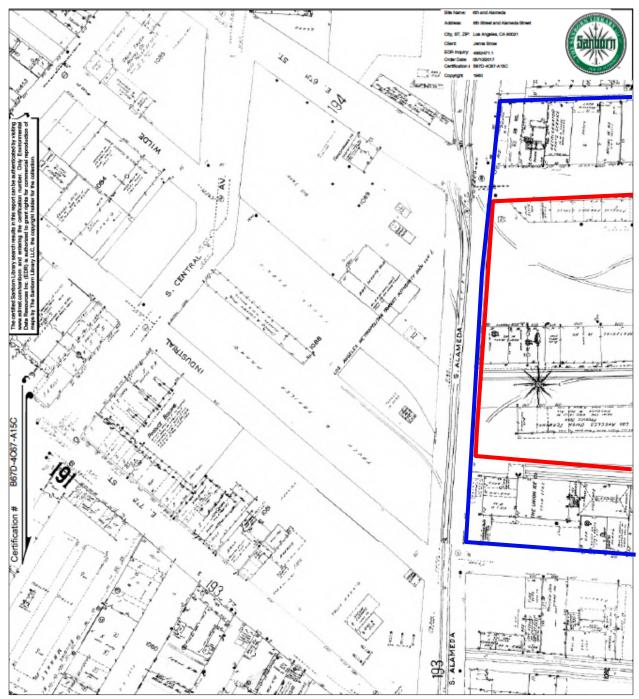


**Map 20:** Sanborn Map showing west portion of study area (outlined in blue) and subject properties (outlined in red), 1960 (Environmental Data Resources, Inc.)

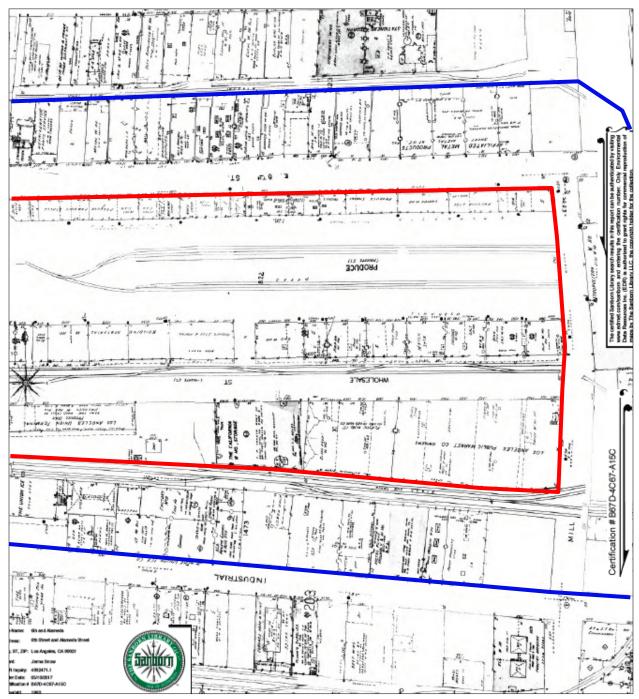


**Map 21:** Sanborn Map showing center portion of study area (outlined in blue) and subject properties (outlined in red), 1960 (Environmental Data Resources, Inc.)

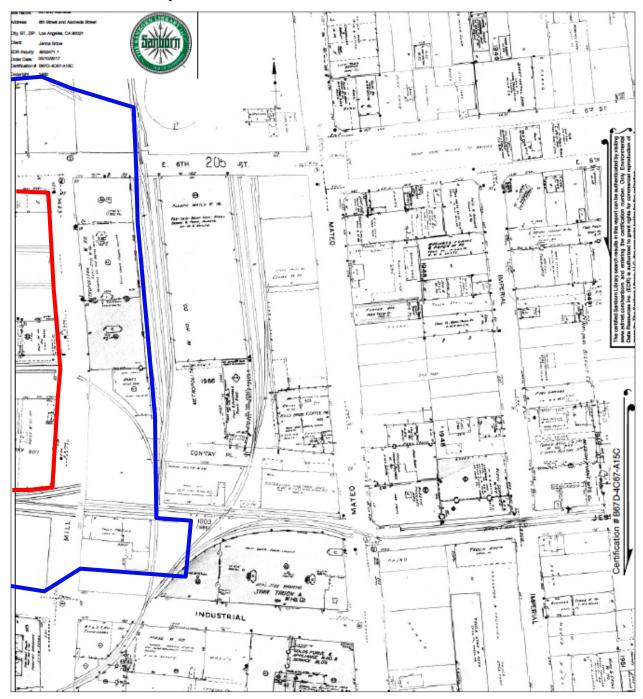


**Map 22:** Sanborn Map showing east portion of study area (outlined in blue) and subject properties (outlined in red), 1960 (Environmental Data Resources, Inc.)

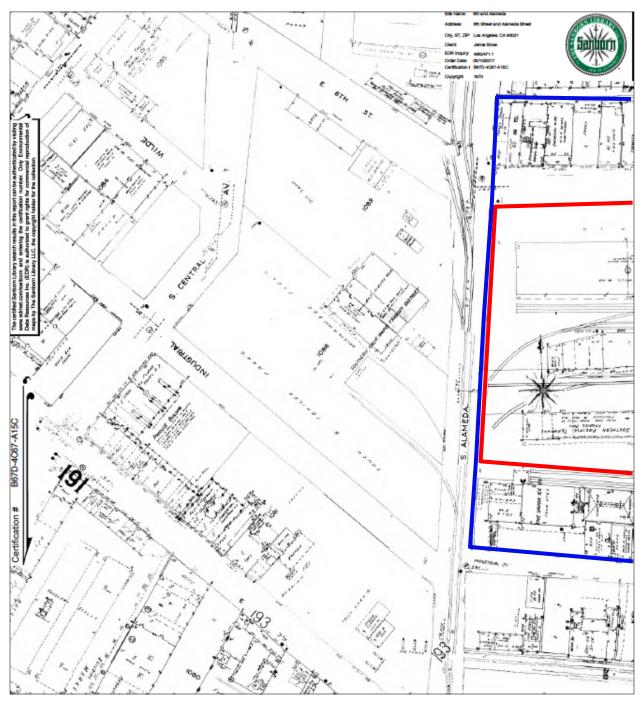

**Map 23:** Sanborn Map showing west portion of study area (outlined in blue) and subject properties (outlined in red), 1970 (Environmental Data Resources, Inc.)

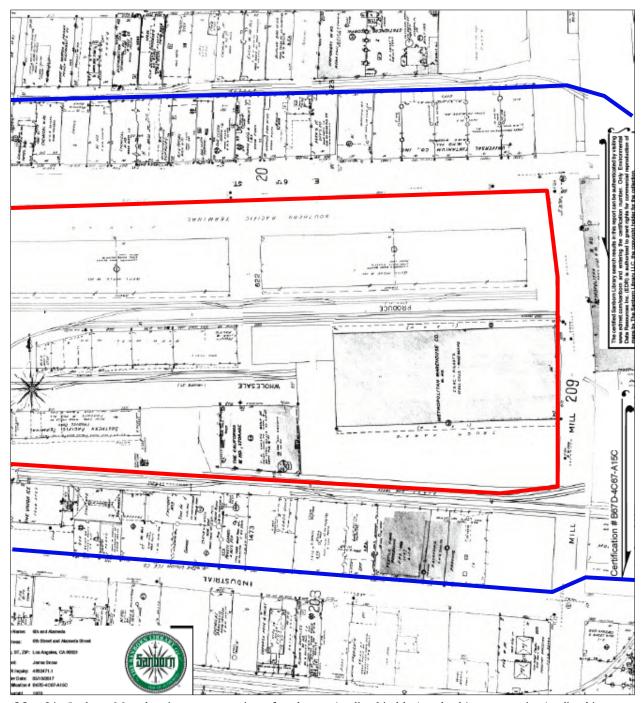

**Map 24:** Sanborn Map showing center portion of study area (outlined in blue) and subject properties (outlined in red), 1970 (Environmental Data Resources, Inc.)

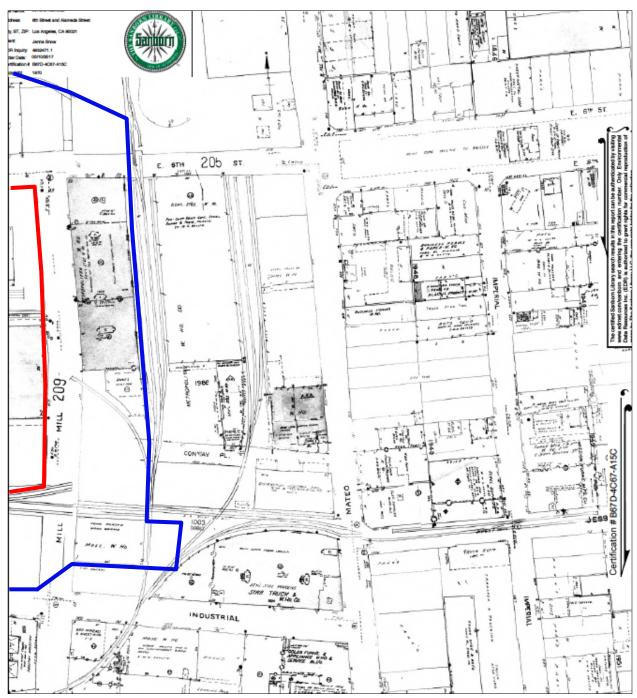

**Map 25:** Sanborn Map showing east portion of study area (outlined in blue) and subject properties (outlined in red), 1970 (Environmental Data Resources, Inc.)



**Figure 1:** Subject property, view southeast from the northwest corner of East 6th and Alameda streets (Snow, 2022)



Figure 2: North buildings, north elevation, view southeast (Snow, 2015)



**Figure 3:** North building, north elevation, detail of individual warehouse entrance, view southwest (Snow, 2015)



Figure 4: North building, east (left) and north (right) elevations, view southwest (Snow, 2022)



Figure 5: North building, east elevation, detail loading dock, view west (Snow, 2015)



Figure 6: North building, south (left) and east (right) elevations, view northwest (Snow, 2022)



Figure 7: North building, west (left) and south (right) elevations, view northeast (Snow, 2022)



Figure 8: North building, west elevation, view southeast (Snow, 2022)



Figure 9: North building, typical warehouse interior, view northeast (Snow, 2015)



Figure 10: North building, typical warehouse interior, view northwest (Snow, 2015)



Figure 11: North building, typical warehouse interior, view northwest (Snow, 2015)



Figure 12: North building, typical warehouse interior, view northwest (Snow, 2015)



Figure 13: North building, typical warehouse interior, view southeast (Snow, 2015)



Figure 14: North building, steel sash windows at west elevation, view west (Snow, 2015)



Figure 15: South building, north elevation, view southeast (Snow, 2015)



Figure 16: South building (left), north building (right), view southwest (Snow, 2022)




**Figure 17:** South building, east elevation (right) and south elevation (left), view northwest (Snow, 2022)



Figure 18: South building, east elevation, view northwest (Snow, 2015)



Figure 19: South building, south elevation, view northeast (Snow, 2015)

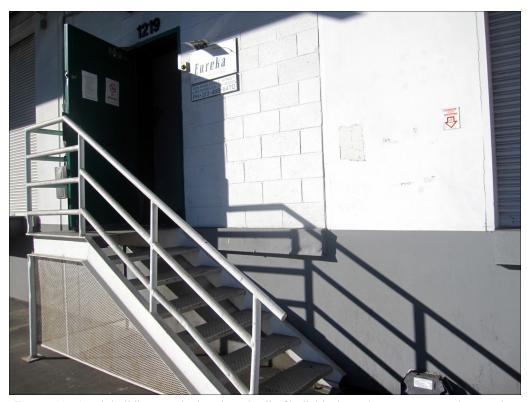

**Figure 20:** South building, south elevation, detail of individual warehouse entrance, view northwest (Snow, 2015)



**Figure 21:** South building, south elevation (right) and west elevation (left), view northeast (Snow, 2022)



Figure 22: South building, typical warehouse interior, view north (Snow, 2015)



Figure 23: South building, typical warehouse interior, view southeast (Snow, 2015)



Figure 24: South building, typical warehouse interior, view northwest (Snow, 2015)



Figure 25: Property C (left), district contributor, view northeast (Snow, 2022)



Figure 26: Property C, district contributor, south façade, view north (Snow, 2022)



Figure 27: Property D, district non-contributor, south façade, view north (Snow, 2022)



Figure 28: Property E, district non-contributor, south façade, view north (Snow, 2022)

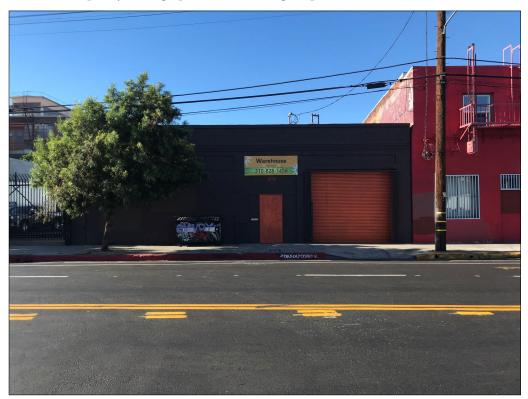


Figure 29: Property F, district contributor, south façade, view north (Snow, 2022)



Figure 30: Property G, district non-contributor, south façade, view northeast (Snow, 2022)



Figure 31: Property H, district non-contributor, south façade, view north (Snow, 2022)



Figure 32: Property I, district contributor, south façade, view north (Snow, 2022)



Figure 33: Property J, district non-contributor, view north (Snow, 2022)



Figure 34: Property K, district contributor, south façade, view north (Snow, 2022)

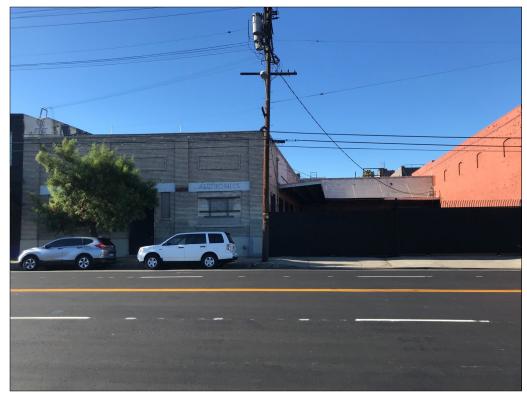


Figure 35: Property L, district contributor, south façade, view north (Snow, 2022)



Figure 36: Property M, district contributor, south façade, view north (Snow, 2022)



Figure 37: Property N, district non-contributor, south façade, view north (Snow, 2022)




Figure 38: Property O, district contributor, south façade, view northeast (Snow, 2022)



**Figure 39:** Property O, district contributor, south façade (left) and east elevation (right), view northwest (Snow, 2022)




**Figure 40:** Properties P and Q, district non-contributor, surface parking lots, view northwest (Snow, 2022)

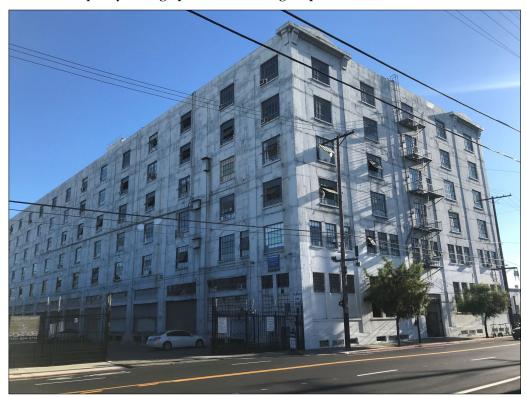

**Figure 41:** Property R, district contributor, north façade (right) and east elevation (left), view southwest (Snow, 2022)



**Figure 42:** Property R (left) and Property S (right), district contributors, from Mill Street, view northeast (Snow, 2022)

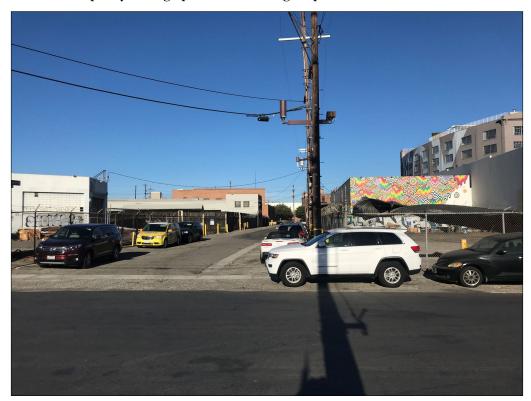

**Figure 43:** Property T, district non-contributor, straddling Conway Place, view northeast from Mill Street (Snow, 2022)



**Figure 44:** Property U, district non-contributor, north elevation (center) and west elevation (right), view southeast (Snow, 2022)



**Figure 45:** Property V, district contributor, rear (north) elevations, from subject property, view southwest (Snow, 2022)



Figure 46: Property V, district contributor, primary (south) facades, from Industrial Street, view northwest (Snow, 2022)



Figure 47: Property V, district contributor, south façade, view northwest (Snow, 2022)



Figure 48: Property V, district contributor, south façade, view north (Snow, 2022)



Figure 49: Property V, district contributor, south façade, view northeast (Snow, 2022)



Figure 50: Property V, district non-contributor, south façade, view northeast (Snow, 2022)



Figure 51: Property V (right), driveway (center), Property W (left), view north (Snow, 2022)



Figure 52: Property W, district non-contributor, view northeast (Snow, 2022)

### Attachment E: Proposed Plans

## EAST END STUDIOS

# Arts District Los Angeles

LOS ANGELES, CA 90021

### PROJECT INFORMATION

ADDRESS: 1206 E 6TH ST. LOS ANGELES, CA 90021

PROJECT SCOPE:

NEW CONSTRUCTION SOUNDSTAGE CAMPUS CONSTRUCTION CONSISTING OF: 2 X [5] STORIES OFFICE STRUCTURES, TYPE III-B ON TYPE I-A PODIUM 16 X [1] STORY SOUND STAGE STUDIO STRUCTURES, TYPE II-B

3 X [1] STORY COVERED OUTDOOR MILLS, TYPE II-B 1 X [6] STORIES PARKING STRUCTURE, TYPE I-A

PROJECT USE:

PARCEL 1:

SOUNDSTAGES WITH ANCILLARY USES (GREEN ROOM, CONFERENCE ROOMS, ETC.) AND INCIDENTAL OFFICES. PROPOSED SOUNDSTAGES ARE FOR THE PURPOSE OF MOTION PICTURE, TELEVISION, AND COMMERCIAL PRODUCTION. ASSEMBLY OF SETS AND FILMING ENVIRONMENTS IN ADJACENT "MILL" WORKSHOPS; CREATIVE WORKPLACE

PROJECT NAME:

EAST END STUDIOS ARTS DISTRICT LOS ANGELES

LEGAL DESCRIPTION:

THE LAND REFERRED TO HEREIN BELOW IS SITUATED IN THE CITY OF LOS ANGELES IN THE COUNTY OF LOS ANGELES. STATE OF CALIFORNIA. AND IS DESCRIBED AS FOLLOWS:

LOT "A" OF TRACT NO. 1182, IN THE CITY OF LOS ANGELES, COUNTY OF LOS ANGELES, STATE OF CALIFORNIA, AS PER MAP RECORDED IN BOOK 17, PAGE 124 OF MAPS, IN THE OFFICE OF THE COUNTY RECORDER OF SAID COUNTY.

RECORDER OF SAID COUNTY.

LOT 1" OF THE INDUSTRIAL TRACT, IN THE CITY OF LOS ANGELES, COUNTY OF LOS ANGELES, STATE OF CALIFORNIA, AS PER MAP RECORDED IN BOOK 5, PAGE 56 OF MAPS, IN THE OFFICE OF THE COUNTY

PARCEL 3: THAT PORTION OF CITY OF LANDS OF LOS ANGELES, AS PER MAP RECORDED IN BOOK 2, PAGES 504 AND 505 OF MISCELLANEOUS RECORDS, IN THE OFFICE OF THE COUNTY RECORDER OF LOS ANGELES COUNTY, BOUNDED AND DESCRIBED AS FOLLOWS:

BEGINNING AT A POINT IN THE EAST LINE OF ALAMEDA STREET WHERE THE SAME IS INTERSECTED BY THE SOUTH LINE OF 6D FOOT STRIP OF LAND CONVEYED BY CAROLINE SHAFER, TO THE CITY OF LOS ANGELES FOR SIXTH STREET,

BY DEED RECORDED IN BOOK 2110, PAGE 131 OF DEEDS; THENCE ALONG THE SOUTH LINE OF SIXTH STREET, NORTH 88"35'30" EAST TO THE WEST LINE OF MILL STREET, AS SHOWN ON MAP OF THE INDUSTRIAL TRACT, IN THE CITY OF LOS ANGELES, COUNTY OF LOS ANGELES, STATE OF CALIFORNIA, RECORDED IN BOOK 5, PAGE 56 OF MAPS; THENCE ALONG THE WEST LINE OF MILIL STREET, SOUTH 04"52' EAST 336 FEET, MORE OR LESS, TO THE NORTHEAST CORNER OF LOT 1' OF SAID INDUSTRIAL TRACT: THENCE WESTERLY ALONG THE NORTHERLY LINE OF SAID LOT 1" AND ALONG THE DIVIDING LINE BETWEEN THE LANDS OF ALICE SHAFER AND CAROLINE SHAFER, AS PARTITIONED BETWEEN THEM, BY DEED RECORDED IN BOOK 755, PAGE 57 OF DEEDS, 1177 FEET, MORE OR LESS, TO A POINT IN THE EASTERLY LINE OF ALAMEDA STREET: THENCE NORTHERLY ALONG SAID STREET LINE TO THE POINT OF BEGINNING, EXCEPTING FROM PARCELS 1, 2 AND 3 ABOVE, ALL OIL, MINERAL, GAS AND OTHER HYDROCARBON SUBSTANCES BELOW A DEPTH OF 500 FEET UNDER THE SURFACE OF THE LAND. BUT WITHOUT THE RIGHT OF SURFACE ENTRY OR ANY OTHER USE OF THE LAND ABOVE SUCH 500 FOOT DEPTH, AS RESERVED BY SOUTHERN PACIFIC TRANSPORTATION COMPANY, IN DEED RECORDED OCTOBER 12, 1988 AS INSTRUMENT NO, 88-1634144 OF OFFICIAL RECORDS,

APN: 5164-010-003 (PORTION OF PARCEL 3): 5164-D10-004 (PORTION OF PARCELS 1 AND 3); 5164-010-005 (PARCEL 2 AND PORTION OF PARCELS 1 AND 3)

**ZONE DISTRICT:** 

M3-1-RIO: HEAVY INDUSTRIAL ZONE, WITHIN A HEIGHT 1 DISTRICT AND WITHIN THE RIVER IMPROVEMENT OVERLAY DISTRICT East Los Angeles Enterprise Zone (State) Transit Oriented Communities (TOC) Tier 3 Designated "Opportunity Zone"

LOT ACREAGE 635,551 SF (14.59 ACRES) PER LOS ANGELES COUNTY ASSESSOR

PROPOSED TOTAL BUILDING FLOOR AREA

ALLOWABLE FAR: 1.5

675.611 SF

ALLOWABLE HEIGHT PER LOS ANGELES ZONING CODE: HEIGHT DISTRICT 1, UNLIMITED

REQUIRED SETBACKS:

- FRONT YARD = 0' (10' AT CORNER OF INTERSECTION) - REAR YARD = 0'

- SIDE YARDS = 0'

TYPE OF CONSTRUCTION: TYPE I-A: PODIUM, PARKING STRUCTURE, COVERED OUTDOOR MILL TYPE II-B: STAGES, COVERED OUTDOOR MILL

TYPE III-B: OFFICES

OCCUPANCY:

F-1: MOTION PICTURE AND TELEVISION PRODUCTION STUDIO SOUNDSTAGES B: SMALL ASSEMBLY SPACES & OFFICES

S-2: PARKING A-3: FOOD AND DRINK CONSUMPTION ASSEMBLY

LIFE SAFETY:

FULLY SPRINKLERED - FIRE SPRINKLER SYSTEM NFPA 13 PER CBC 903.3.1.1, 410.6, AND 410.7.

APPLICABLE CODES

2022 CALIFORNIA BUILDING CODE (CBC) 2022 CBC ACCESSIBILITY CODE (CBC-11B)

2022 CALIFORNIA ELECTRICAL CODE (CEC)

2022 CALIFORNIA ENERGY CODE (CEnC) 2022 CALIFORNIA MECHANICAL CODE (CMC)

2022 CALIFORNIA PLUMBING CODE (CPC)

2022 CALIFORNIA GREEN BUILDING CODE (CAL GREEN) 2022 CALIFORNIA FIRE CODE (CFC)

ALL CURRENT LOS ANGELES MUNICIPAL CODES AND LOCAL ORDINANCES (L.A.M.C.)



**DEFERRED PERMITS:** DESIGN/BUILD ENGINEERING SYSTEMS WILL BE DEFERRED PERMIT SUBMITTALS AND SHALL BE SUBMITTED BY THE SUBCONTRACTOR TO THE AUTHORITY HAVING JURISDICTION. THESE ITEMS INCLUDE, BUT ARE NOT LIMITED TO THE FOLLOWING:

- FIRE SPRINKLER SYSTEM - FIRE ALARM SYSTEM

- ELEVATOR SYSTEM - SOLAR PHOTOVOLTAIC SYSTEM

- STEEL STAIRS

- HANDRAILS & GUARDRAILS ANCHORS - STOREFRONT SYSTEM

### **BUILDING AREA & PROGRAM**

Building	Area in S	F Type	Use	Height	Stories
		ype		neight	
BUILDING #1					
COVERED DROP-OFF A	5,869 SF	I-A	INDUSTRIAL		
COVERED OUTDOOR MILL	8,045 SF	I-A	INDUSTRIAL		
MILL A	10,446 SF	I-A	INDUSTRIAL		
OFFICE A	153,561 SF	III-B	BUSINESS		
Building Total	177,921 SF	III-D	DOSINESS	74'	5 Stories w/ I-A Podium
Danaing Total	111,821 35			1-1	O Otorios W/ I-A I-UdiuIII
BUILDING #2					
STUDIO 1	18,018 SF	II-B	INDUSTRIAL		
STUDIO 2	18,109 SF	II-B	INDUSTRIAL		
STUDIO 3	18,018 SF	II-B	INDUSTRIAL		
Building Total	54,145 SF	II-D	INDUSTRIAL	53'	1 Story
Building Total	54, 145 SF			33	1 Story
DUIL DING #2					
BUILDING #3	E 007 0E	шъ	INDUIGEDIAL		
BOH	5,027 SF	II-B	INDUSTRIAL		
COVERED OUTDOOR MILL	2,950 SF	II-B	INDUSTRIAL	001	4.04
Building Total	7,977 SF			20'	1 Story
BUILDING #4					
STUDIO 4	18,018 SF	II-B	INDUSTRIAL		
STUDIO 5	18,109 SF	II-B	INDUSTRIAL		
STUDIO 6	18,018 SF	II-B	INDUSTRIAL		
Building Total	54,145 SF			53'	1 Story
BUILDING #5					
COVERED DROP-OFF B	3,878 SF	I-A	INDUSTRIAL		
COVERED OUTDOOR MILL	8,075 SF	I-A	INDUSTRIAL		
MILL B	8,795 SF	I-A	INDUSTRIAL		
OFFICE B	144,099 SF	III-B	BUSINESS		
Building Total	164,847 SF			74'	5 Stories w/ I-A Podium
BUILDING #6					
PARKING STRUCTURE	0 SF				
Building Total	415 STALLS			53'	5 Stories
<b>o</b>					
BUILDING #7					
COVERED OUTDOOR MILL	7,973 SF	I-A	INDUSTRIAL		
STUDIO 7	16,038 SF	II-B	INDUSTRIAL		
STUDIO 8	16,038 SF	II-B	INDUSTRIAL		
Building Total	40,049 SF	II D	111200111111112	53'	1 Story
Danian ig Total	10,010 01				, otory
BUILDING #8					
STUDIO 9	17,127 SF	II-B	INDUSTRIAL		
STUDIO 9 STUDIO 10	17,127 SF	II-B	INDUSTRIAL		
	34,254 SF	II-D	INDUSTRIAL	53'	1 Ctom
Building Total	34,234 SF			33	1 Story
DI III DINIC #0					
BUILDING #9	2 204 05	шр	INDUCTOR		
BOH	3,361 SF	II-B	INDUSTRIAL		
COVERED OUTDOOR MILL	4,360 SF	II-B	INDUSTRIAL	001	4.04
Building Total	7,721 SF			20'	1 Story
BUILDING #10	1	lu e	Table 1.1.		
STUDIO 11	27,942 SF	II-B	INDUSTRIAL		
				1	
STUDIO 12	27,942 SF	II-B	INDUSTRIAL		
STUDIO 12 Building Total	27,942 SF 55,884 SF	II-B	INDUSTRIAL	57'	1 Story
Building Total	,	II-B	INDUSTRIAL	57'	1 Story
	,	II-B	INDUSTRIAL	57'	1 Story
Building Total	,	II-B	INDUSTRIAL	57'	1 Story
Building Total BUILDING #11	55,884 SF			57'	1 Story
Building Total  BUILDING #11  BOH	55,884 SF 4,733 SF	II-B	INDUSTRIAL	57'	1 Story  1 Story
Building Total  BUILDING #11  BOH  COVERED OUTDOOR MILL	55,884 SF 4,733 SF 5,427 SF	II-B	INDUSTRIAL		,
Building Total  BUILDING #11  BOH  COVERED OUTDOOR MILL	55,884 SF 4,733 SF 5,427 SF	II-B	INDUSTRIAL		,
Building Total  BUILDING #11  BOH  COVERED OUTDOOR MILL  Building Total  BUILDING #12	55,884 SF 4,733 SF 5,427 SF 10,160 SF	II-B II-B	INDUSTRIAL INDUSTRIAL		,
Building Total  BUILDING #11  BOH  COVERED OUTDOOR MILL  Building Total  BUILDING #12  STUDIO 13	55,884 SF 4,733 SF 5,427 SF 10,160 SF	II-B II-B	INDUSTRIAL INDUSTRIAL INDUSTRIAL		,
Building Total  BUILDING #11  BOH  COVERED OUTDOOR MILL  Building Total  BUILDING #12  STUDIO 13  STUDIO 14	55,884 SF  4,733 SF  5,427 SF  10,160 SF  17,127 SF  17,127 SF	II-B II-B	INDUSTRIAL INDUSTRIAL	20'	1 Story
Building Total  BUILDING #11  BOH  COVERED OUTDOOR MILL  Building Total  BUILDING #12  STUDIO 13	55,884 SF 4,733 SF 5,427 SF 10,160 SF	II-B II-B	INDUSTRIAL INDUSTRIAL INDUSTRIAL		,
Building Total  BUILDING #11  BOH  COVERED OUTDOOR MILL  Building Total  BUILDING #12  STUDIO 13  STUDIO 14  Building Total	55,884 SF  4,733 SF  5,427 SF  10,160 SF  17,127 SF  17,127 SF	II-B II-B	INDUSTRIAL INDUSTRIAL INDUSTRIAL	20'	1 Story
Building Total  BUILDING #11  BOH  COVERED OUTDOOR MILL  Building Total  BUILDING #12  STUDIO 13  STUDIO 14  Building Total  BUILDING #13	55,884 SF  4,733 SF  5,427 SF  10,160 SF  17,127 SF  17,127 SF  34,254 SF	II-B II-B II-B	INDUSTRIAL INDUSTRIAL INDUSTRIAL INDUSTRIAL	20'	1 Story
Building Total  BUILDING #11  BOH  COVERED OUTDOOR MILL  Building Total  BUILDING #12  STUDIO 13  STUDIO 14  Building Total  BUILDING #13  STUDIO 15	55,884 SF  4,733 SF 5,427 SF 10,160 SF  17,127 SF 17,127 SF 34,254 SF	II-B II-B II-B	INDUSTRIAL INDUSTRIAL INDUSTRIAL INDUSTRIAL	20'	1 Story
Building Total  BUILDING #11  BOH  COVERED OUTDOOR MILL  Building Total  BUILDING #12  STUDIO 13  STUDIO 14  Building Total  BUILDING #13  STUDIO 15  STUDIO 16	55,884 SF  4,733 SF 5,427 SF 10,160 SF  17,127 SF 17,127 SF 34,254 SF  17,127 SF 17,127 SF	II-B II-B II-B	INDUSTRIAL INDUSTRIAL INDUSTRIAL INDUSTRIAL	20'	1 Story  1 Story
Building Total  BUILDING #11  BOH  COVERED OUTDOOR MILL  Building Total  BUILDING #12  STUDIO 13  STUDIO 14  Building Total  BUILDING #13  STUDIO 15	55,884 SF  4,733 SF 5,427 SF 10,160 SF  17,127 SF 17,127 SF 34,254 SF	II-B II-B II-B	INDUSTRIAL INDUSTRIAL INDUSTRIAL INDUSTRIAL	20'	1 Story

Name	Area
OFFICE	
OFFICE	TE 000 0E
COVERED DROP-OFF A	5,869 SF
COVERED DROP-OFF B	3,878 SF
OFFICE A	153,561 SF
OFFICE B	144,099 SF
	307,407 SF
STUDIO	T
STUDIO 1	18,018 SF
STUDIO 2	18,109 SF
STUDIO 3	18,018 SF
STUDIO 4	18,018 SF
STUDIO 5	18,109 SF
STUDIO 6	18,018 SF
STUDIO 7	16,038 SF
STUDIO 8	16,038 SF
STUDIO 9	17,127 SF
STUDIO 10	17,127 SF
STUDIO 11	27,942 SF
STUDIO 12	27,942 SF
STUDIO 13	17,127 SF
STUDIO 14	17,127 SF
STUDIO 15	17,127 SF
STUDIO 16	17,127 SF
	299,012 SF
SUPPORT	
вон	13,121 SF
COVERED OUTDOOR MILL	36,830 SF
MILL A	10,446 SF
MILL B	8,795 SF
	69,192 SF
0 11 1 1	075 044 05

675,611 SF

Area by Building Type

# SHEET LIST

A00-1001	COVER SHEET - ENTITLEMENT
A00-1010	PLOT PLAN
A01 Eviating	Canditions / Domalitions
A01 - Existing	Conditions / Demolitions ZONING INFORMATION AND SITE SURVEY
A01-1002	RENDERINGS 1 OF 3
A01-1003	RENDERINGS 2 OF 3 RENDERINGS 3 OF 3
A01-1004	SITE PHOTOS
A01-1007	SITE PROTOS
A02 - Genera	l Site Plans
A02-1001	GROUND LEVEL
A02-1002	OFFICE LEVEL 2 / AMENITY LEVEL
A02-1003	OFFICE LEVEL 3 / SUPPORT LEVEL
A02-1016	ROOFTOP LEVEL
A03 - GA Floo	or Plans
A03-1001	STUDIOS 1-3
A03-1002	STUDIOS 4-6
A03-1003	STUDIOS 7-10
A03-1004	STUDIOS 11-14
A03-1005	STUDIOS 15 & 16
A03-1020	OFFICE BUILDING - ALAMEDA
A03-1021	OFFICE BUILDING - ALAMEDA
A03-1022	OFFICE BUILDING - MILL
A03-1023	OFFICE BUILDING - MILL
A03-1030	PARKING STRUCTURE
A03-1031	PARKING STRUCTURE
A03-1032	PARKING STRUCTURE
400 OA El-	
A06 - GA Elev A06-1001	SOUTH ELEVATIONS
	3 3 3 3 3 3 4 3 4 3 4 3 4 3 4 3 4 3 4 3
A06-1002 A06-1003	6TH STREET ELEVATIONS
AU6-1003	MILL AND ALAMEDA STREET ELEVATIONS
A07 - GA Sec	tions
A07-1001	SITE SECTIONS
A07-1002	TYPICAL STUDIO BUILDING SECTIONS
A07-1003	TYPICAL OFFICE BUILDING SECTIONS
Civil Sheets	
CG-101	CONCEPTUAL GRADING PLAN
CS-101	CONCEPTUAL LID PLAN
1 1	
Landscape St	
L-001	OPEN SPACE CALCULATIONS
L-002	TREE DISPOSITION PLAN
L-101	CONCEPTUAL LANDSCAPE PLAN - L1 GROUND FLOOR
L-102	CONCEPTUAL LANDSCAPE PLAN - L2 AMENITY DECK
L-103	CONCEPTUAL LANDSCAPE PLAN - ROOF LEVEL
L-104	PLANT PALETTE
	SITE ELEVATIONS
L-105 L-106	SITE ELEVATIONS

# PROJECT CONTACTS

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CIVIL: LANGAN STRUCTURAL: HOLMES FIRE, LIFE & SAFETY: HOLMES MECHANICAL, ELECTRICAL & PLUMBING: MEYERS+ ENGINEERS LANDSCAPE ARCHITECT: STUDIO MLA SOIL ENGINEER: LANGAN



VICINITY PLAN

**East End Studios** 

PROJECT NO.

**Arts District Los Angeles** 

**ALAMEDA** STUDIOS OWNER,

CONSULTANTS

1206 East 6th Street

Los Angeles, CA

REV BY DATE DESCRIPTION

**COVER SHEET - ENTITLEMENT** 

GRM GRM GRM 05/12/23 DRAWING NO. A00-1001

DRW CH APPR DRW DATE REV

1/64" = 1'-0"


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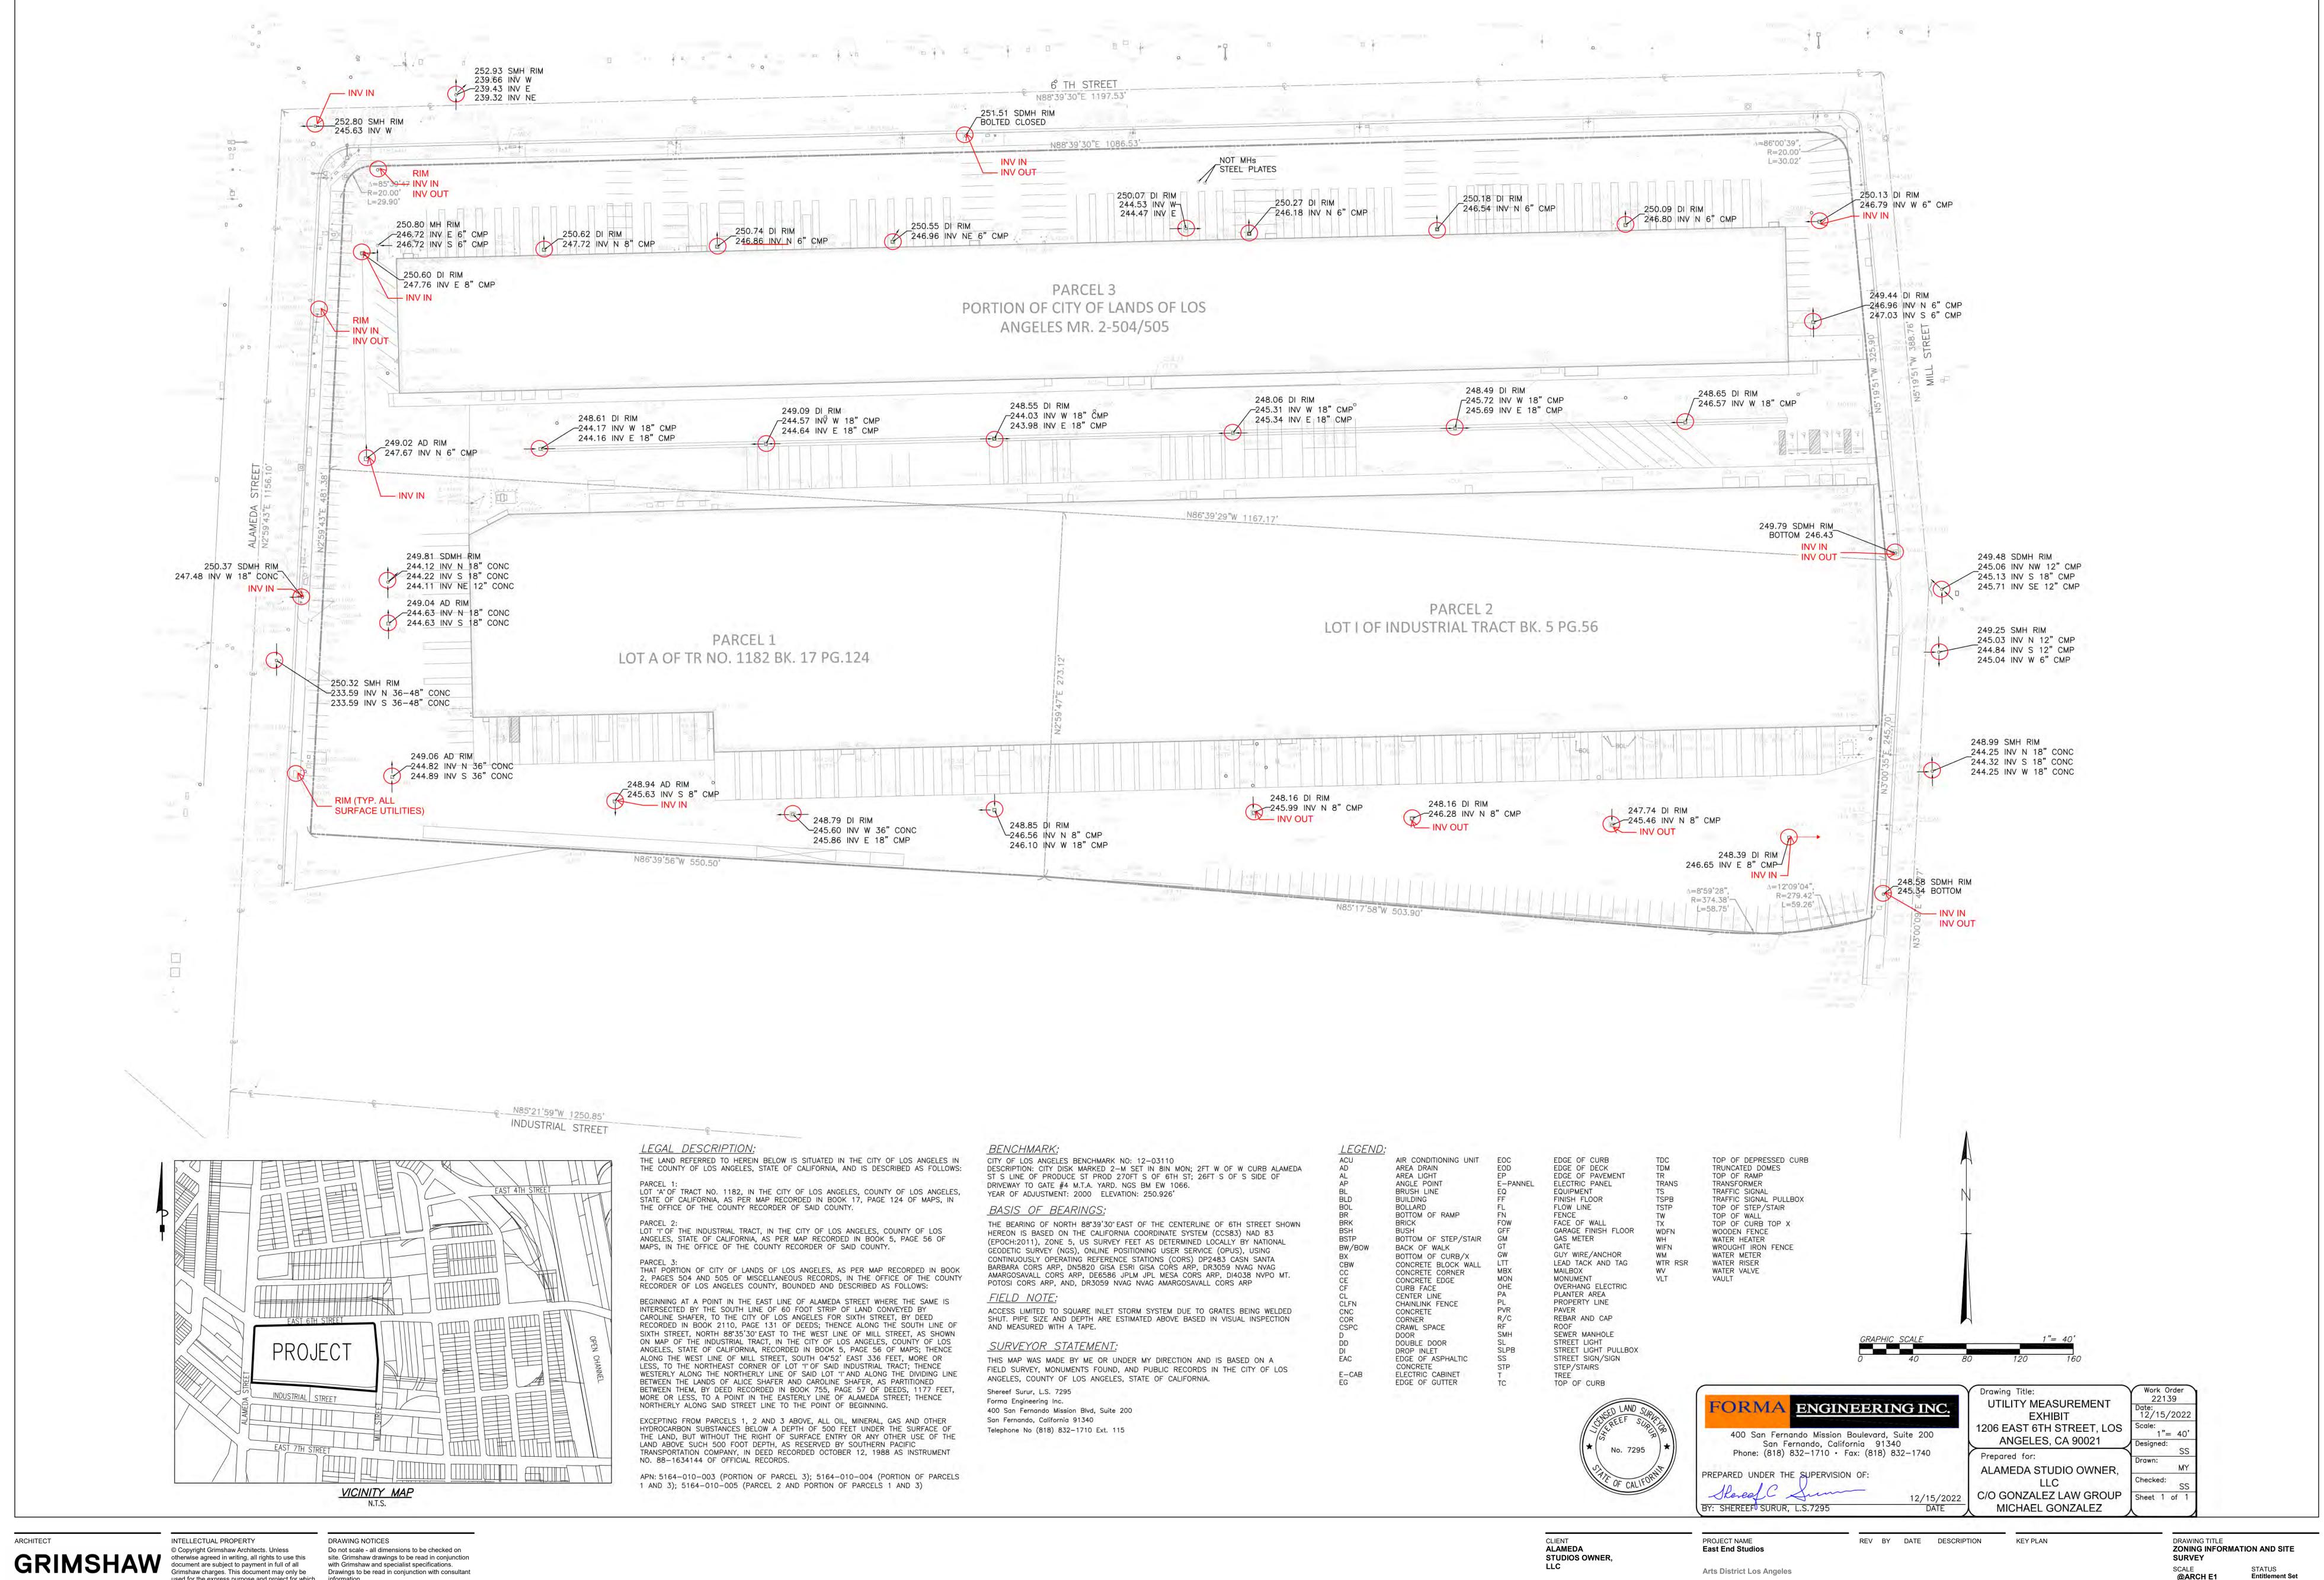
ADDRESS 1206 East 6th Street

Los Angeles, CA

PROJECT NO.

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1" = 40'-0" @ARCH E1 DRW CH APPR DRW DATE REV GRM GRM GRM 05/12/23

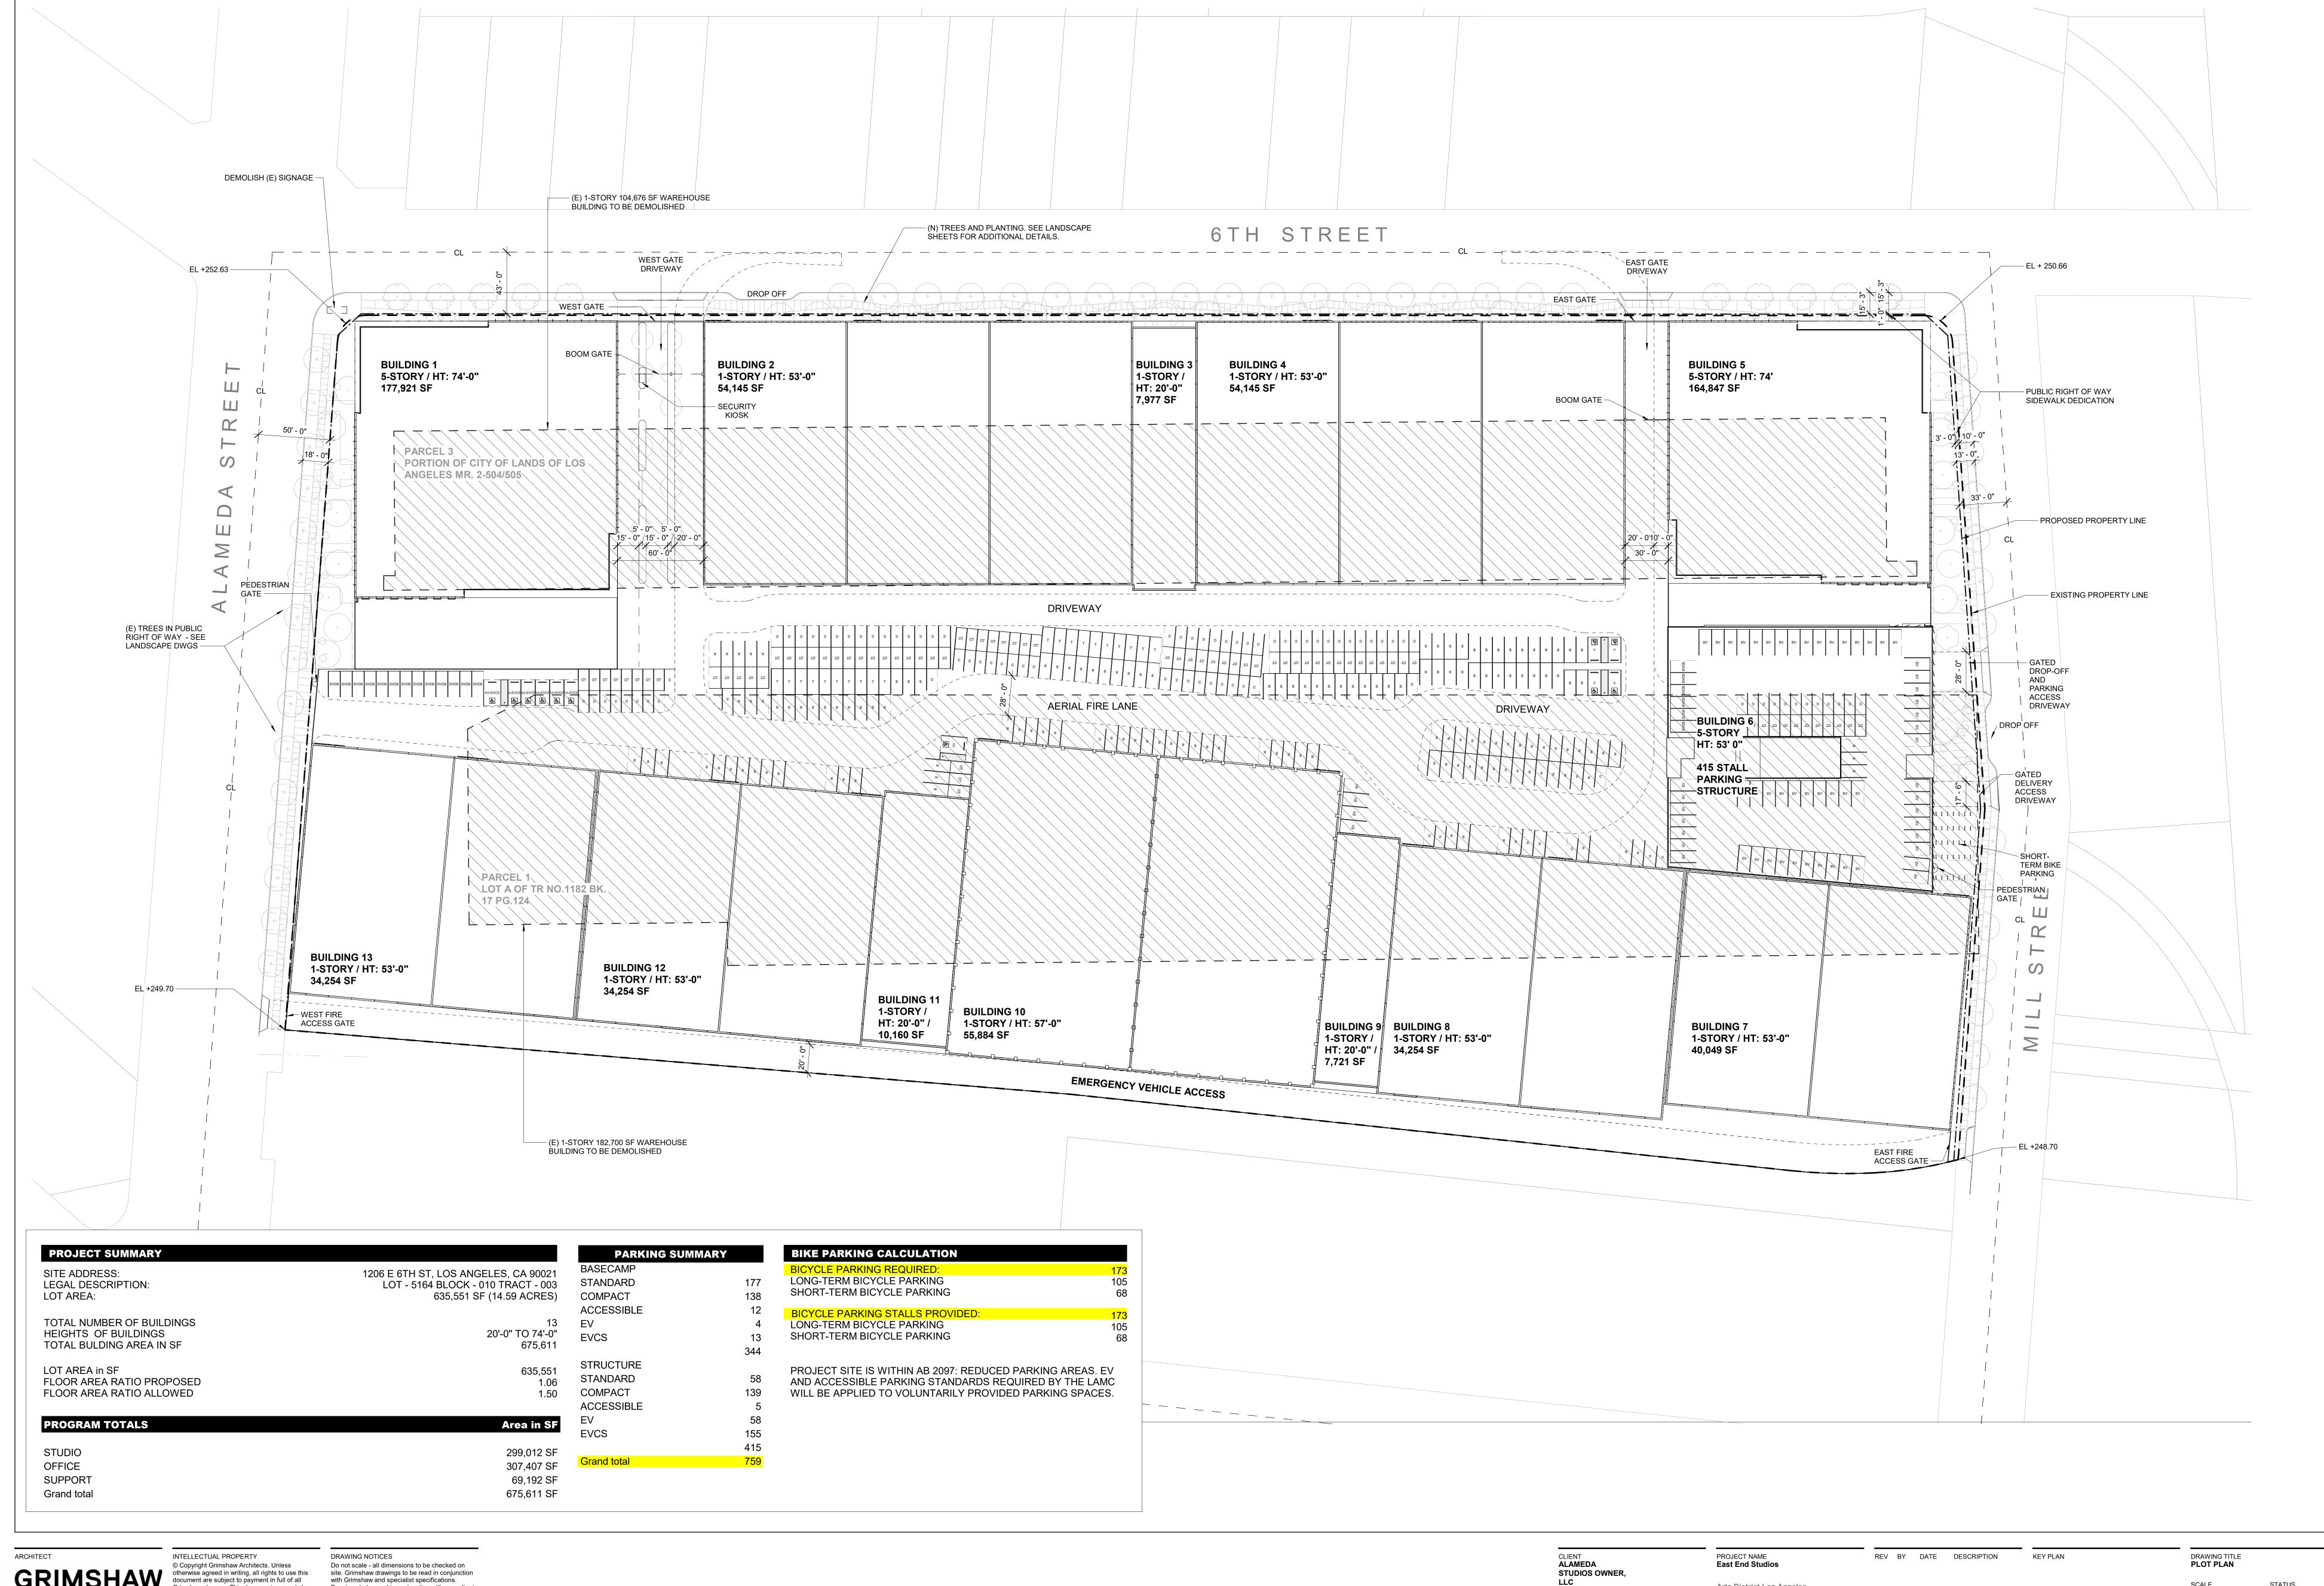

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PROJECT NAME
East End Studios **Arts District Los Angeles** 

PROJECT NO. **22043** 

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REV BY DATE DESCRIPTION

DRAWING TITLE
RENDERINGS 1 OF 3 SCALE **@ARCH E1** 

> DRW CH APPR DRW DATE REV GRM GRM GRM 05/12/23 DRAWING NO. **A01-1002**



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REV BY DATE DESCRIPTION KEY PLAN

DRAWING TITLE
RENDERINGS 2 OF 3

SCALE **@ARCH E1** DRW CH APPR DRW DATE REV GRM GRM GRM 05/12/23



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PROJECT NAME **East End Studios Arts District Los Angeles** 

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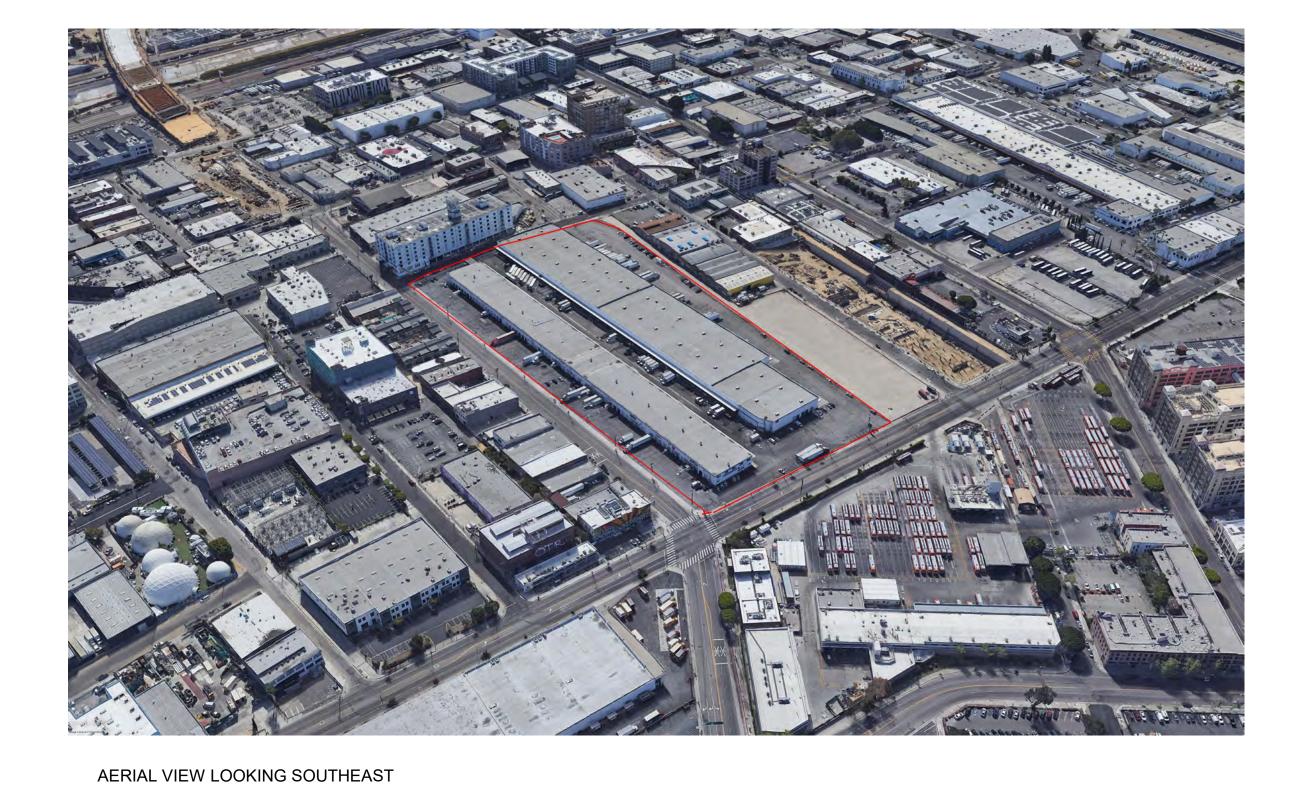
Los Angeles, CA

PROJECT NO. **22043** 

REV BY DATE DESCRIPTION

DRAWING TITLE
RENDERINGS 3 OF 3 **KEY PLAN** 


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> GRM GRM GRM 05/12/23









STREET VIEW OF 6TH AND ALAMEDA STREET VIEW ALONG ALAMEDA

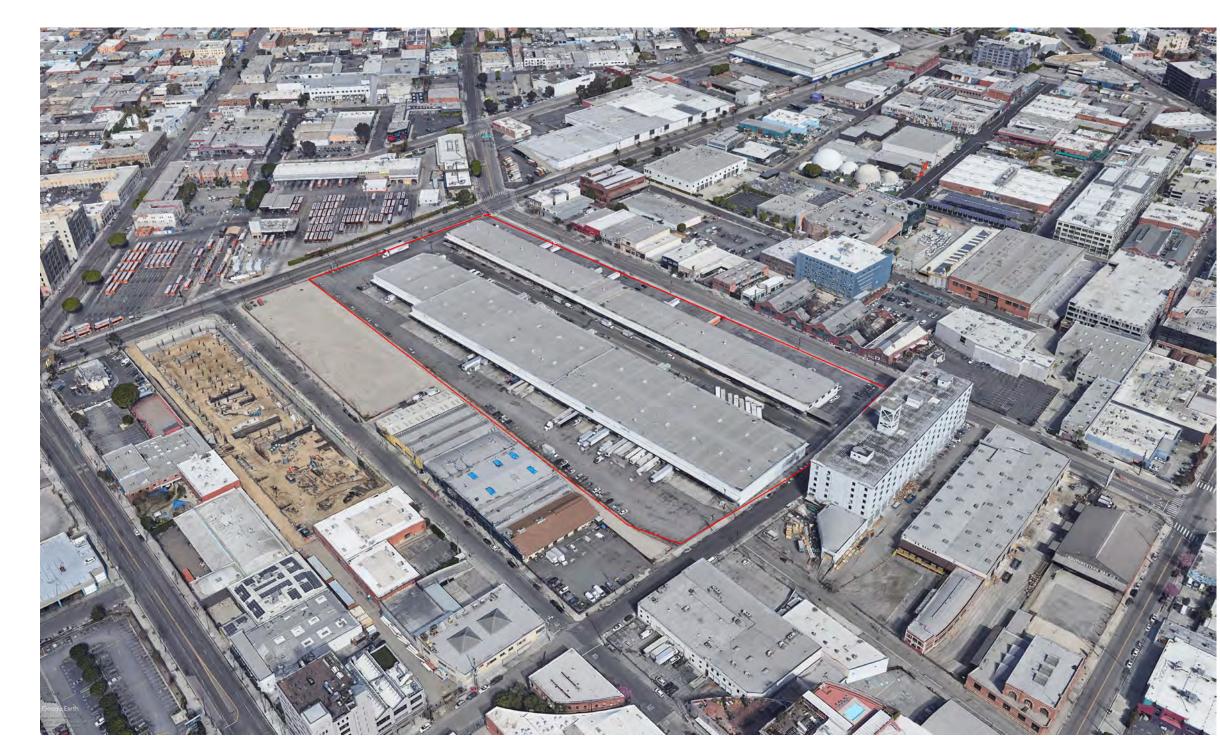

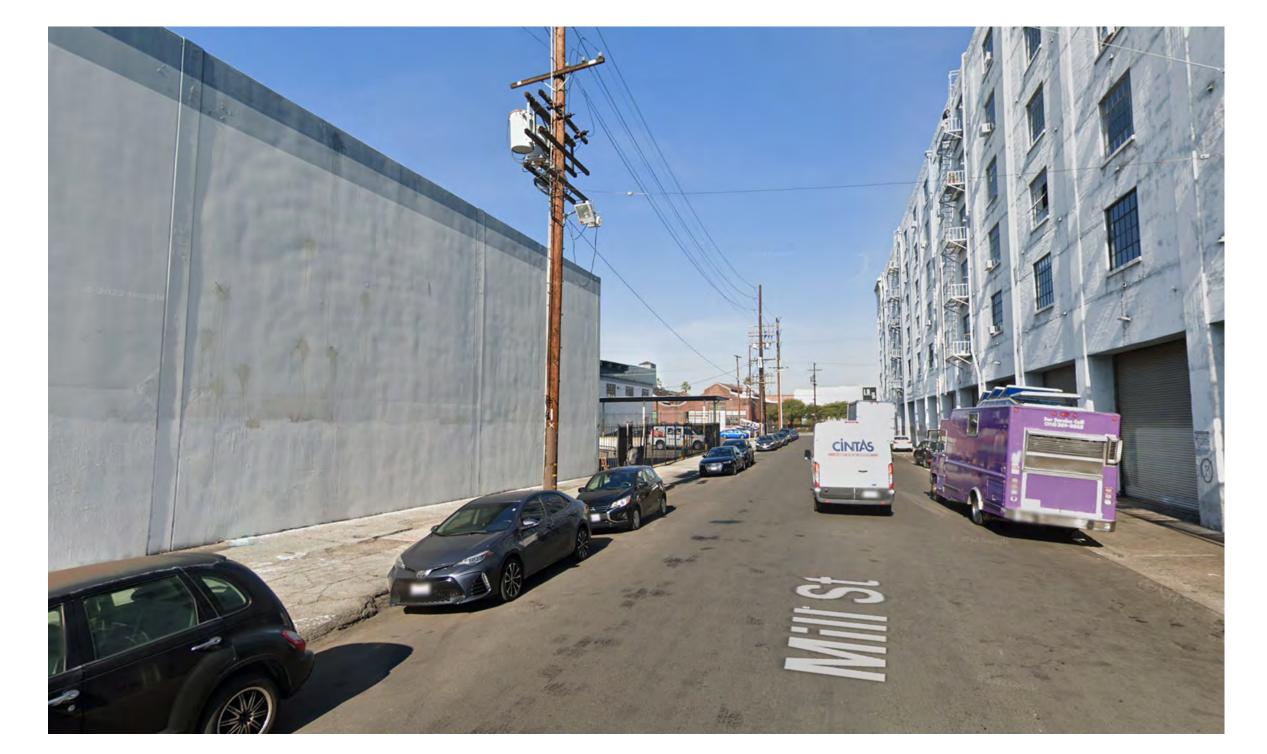

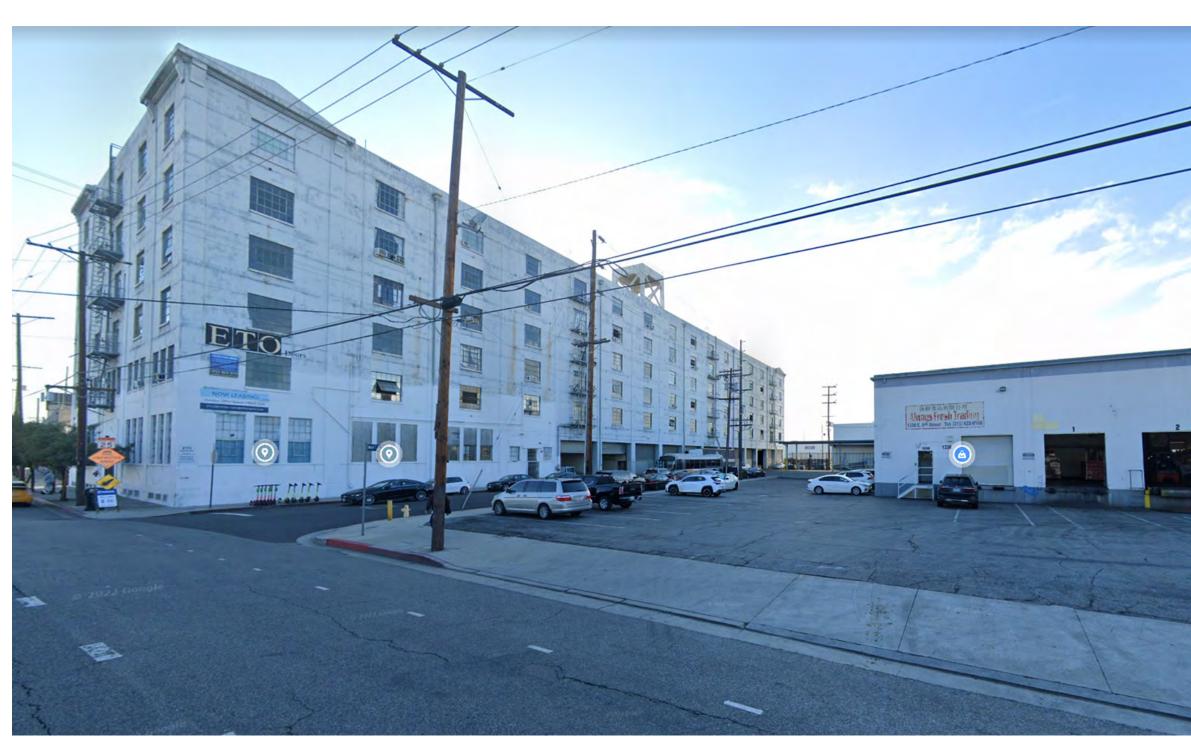

AERIAL VIEW LOOKING NORTHWEST STREET VIEW ALONG MILL AERIAL VIEW LOOKING NORTHWEST

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PROJECT NAME
East End Studios **Arts District Los Angeles** 

PROJECT NO. **22043** 

ADDRESS 1206 East 6th Street Los Angeles, CA 90021

REV BY DATE DESCRIPTION KEY PLAN

DRAWING TITLE SITE PHOTOS

SCALE **@ARCH E1** DRW CH APPR DRW DATE REV GRM GRM GRM 05/12/23



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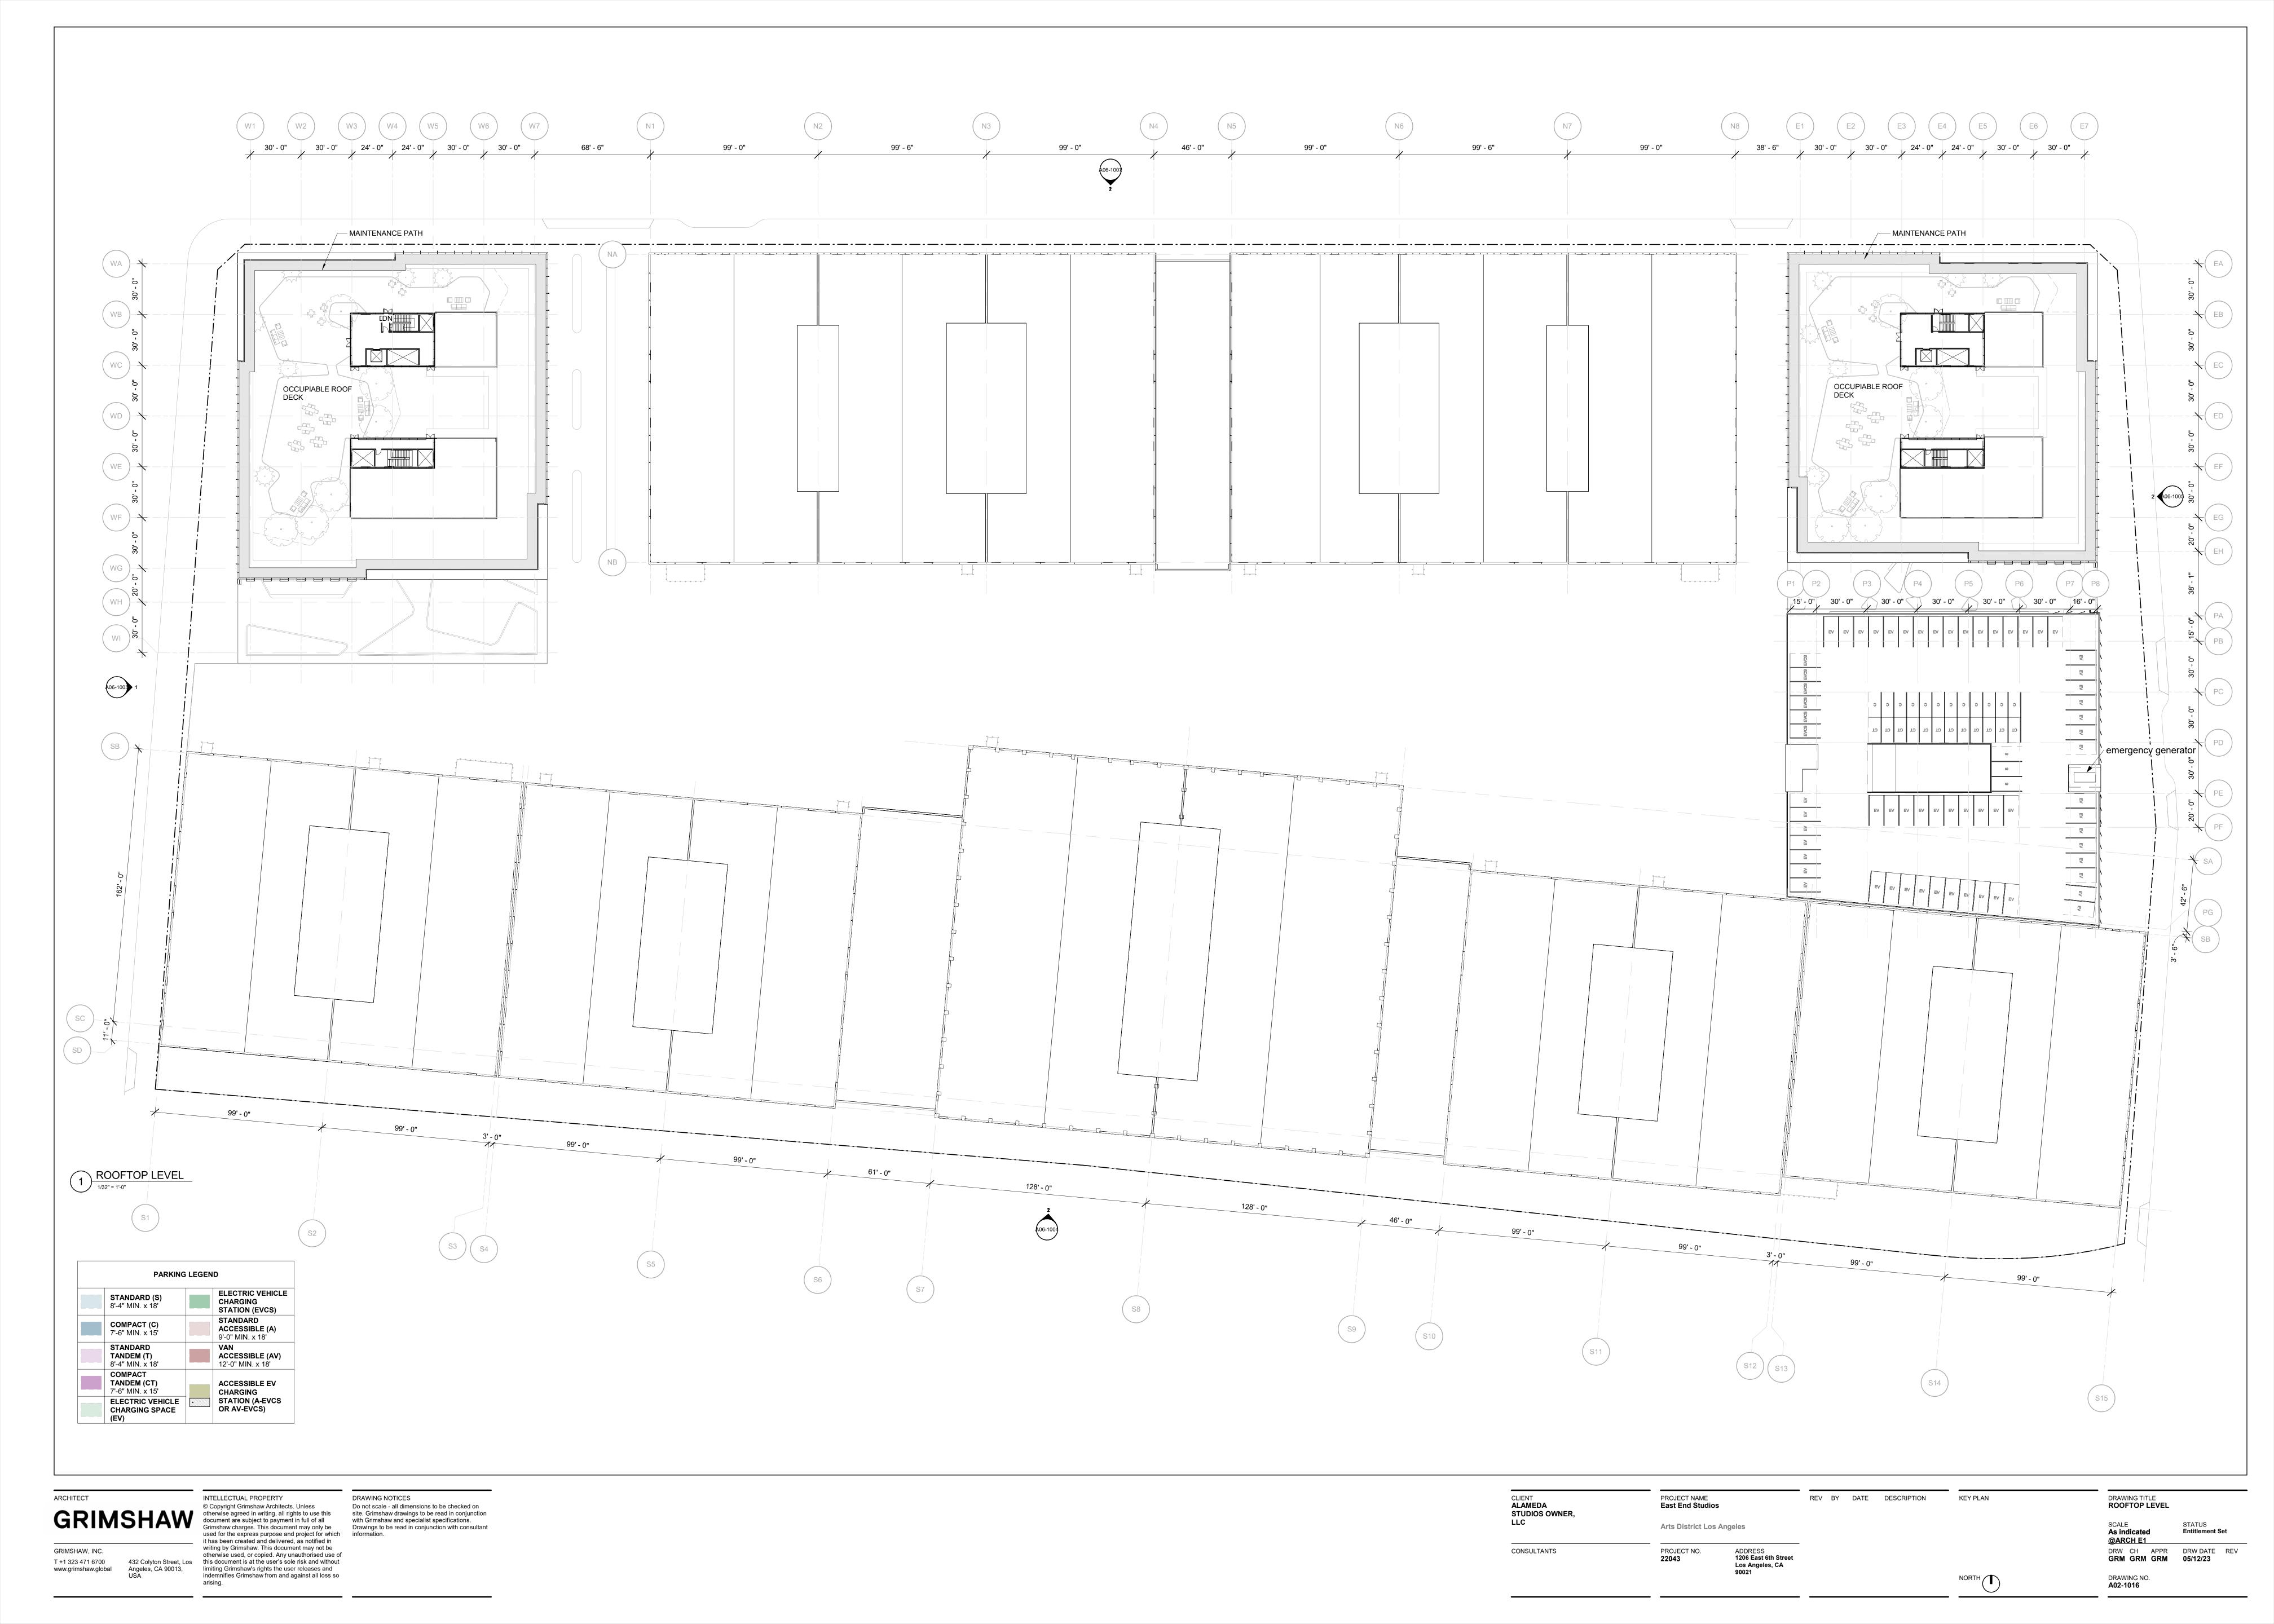
ADDRESS 1206 East 6th Street


Los Angeles, CA

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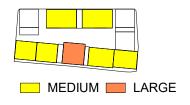




STUDIOS 1-3 GROUND LEVEL

1/16" = 1'-0"

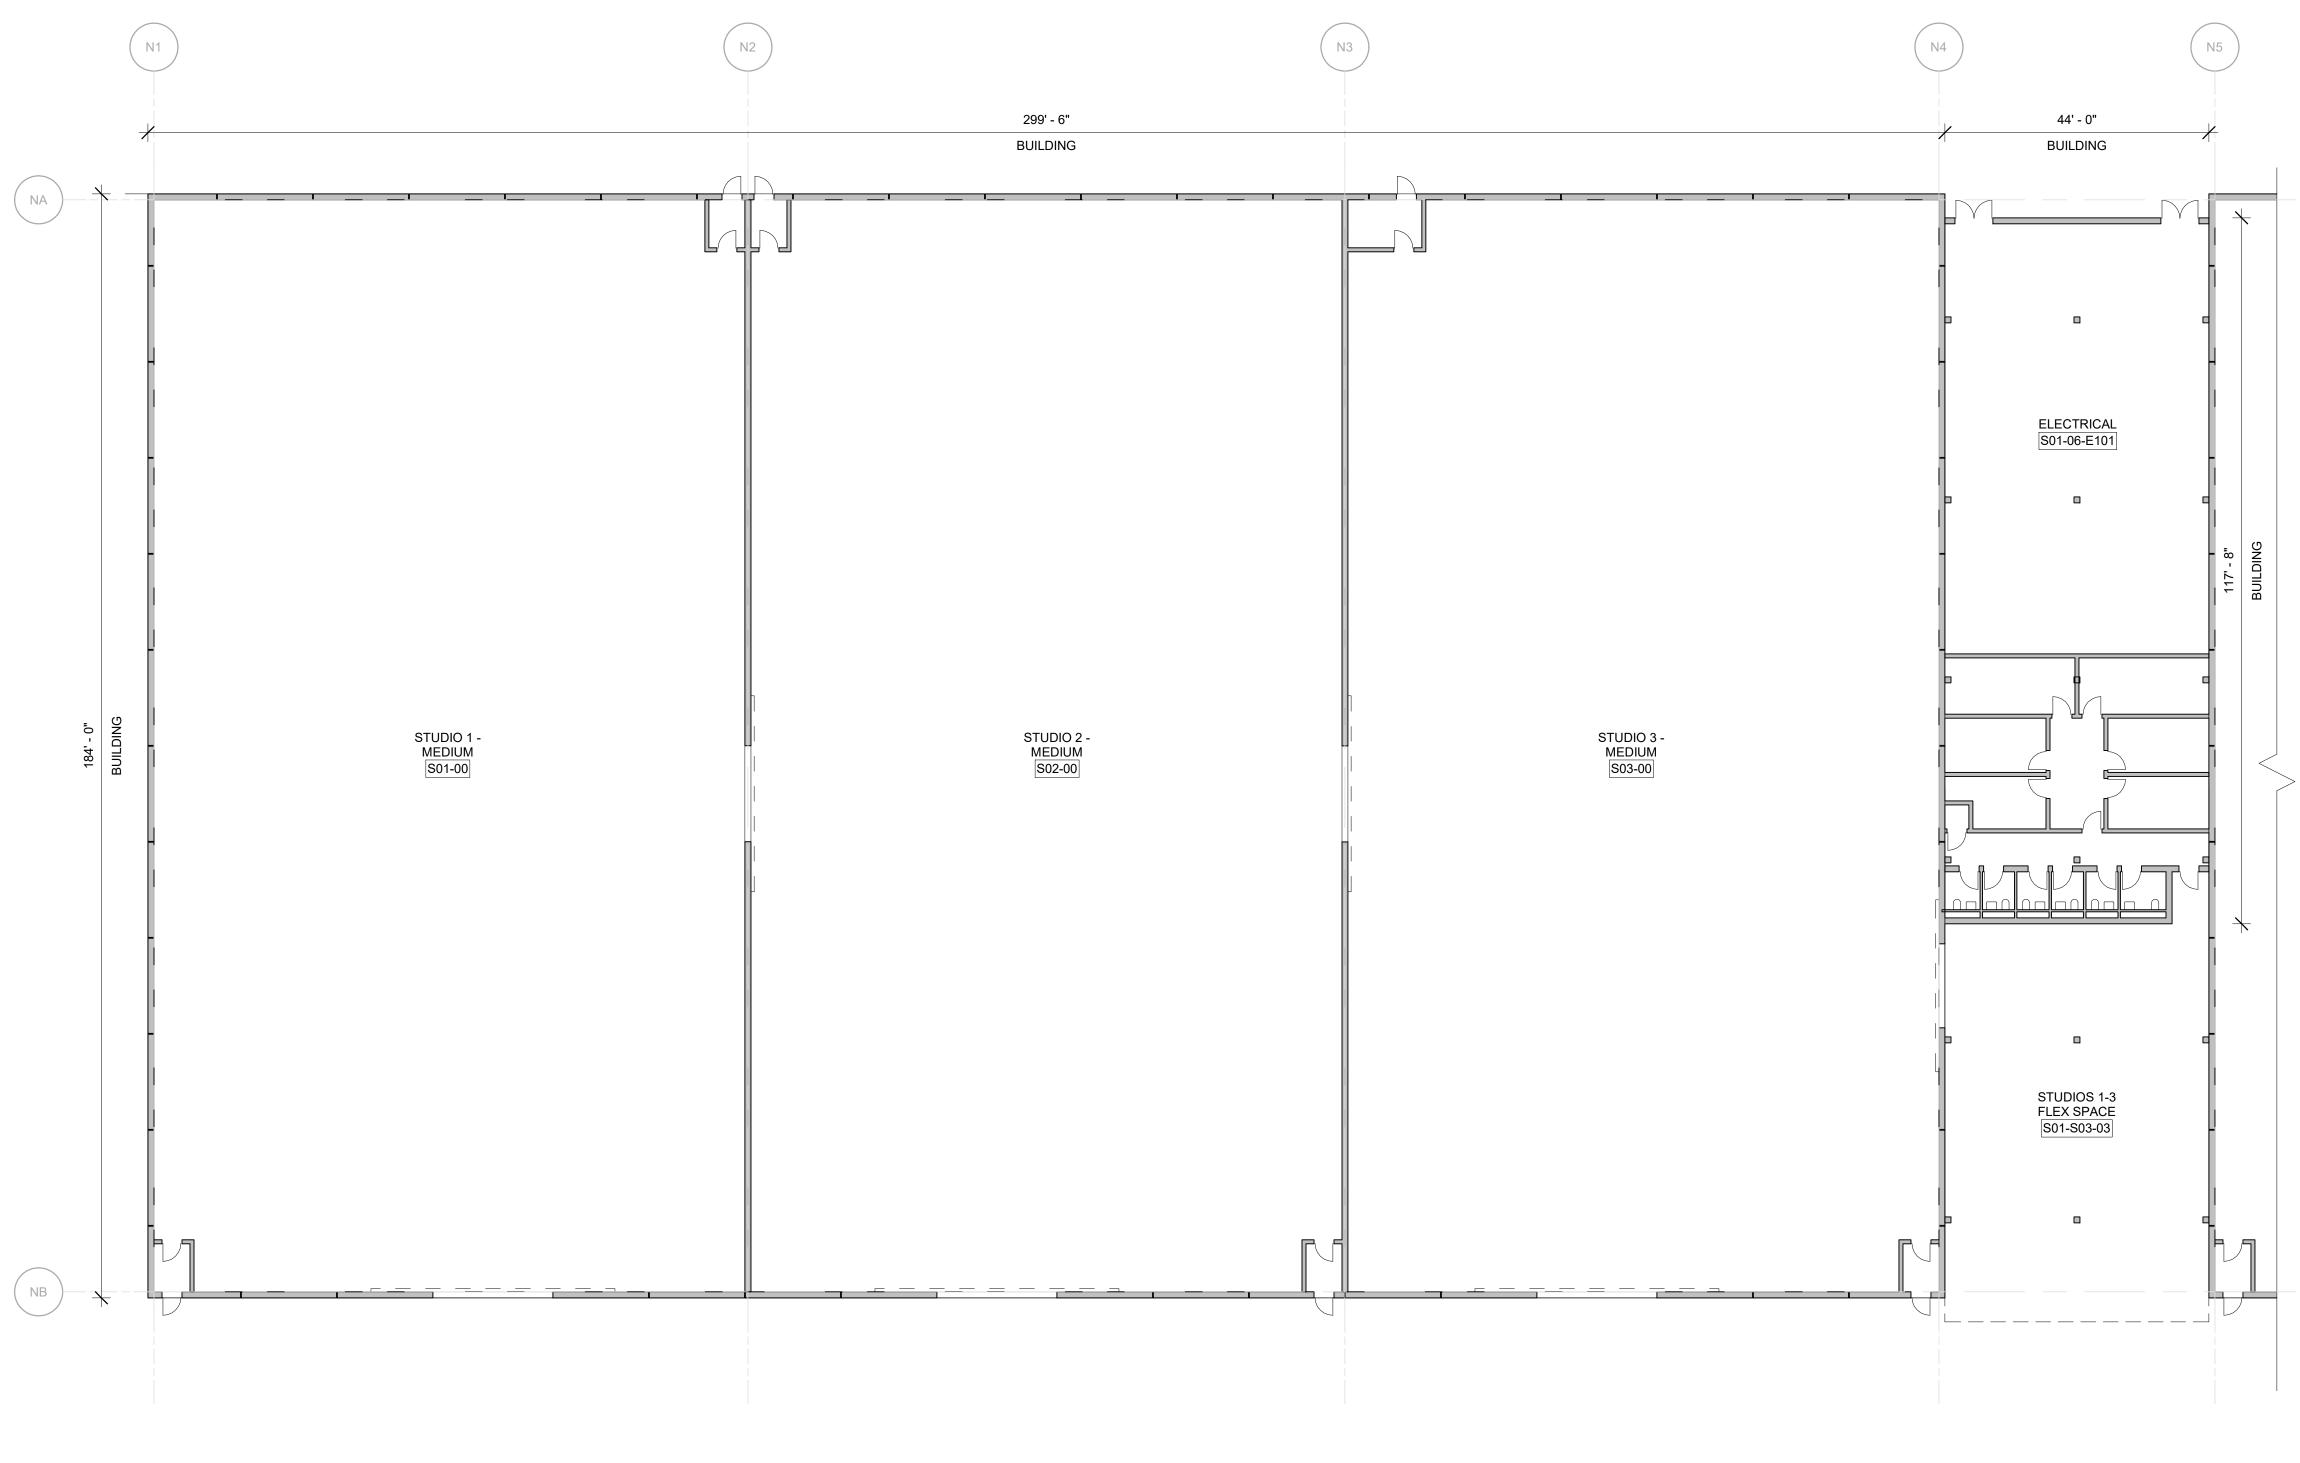STUDIO SIZES STUDIOS 1-10 & 13-16 STUDIOS 11-12 STUDIO SIZES ARE DEPENDENT ON HEIGHT AND TRUSS SPAN LENGTH.



**KEYNOTE LEGEND** 

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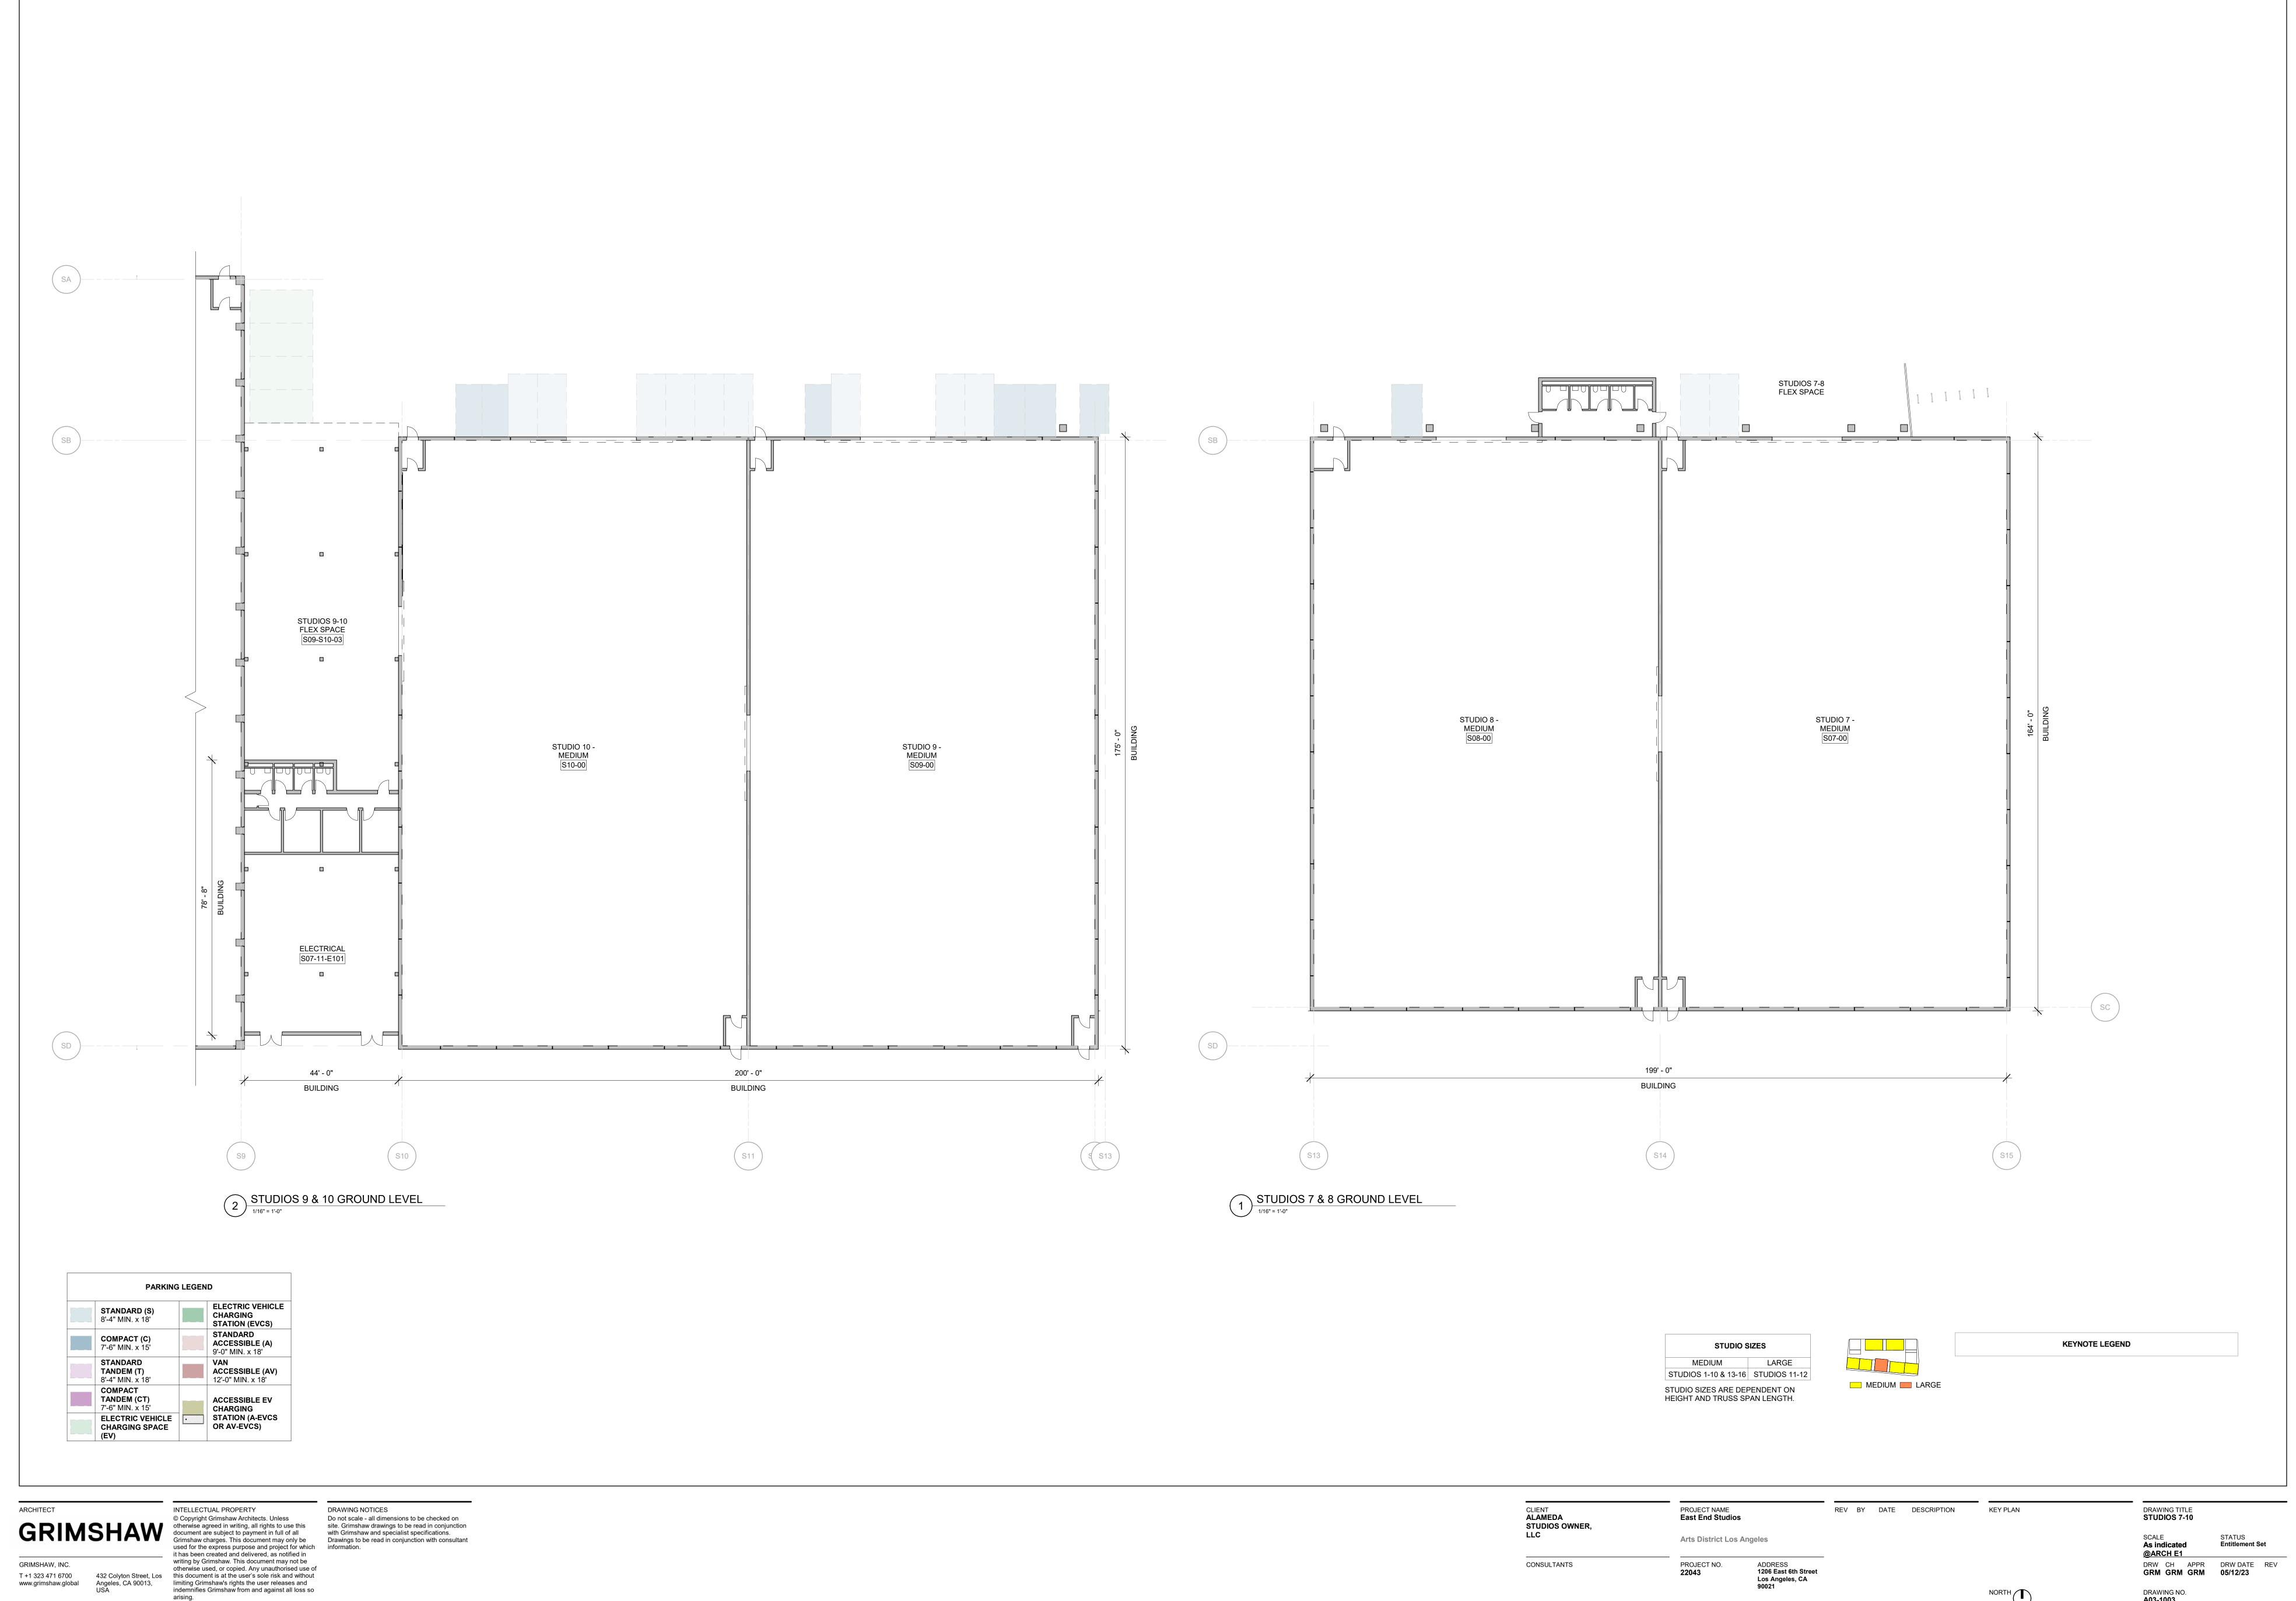
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REV BY DATE DESCRIPTION KEY PLAN

DRAWING TITLE STUDIOS 1-3


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As indicated
@ARCH E1 DRW CH APPR DRW DATE REV GRM GRM GRM 05/12/23 DRAWING NO. **A03-1001** 



Los Angeles, CA 90021



Los Angeles, CA 90021

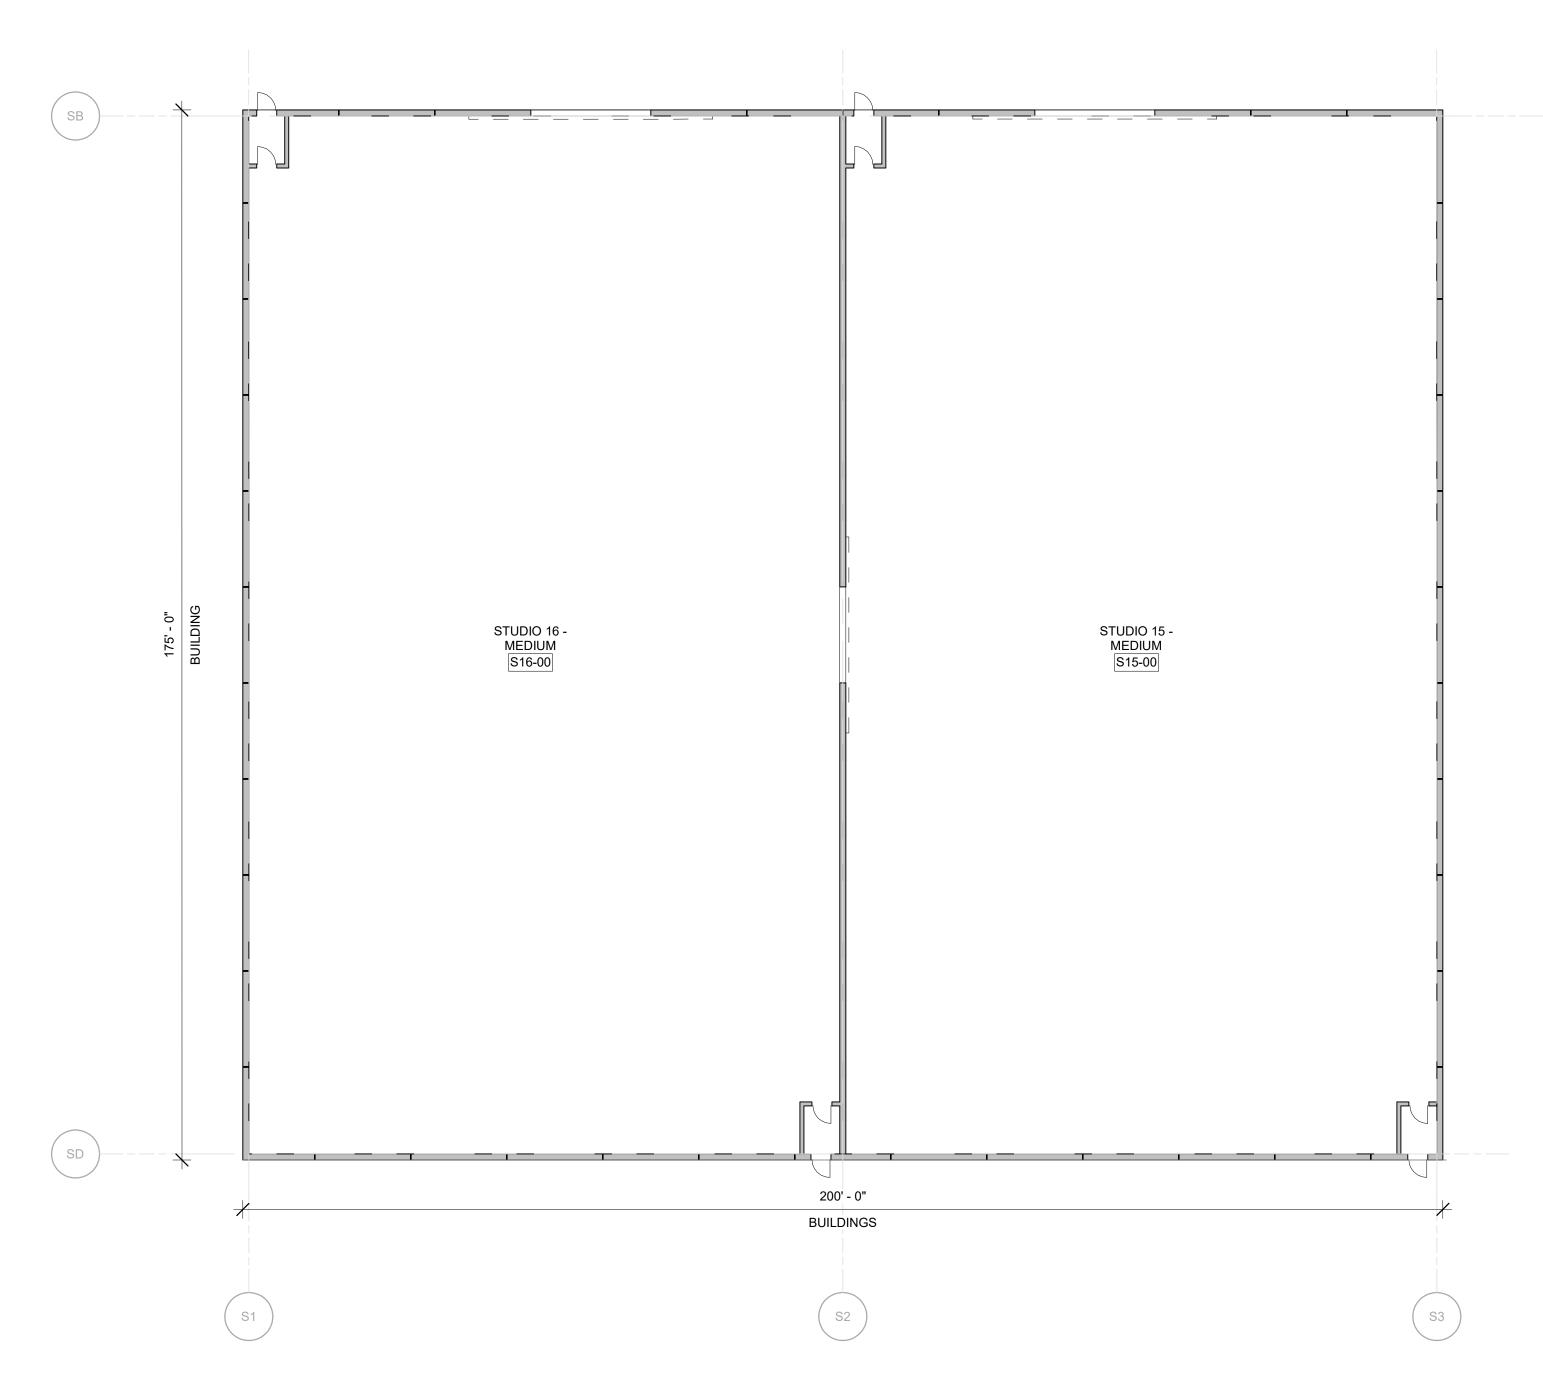

1 STUDIOS 15 & 16 GROUND LEVEL

STUDIO SIZES STUDIOS 1-10 & 13-16 STUDIOS 11-12 STUDIO SIZES ARE DEPENDENT ON HEIGHT AND TRUSS SPAN LENGTH.

MEDIUM LARGE

**KEYNOTE LEGEND** 

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CLIENT
ALAMEDA
STUDIOS OWNER,
LLC

CONSULTANTS

PROJECT NAME
East End Studios **Arts District Los Angeles** 


PROJECT NO. **22043** 


ADDRESS 1206 East 6th Street Los Angeles, CA 90021

REV BY DATE DESCRIPTION KEY PLAN

DRAWING TITLE STUDIOS 15 & 16

SCALE
As indicated
@ARCH E1 DRW CH APPR DRW DATE REV GRM GRM GRM 05/12/23

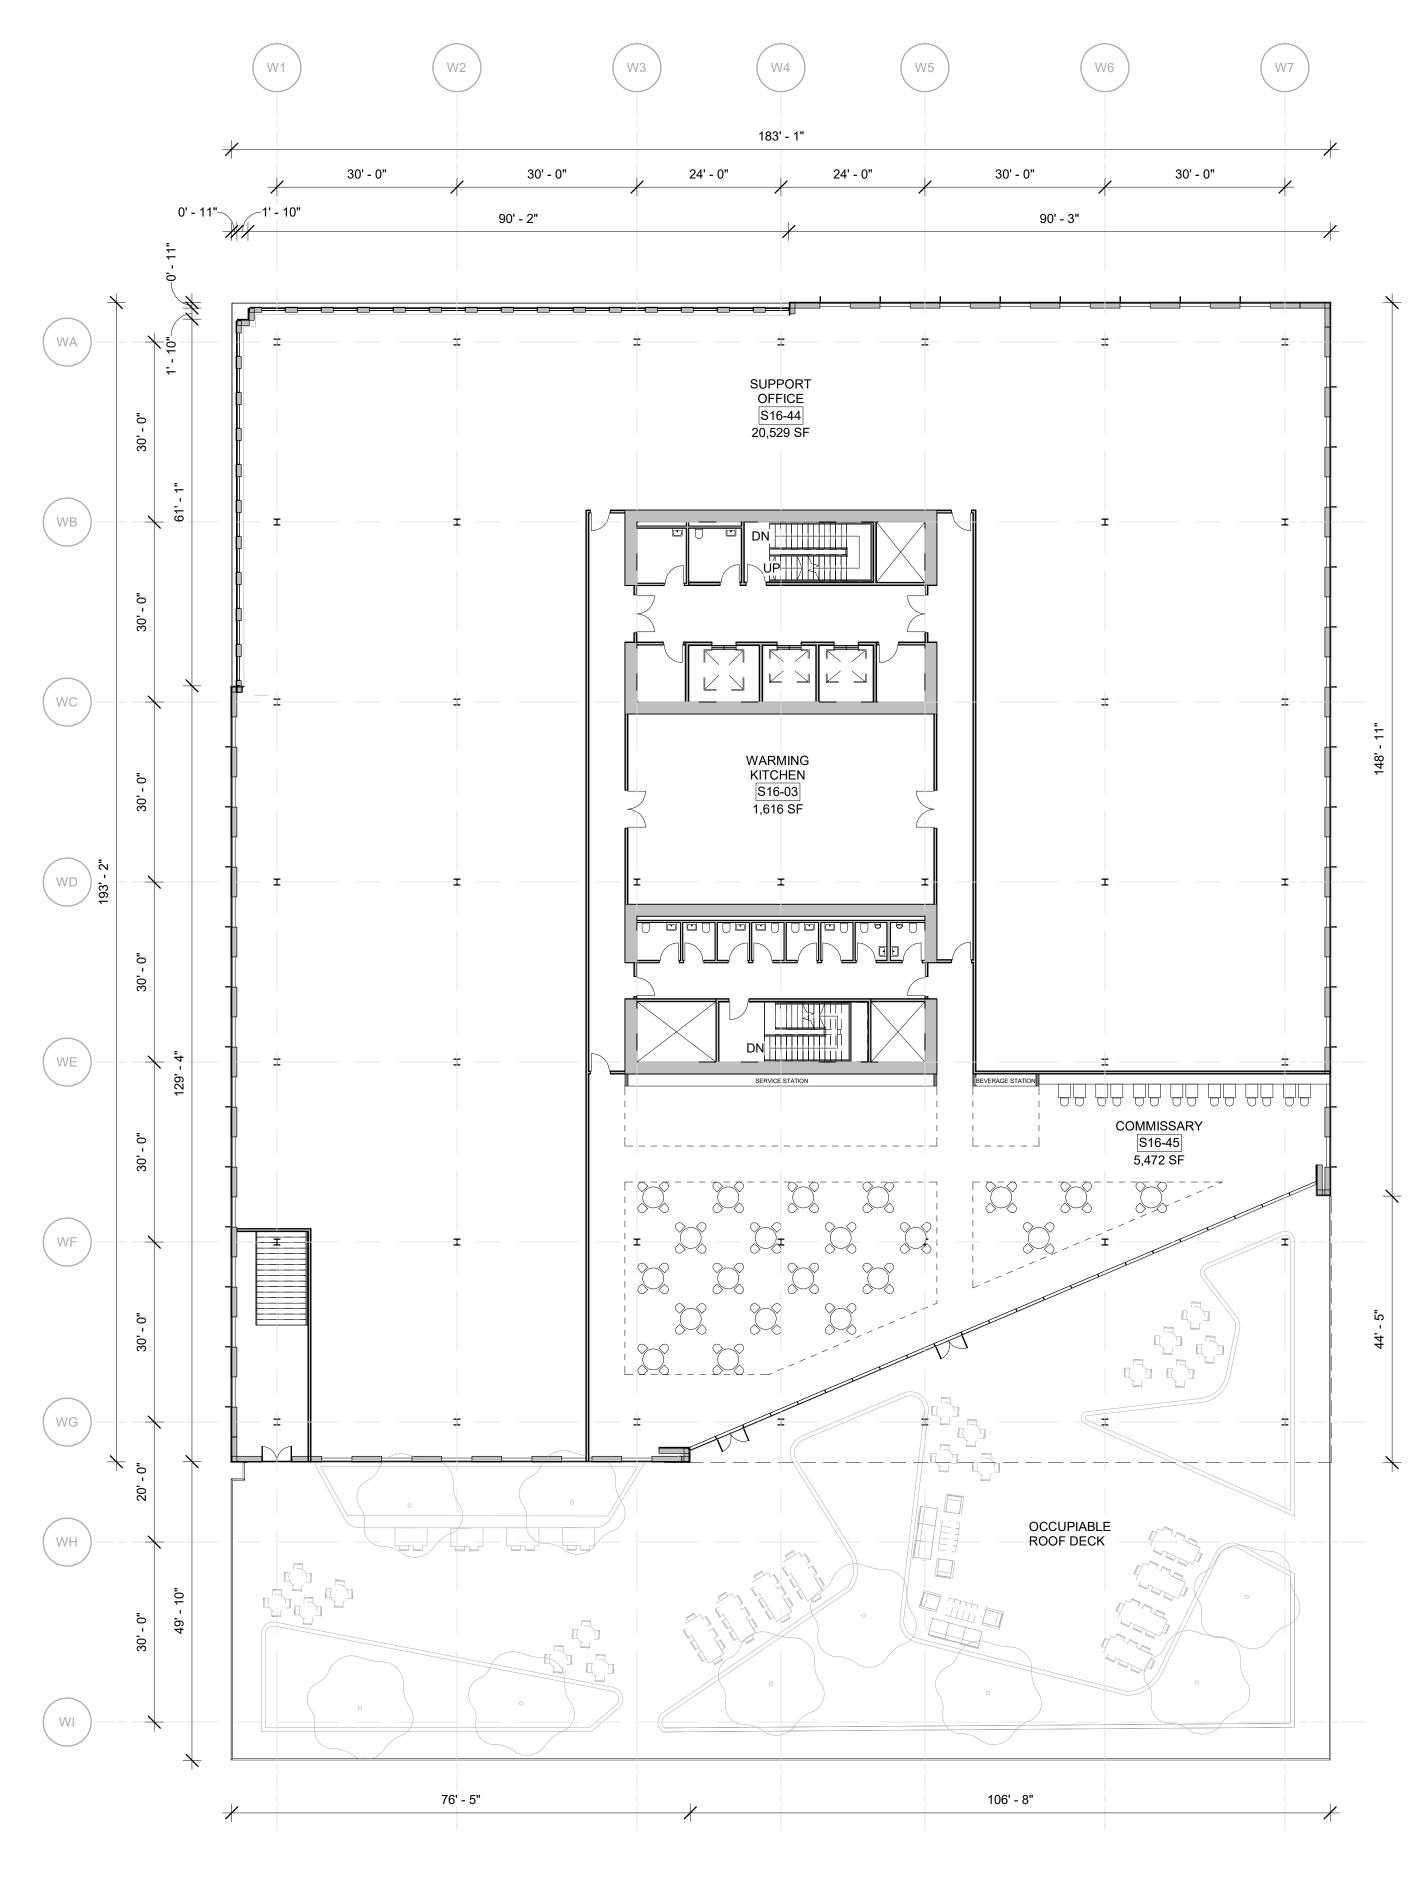

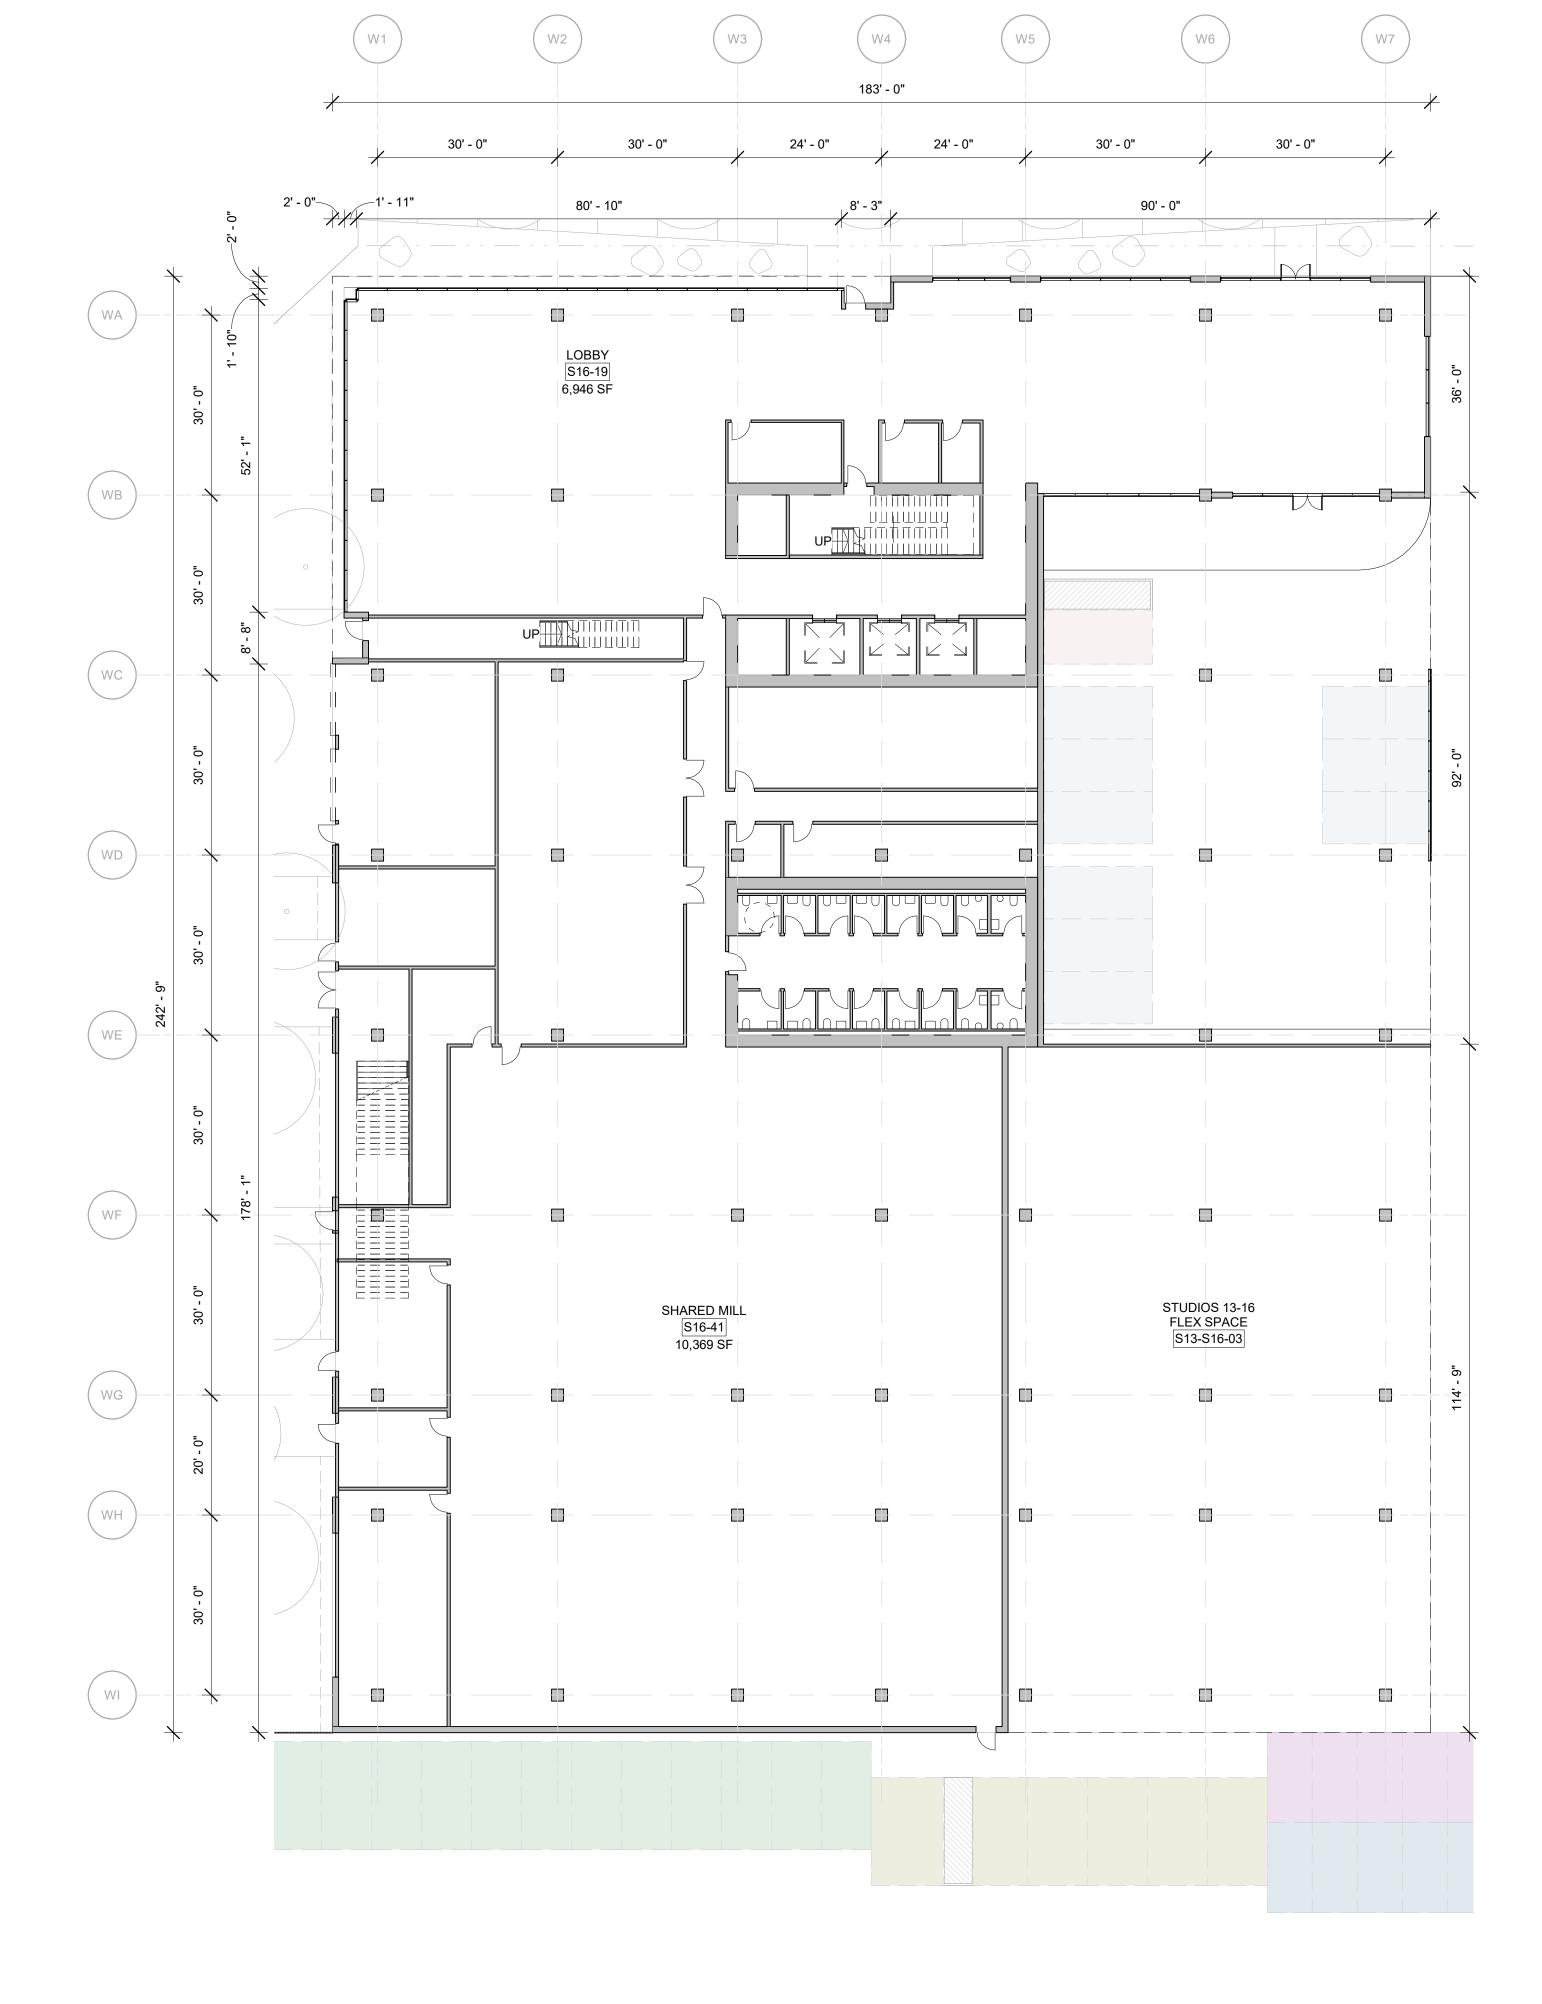

PARKING LEGEND ELECTRIC VEHICLE CHARGING STATION (EVCS) **STANDARD (S)** 8'-4" MIN. x 18' STANDARD ACCESSIBLE (A) COMPACT (C) 7'-6" MIN. x 15' 9'-0" MIN. x 18' STANDARD TANDEM (T) 8'-4" MIN. x 18' ACCESSIBLE (AV) 12'-0" MIN. x 18' COMPACT **TANDEM (CT)** 7'-6" MIN. x 15' ACCESSIBLE EV CHARGING STATION (A-EVCS ELECTRIC VEHICLE

arising.

OFFICE BUILDING - ALAMEDA AMENITY LEVEL

OFFICE BUILDING - ALAMEDA GROUND LEVEL

1/16" = 1'-0"

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OR AV-EVCS)

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REV BY DATE DESCRIPTION **KEY PLAN** 


ADDRESS 1206 East 6th Street

Los Angeles, CA

DRAWING TITLE OFFICE BUILDING - ALAMEDA SCALE 1/16" = 1'-0" @ARCH E1 DRW CH APPR DRW DATE REV
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DRAWING NO. **A03-1020** 

NORTH (

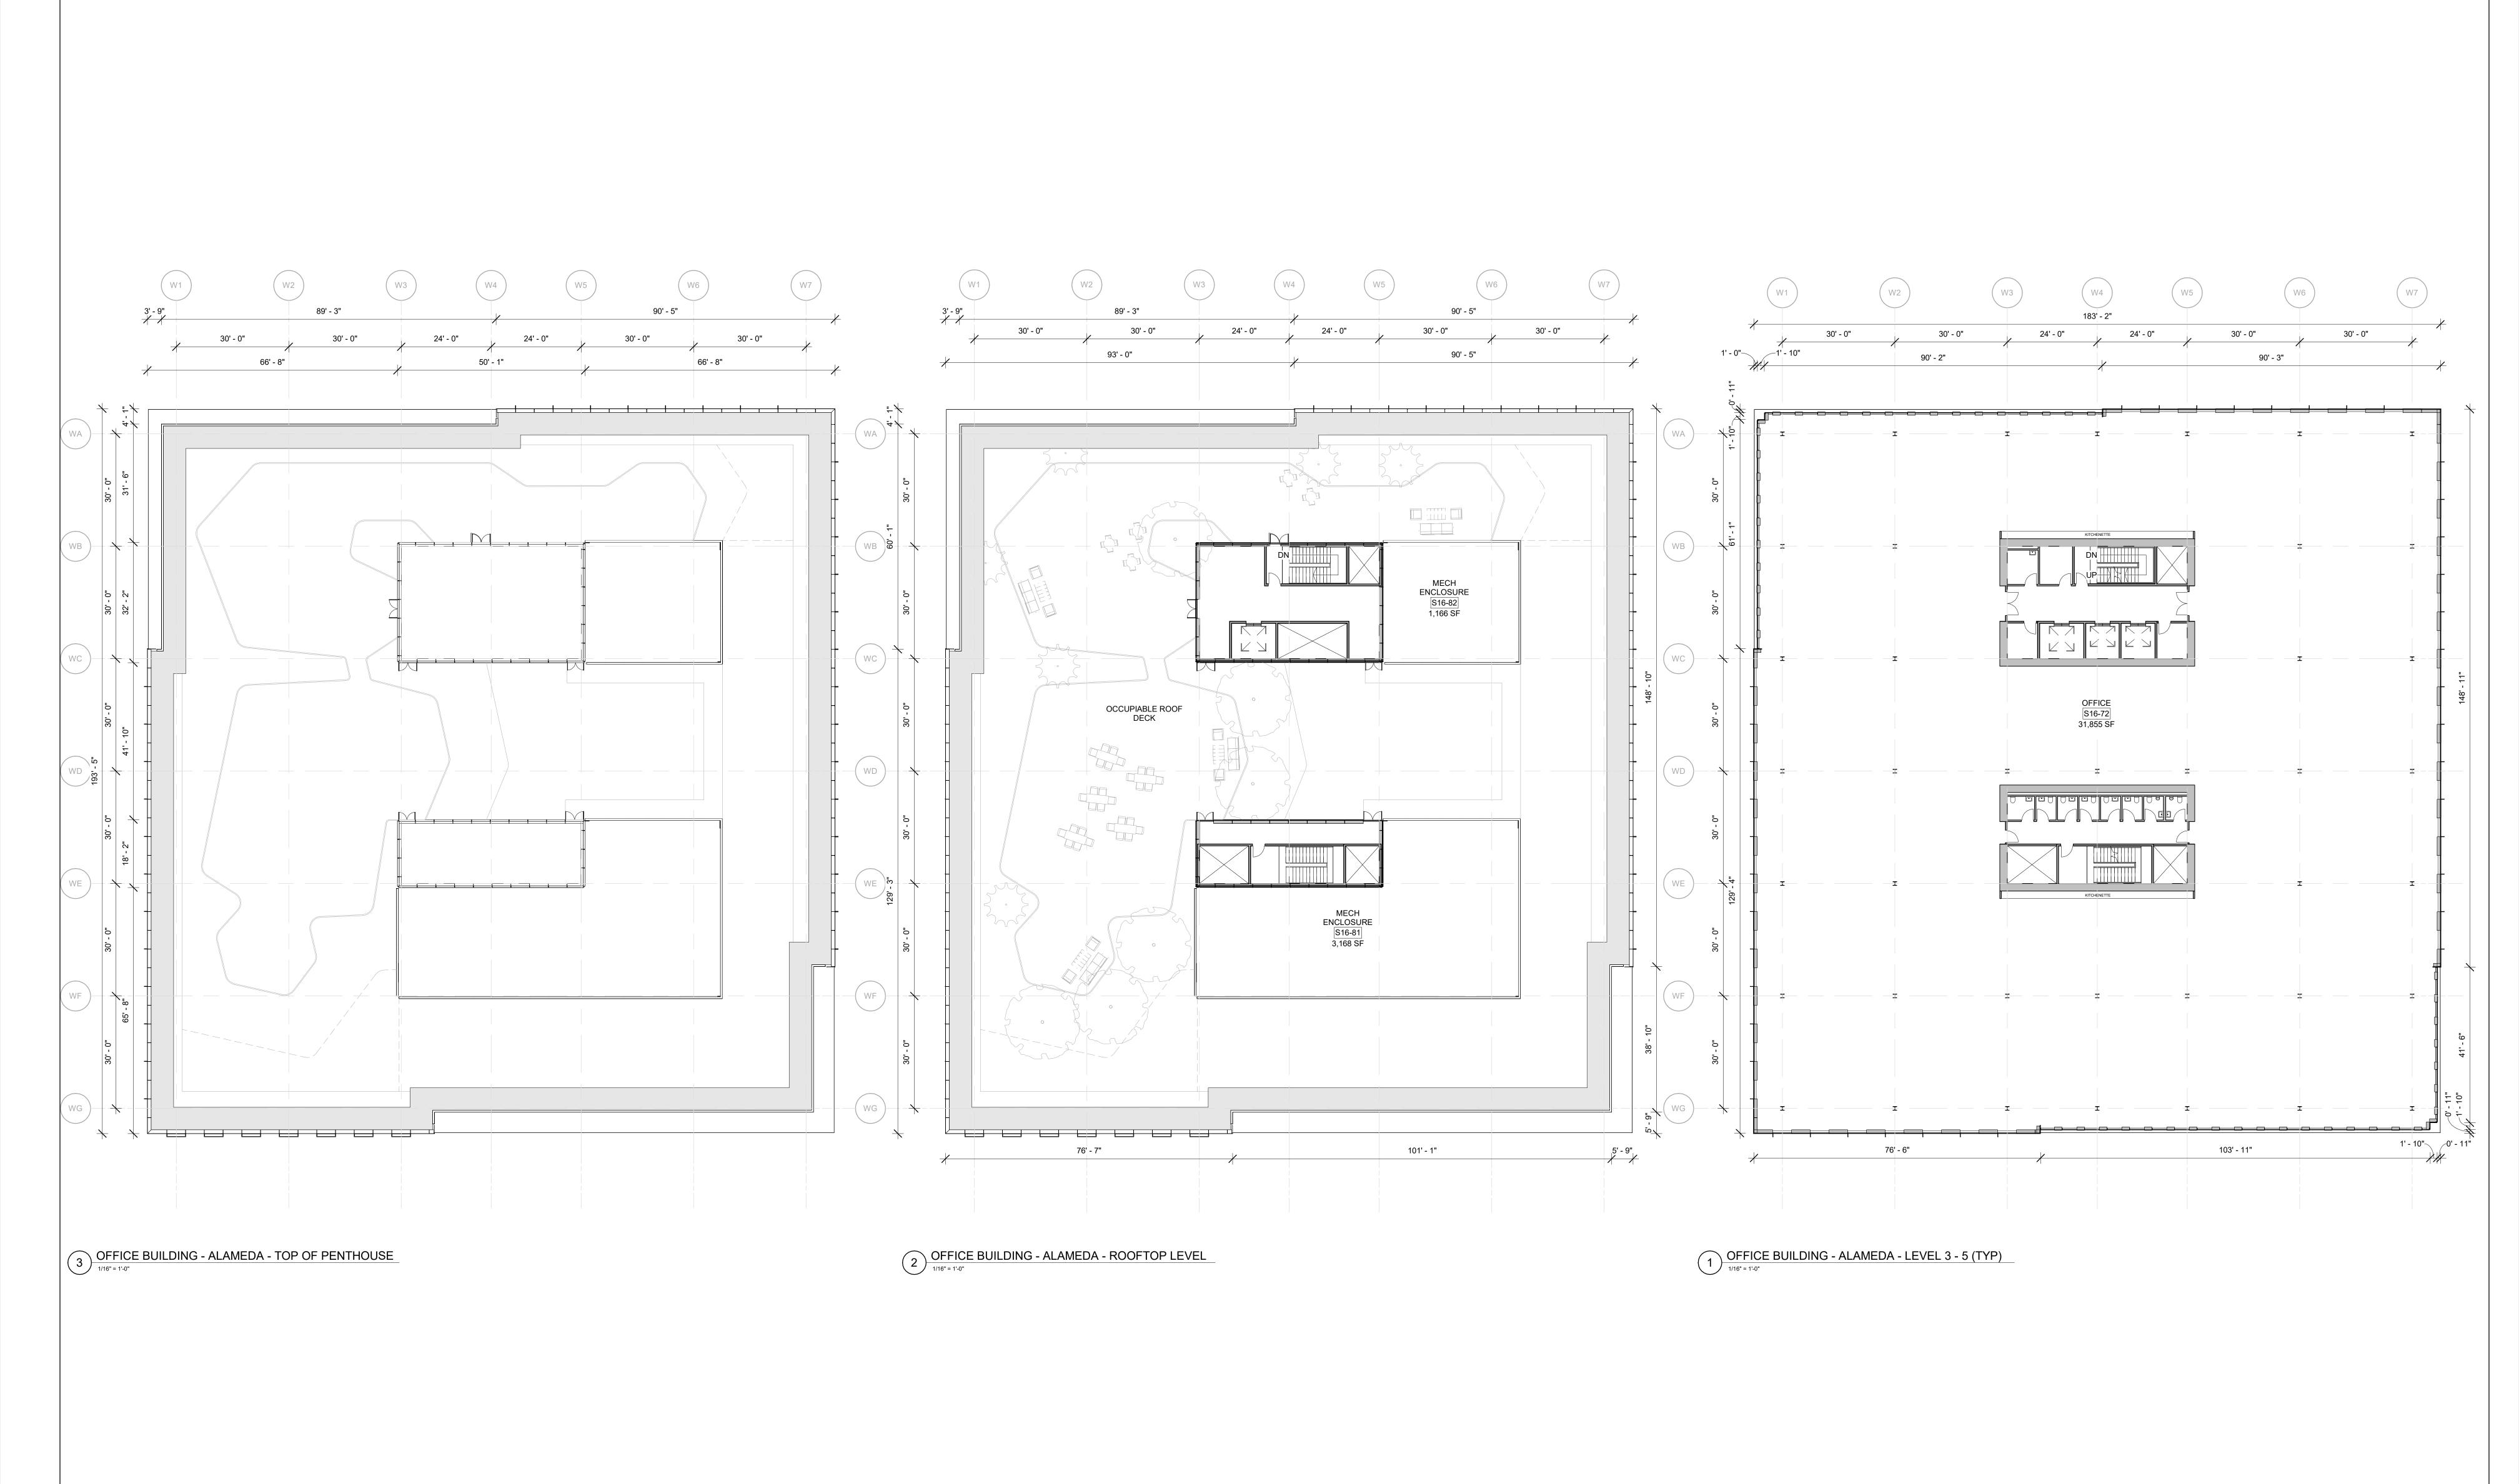

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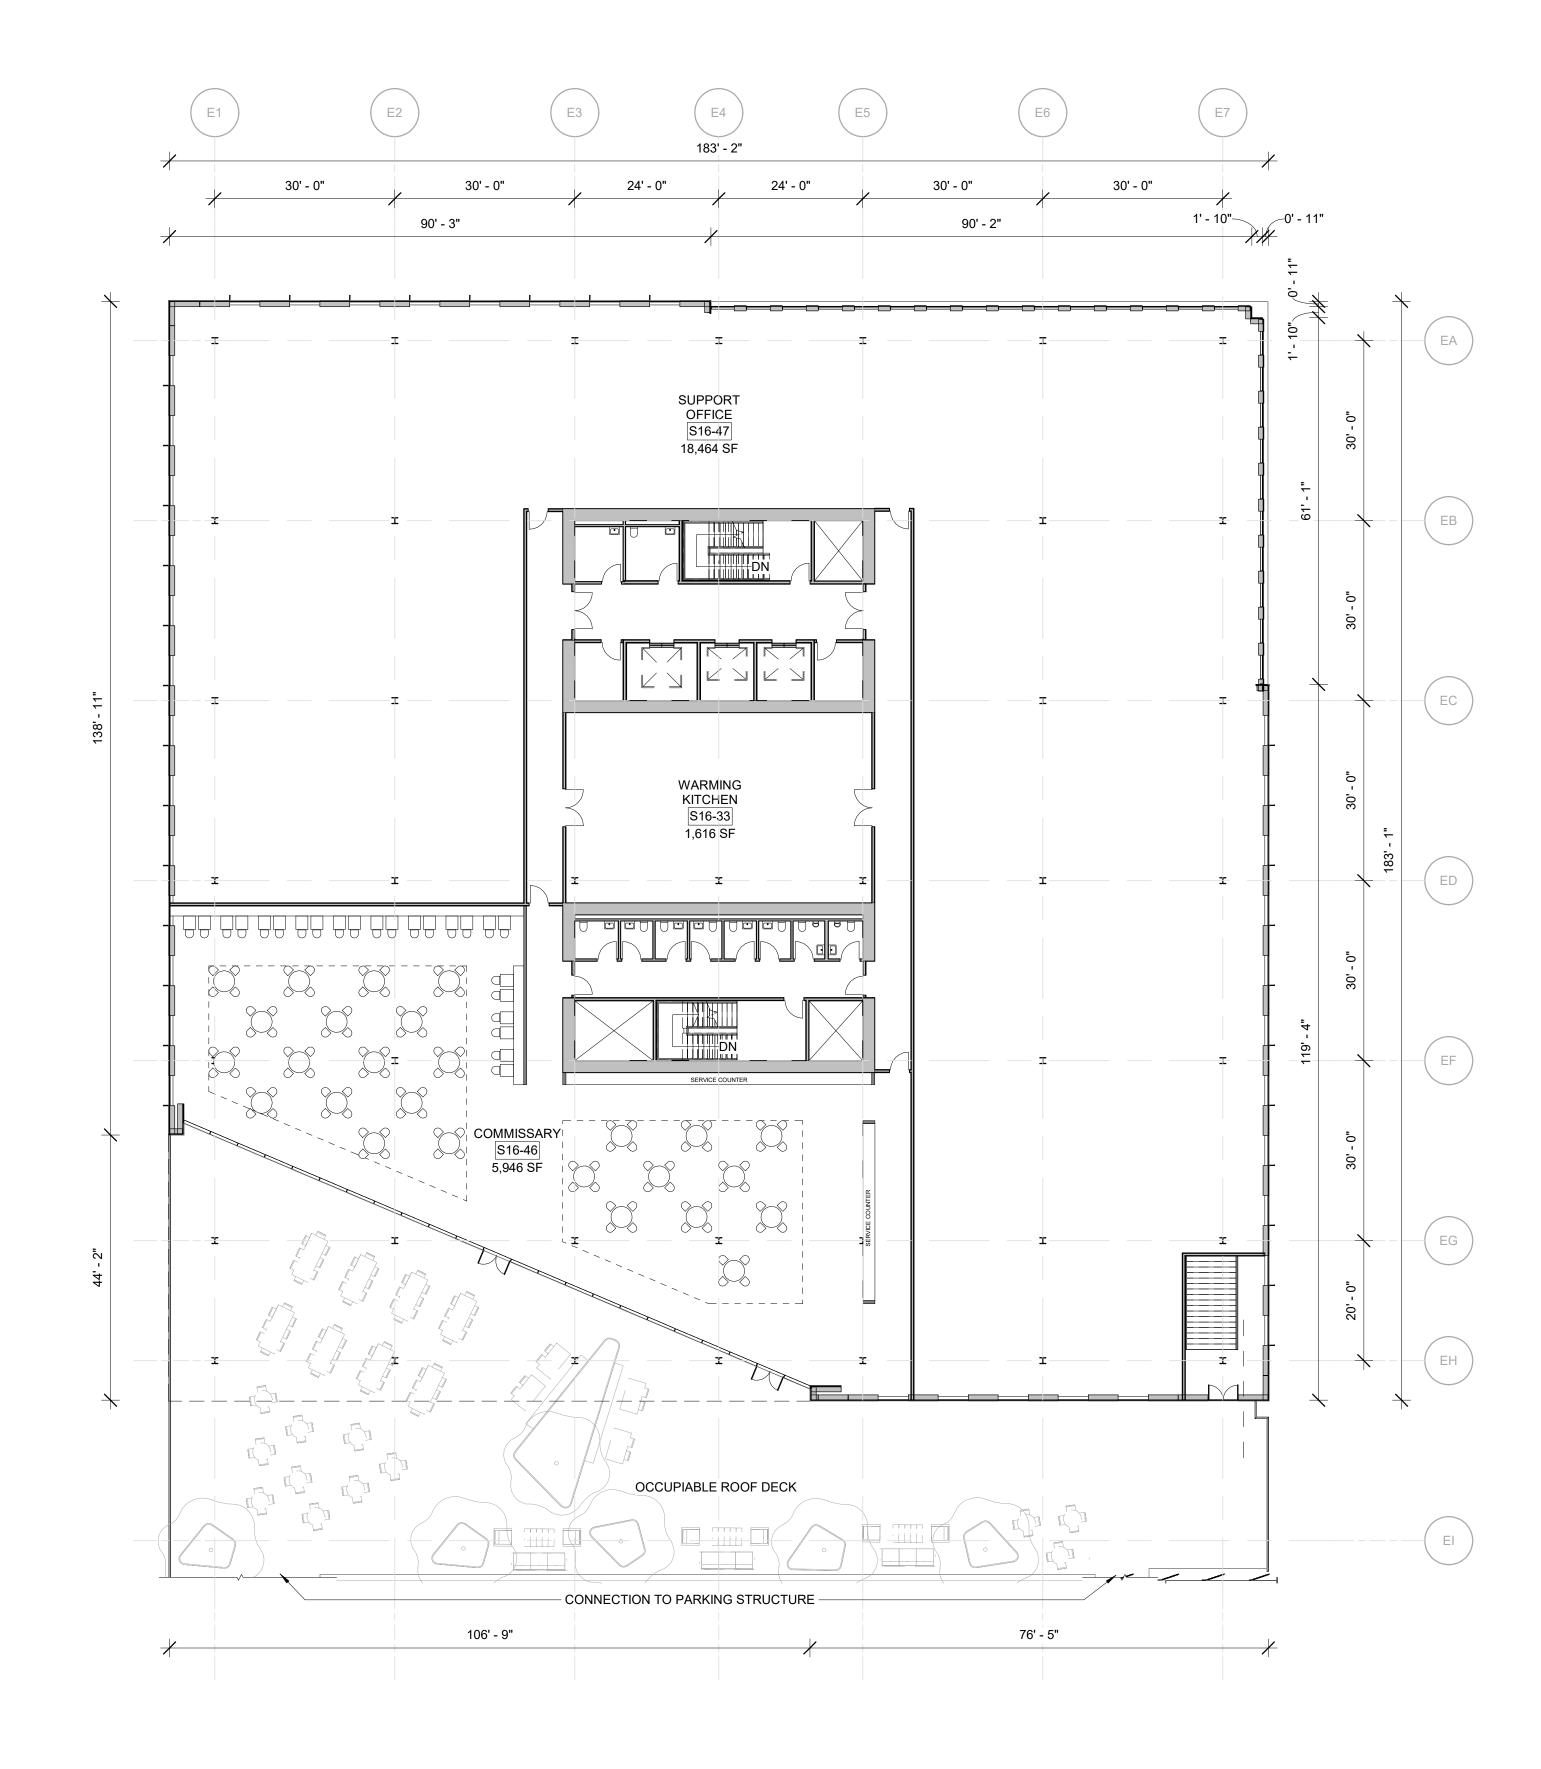
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Los Angeles, CA 90021

REV BY DATE DESCRIPTION **KEY PLAN** DRAWING TITLE
OFFICE BUILDING - ALAMEDA SCALE 1/16" = 1'-0" @ARCH E1 DRW CH APPR DRW DATE REV
GRM GRM GRM 05/12/23


DRAWING NO. **A03-1021** 

NORTH (1)



OFFICE BUILDING - MILL AMENITY LEVEL

1/16" = 1'-0"

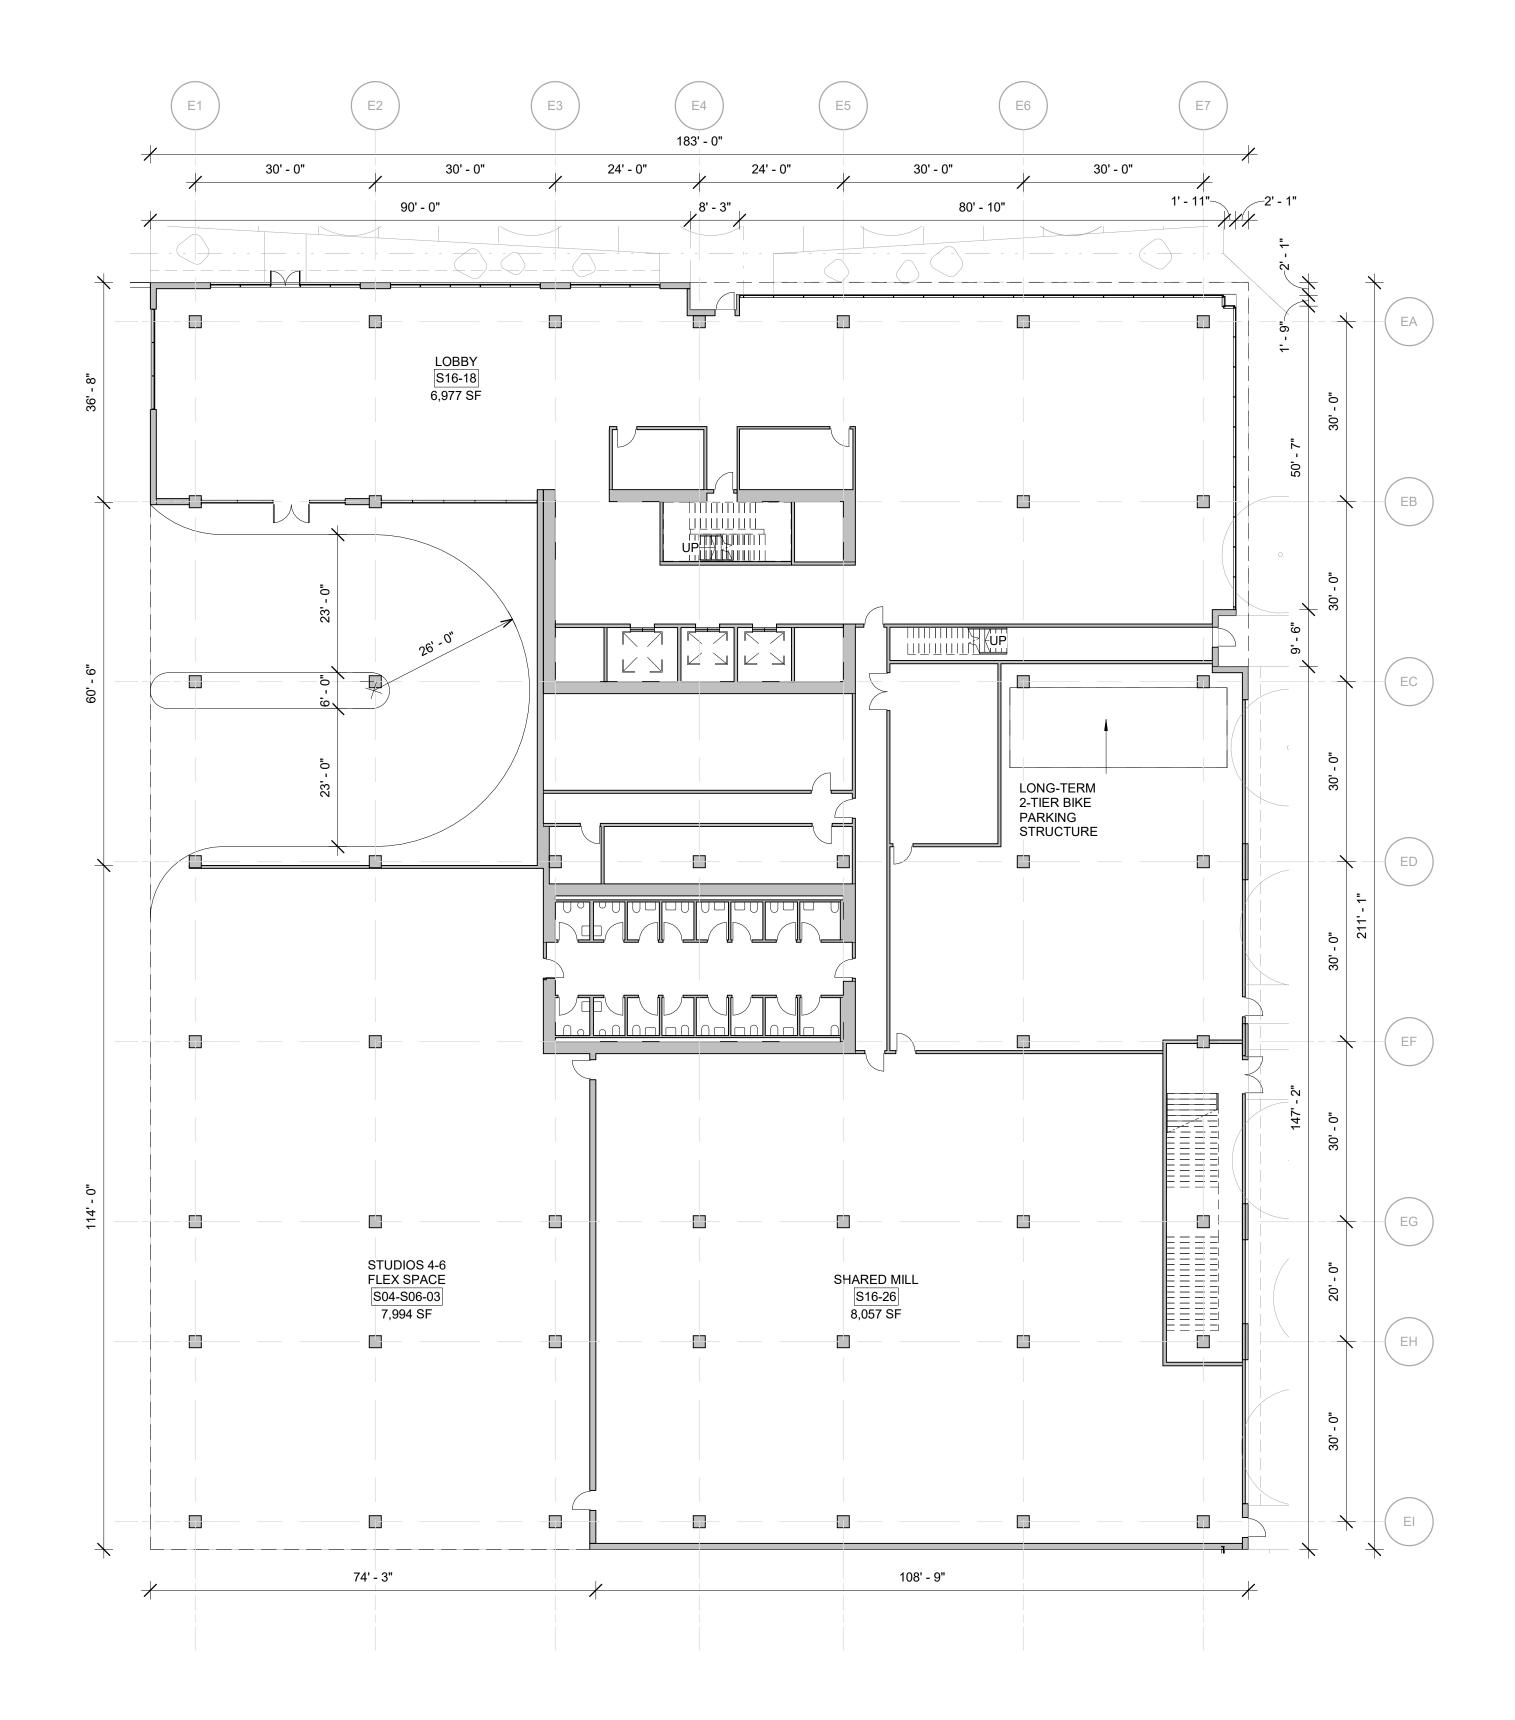

OFFICE BUILDING - MILL GROUND LEVEL

1/16" = 1'-0"

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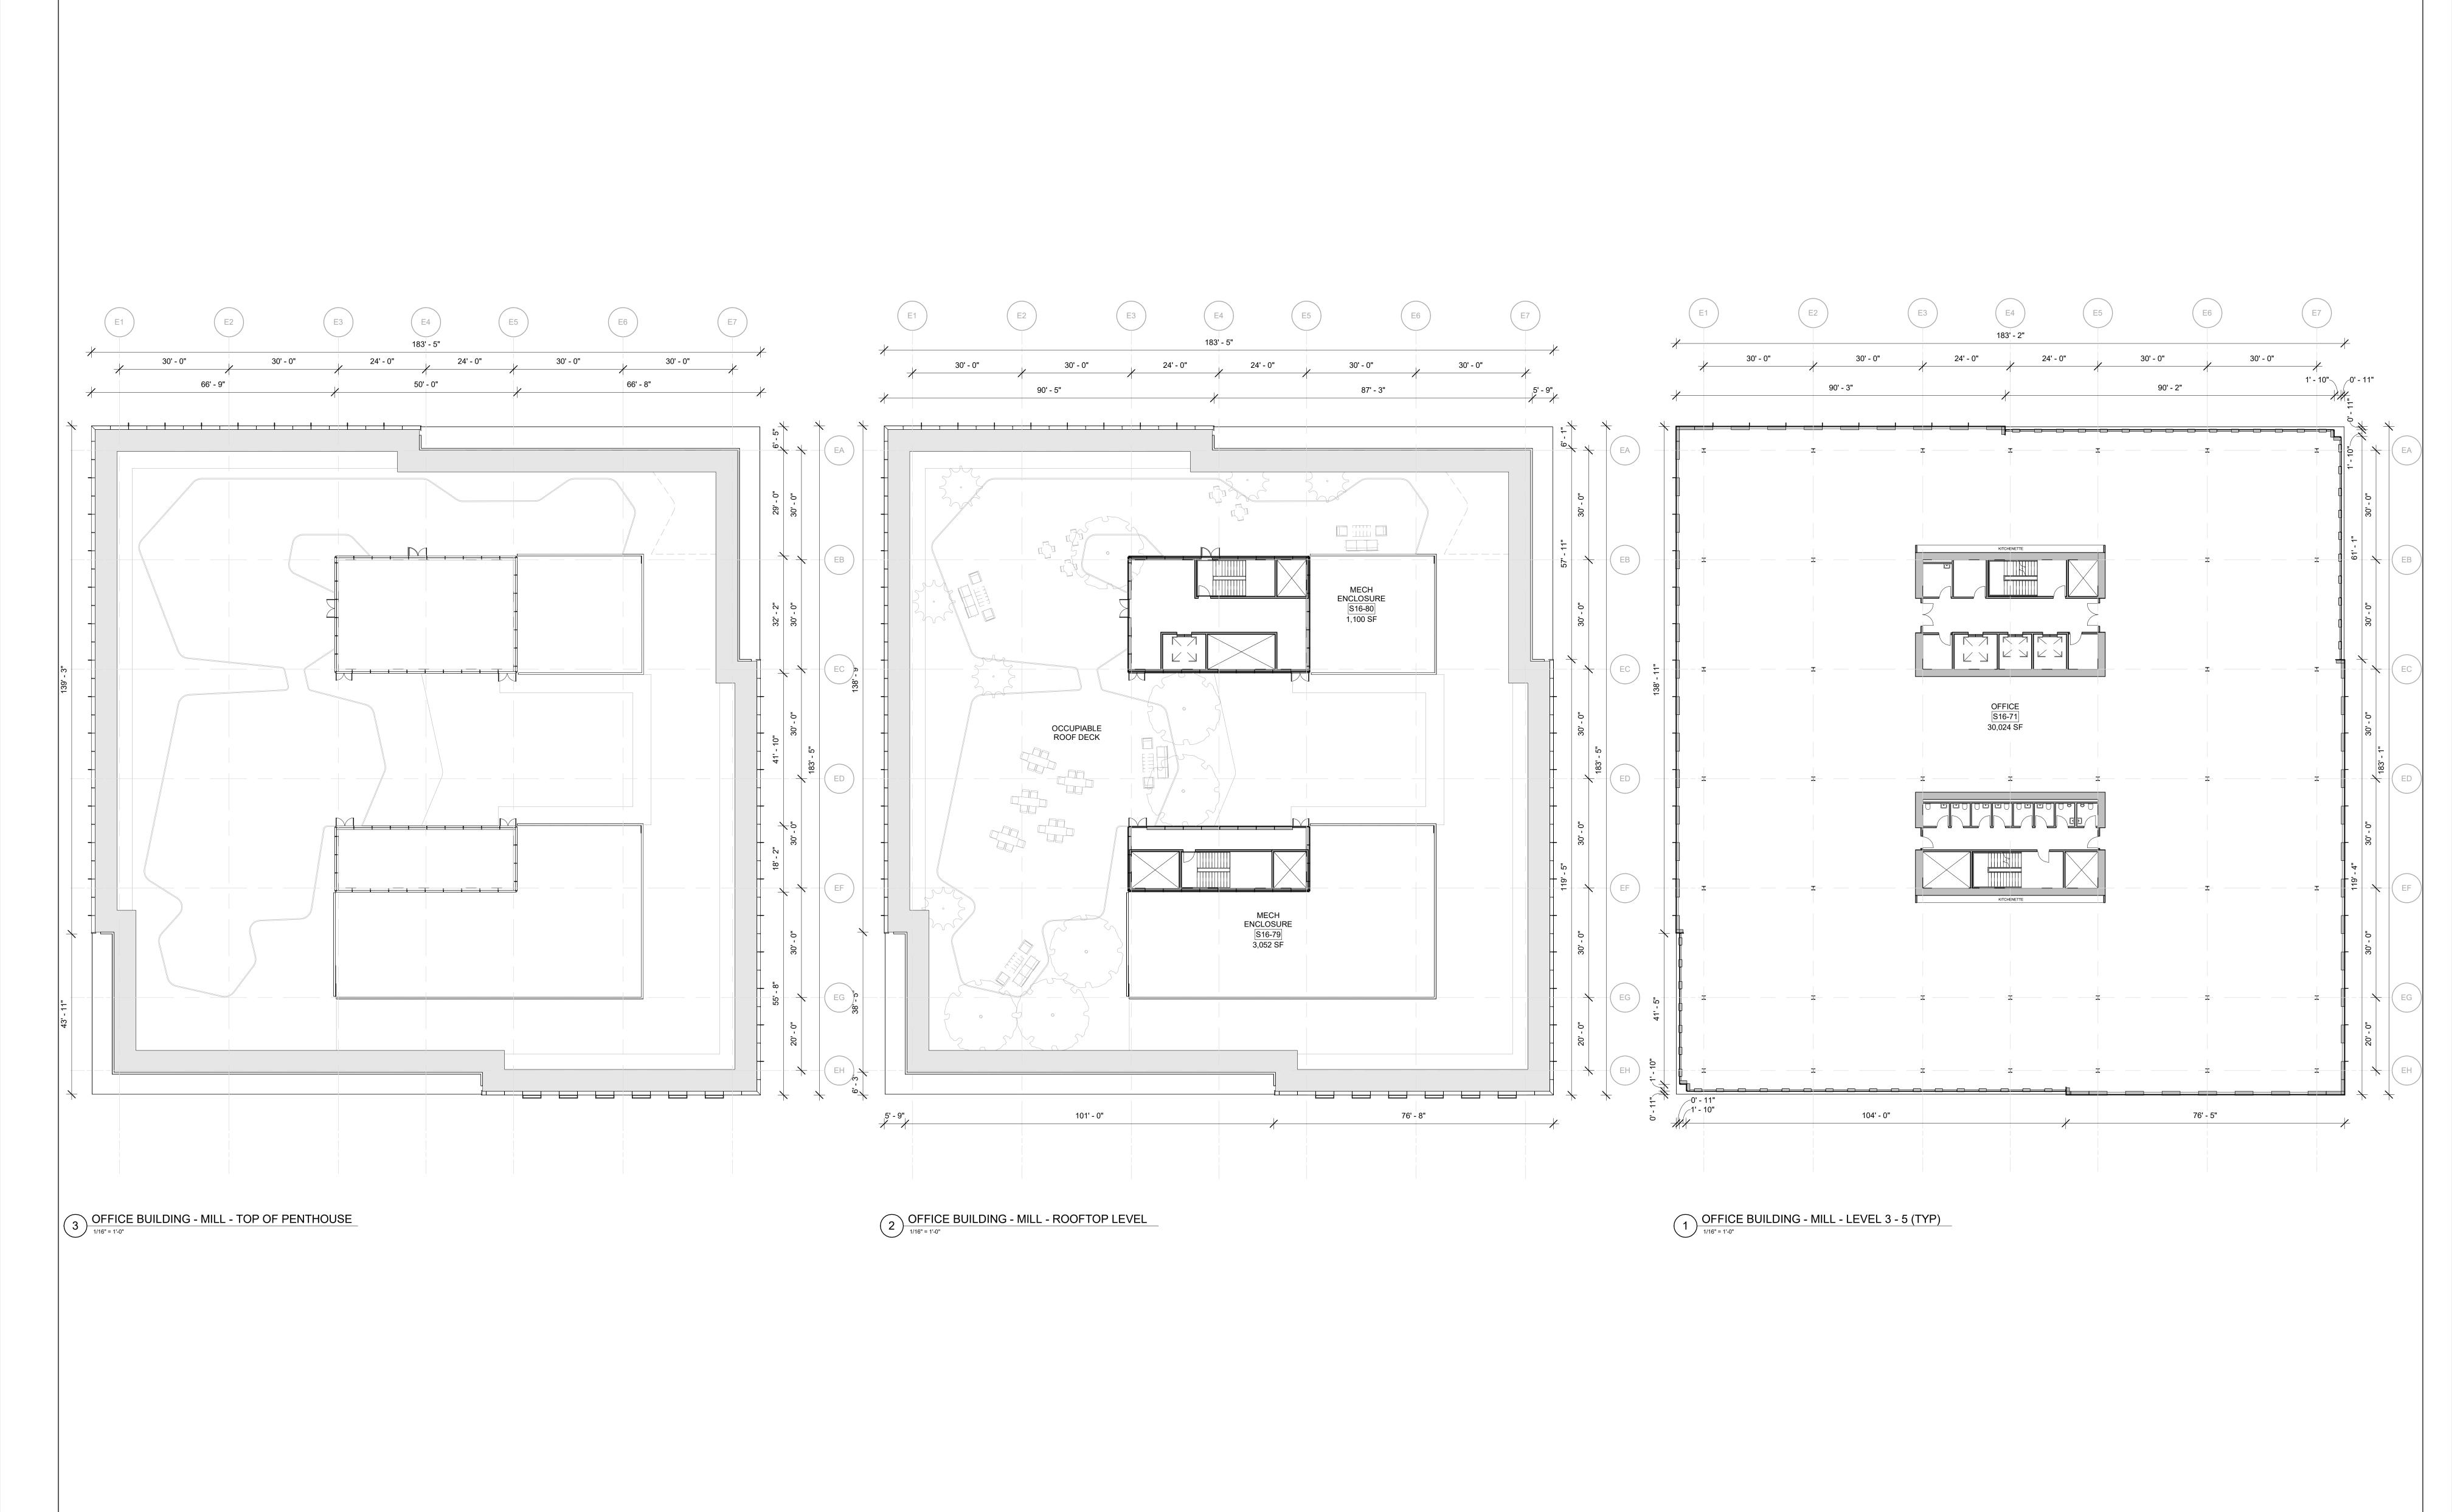
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DRAWING TITLE
OFFICE BUILDING - MILL REV BY DATE DESCRIPTION **KEY PLAN** SCALE 1/16" = 1'-0" @ARCH E1

NORTH (1)

DRW CH APPR DRW DATE REV
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STUDIOS OWNER, CONSULTANTS

PROJECT NAME **East End Studios** 


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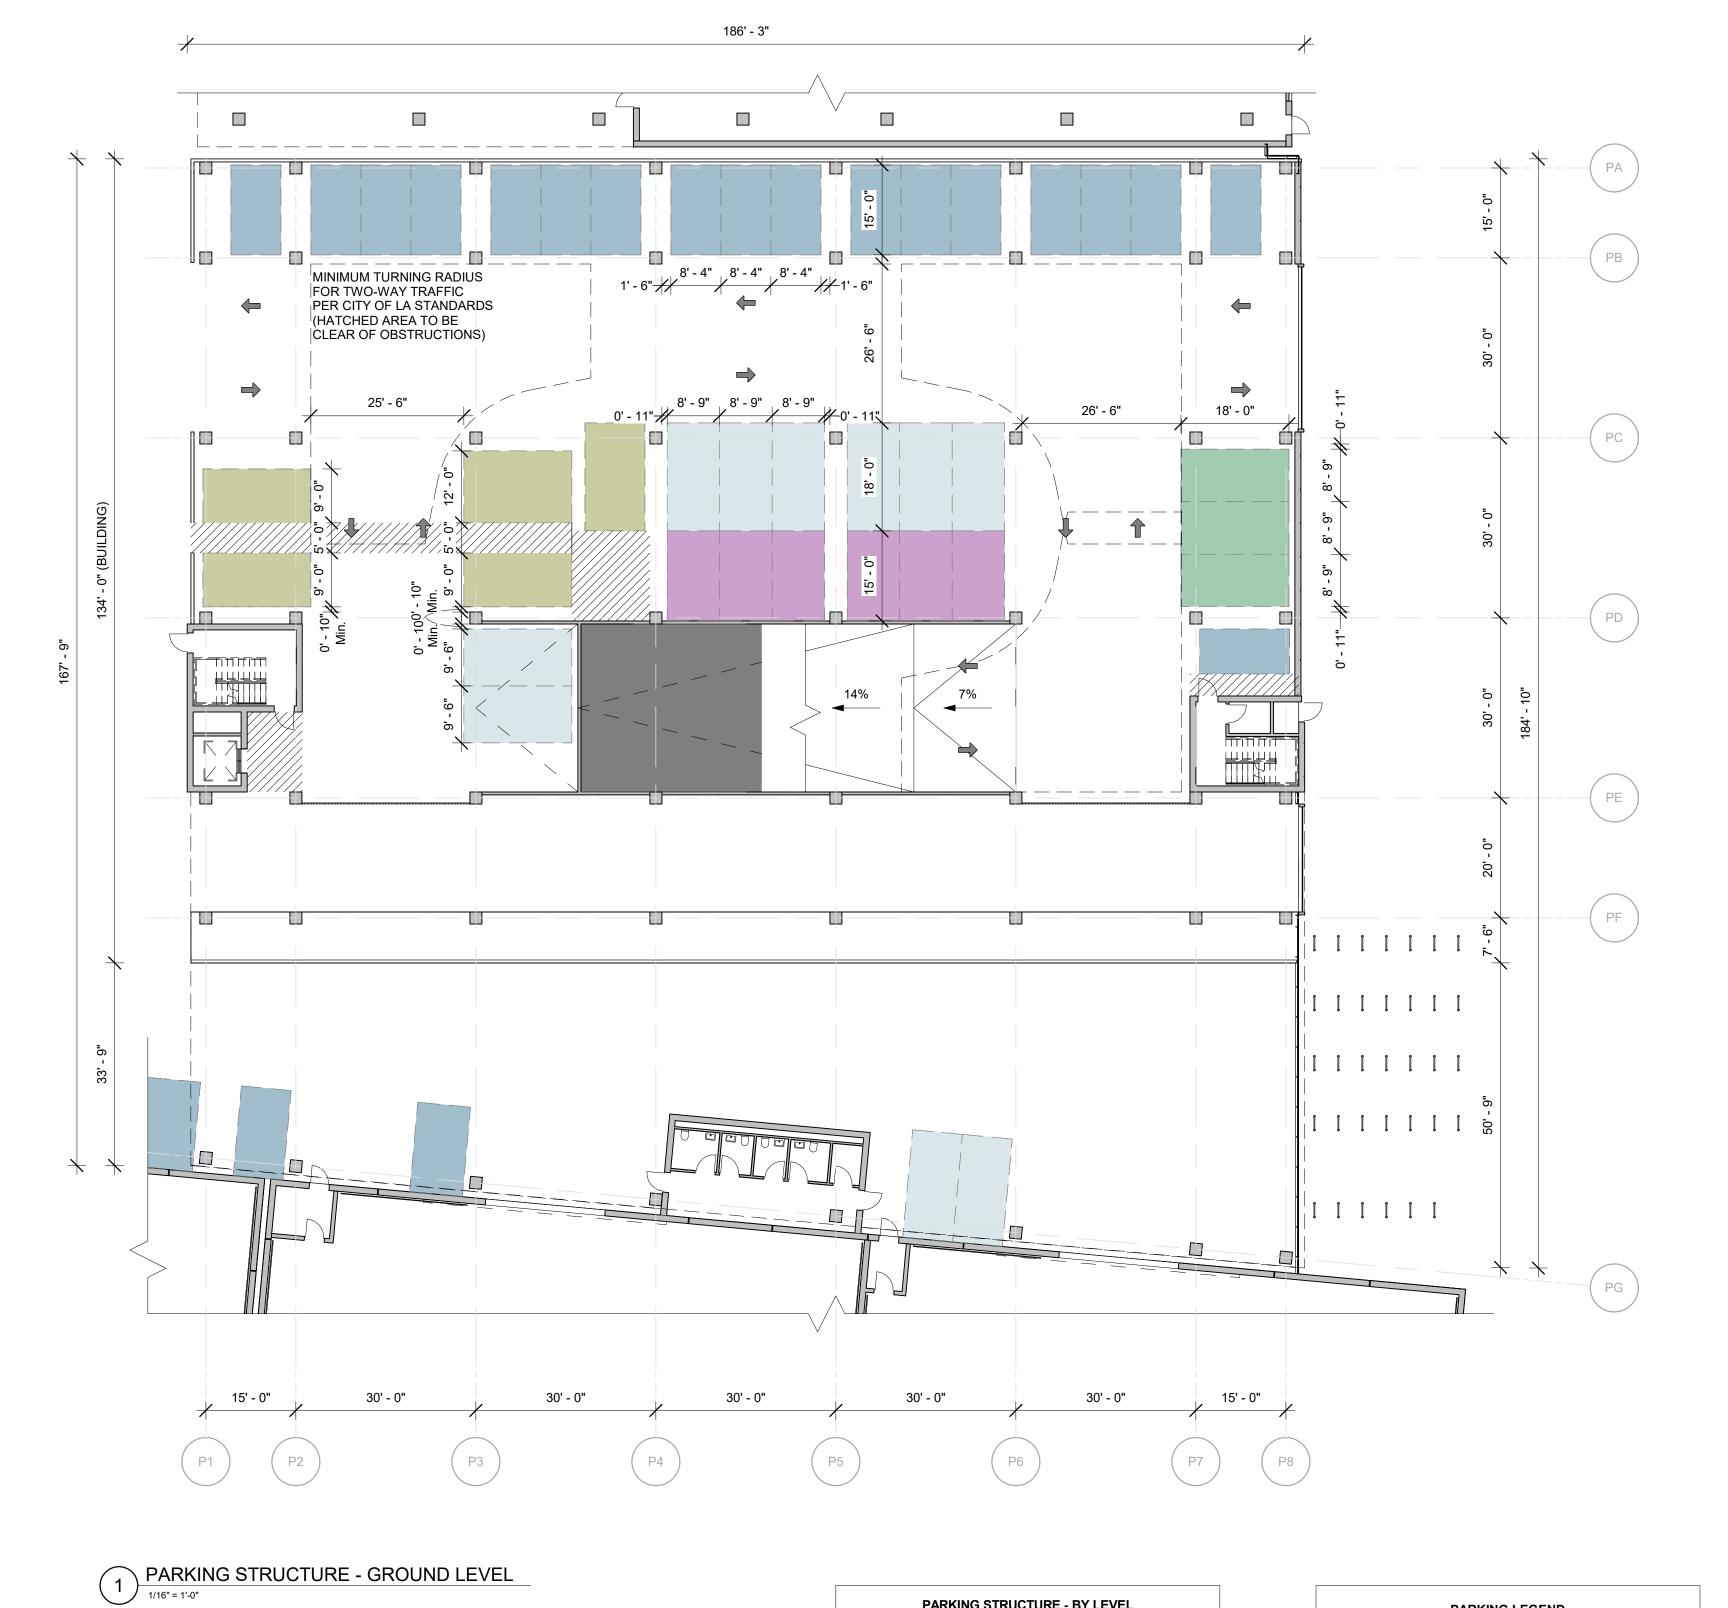
**Arts District Los Angeles** 

REV BY DATE DESCRIPTION

DRAWING TITLE
OFFICE BUILDING - MILL **KEY PLAN** SCALE 1/16" = 1'-0" @ARCH E1 DRW CH APPR DRW DATE REV
GRM GRM GRM 05/12/23

ADDRESS 1206 East 6th Street Los Angeles, CA 90021 NORTH (1)



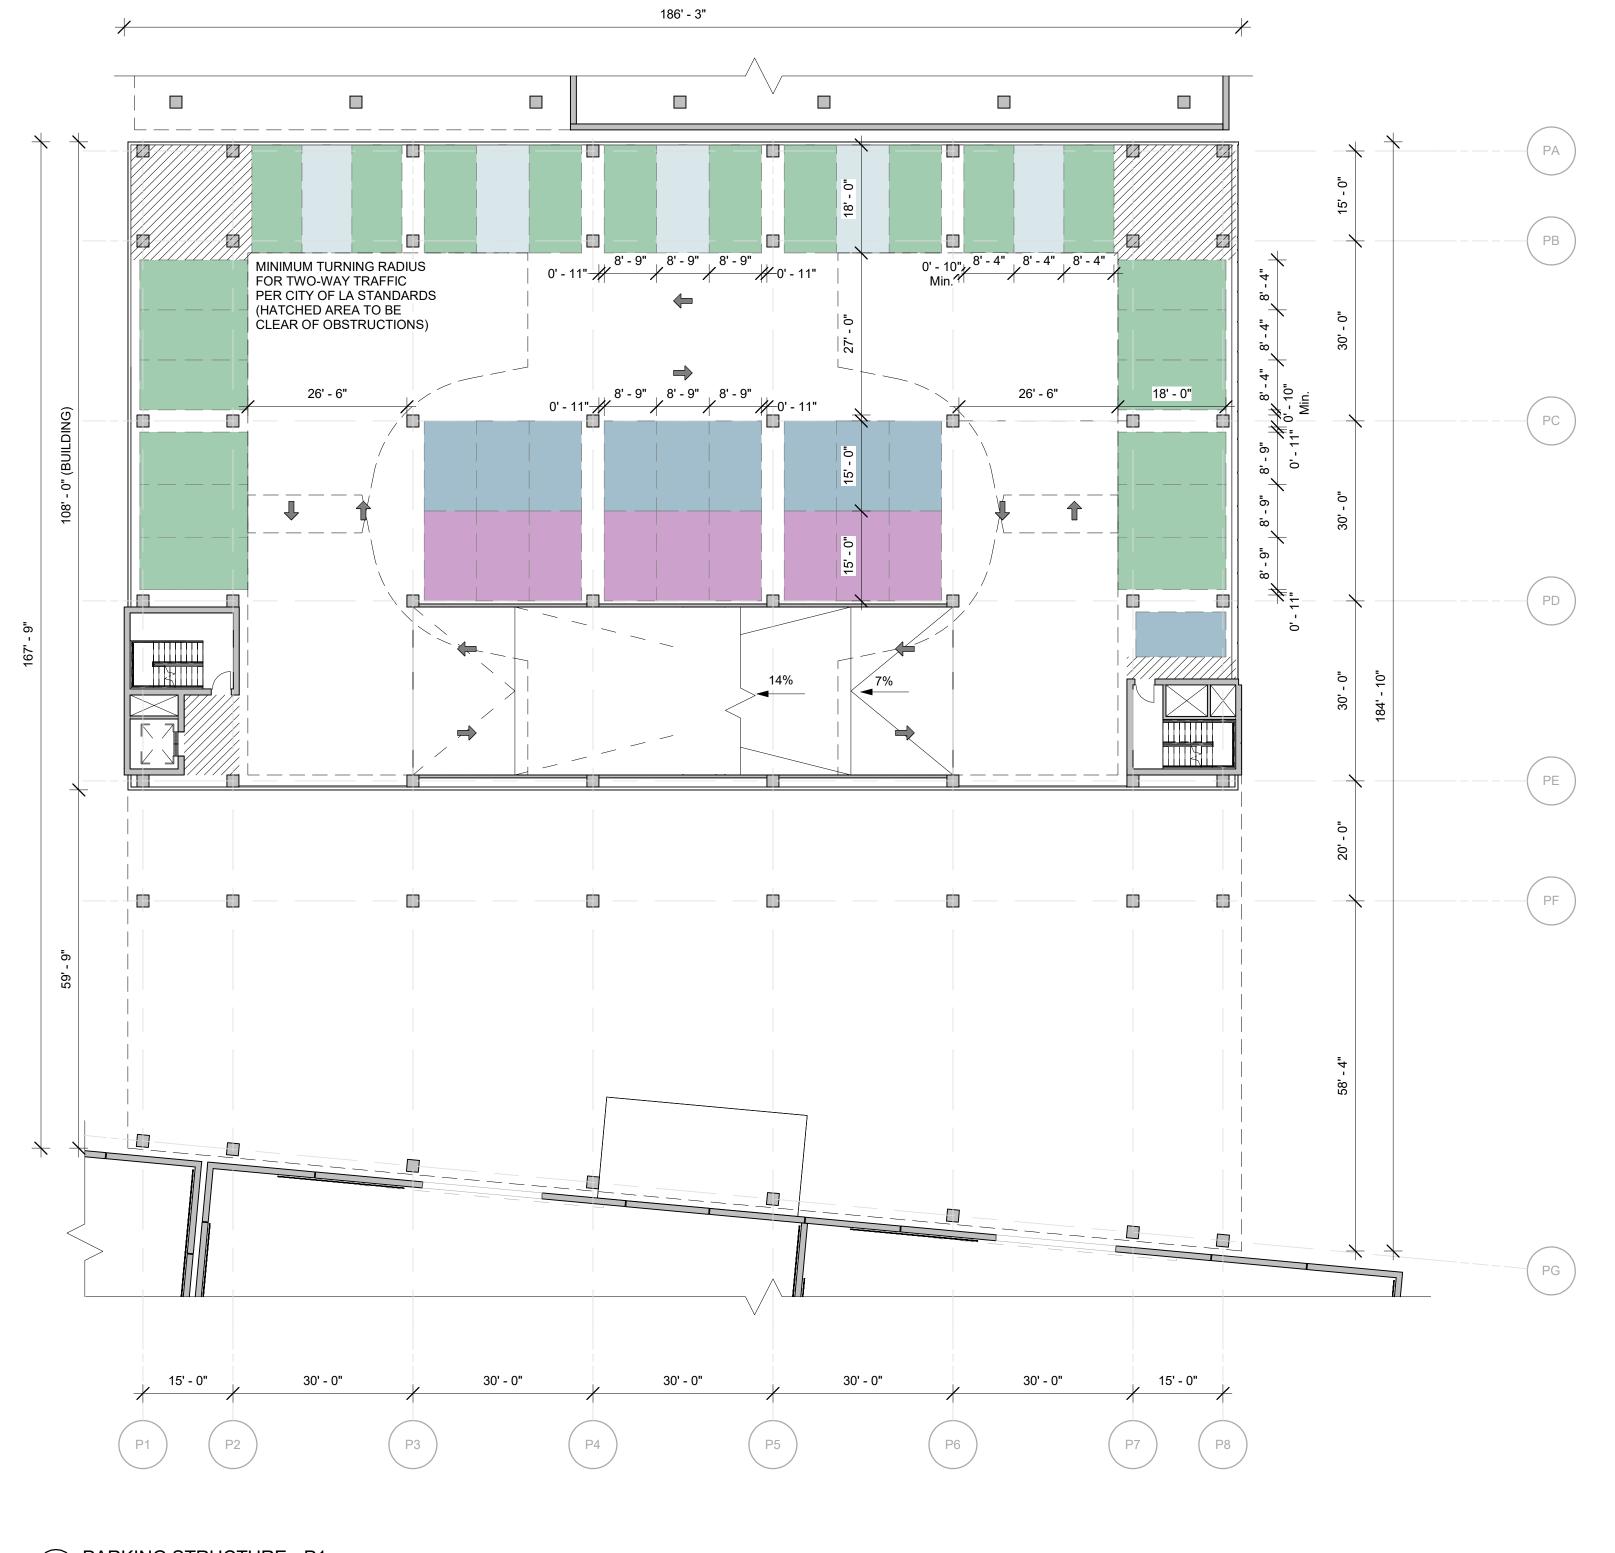

PARKING STRUCTURE - P1
1/16" = 1'-0"

PARKING STRUCTURE - BY LEVEL GROUND LEVEL

AMBULATORY EV CHARGING STATION (AA-EVCS)

COMPACT (C)

COMPACT TANDEM (CT)

ELECTRIC VEHICLE CHARGING STATION (EVCS)

STANDARD (S)

STANDARD ACCESSIBLE EV CHARGING STATION (A-EVCS) VAN ACCESSIBLE EV CHARGING STATION (AV-EVCS) P1 COMPACT (C) COMPACT TANDEM (CT) ELECTRIC VEHICLE CHARGING STATION (EVCS STANDARD (S)

PARKING	E LEGEN	D
<b>STANDARD (S)</b> 8'-4" MIN. x 18'		ELECTRIC VEHICLE CHARGING STATION (EVCS)
<b>COMPACT (C)</b> 7'-6" MIN. x 15'		STANDARD ACCESSIBLE (A) 9'-0" MIN. x 18'
STANDARD TANDEM (T) 8'-4" MIN. x 18'		VAN ACCESSIBLE (AV) 12'-0" MIN. x 18'
COMPACT TANDEM (CT) 7'-6" MIN. x 15'		ACCESSIBLE EV CHARGING
ELECTRIC VEHICLE CHARGING SPACE (EV)		STATION (A-EVCS OR AV-EVCS)

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LLC	Arts District Los	Arts District Los Angeles				
CONSULTANTS	PROJECT NO. <b>22043</b>	ADDRESS 1206 East 6th Street Los Angeles, CA 90021				

**KEY PLAN** DRAWING TITLE
PARKING STRUCTURE SCALE 1/16" = 1'-0" @ARCH E1 DRW CH APPR DRW DATE REV
GRM GRM GRM 05/12/23



0' - 11" MINIMUM TURNING RADIUS FOR TWO-WAY TRAFFIC
PER CITY OF LA STANDARDS (HATCHED AREA TO BE CLEAR OF OBSTRUCTIONS) 26' - 6" 26' - 6" 0' - 11" | 8' - 9" | 8' - 9" | 8' - 9" | 0' - 11" 26' - 8" 30' - 0" 30' - 0" 30' - 0"

186' - 3"

- CONNECTION TO AMENITY DECK

PARKING STRUCTURE - P2 / AMENITY LEVEL

1/16" = 1'-0"

PARKING STRUCTURE - BY LEVEL	
TYPE	STALLS
AMENITY LEVEL	
COMPACT (C)	15
COMPACT TANDEM (CT)	9
ELECTRIC VEHICLE CHARGING STATION (EVCS)	40
STANDARD (S)	14
	78
P3	
COMPACT (C)	15
COMPACT TANDEM (CT)	9
ELECTRIC VEHICLE CHARGING STATION (EVCS)	42
STANDARD (S)	14
	80

Los Angeles, CA

PARKING LEGEND							
<b>STANDARD (S)</b> 8'-4" MIN. x 18'		ELECTRIC VEHICLE CHARGING STATION (EVCS)					
<b>COMPACT (C)</b> 7'-6" MIN. x 15'		STANDARD ACCESSIBLE (A) 9'-0" MIN. x 18'					
STANDARD TANDEM (T) 8'-4" MIN. x 18'		VAN ACCESSIBLE (AV) 12'-0" MIN. x 18'					
COMPACT TANDEM (CT) 7'-6" MIN. x 15'		ACCESSIBLE EV CHARGING					
ELECTRIC VEHICLE CHARGING SPACE (EV)		STATION (A-EVCS OR AV-EVCS)					

PG

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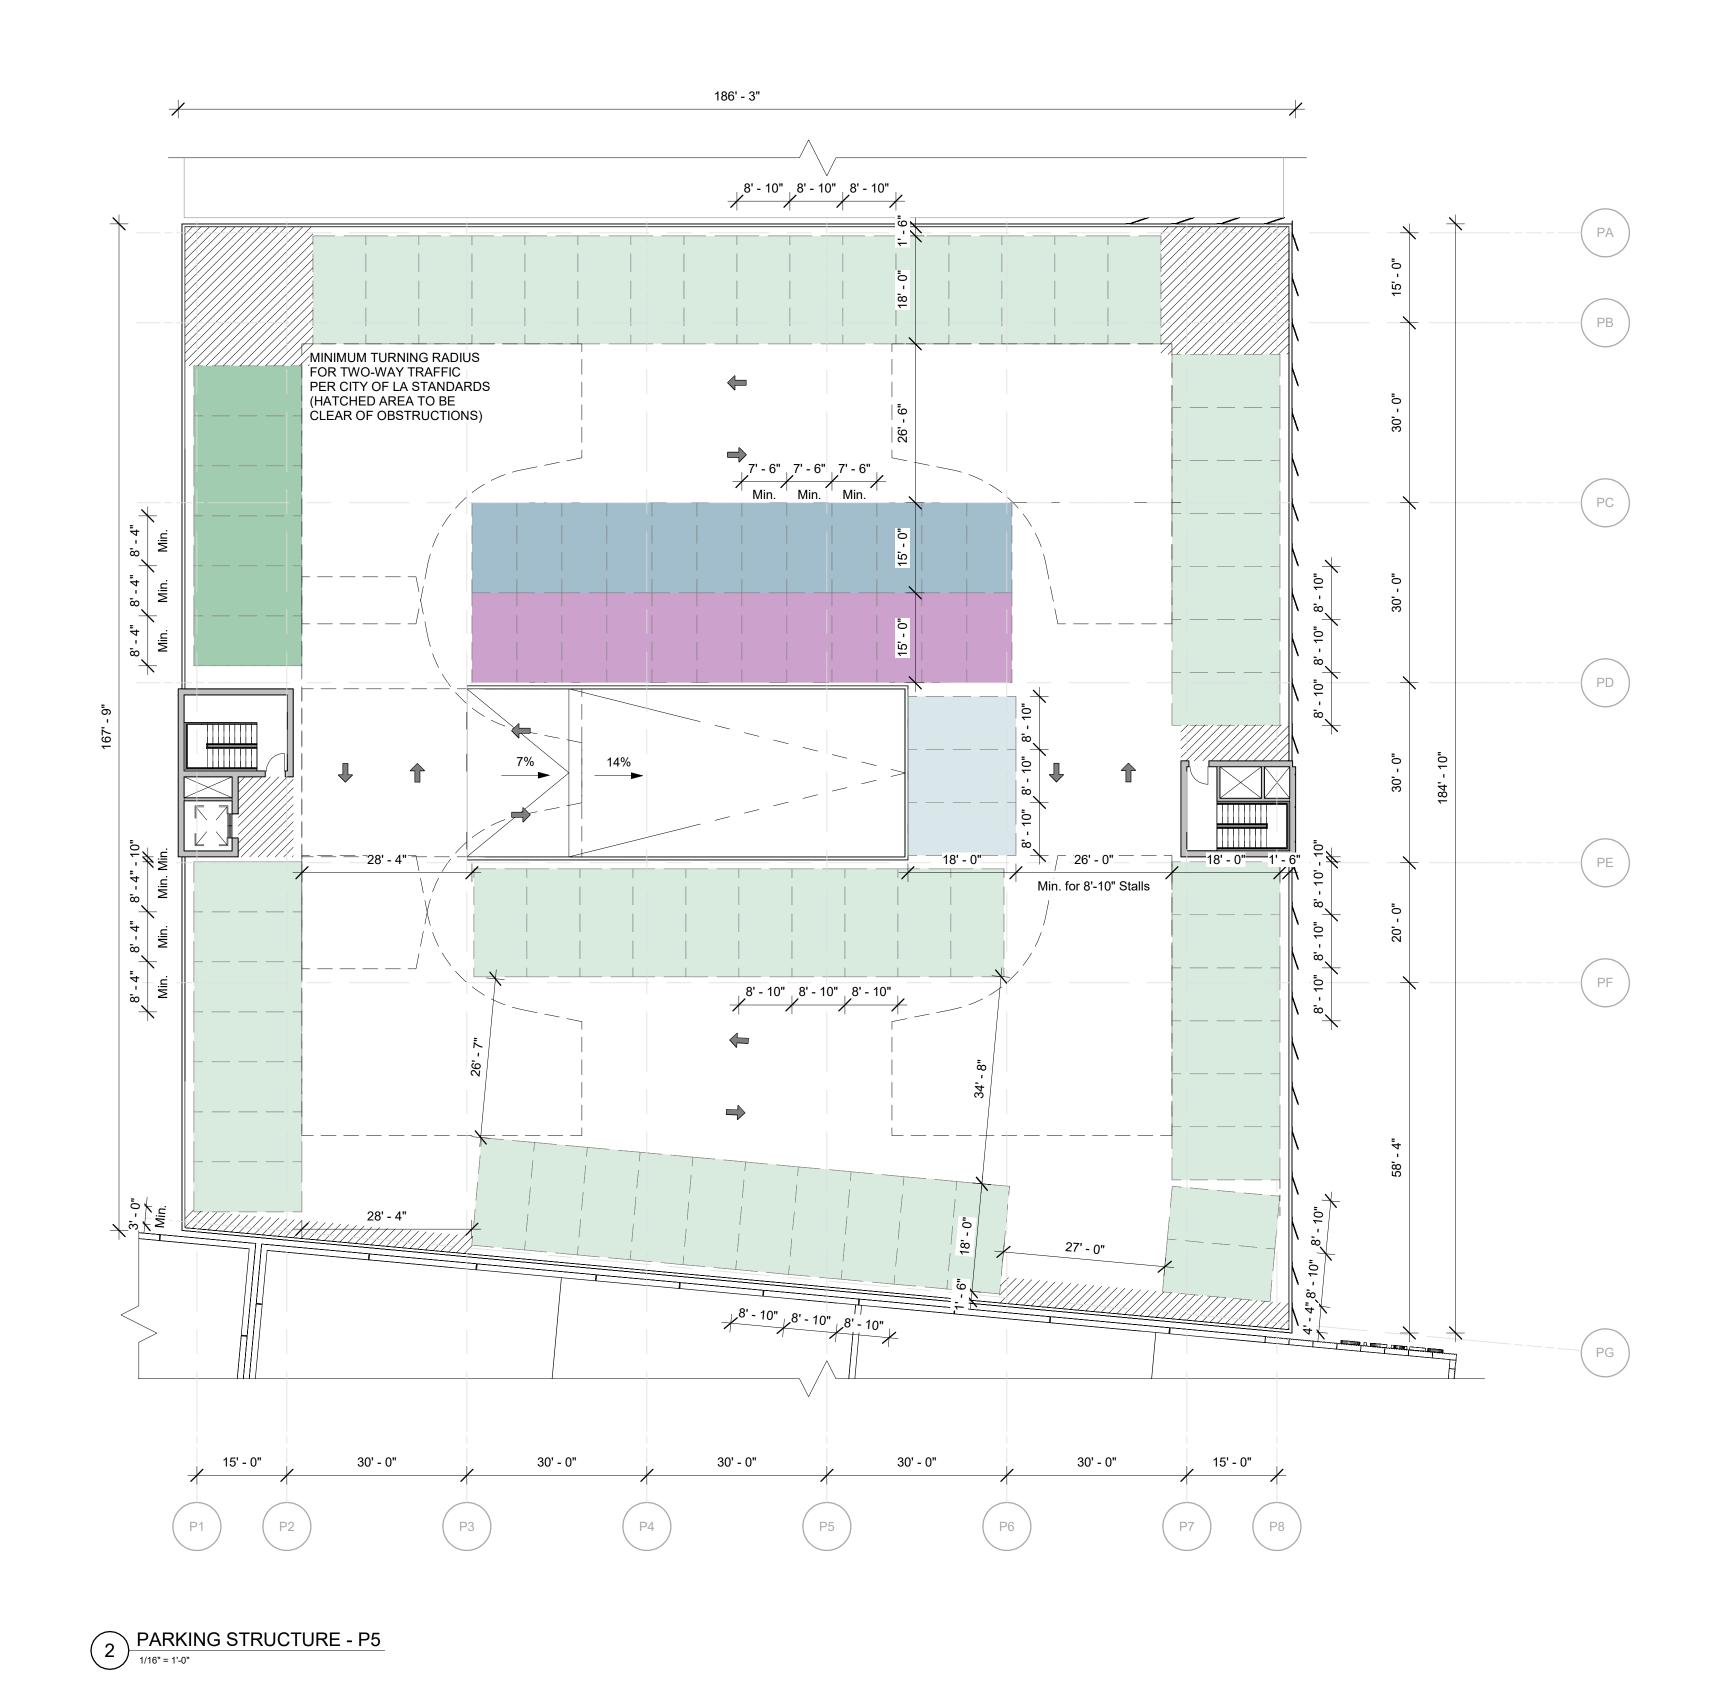
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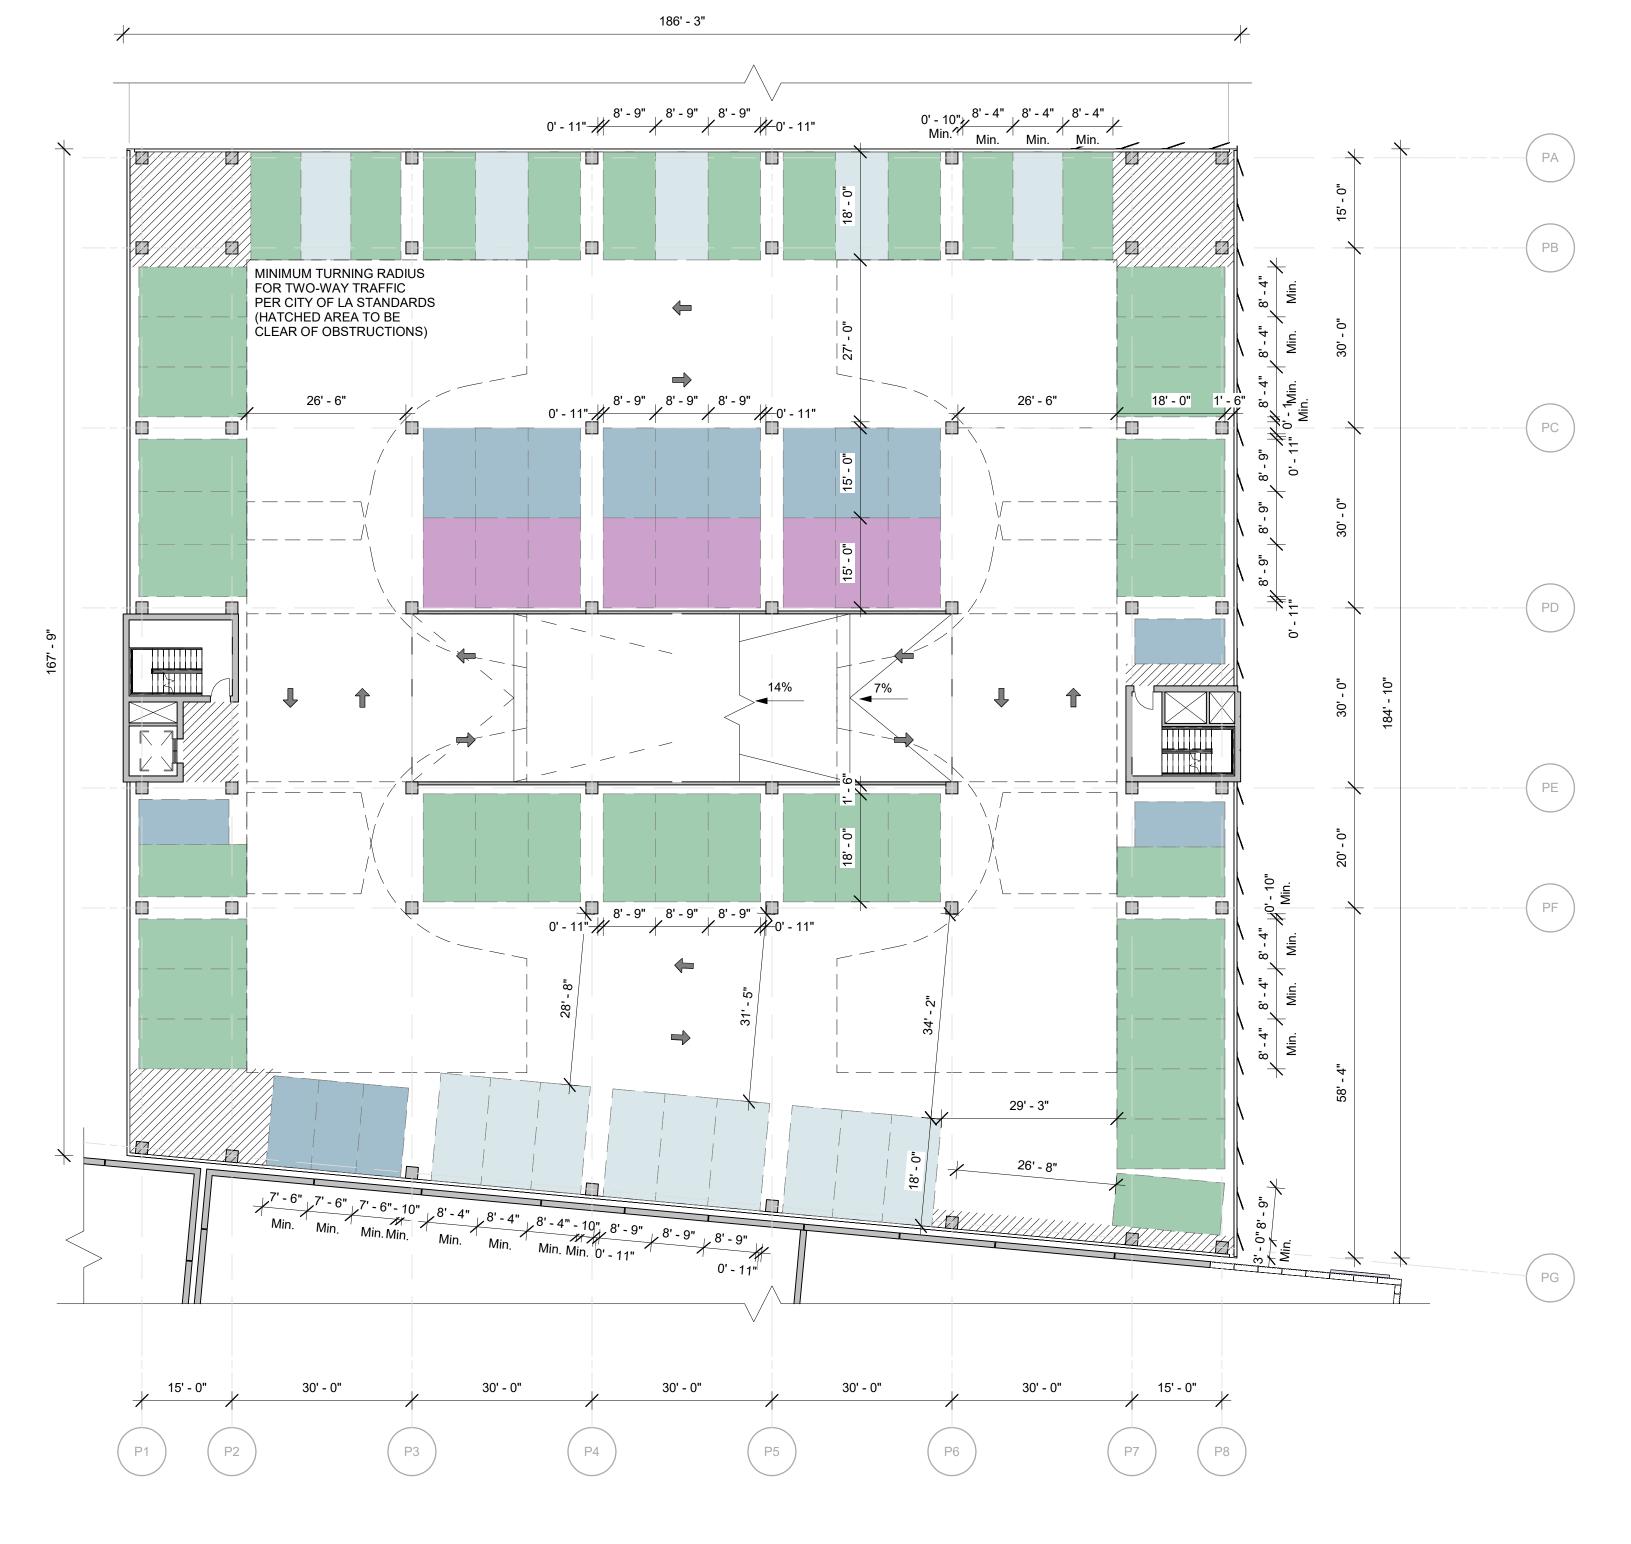
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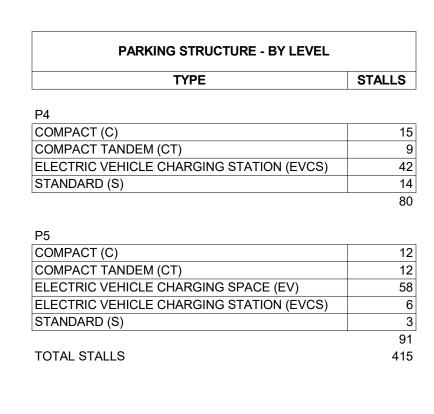
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GRM GRM GRM 05/12/23 DRAWING NO. **A03-1031** 

DRAWING TITLE
PARKING STRUCTURE





PARKING STRUCTURE - P4
1/16" = 1'-0"



PARKING	ELEGEN	D
<b>STANDARD (S)</b> 8'-4" MIN. x 18'		ELECTRIC VEHICLE CHARGING STATION (EVCS)
<b>COMPACT (C)</b> 7'-6" MIN. x 15'		STANDARD ACCESSIBLE (A) 9'-0" MIN. x 18'
STANDARD TANDEM (T) 8'-4" MIN. x 18'		VAN ACCESSIBLE (AV) 12'-0" MIN. x 18'
COMPACT TANDEM (CT) 7'-6" MIN. x 15'		ACCESSIBLE EV CHARGING
ELECTRIC VEHICLE CHARGING SPACE (EV)		STATION (A-EVCS OR AV-EVCS)

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LLC	Arts District Los	Angeles						SCALE <b>1/16" = 1'-0"</b> <b>@ARCH E1</b>	STATUS Entitlement Set
CONSULTANTS	PROJECT NO. <b>22043</b>	ADDRESS 1206 East 6th Street Los Angeles, CA						DRW CH APPR GRM GRM GRM	DRW DATE REV <b>05/12/23</b>
		90021					NORTH (T)	DRAWING NO. <b>A03-1032</b>	



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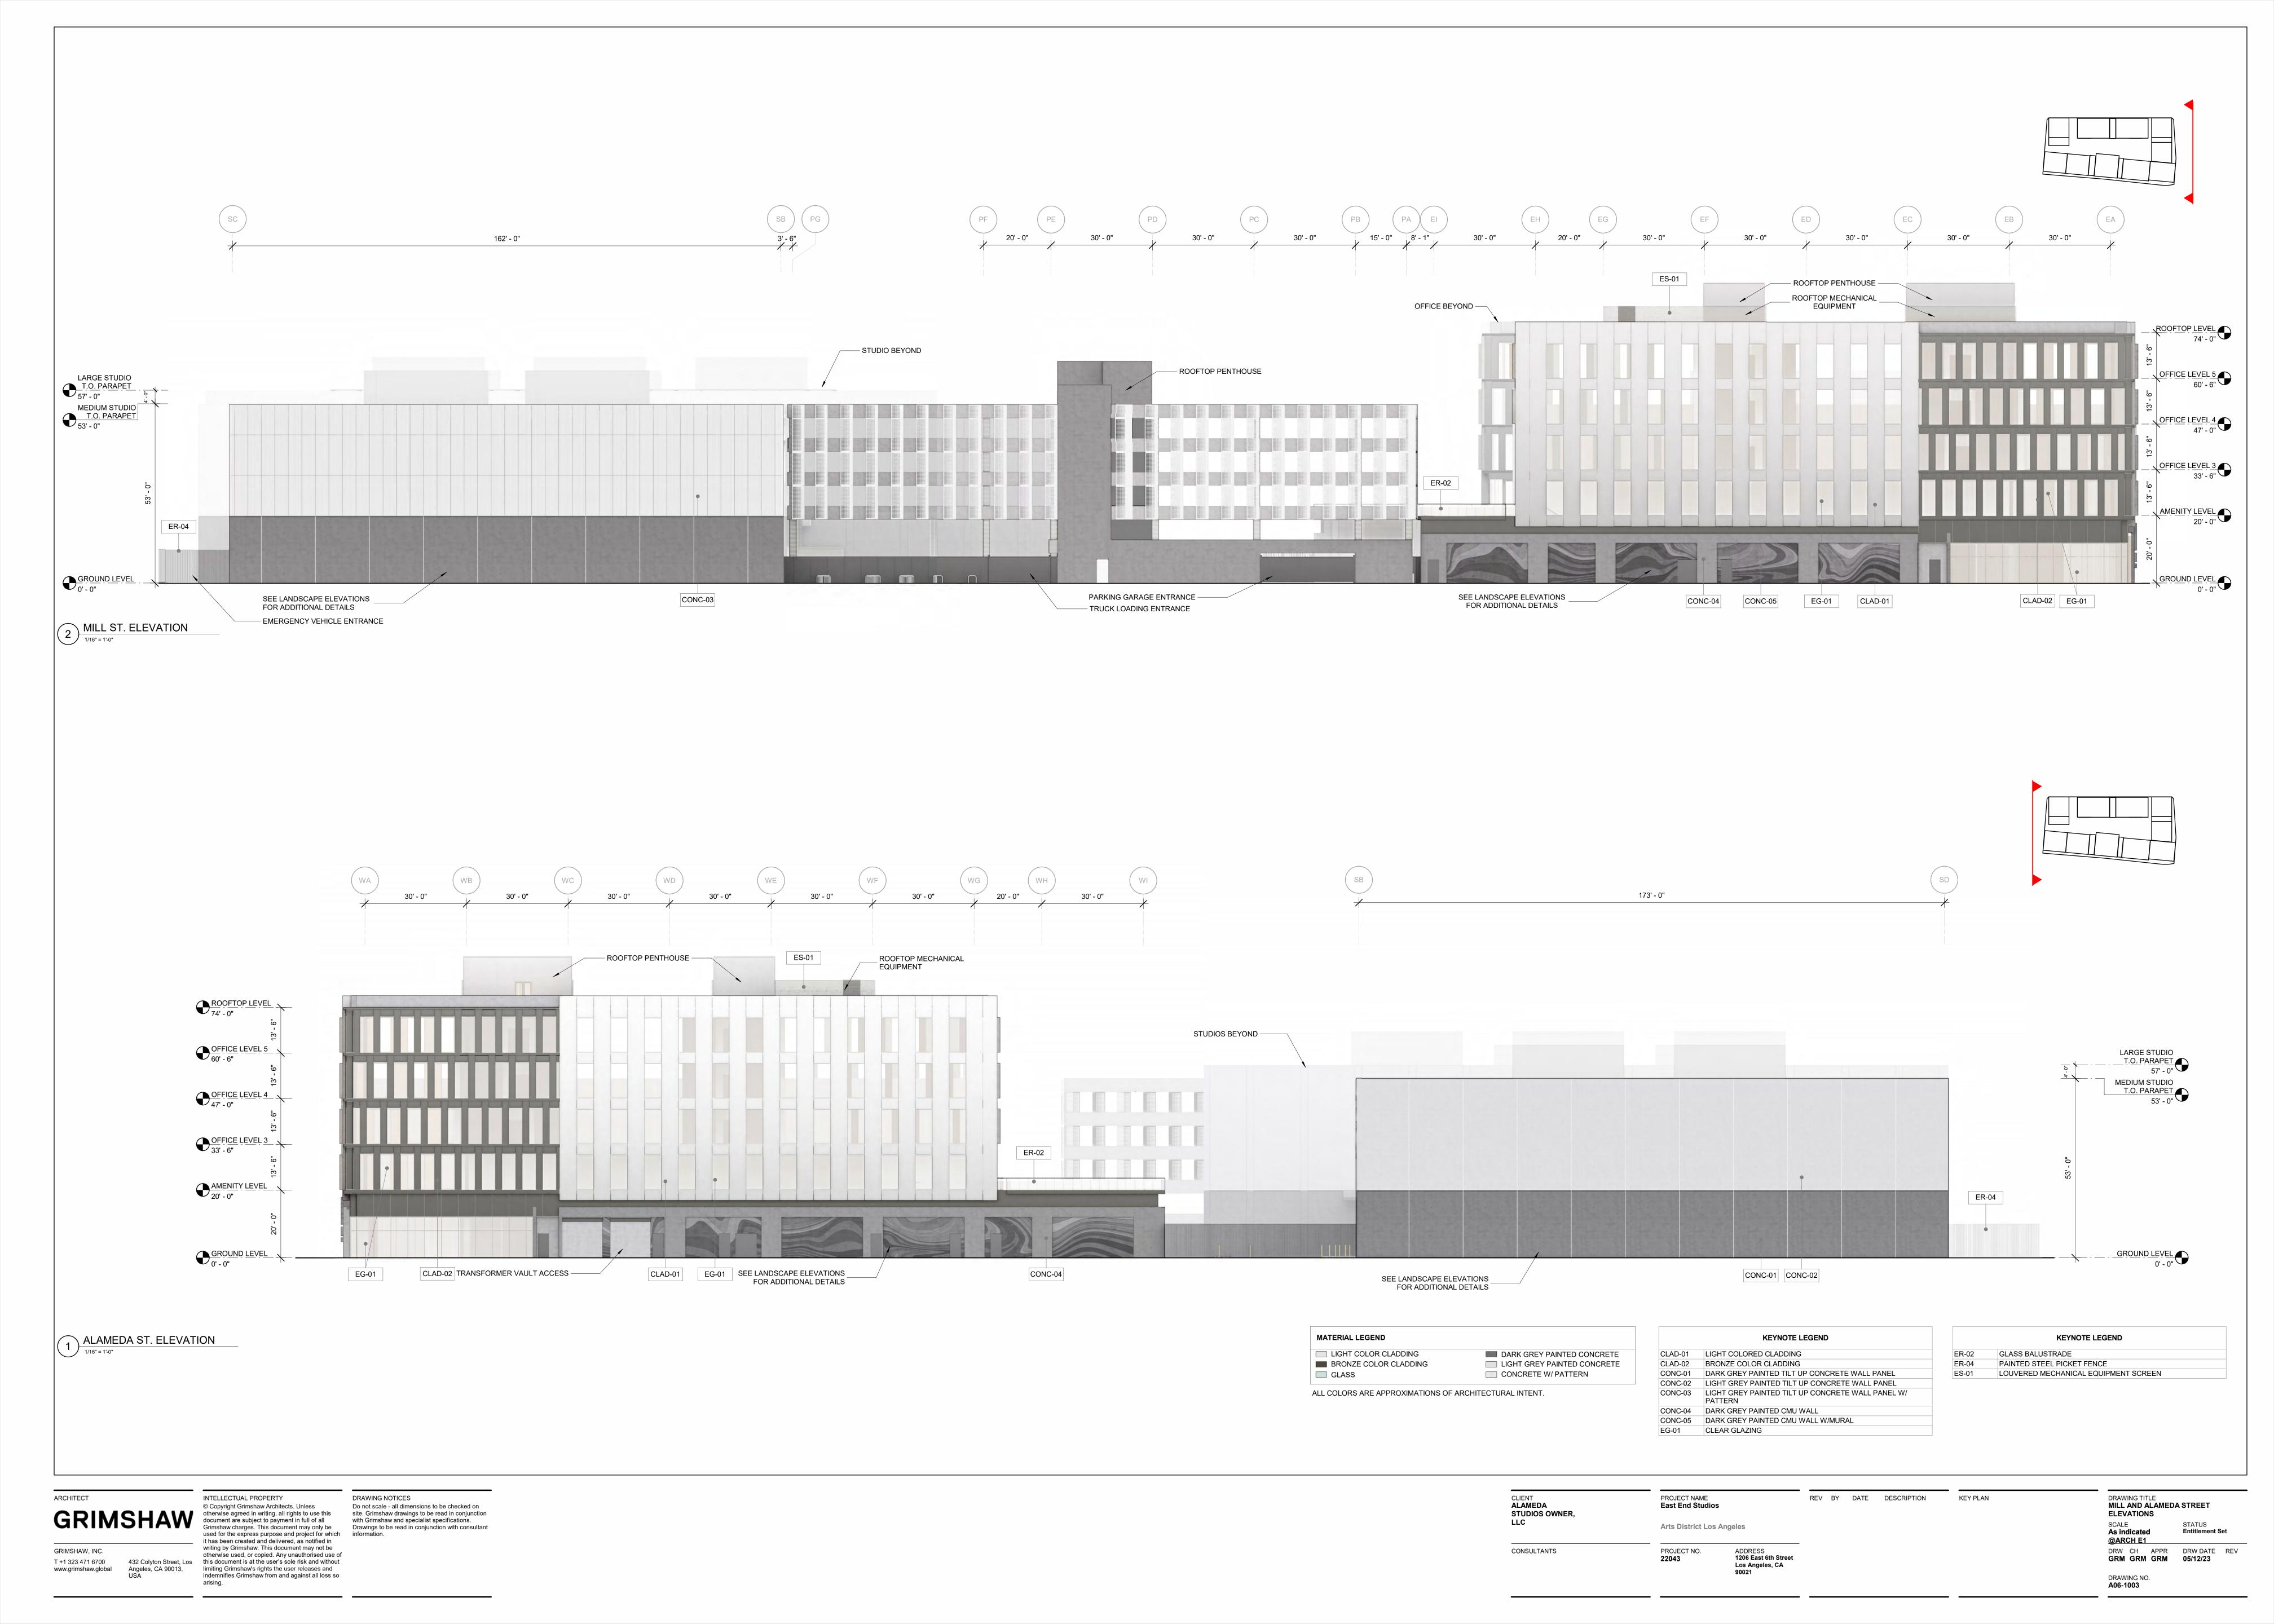
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STUDIOS OWNER, PROJECT NAME
East End Studios Arts District Los Angeles PROJECT NO. **22043** CONSULTANTS ADDRESS 1206 East 6th Street Los Angeles, CA 90021

KEY PLAN

DRAWING TITLE SITE SECTIONS SCALE 1/32" = 1'-0" @ARCH E1

DRAWING NO. **A07-1001** 


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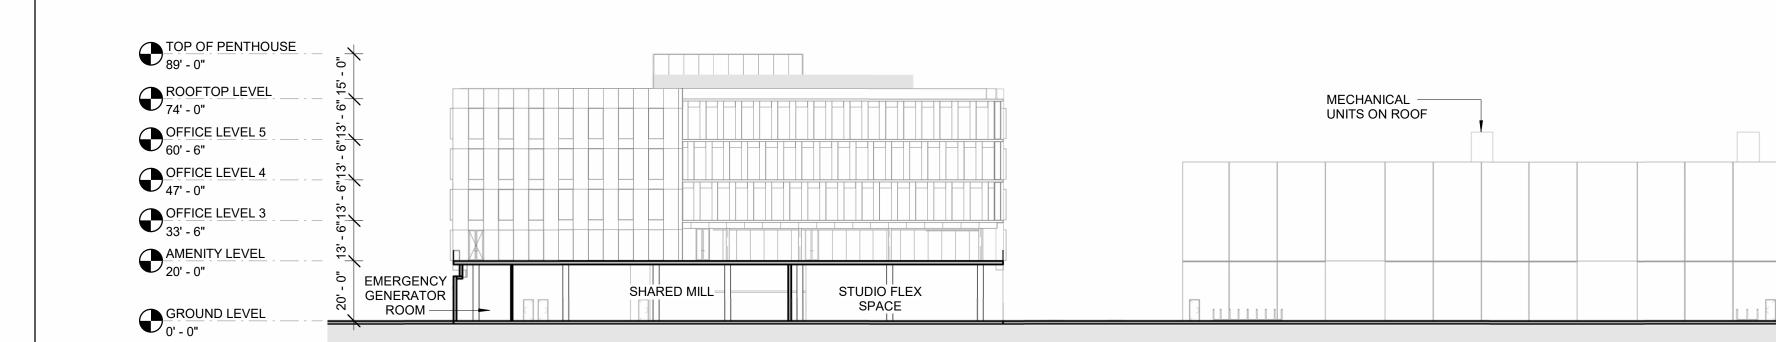
REV BY DATE DESCRIPTION


N-S SITE SECTION


1/32" = 1'-0"


MECHANICAL — UNITS ON ROOF TOP OF PENTHOUSE
89' - 0" MECHANICAL — UNITS ON ROOF LARGE STUDIO
T.O. PARAPET
57' - 0" MEDIUM STUDIO T.O. PARAPET 53' - 0" AMENITY LEVEL 20' - 0" -∤STUDIO 3---STUDIO 12 GROUND LEVEL 0' - 0"



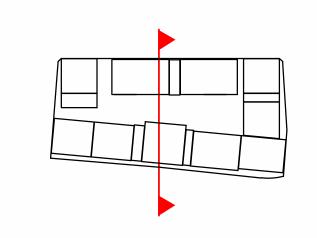

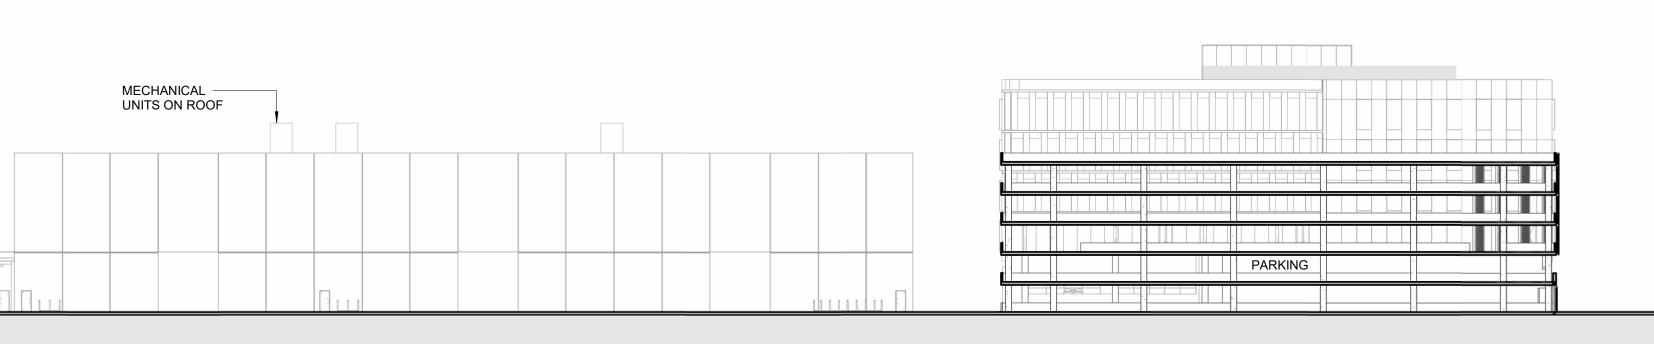


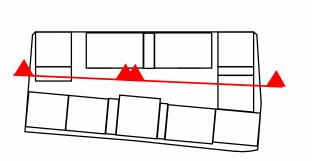

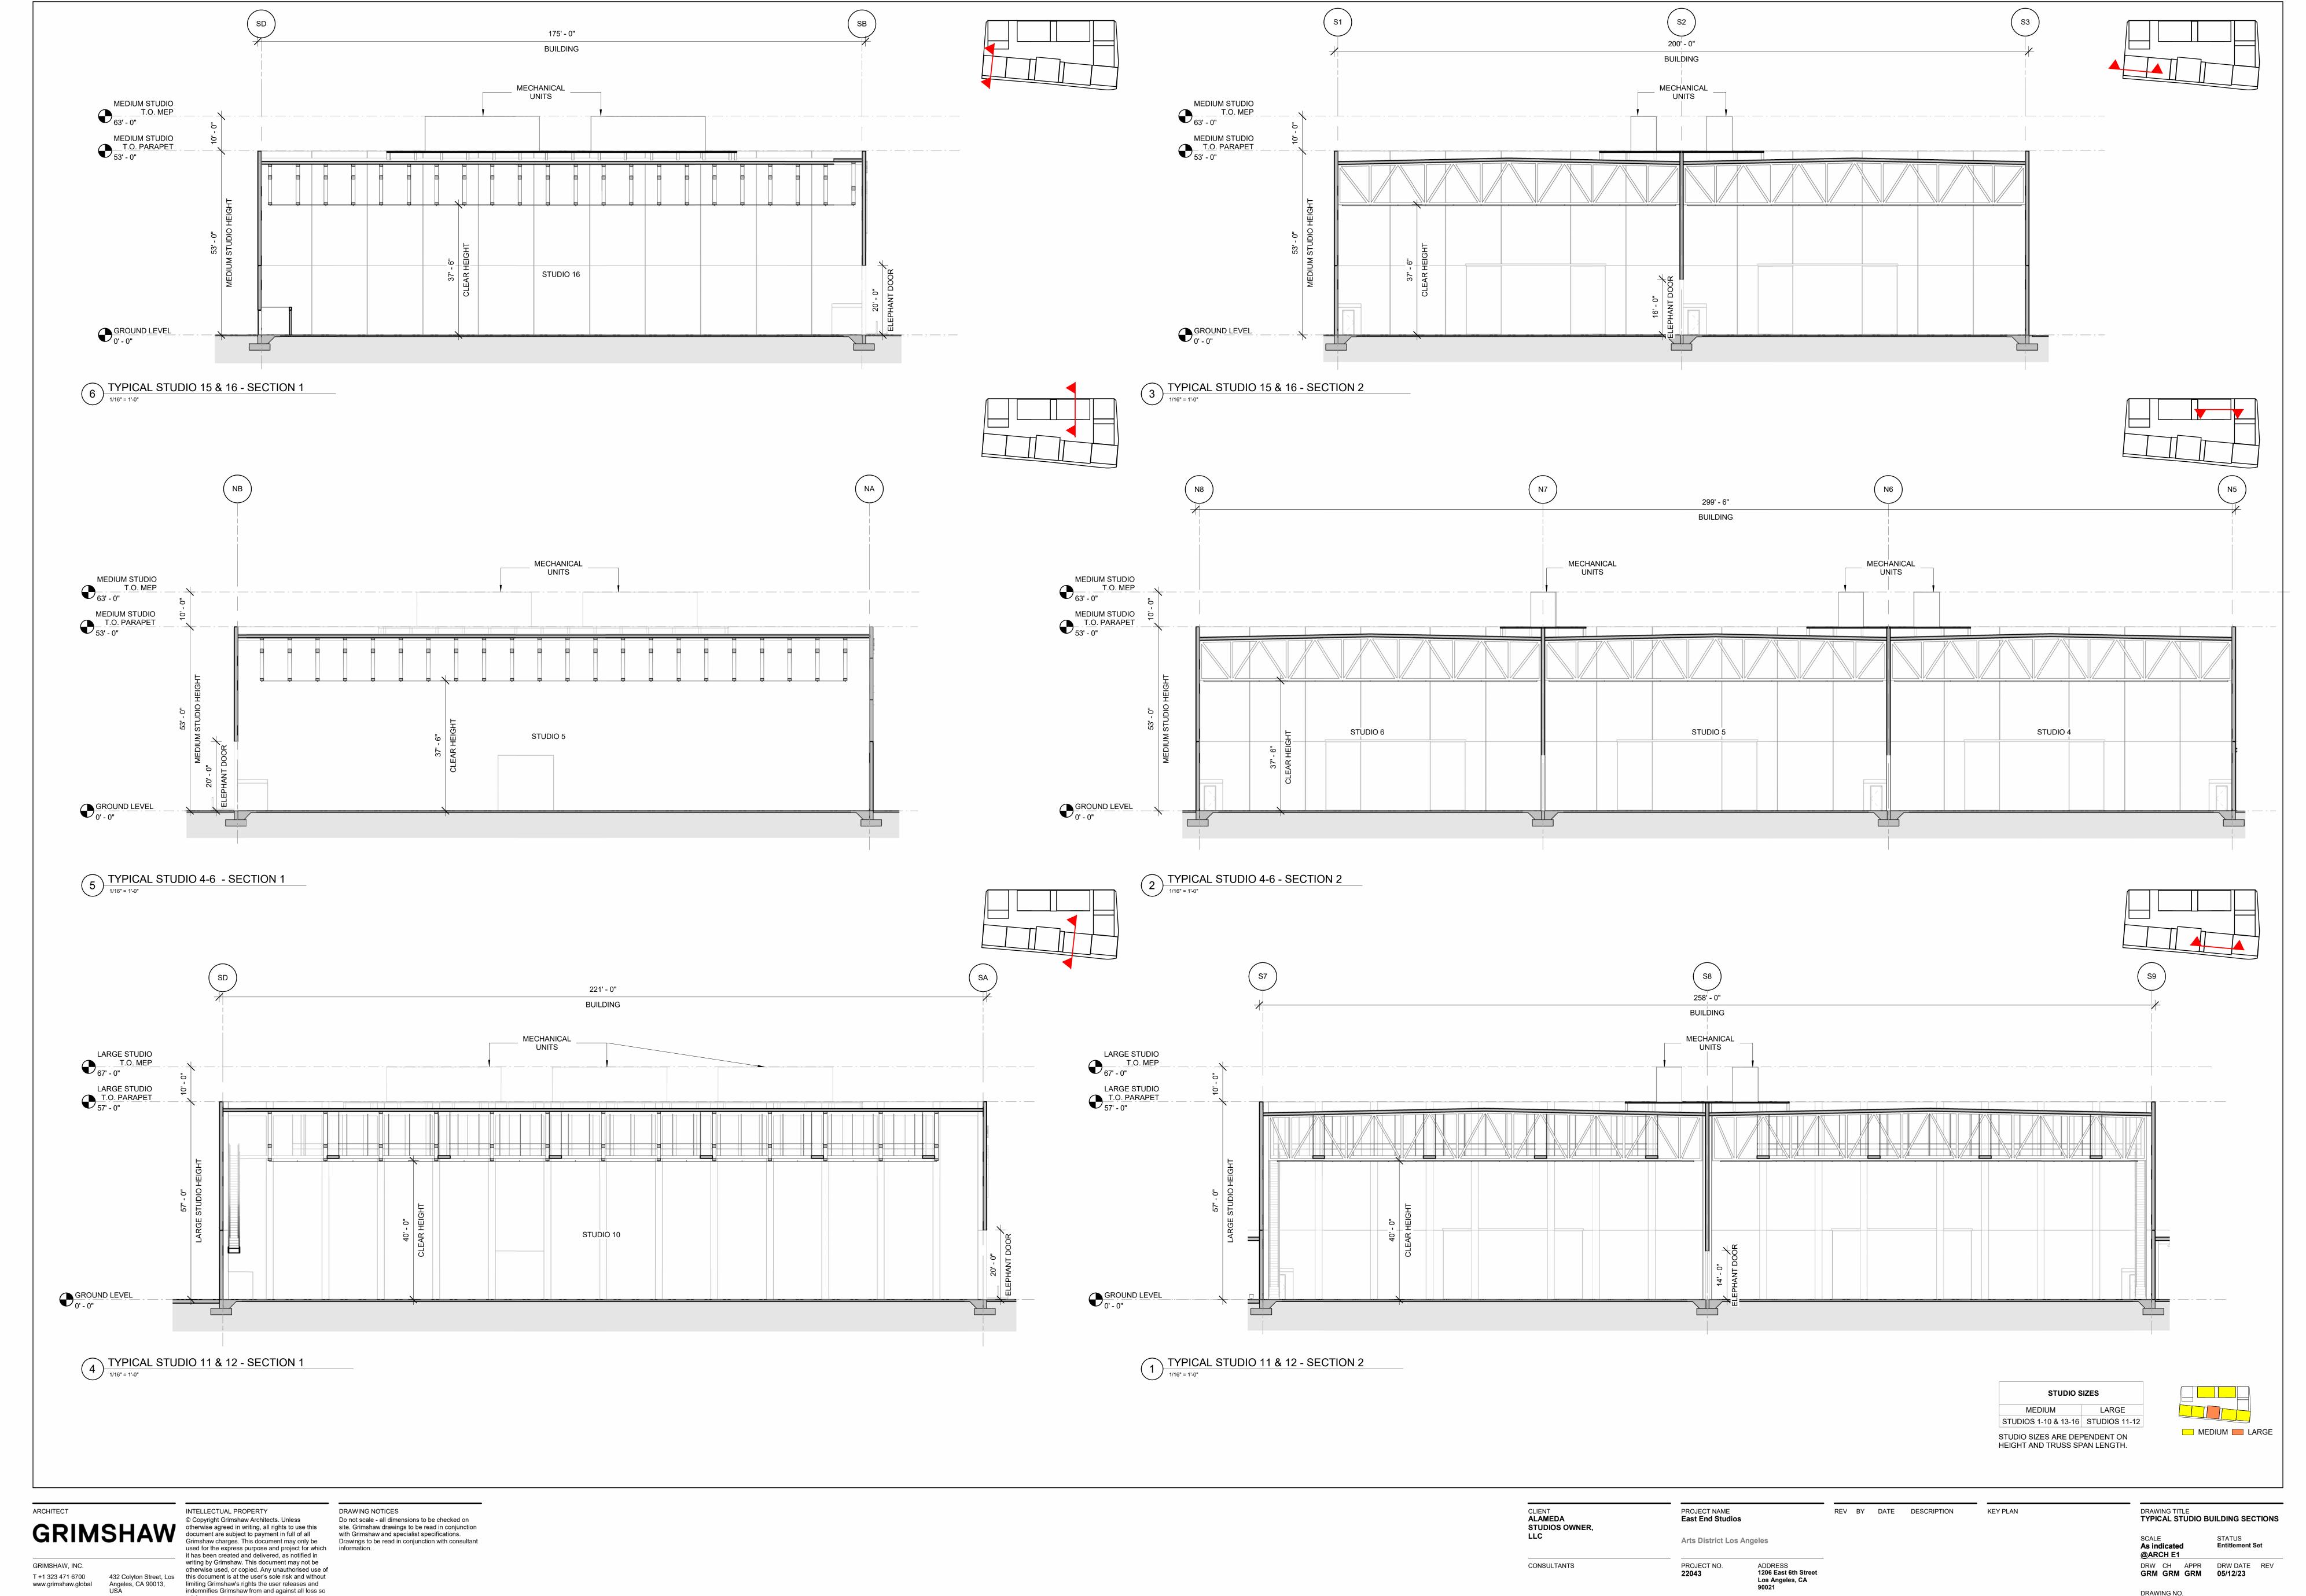

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DRW CH APPR DRW DATE REV
LAN LAN 05/12/2023

NORTH ( DRAWING NO. **CG101** Date: 6/15/2023 Time: 09:59 User: nluck Style Table: Langan.stb Layout: CG101 Document Code: 700118201-0101-CG101-0101

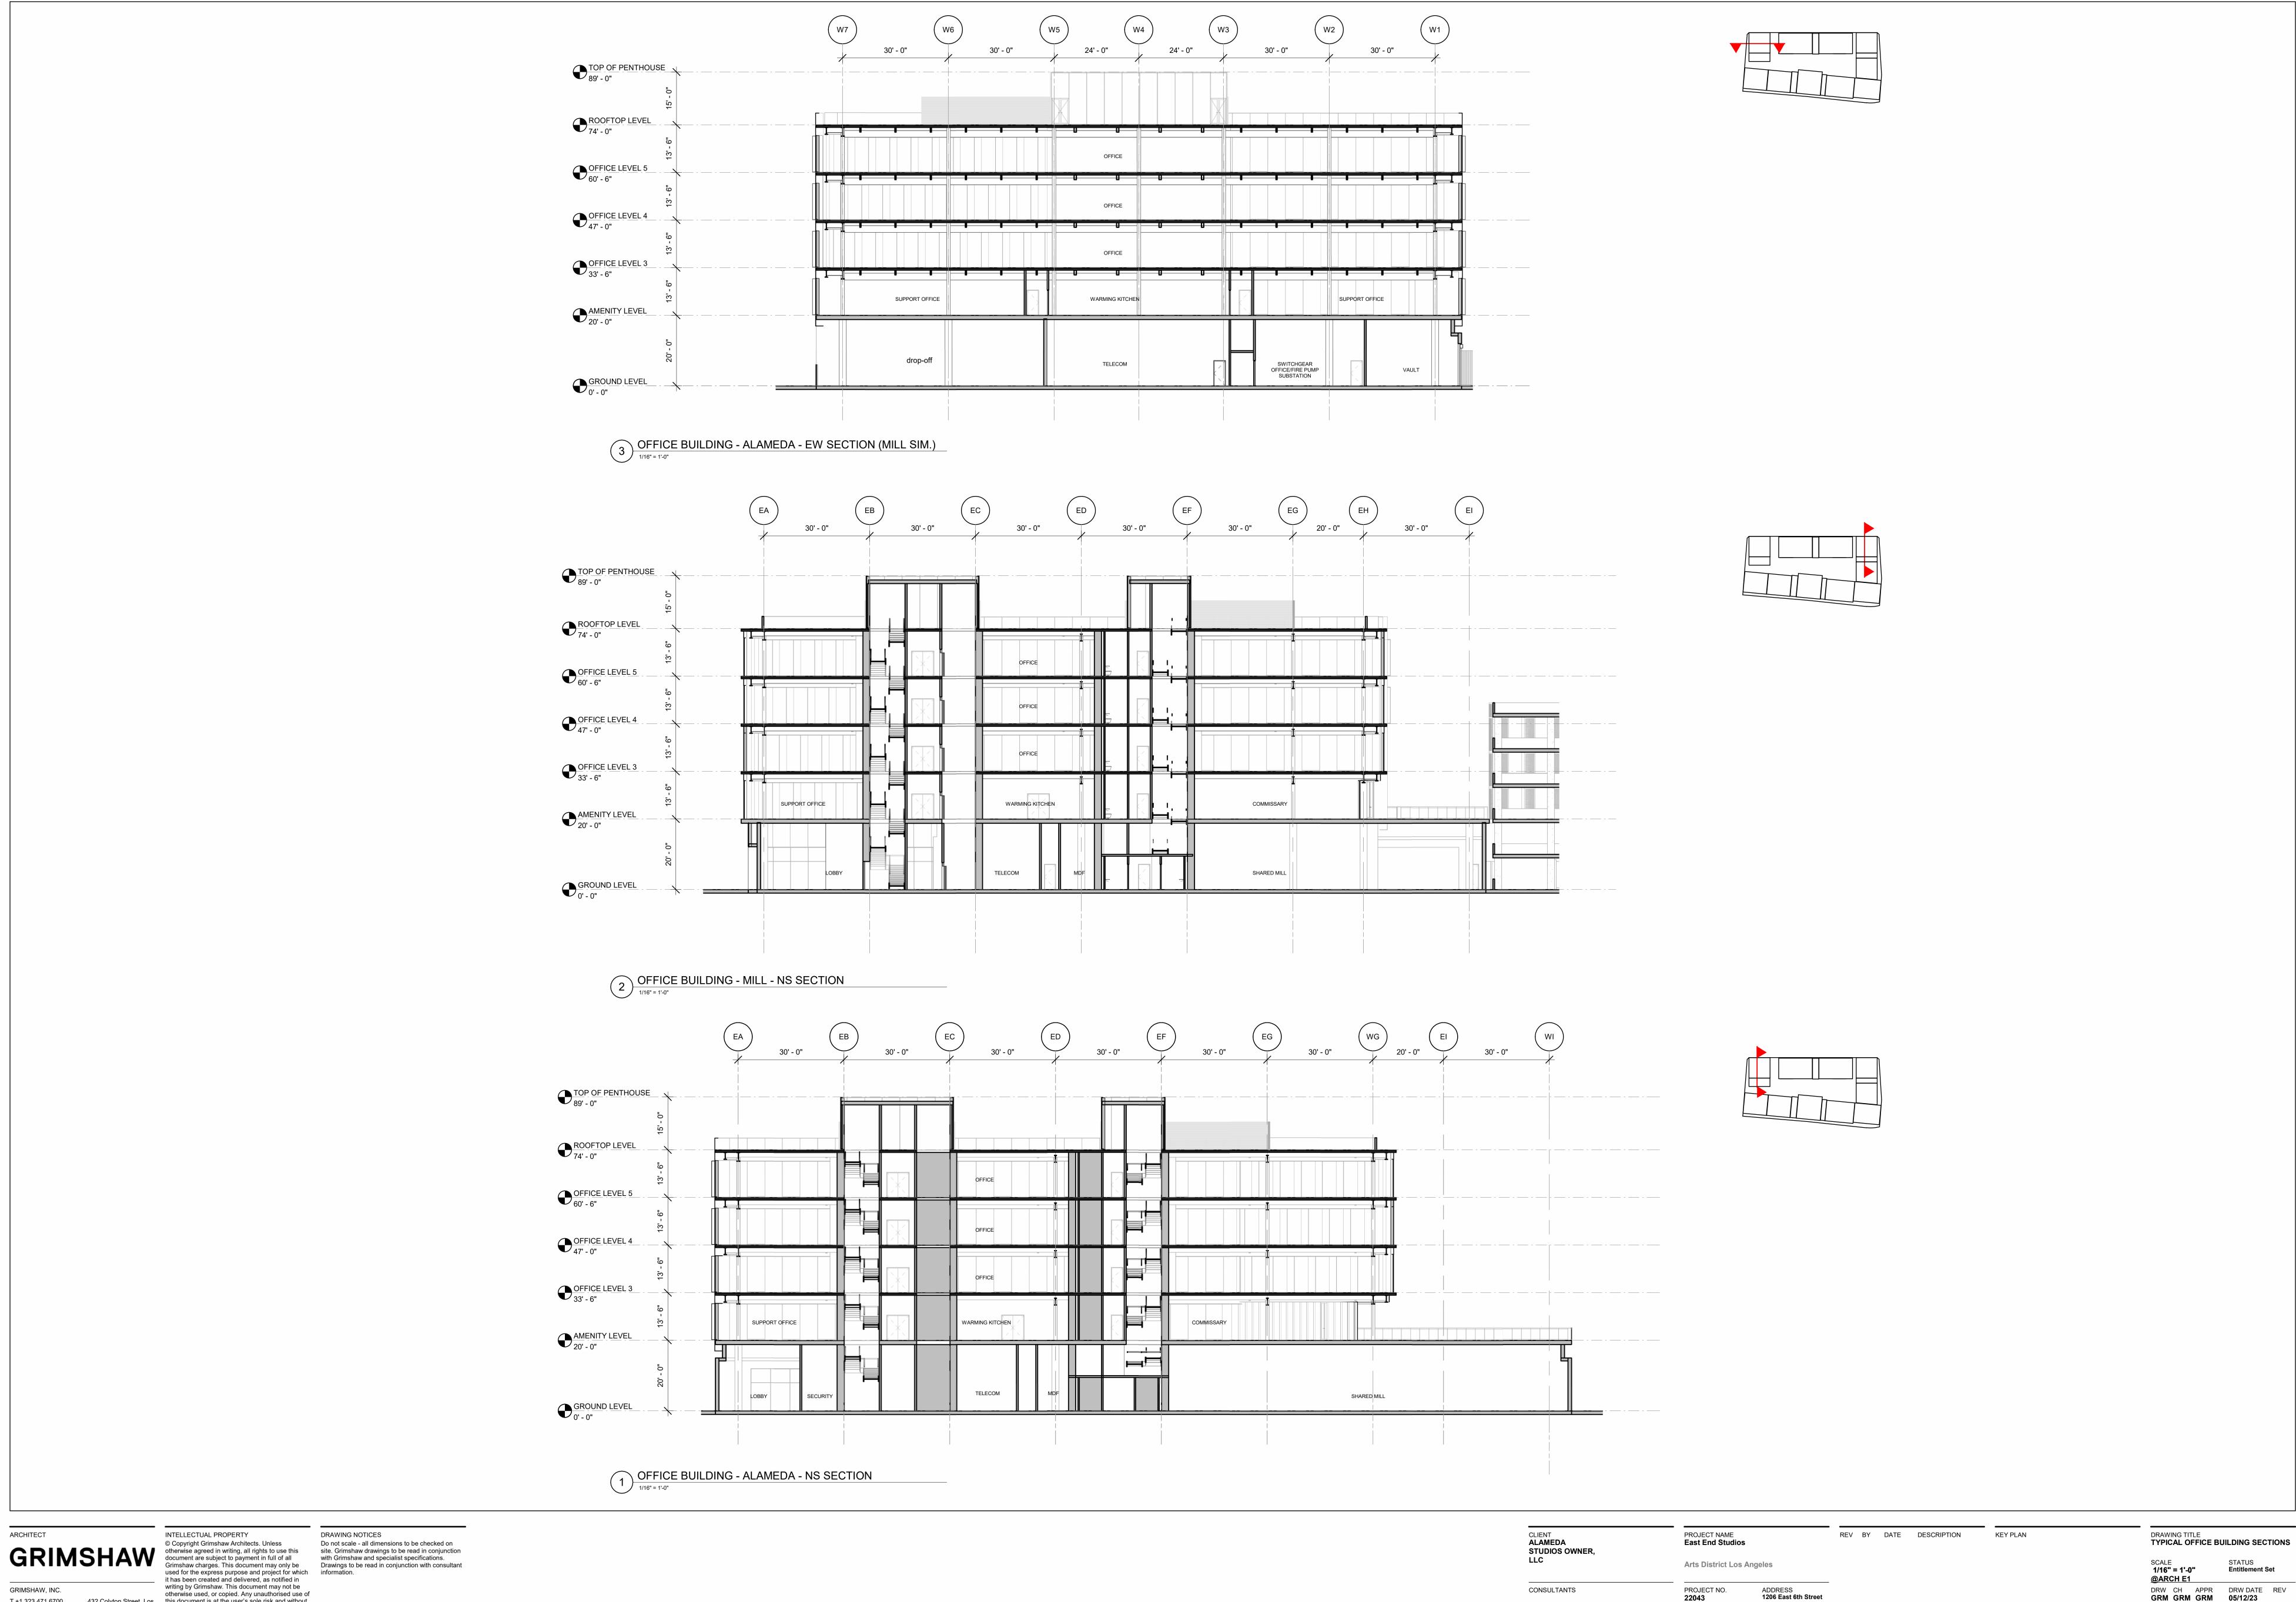

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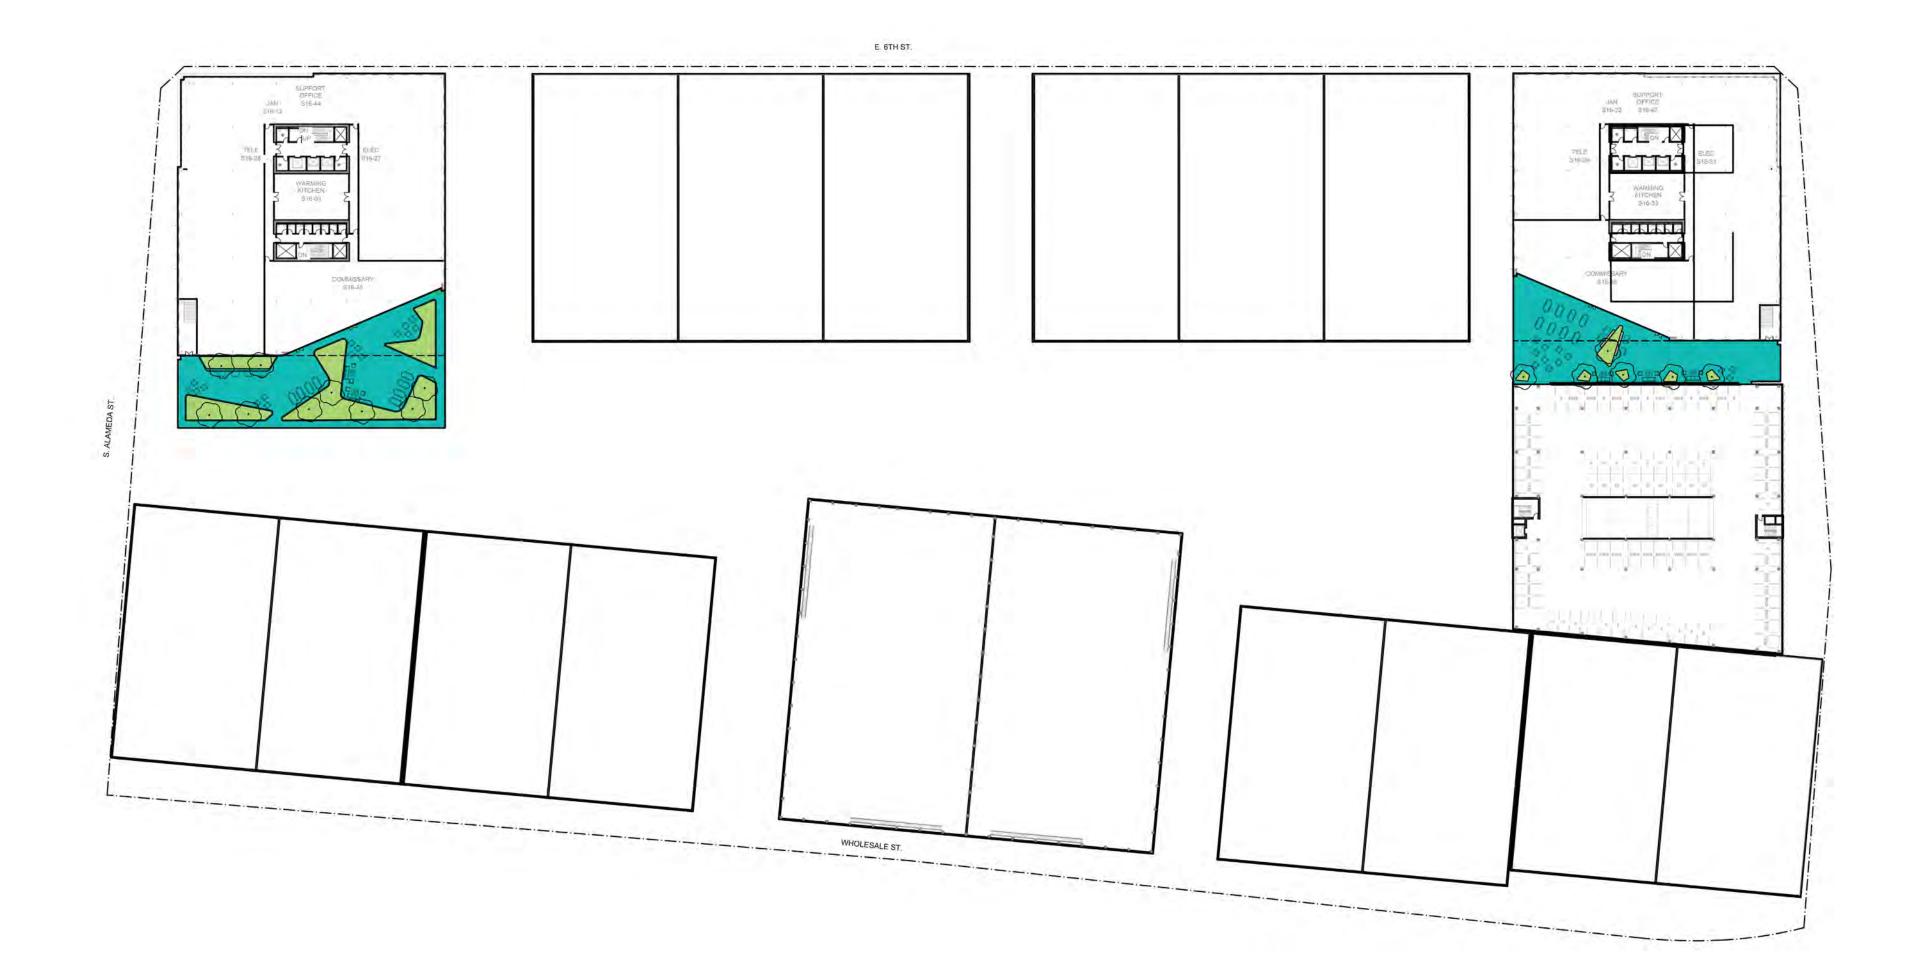
Arts District Los Angeles ADDRESS 1206 East 6th Street

Los Angeles, CA


1" = 40'-0" DRW CH APPR DRW DATE REV LAN LAN 05/12/2023

NORTH ( DRAWING NO. **CS101** Date: 5/12/2023 Time: 16:07 User: nluck Style Table: Langan.stb Layout: CS101 Document Code: 700118201-0101-CU201-0101





OPEN SPACE DIAGRAM - GROUND FLOOR

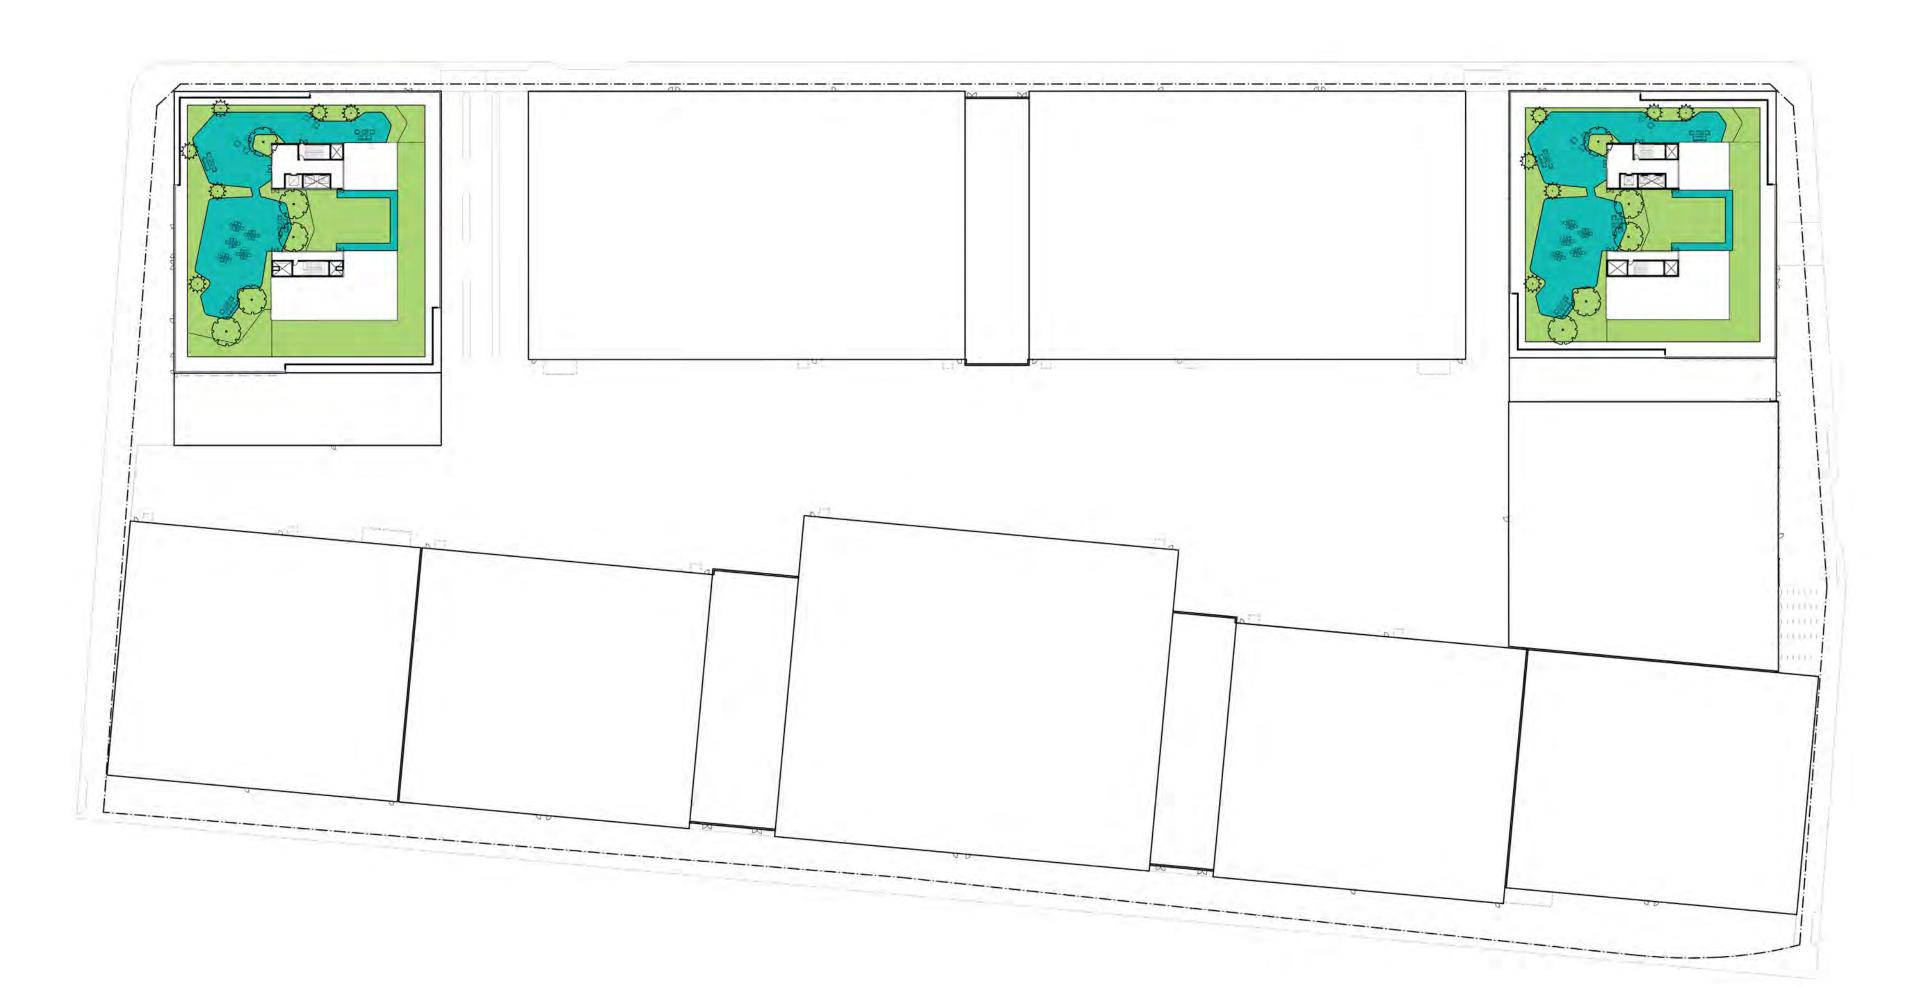

**OPEN SPACE CALCULATIONS** 

# LEVEL 1 - GROUND FLOOR

RIGHT OF WAY (ROW)

OPEN SPACE DIAGRAM - LEVEL 02

NON-PERMEABLE: 15,953 SF PERMEABLE: 16,727 SF TOTAL: 32,680 SF

### PRIVATE

NON-PERMEABLE: 206,132 SF PERMEABLE: 15,926 SF TOTAL: 222,058 SF

## **LEVEL 02 - AMENITY DECK**

WEST BUILDING

NON-PERMEABLE: 7,580 SF PERMEABLE: 4,584 SF TOTAL: 12,164 SF

### EAST BUILDING

NON-PERMEABLE: 7,500 SF PERMEABLE: 448 SF TOTAL: 7,948 SF

### **ROOF LEVEL**

WEST BUILDING

NON-PERMEABLE: 8,023 SF PERMEABLE: 12,965 SF TOTAL: 20,988 SF

## EAST BUILDING

NON-PERMEABLE: 8,003 SF PERMEABLE: 11,066 SF TOTAL: 19,069 SF

**CALCULATIONS** 

### A. EXISTING TREES

**TOTAL STREET PARKWAY TREES:** E. 6TH STREET: ALAMEDA STREET: WHOLESALE STREET: MILL STREET:

B. TREE REQUIREMENT CALCULATION CITY OF LOS ANGELES LANDSCAPE ORDINANCE

12.42.C.A LOS ANGELES MUNICIPAL CODE AT LEAST ONE TREE, WHICH NOT BE A PALM, SHALL BE PROVIDED IN THE PROJECT FOR EACH 500 SF OF LANDSCAPED AREA IN THE PROJECT. A MINIMUM OF 100 SF OF UNPAVED AREA SHALL BE PROVIDED AT THE BASE OF EACH TREEE, THE SHORTEST DIMENSION OF WHICH SHALL BE 4 FEET MINIMUM, TO ALLOW FOR WATER INFILRTRATION AND GAS EXCHANGE.

#### QUALIFIED LANDSCAPE AREA: 62,035SF / 500 =124 **REQUIRED TREES**

PROPOSED TREES **LEVEL 1 STREET ROW TREES:** ALAMEDA STREET: E. 6TH STREET: WHOLESALE STREET: MILL STREET: **LEVEL 1 PRIVATE TREES:** ALAMEDA ST. FRONTAGE: E. 6TH STREET. FRONTAGE: WHOLESALE ST. FRONTAGE: MILL ST. FRONTAGE: **LEVEL 2 TOTAL TREES:** WEST BUILDING: **EAST BUILDING: ROOF LEVEL TOTAL TREES:** WEST BUILDING: **EAST BUILDING:** 

### C. OPEN SPACE CALCULATIONS

**TOTAL PROPOSED TREES:** 

32,680 LEVEL 1 TOTAL (ROW): NON-PERMEABLE (ROW PAVING): 15,953 PERMEABLE (ROW PLANTING): 16,727 LEVEL 1 TOTAL (PRIVATE): 222,058 NON-PERMABLE (INTERIOR BASECAMP): 199,301 NON-PERMEABLE (PRIVATE PAVING): 6,831 PERMEABLE (PRIVATE PLANTING): 15,926 20,112 **LEVEL 2 TOTAL:** NON-PERMEABLE (PAVING): 15,080 PERMEABLE (PLANTING): 5,032 40,057 ROOF LEVEL TOTAL: NON-PERMEABLE (PAVING): PERMEABLE (PLANTING + AGGREGTE): 24,031

OPEN SPACE TOTAL (ROW): 32,680 SQFT 15,953 SQFT (49%) NON-PERMEABLE AREA TOTAL: PERMEABLE AREA TOTAL: 16,727 SQFT (51%)

**OPEN SPACE TOTAL (PRIVATE):** 282,227 SQFT **NON-PERMEABLE AREA TOTAL:** 237,238 SQFT (84%) PERMEABLE AREA TOTAL: 44,989 SQFT (16%)

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OPEN SPACE DIAGRAM - LEVEL RL

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CONSULTANTS STUDIO-

MLA

PROJECT NAME
East End Studios

**EES2022** 

**Building Name (Optional)** 


ADDRESS

6th and Alameda, Los Angeles, CA 90021

REV BY DATE DESCRIPTION

**OPEN SPACE CALCULATIONS AS NOTED** DRAWING NO. L-001

DRAWING TITLE

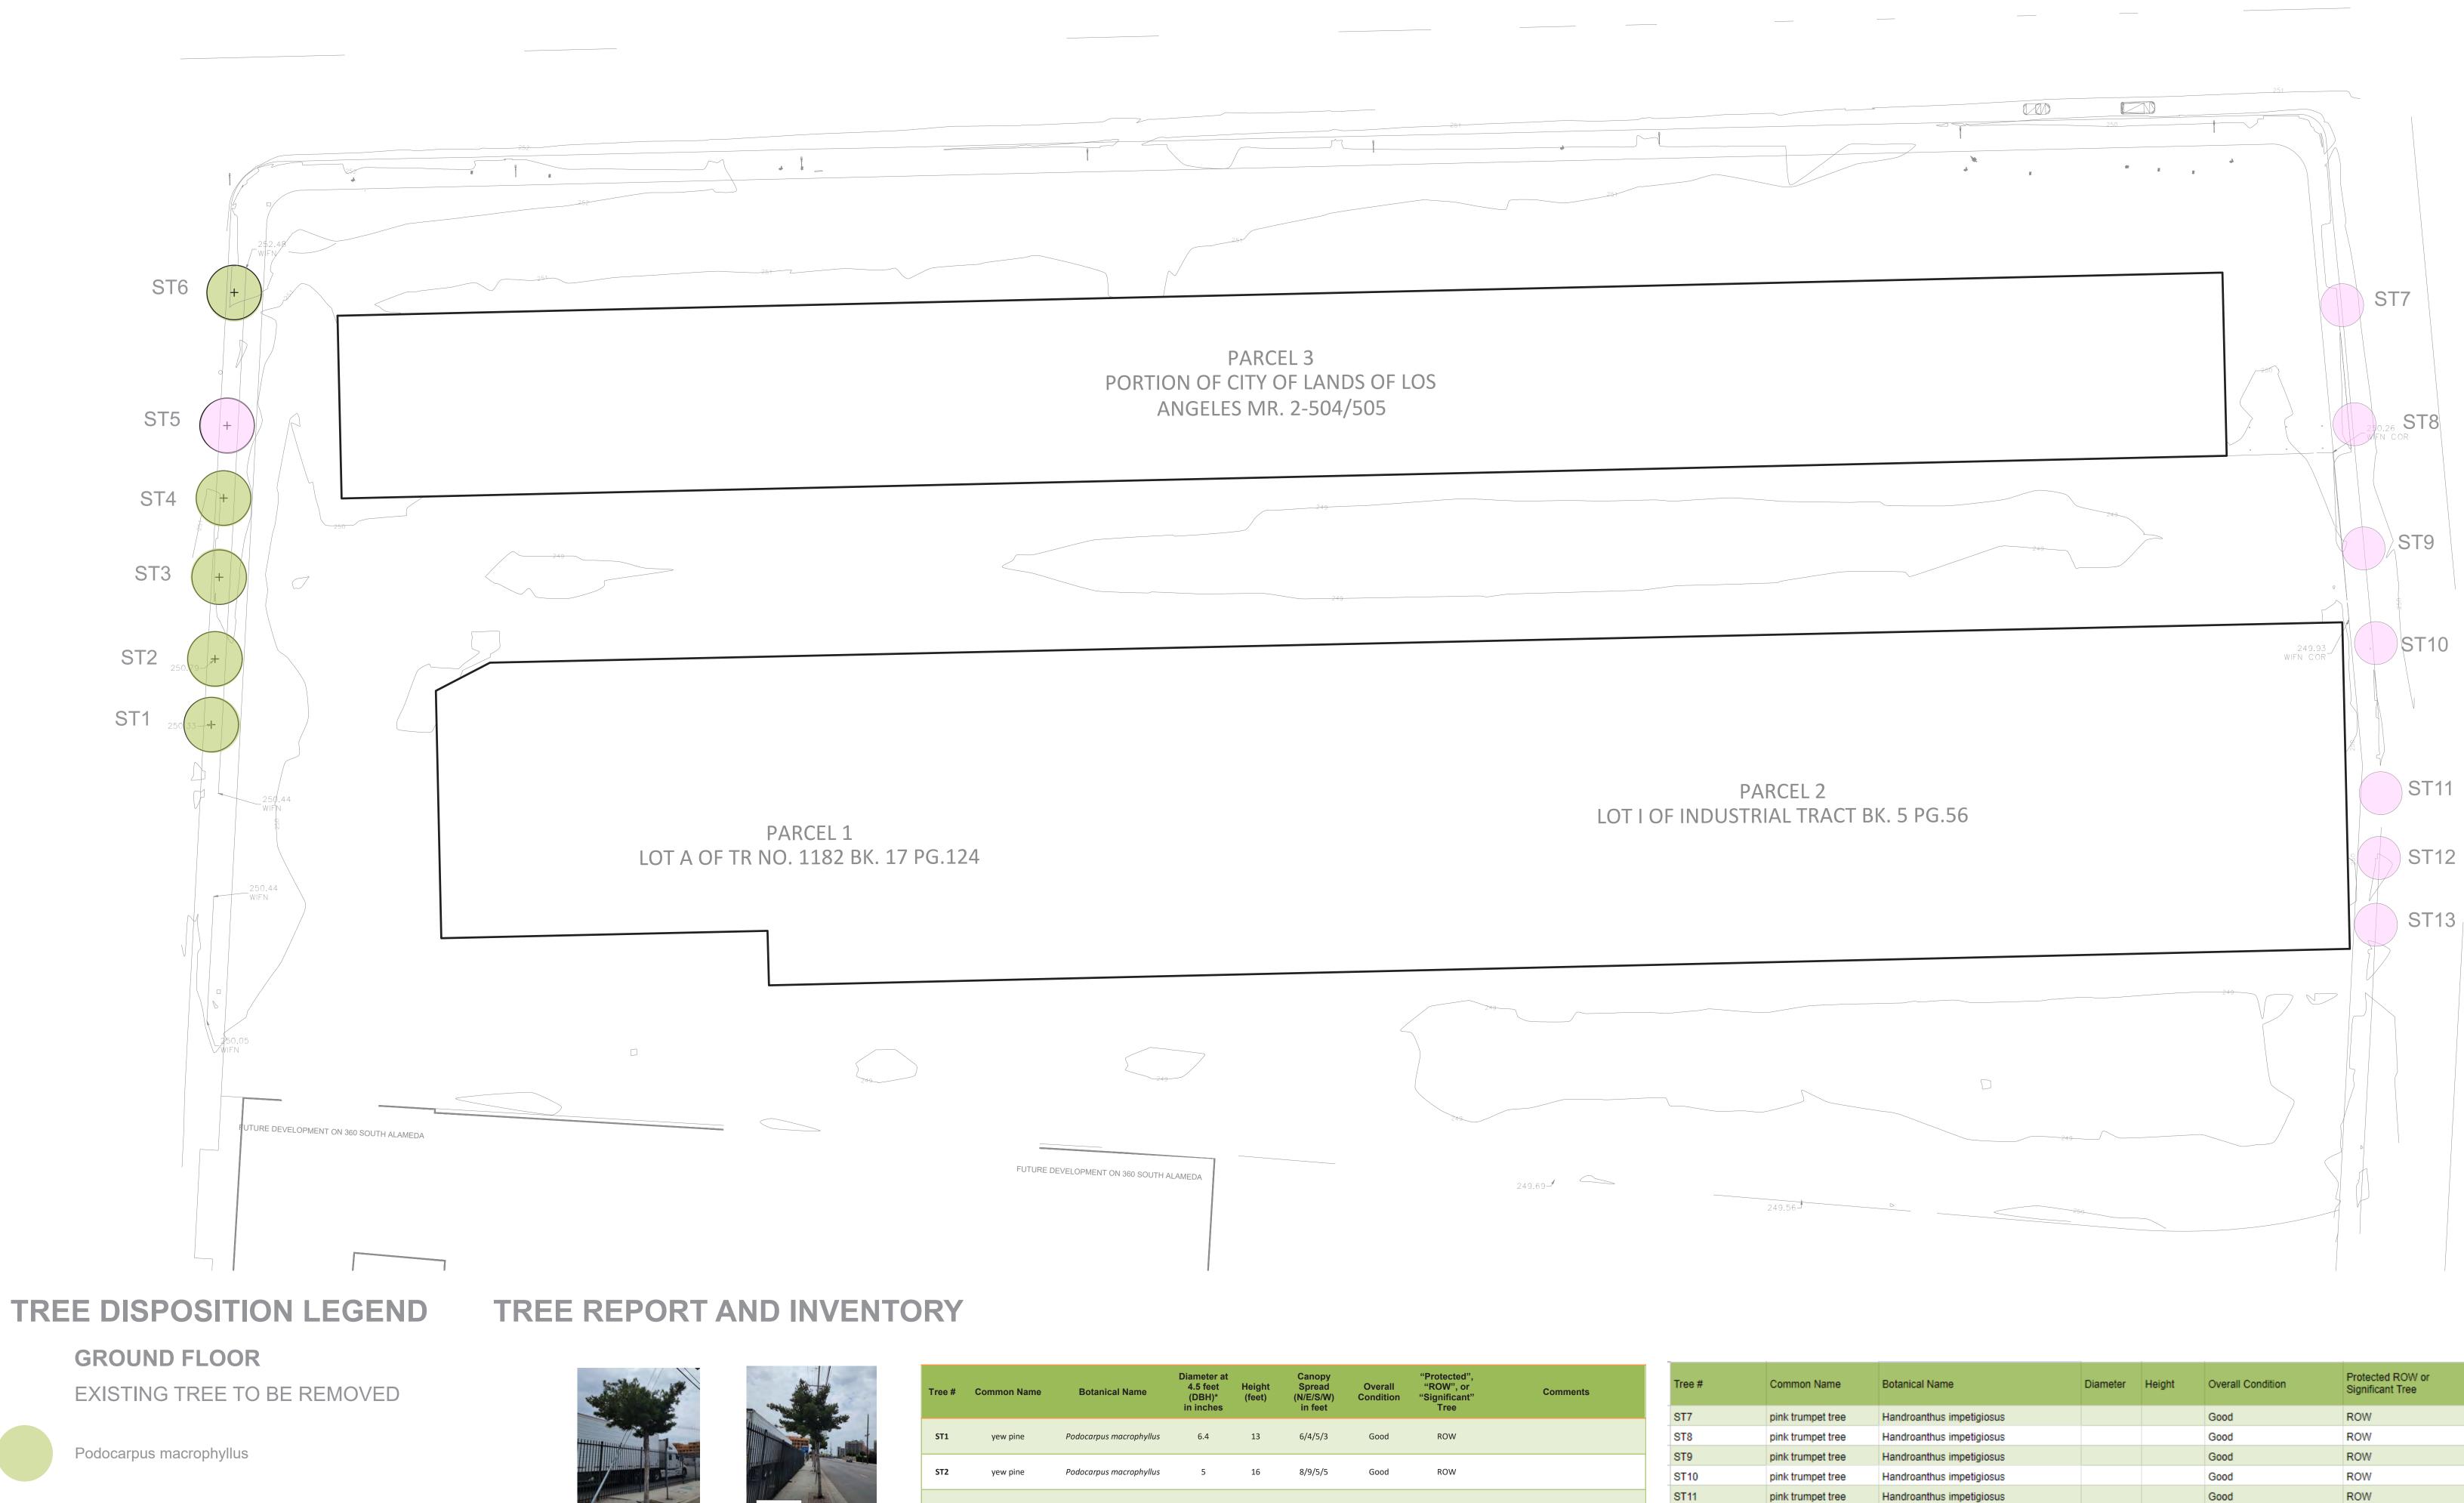

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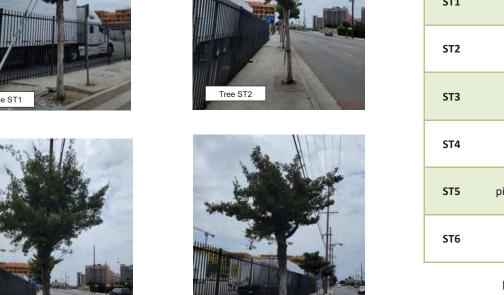
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DRAWING NOTICES Do not scale - all dimensions to be checked on

Handroanthus impetiginosus

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Tree #	Common Name	Botanical Name	4.5 feet (DBH)* in inches	Height (feet)	Spread (N/E/S/W) in feet	Overall Condition	"Protected", "ROW", or "Significant" Tree	Comments
ST1	yew pine	Podocarpus macrophyllus	6.4	13	6/4/5/3	Good	ROW	
ST2	yew pine	Podocarpus macrophyllus	5	16	8/9/5/5	Good	ROW	
ST3	yew pine	Podocarpus macrophyllus	9	18	10/5/8/7	Good	ROW	
ST4	yew pine	Podocarpus macrophyllus	10.5	20	10/6/8/9	Good	ROW	
ST5	pink trumpet tree	Handroanthus impetiginosus	5.8	18	16/17/12/12	Good	ROW	Mechanical damage to trunk
ST6	desert willow	Chilopsis linearis	2.9 measured at 3'	8	4/4/4/4	Good	ROW	

**DBH** – Diameter at breast height. A forestry term used to describe a tree's trunk diameter measured at 4.5 feet above grade. Often used as a ST – Street tree

OWNER ALAMEDA	PROJECT NAME East End Studios	REV	BY	DATE	DESCRIPTION

STUDIOS OWNER, LLC **Building Name (Optional)** CONSULTANTS STUDIO

Handroanthus impetigiosus


ST12

ADDRESS **EES2022** 6th and Alameda, Los Angeles, CA 90021

1" - 40'-0" DRAWING NO. L-002

DRAWING TITLE

TREE DISPOSITION PLAN

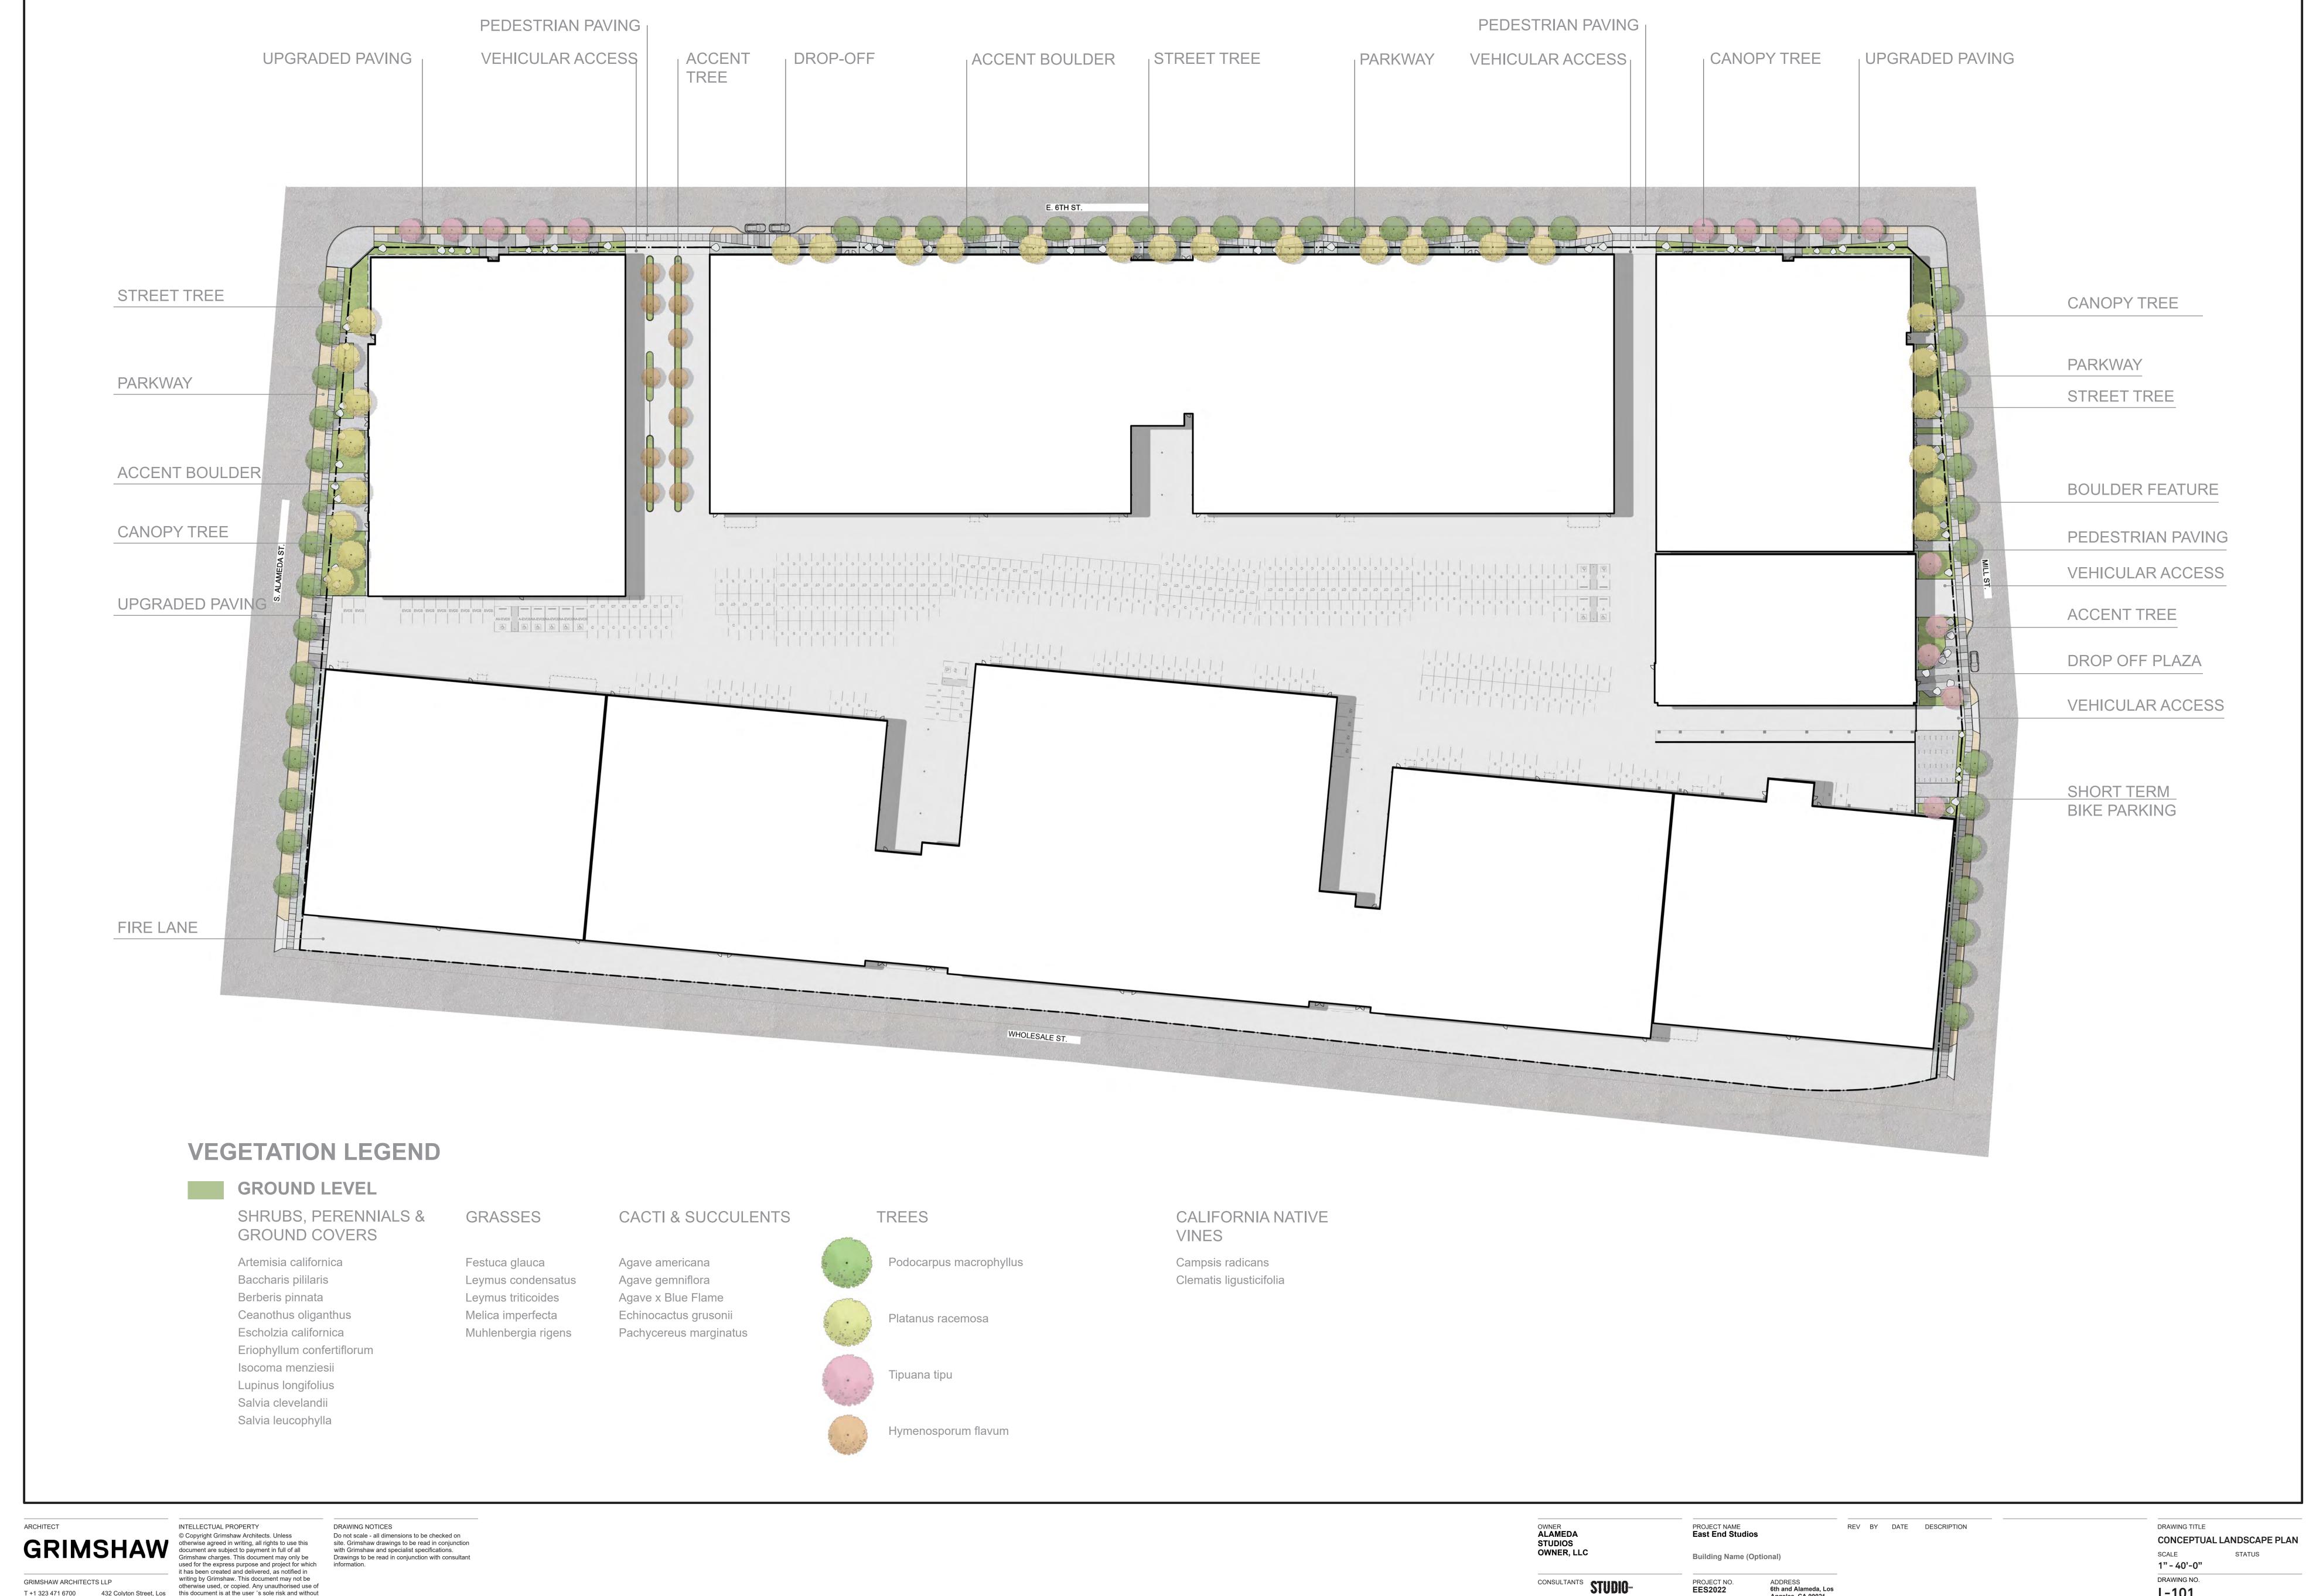

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L-101



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Helichrysum italicum

Mimulus aurantiacus

Solidago californica

Symphoricarpos mollis

Salvia mellifera

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East End Studios

PROJECT NO. **EES2022** 

**Building Name (Optional)** 


ADDRESS
6th and Alameda, Los

Angeles, CA 90021

REV BY DATE DESCRIPTION

DRAWING TITLE CONCEPTUAL LANDSCAPE PLAN 1" - 40'-0" DRAWING NO.

L-102

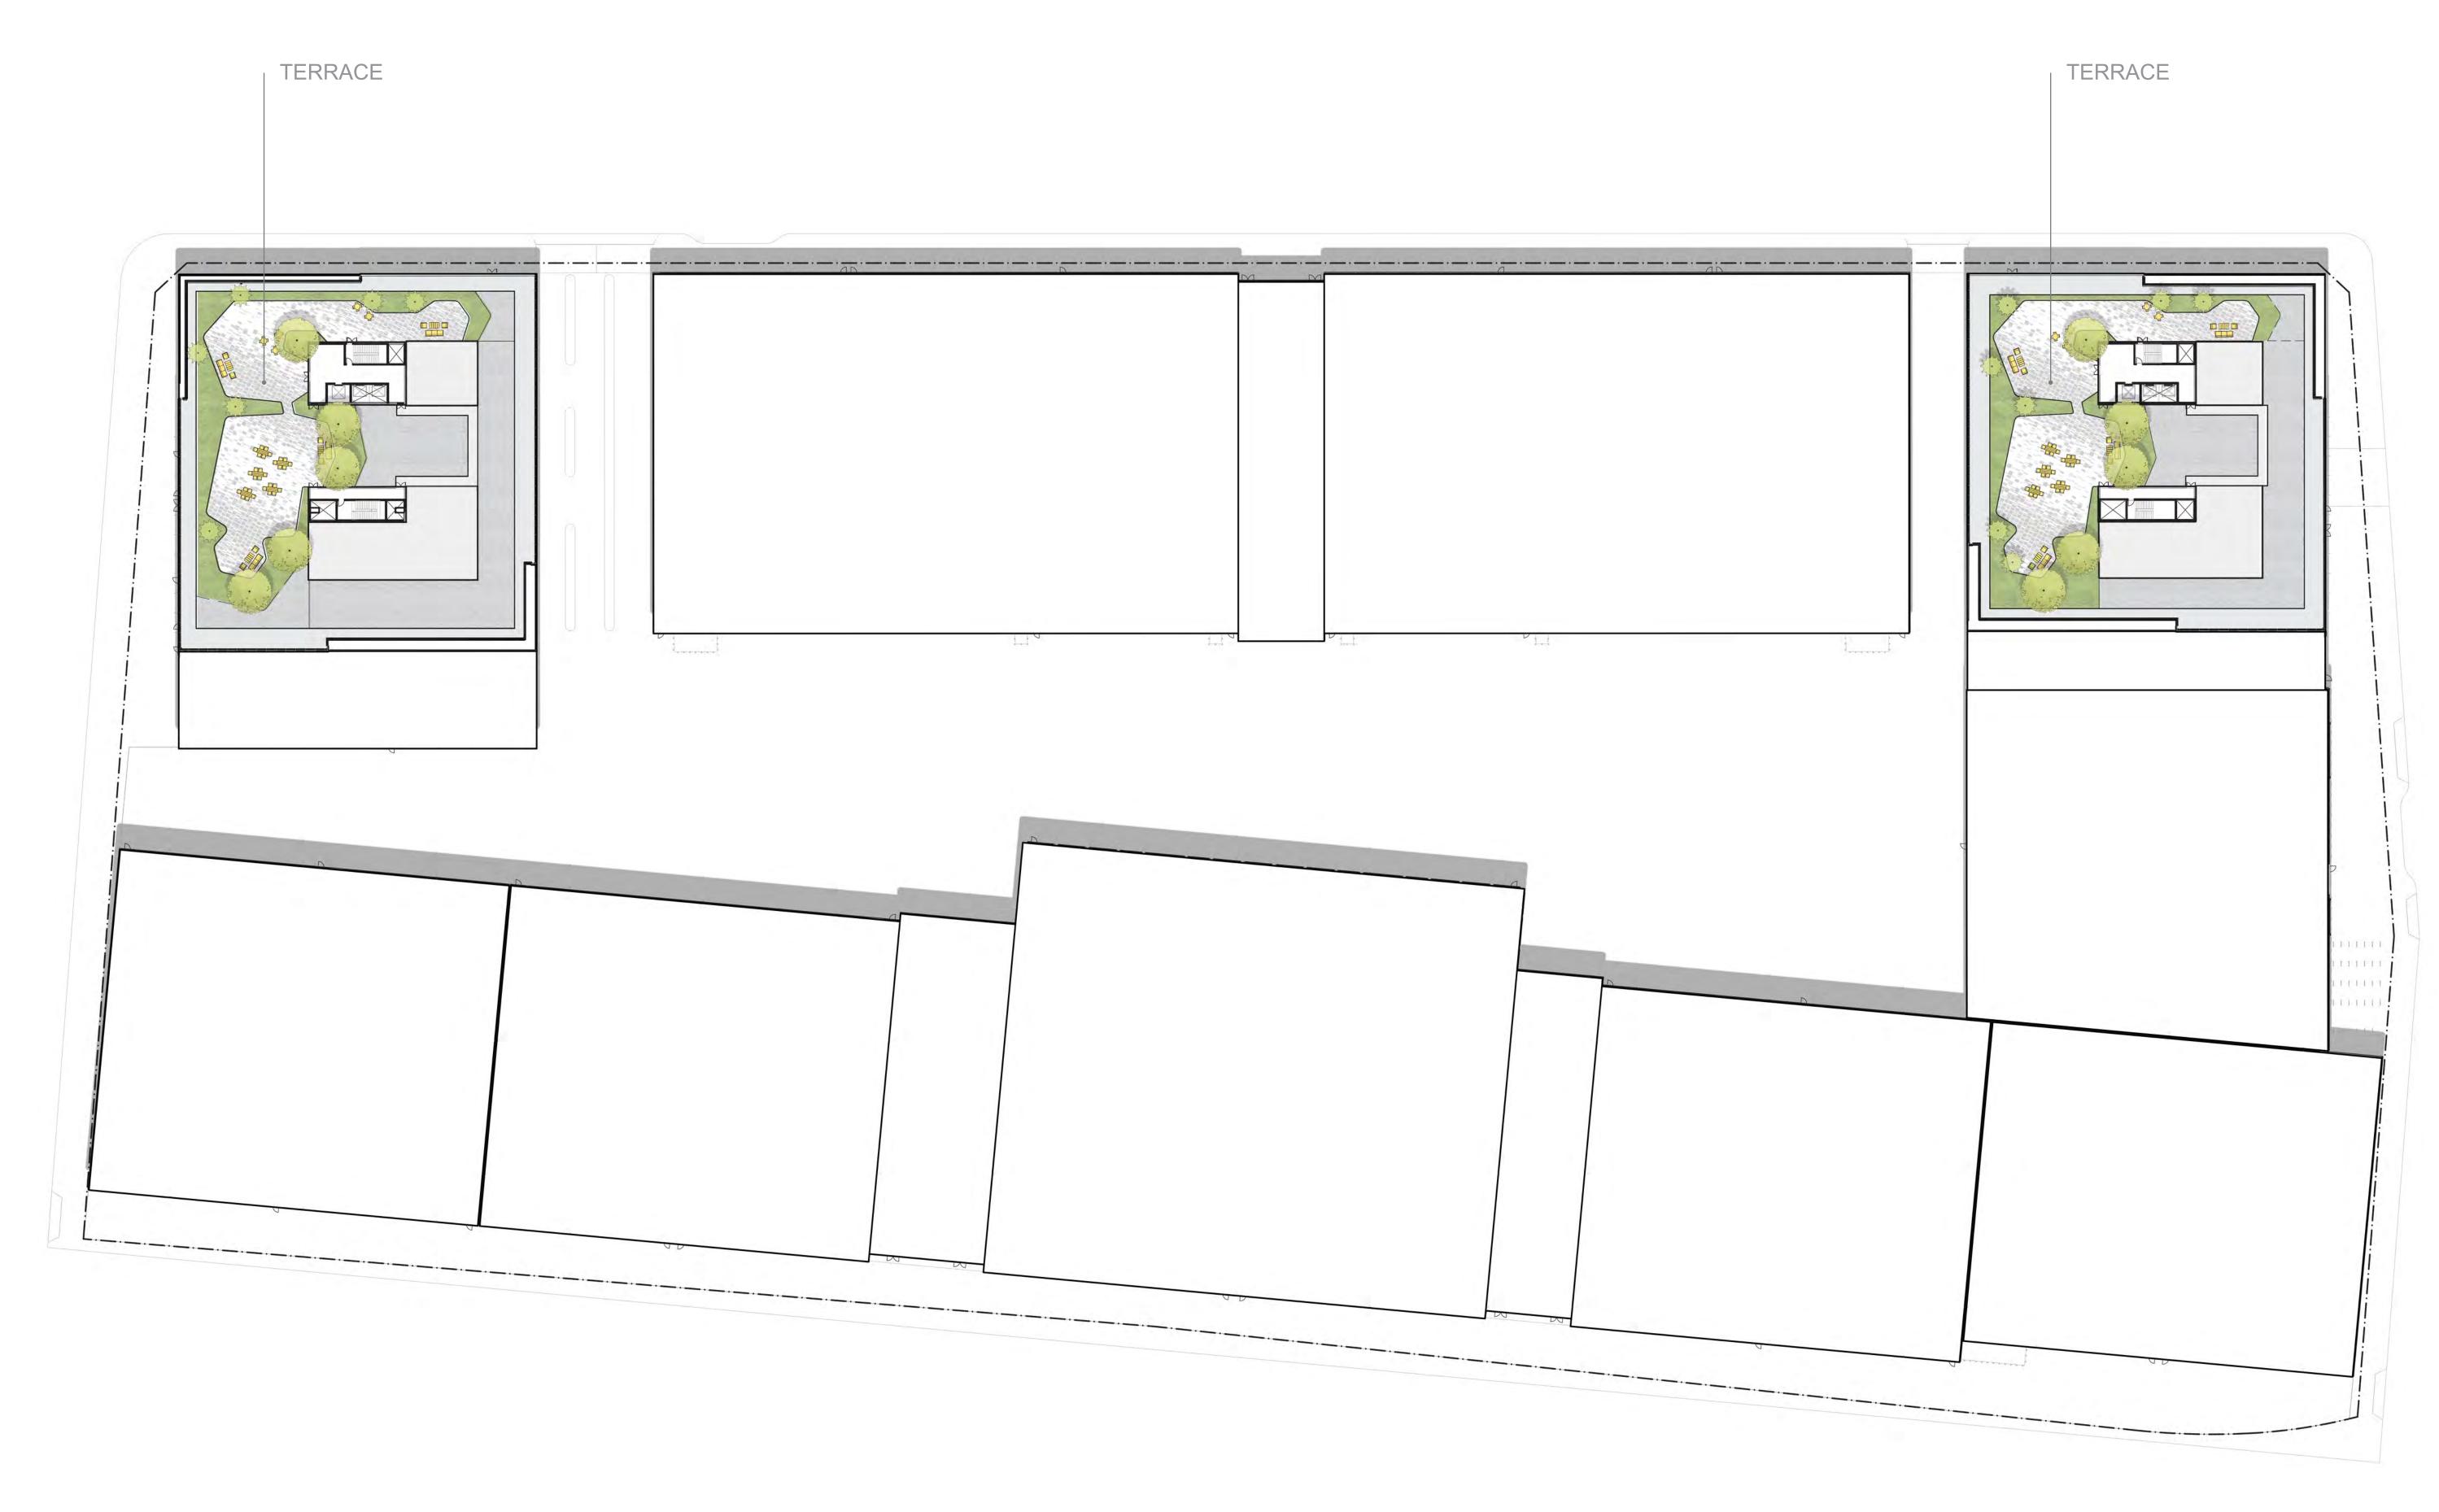

# **VEGETATION LEGEND**

ROOF DECK

SHRUBS, PERENNIALS & **GROUND COVERS** 

Ceanothus leucodermis Eriogonum fasciculatum Sriophyllum confertiflorum

### GRASSES

Bouteloua gracilis Leymus 'Canyon Prince' Nassella stipa

# **CACTI & SUCCULENTS**

Agave parry var. truncata Agave x Blue Flame Dudley spp. Echeveria derenbergii Echincactus grusonii Opuntia spp. Sedum laxum

Sedum morganianum

## CALIFORNIA NATIVE

VINES Clematis ligusticifolia Cochiliasanthus caracalla Keckiella cordifolia Lonicera subspicata Passiflora incaranater Vitis girdiana

## TREES



Salix laevigata

ARCHITECT

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ALAMEDA
STUDIOS OWNER, LLC

CONSULTANTS STUDIO-

PROJECT NAME
East End Studios

PROJECT NO. **EES2022** 

**Building Name (Optional)** 

ADDRESS 6th and Alameda, Los Angeles, CA 90021

REV BY DATE DESCRIPTION

DRAWING TITLE


1" - 40'-0" DRAWING NO.

L-103

CONCEPTUAL LANDSCAPE PLAN

# STREETSCAPE:

# SHRUBS, PERENNIALS & GROUND COVERS

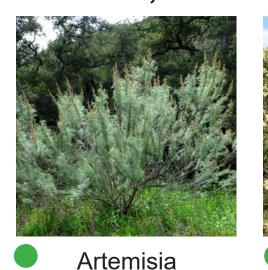

californica



Baccharis pililaris



Berberis pinnata

**CACTI & SUCCULENTS** 



Ceonothus oliganthus



Eriophyllum Eschscholzia confertiflorum



Isocoma

menziesii



longifolius

Salvia

clevelandii






glauca

**GRASSES** 



condensatus

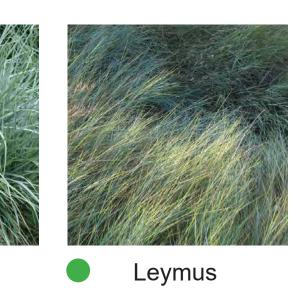

triricoides



imperfecta

Muhlenbergia

**CALIFORNIA NATIVE VINES** 



Clematis ligusticifolia



americana



Agave x Blue Flame




grusonii

Pachycereus marginatus



**TREE** 



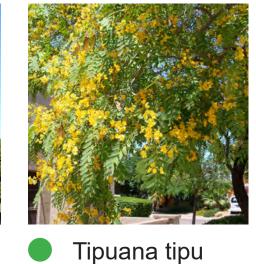



Hymenosporum flavum

# **AMENITY DECK:**

Campsis

radicans

# SHRUBS, PERENNIALS & GROUND COVERS






Baccharis

pilularis

gemniflora





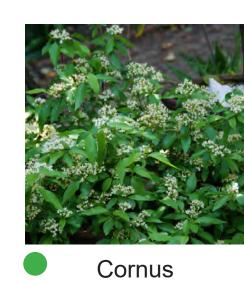

glabrata



occidentalis



italicum






aurantiacus






californica

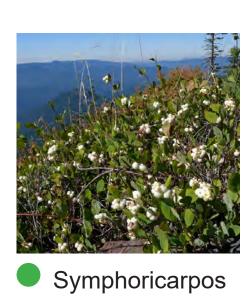

millefolium exarata

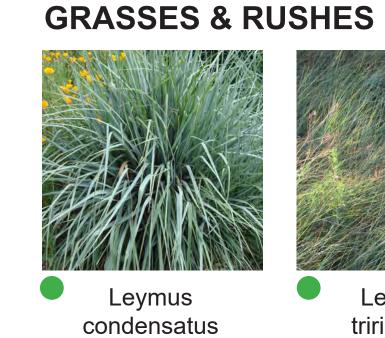

Leymus

triricoides



californica





laevigata





gooddingii

**ROOF DECK:** 

### **GRASSES** SHRUBS, PERENNIALS & GROUND COVERS



leucodermis

Erigonum

fasciculatum







gracilis

spp.





stipa

# **CACTI & SUCCULENTS**



grusonii

Agave x Blue Echinocactus Flame







derenbergii






morganianum



spp.



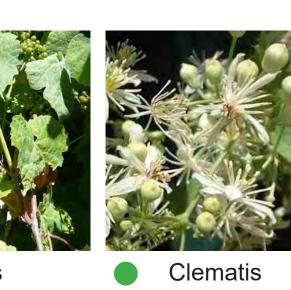









subspicata





REV BY DATE DESCRIPTION

RIO PLANTING

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truncata

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OWNER **ALAMEDA** STUDIOS OWNER, LLC

CONSULTANTS STUDIO

MLA

**EES2022** 

PROJECT NAME
East End Studios

**Building Name (Optional)** 

ADDRESS 6th and Alameda, Los Angeles, CA 90021

NORTH

DRAWING TITLE PLANTING PALETTE SCALE N/A DRAWING NO.

MATCHLINE ROOFTOP LEVEL OFFICE LEVEL 5 STUDIO OFFICE LEVEL 4 STUDIO STUDIO OFFICE LEVEL 3 AMENITY LEVEL 20' - 0" 1 6TH ST. ELEVATION PART 2 MATCHLINE STUDIO OFFICE LEVEL 3 AMENITY LEVEL 2 6TH ST. ELEVATION PART 1 OWNER
ALAMEDA
STUDIOS PROJECT NAME
East End Studios INTELLECTUAL PROPERTY REV BY DATE DESCRIPTION DRAWING TITLE DRAWING NOTICES GRIMSHAW ARCHITECTS LLP

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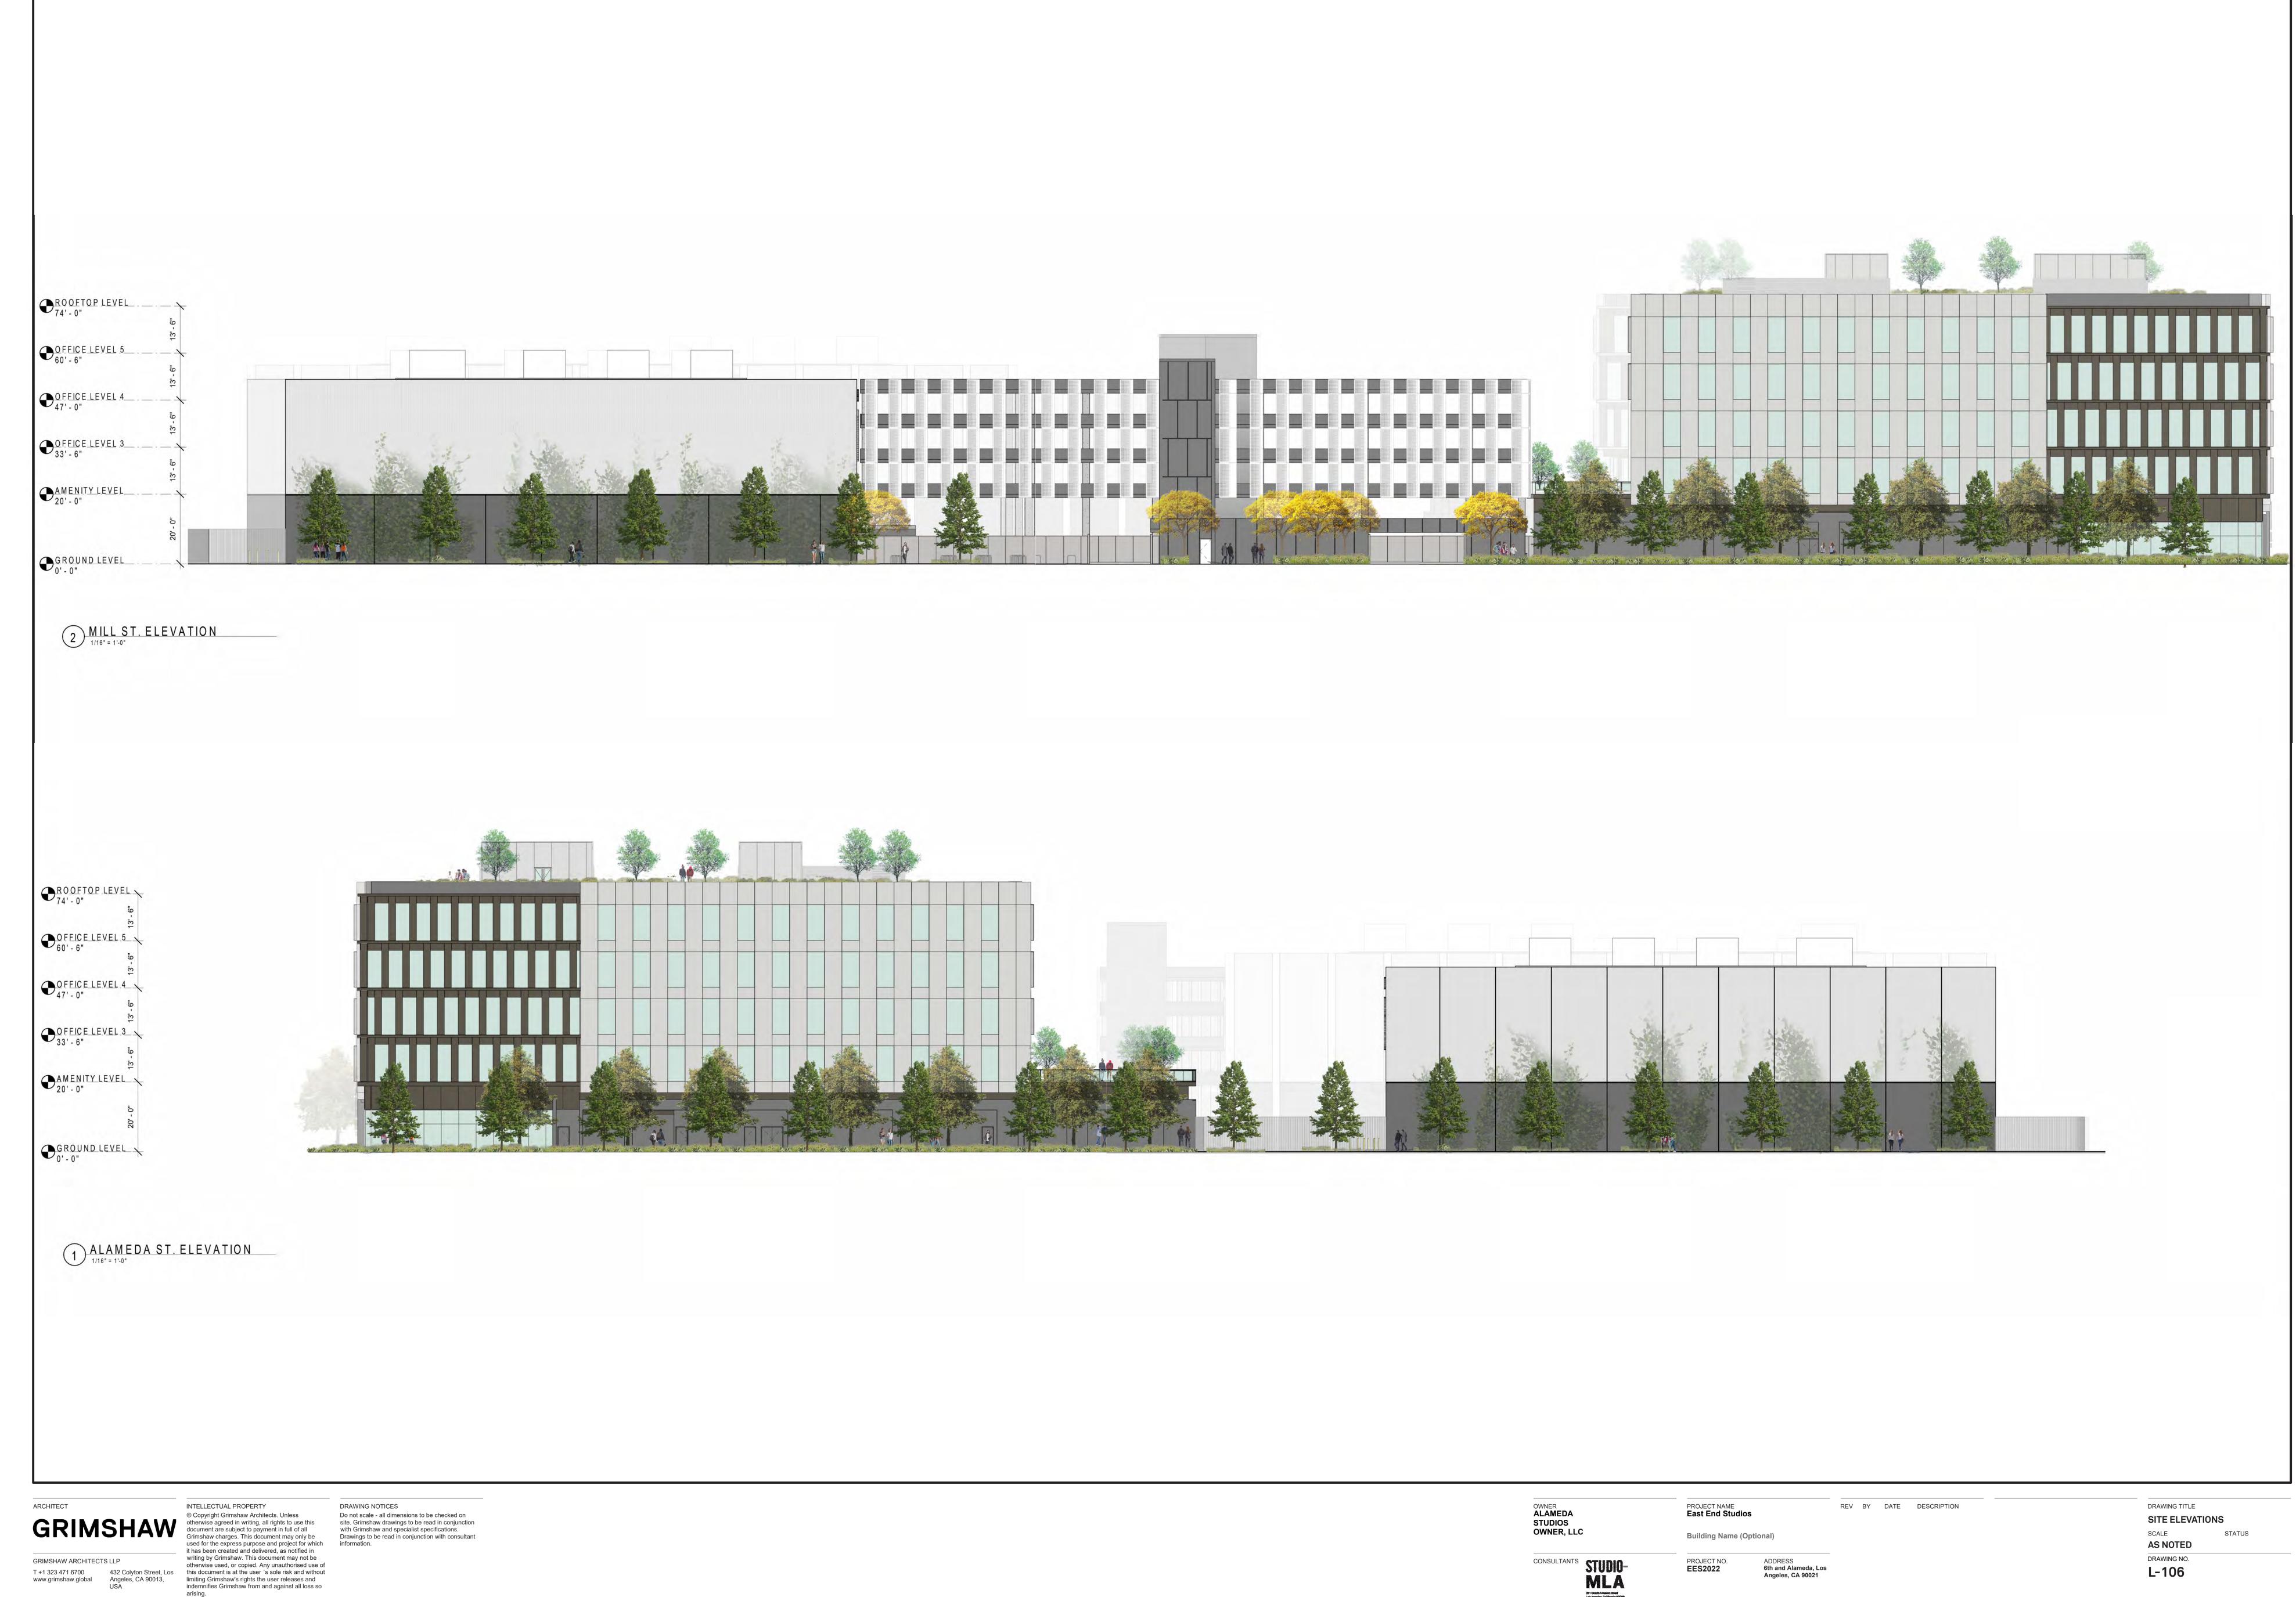
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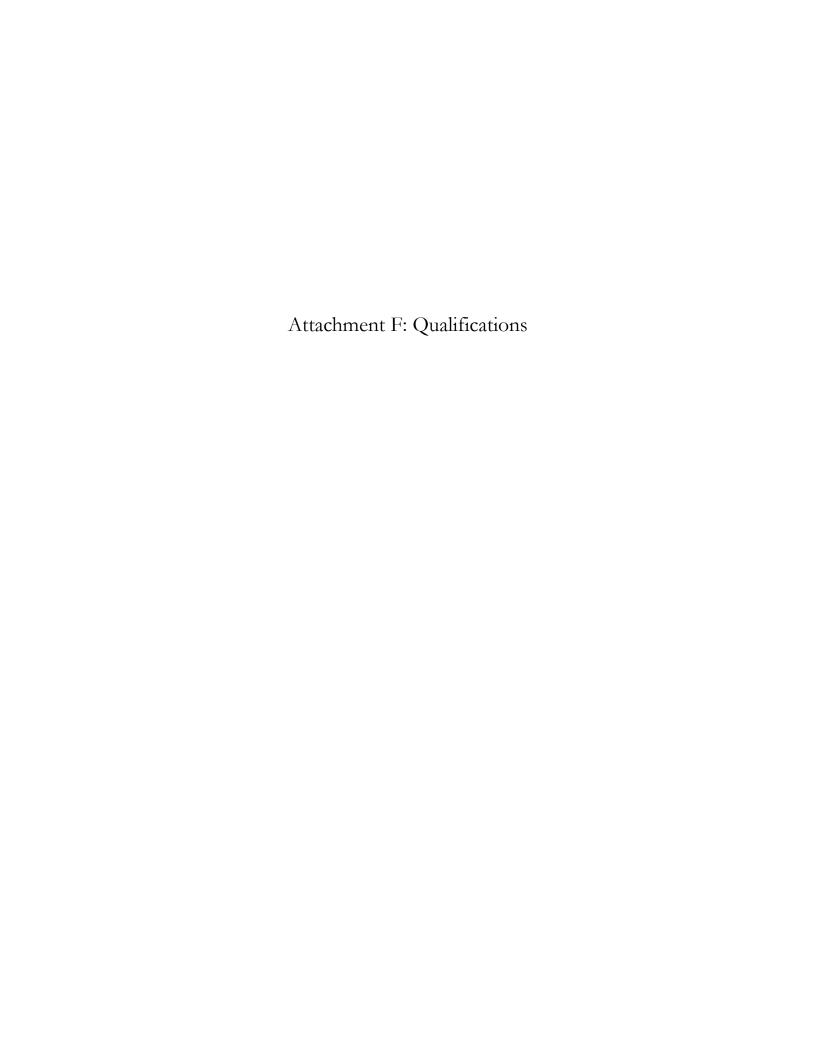
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Drawings to be read in conjunction with consultant OWNER, LLC SCALE **Building Name (Optional) AS NOTED** DRAWING NO. ADDRESS 6th and Alameda, Los Angeles, CA 90021 CONSULTANTS STUDIO-PROJECT NO. **EES2022** L-105



ADDRESS 6th and Alameda, Los Angeles, CA 90021

L-106



#### **JENNA SNOW**



In January 2015, Jenna Snow launched an independent historic preservation consulting practice with offices in Los Angeles. With twenty years of professional experience, Ms. Snow has a strong and broad understanding of best historic preservation practice, including federal, state, and local regulations. Throughout her career, Ms. Snow has authored, co-authored, and/or served as project manager for nearly 125 historic preservation projects, including a wide variety of historic resource assessments, National Register, California Register, and local nominations, as well as historic resources surveys. She regularly contributes to environmental impact reports, historic preservation certification applications, Section 106 reviews and other work associated with historic building rehabilitation and preservation planning.

#### **EDUCATION**

Columbia University in the City of New York, Master of Science in Historic Preservation, 2002

Brandeis University, Bachelor of Arts in Fine Arts, 1998

#### **QUALIFICATIONS**

Secretary of the Interior's Professional Qualifications Standards in Architectural History

#### **AWARDS**

Research Fellowship, Friends of Residential Treasures: Los Angeles (FORT:LA), June 2020-March 2023

Rosalind W. Levine Prize for excellence in Fine Arts, June 1998

### COMMUNITY INVOLVEMENT

Secretary, South Carthay Historic Preservation Overlay Zone Board, 2011-2016

Pick Leader, Food Forward, 2011-2016

Los Angeles Conservancy ModCom Working Group, 2013-2014

Guest Editor, *The Next American City*, Fall 2006, Issue 12

New Orleans recovery team from Western Regional Office of the National Trust for Historic Preservation, February 2006

#### PROFESSIONAL EXPERIENCE

Jenna Snow, Historic Preservation Consulting, January 2015-present

Chattel, Inc., Los Angeles, CA, July 2002 - December 2014

International Council on Monuments and Sites, Transylvania Trust Foundation, Cluj-Napoca, Romania, Fall 2004

Neighborhood Preservation Center, New York, NY, Spring 2002

New York City Department of Design and Construction, Historic Preservation Office, New York, NY, Summer 2001

The Freedom Trail Foundation, Boston, MA, January 1999 - October 1999

#### **SELECTED PROJECTS**

Temple Ohave Israel (Brownsville, PA) – Prepared a National Register nomination for a 1919 synagogue located in a small, economically depressed town of western Pennsylvania. The synagogue, significant as an anchor for the small, but influential Jewish community of Brownsville, PA, was listed in the National Register in February 2016. Listing in the National Register makes the property eligible for state grants to maintain the building, including replacement of a much needed roof.

Hawk House (Los Angeles, CA) – Prepared a successful Historic Cultural Monument nomination for a 1939 single family residential house designed by renown Los Angeles architect Harwell Hamilton Harris for Stan and Ethyl Hawk. The house severed as the headquarters for the furnishing company "Hawk House."

Chuey House (Los Angeles, CA) - Prepared a Historic-Cultural Monument nomination for a single family residence designed by one of the most influential Los Angeles architects, Richard Neutra, in 1956. As the property was for sale, the house was threatened with demolition. While the nomination was ultimately withdrawn, it served as a negotiation tool for the Los Angeles Conservancy.

Bank of America, Chinatown Branch (Los Angeles, CA) - Prepared a successful Historic Cultural Monument nomination for a 1971 bank branch located in Los Angeles' Chinatown, designed by Chinese American architects Gilbert Leong and Richard Layne Thom. The first national bank to open a branch in Chinatown, the building underscored the growth and preeminence of the local Chinese community during an important period in its history.

Monday Women's Club (Los Angeles, CA) - Prepared a historic resource assessment for a black women's club in the Venice neighborhood. Moved to the site in 1926, the building on the property was proposed for demolition. Worked with the project team on a focused EIR that studied alternatives.

#### **Additional Projects:**

Commodore Apartments (Los Angeles, CA) - Process Investment Tax Credit application for a 1926 Hollywood apartment building that completed a major rehabilitation project. The rehabilitation carefully restored the primary façade, which had experienced multiple alterations over the years.

West Los Angeles Veteran's Affairs Building 205 and Building 208 (Los Angeles, CA) - Process Investment Tax Credit application and Section 106 review for two buildings out-leased to a nonprofit developer. The two buildings will be rehabilitated to house homeless veterans. Work completed in 2023.

1505 Crest Drive (Manhattan Beach, CA) - Prepared a successful local Landmark nomination for a 1964 A-frame residence. The house was the second local Landmark in Manhattan Beach and reflects the city's growth in the post-World War II era and its beach culture.

Leone's Castle (San Pedro, CA) - Prepared a successful Historic Cultural Monument nomination for an exuberant Chateauesque style 1936 apartment house. The 4-flat apartment house was designed by prominent architect Saul H. Brown for Leone Redding.

West Los Angeles Veteran's Affairs (Los Angeles, CA) – Between 2010 and 2014, prepared Section 106 review and consultation for the first of 11 buildings that are undergoing seismic retrofit and limited rehabilitation. The buildings was reused to house veterans who are homeless. The rehabilitation won a Los Angeles Conservancy award. Also prepared a successful National Register nomination for the whole campus, which was listed in November 2014. Work was done at Chattel, Inc.

Breed Street Shul Project, Inc. (Los Angeles, CA) – Project Manager for Phase 1 seismic stabilization and stained glass window restoration. Provided design review and construction monitoring and prepared historic review documentation for local environmental review. Consulted with federal agencies on Section 106 compliance for a FE-MA grant and a federal appropriation. Work was done at Chattel, Inc.

Boyle Hotel/Cummings Block (Los Angeles, CA) – Completed Investment Tax Credit Application and National Register nomination for 1898 hotel in Boyle Heights neighborhood of Los Angeles. The building has been reused to house low-income residents of Boyle Heights and has been a catalyst for economic rehabilitation in the neighborhood. The rehabilitation won a Los Angeles Conservancy award, as well as a National Preservation Honor Award. Work was done at Chattel, Inc.

Judson Rives Building (Los Angeles, CA)—Completed Investment Tax Credit Application for a 1908 office building in downtown Los Angeles, a contributing resource to the Broadway Historic District that was converted to residential use. Work was done at Chattel, Inc.

Hollywood Profession Building (Los Angeles, CA) - Completed Investment Tax Credit Application for a 1926 office building on Hollywood Boulevard. The building is significant not only for its distinctive Neo-Gothic style, but also with for its association with former United States President Ronald Reagan. The office building was converted to residential use. Work was done for Chattel, Inc.

Historic Resources Survey Update (Los Angeles, CA) - Served as the project manager for preparation of historic context statements and intensive-level historic resource survey. The survey were prepared in close coordination with the Los Angeles Office of Historic Resources to dovetail into SurveyLA. Surveyed approximately 3,000 properties, including property-specific research on approximately 400 of these properties. Attended several public hearings at both the beginning and end of the process, as well as presented at nearly a dozen neighborhood council meetings. Work was done with Chattel, Inc.

Residential Survey (Whittier, CA) - Prepared a historic context statement focusing on architectural contexts and themes connected with residential development in Whittier. Feld surveyed approximately 1,540 properties generally constructed prior to 1941 using an Access database incorporating GIS mapping to collect survey data in the field. The survey was prepared in close coordination with the City of Whittier staff and Historic Resources Commission and was adopted by the City of Whitter in 2015. Work was done with Chattel, Inc.

SurveyLA City of Los Angeles (Office of Historic Resources) – Participated in completing a historic resource survey of over 97,000 properties in South and Southeast Los Angeles. Co-authored historic context statement of Los Angeles' industrial history. Work was done at Chattel, Inc.