

INDEX OF DRAWINGS

201614:57 MF-

066533 15-AUG-

						DESIGNED BY  C. LEMLEY	_
						DRAWN BY J. ALADIN	
						CHECKED BY	
						S. WILSON In charge	
						C. LEMLEY	
REV	DATE	BY	снк	APP	DESCRIPTION	08/12/2016	

RECORD SET
15% DESIGN
SUBMITTAL
NOT FOR
CONSTRUCTION





# CALIFORNIA HIGH-SPEED TRAIN PROJECT MERCED TO FRESNO SECTION

CENTRAL VALLEY WYE
ALIGNMENT AND TYPICAL SECTION PLANS
INDEX OF DRAWINGS
SHEET 1 OF 9

CONTRACT NO.
HSR08-05
DRAWING NO.
TT-B0002
SCALE
NO SCALE

INDEX OF DRAWINGS

TITLE

ALIGNMENT / PLAN SET

0164 4:57 MF-TT

15-AUG-

DESIGNED BY
C. LEMLEY
DRAWN BY
J. ALADIN
CHECKED BY
S. WILSON
IN CHARGE
C. LEMLEY
DATE
BY CHK APP
DESCRIPTION
DATE
08/12/2016

SECTION

DRAWING NO

RECORD SET
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# CALIFORNIA HIGH-SPEED TRAIN PROJECT MERCED TO FRESNO SECTION

DESCRIPTION

CENTRAL VALLEY WYE
ALIGNMENT AND TYPICAL SECTION PLANS
INDEX OF DRAWINGS
SHEET 2 OF 9

CONTRACT NO.
HSR08-05
DRAWING NO.
TT-B0003
SCALE
NO SCALE
SHEET NO.

TT-D1520-A

TT-D1530-A

TT-D1610-A

TT-D1611-A

SECTION

CENTRAL VALLEY WYE

CENTRAL VALLEY WYE

CENTRAL VALLEY WYE

CENTRAL VALLEY WYE

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BY CHK APP

DESCRIPTION

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TT-D1620-A	CENTRAL VALLEY WYE	SR 152 (NORTH) TO ROAD 13 WYE ALTERNATIVE	TRACK PLAN	SJD-MER STA 36302+00.00 TO 36358+00.00
TT-D1621-A	CENTRAL VALLEY WYE	SR 152 (NORTH) TO ROAD 13 WYE ALTERNATIVE	TRACK PROFILE	SJD-MER STA 36302+00.00 TO 36358+00.00
TT-D1630-A	CENTRAL VALLEY WYE	SR 152 (NORTH) TO ROAD 13 WYE ALTERNATIVE	TRACK PLAN	SJD-MER STA 36358+00.00 TO 36414+00.00
TT-D1631-A	CENTRAL VALLEY WYE	SR 152 (NORTH) TO ROAD 13 WYE ALTERNATIVE	TRACK PROFILE	SJD-MER STA 36358+00.00 TO 36414+00.00
TT-D1640-A	CENTRAL VALLEY WYE	SR 152 (NORTH) TO ROAD 13 WYE ALTERNATIVE	TRACK PLAN	SJD-MER STA 36414+00.00 TO 36470+00.00
TT-D1641-A	CENTRAL VALLEY WYE	SR 152 (NORTH) TO ROAD 13 WYE ALTERNATIVE	TRACK PROFILE	SJD-MER STA 36414+00.00 TO 36470+00.00
TT-D1650-A	CENTRAL VALLEY WYE	SR 152 (NORTH) TO ROAD 13 WYE ALTERNATIVE	TRACK PLAN	SJD-MER STA 36470+00.00 TO 36526+00.00
TT-D1651-A	CENTRAL VALLEY WYE	SR 152 (NORTH) TO ROAD 13 WYE ALTERNATIVE	TRACK PROFILE	SJD-MER STA 36470+00.00 TO 36526+00.00
TT-D1660-A	CENTRAL VALLEY WYE	SR 152 (NORTH) TO ROAD 13 WYE ALTERNATIVE	TRACK PLAN	SJD-MER STA 36526+00.00 TO 36544+07.50
TT-D1661-A	CENTRAL VALLEY WYE	SR 152 (NORTH) TO ROAD 13 WYE ALTERNATIVE	TRACK PROFILE	SJD-MER STA 36526+00.00 TO 36544+07.50
		SR 152 (NORTH) I	TO ROAD 19 WYE ALTERNATIVE	
TT-C4001-B	CENTRAL VALLEY WYE	SR 152 (NORTH) TO ROAD 19 WYE ALTERNATIVE	KEY MAP	SHEET 1 OF 3
TT-C4002-B	CENTRAL VALLEY WYE	SR 152 (NORTH) TO ROAD 19 WYE ALTERNATIVE	KEY MAP	SHEET 2 OF 3
TT-C4003-B	CENTRAL VALLEY WYE	SR 152 (NORTH) TO ROAD 19 WYE ALTERNATIVE	KEY MAP	SHEET 3 OF 3
TT-B0020-B	CENTRAL VALLEY WYE	SR 152 (NORTH) TO ROAD 19 WYE ALTERNATIVE	TYPICAL SECTION	SHEET 1 OF 12
TT-B0021-B	CENTRAL VALLEY WYE	SR 152 (NORTH) TO ROAD 19 WYE ALTERNATIVE	TYPICAL SECTION	SHEET 2 OF 12
TT-B0022-B	CENTRAL VALLEY WYE	SR 152 (NORTH) TO ROAD 19 WYE ALTERNATIVE	TYPICAL SECTION	SHEET 3 OF 12
TT-B0023-B	CENTRAL VALLEY WYE	SR 152 (NORTH) TO ROAD 19 WYE ALTERNATIVE	TYPICAL SECTION	SHEET 4 OF 12
TT-B0024-B	CENTRAL VALLEY WYE	SR 152 (NORTH) TO ROAD 19 WYE ALTERNATIVE	TYPICAL SECTION	SHEET 5 OF 12
TT-B0025-B	CENTRAL VALLEY WYE	SR 152 (NORTH) TO ROAD 19 WYE ALTERNATIVE	TYPICAL SECTION	SHEET 6 OF 12
TT-B0026-B	CENTRAL VALLEY WYE	SR 152 (NORTH) TO ROAD 19 WYE ALTERNATIVE	TYPICAL SECTION	SHEET 7 OF 12
TT-B0027-B	CENTRAL VALLEY WYE	SR 152 (NORTH) TO ROAD 19 WYE ALTERNATIVE	TYPICAL SECTION	SHEET 8 OF 12
TT-B0028-B	CENTRAL VALLEY WYE	SR 152 (NORTH) TO ROAD 19 WYE ALTERNATIVE	TYPICAL SECTION	SHEET 9 OF 12
TT-B0029-B	CENTRAL VALLEY WYE	SR 152 (NORTH) TO ROAD 19 WYE ALTERNATIVE	TYPICAL SECTION	SHEET 10 OF 12
ТТ-ВООЗО-В	CENTRAL VALLEY WYE	SR 152 (NORTH) TO ROAD 19 WYE ALTERNATIVE	TYPICAL SECTION	SHEET 11 OF 12
TT-B0031-B	CENTRAL VALLEY WYE	SR 152 (NORTH) TO ROAD 19 WYE ALTERNATIVE	TYPICAL SECTION	SHEET 12 OF 12
TT-B0050-B	CENTRAL VALLEY WYE	SR 152 (NORTH) TO ROAD 19 WYE ALTERNATIVE	SB TRACK SAN JOSE TO FRESNO GEOMETRY DATA	SHEET 1 OF 9
TT-B0051-B	CENTRAL VALLEY WYE	SR 152 (NORTH) TO ROAD 19 WYE ALTERNATIVE	SB TRACK SAN JOSE TO FRESNO GEOMETRY DATA	SHEET 2 OF 9
TT-B0052-B	CENTRAL VALLEY WYE	SR 152 (NORTH) TO ROAD 19 WYE ALTERNATIVE	SB & NB TRACK SAN JOSE TO FRESNO GEOMETRY DATA	SHEET 3 OF 9
TT-B0053-B	CENTRAL VALLEY WYE	SR 152 (NORTH) TO ROAD 19 WYE ALTERNATIVE	NB TRACK SAN JOSE TO FRESNO GEOMETRY DATA	SHEET 4 OF 9
TT-B0054-B	CENTRAL VALLEY WYE	SR 152 (NORTH) TO ROAD 19 WYE ALTERNATIVE	NB TRACK SAN JOSE TO FRESNO GEOMETRY DATA	SHEET 5 OF 9
TT-B0055-B	CENTRAL VALLEY WYE	SR 152 (NORTH) TO ROAD 19 WYE ALTERNATIVE	SB TRACK MERCED TO FRESNO GEOMETRY DATA	SHEET 6 OF 9
TT-B0056-B	CENTRAL VALLEY WYE	SR 152 (NORTH) TO ROAD 19 WYE ALTERNATIVE	SB & NB TRACK MERCED TO FRESNO GEOMETRY DATA	SHEET 7 OF 9
TT-B0057-B	CENTRAL VALLEY WYE	SR 152 (NORTH) TO ROAD 19 WYE ALTERNATIVE	NB TRACK MERCED TO FRESNO GEOMETRY DATA	SHEET 8 OF 9
TT-B0058-B	CENTRAL VALLEY WYE	SR 152 (NORTH) TO ROAD 19 WYE ALTERNATIVE	SB & NB TRACK SAN JOSE TO MERCED GEOMETRY DATA	SHEET 9 OF 9
TT-D1010-B	CENTRAL VALLEY WYE	SR 152 (NORTH) TO ROAD 19 WYE ALTERNATIVE	TRACK PLAN AND PROFILE	SJD-FRE STA 5338+00.00 TO 5394+00.00
TT-D1020-B	CENTRAL VALLEY WYE	SR 152 (NORTH) TO ROAD 19 WYE ALTERNATIVE	TRACK PLAN AND PROFILE	SJD-FRE STA 5394+00.00 TO 5450+00.00
		DESIGNED BY C. LEMLEY  DRAWN BY 15% DESIGN		CALIFORNIA HIGH-SPEED MERCED TO FRESN
		J. ALADIN	PARSONS	CENTRAL VALLE

PARSONS

INDEX OF DRAWINGS

ALIGNMENT / PLAN SET

SR 152 (NORTH) TO ROAD 13 WYE ALTERNATIVE

CHECKED BY

C. LEMLEY

08/<u>12/2016</u>

NOT FOR

CONSTRUCTION

TITLE

TRACK PLAN AND PROFILE

TRACK PLAN AND PROFILE

TRACK PLAN

TRACK PROFILE

## ED TRAIN PROJECT CONTRACT NO. HSROR-C MERCED TO FRESNO SECTION

DESCRIPTION

MER-FRE STA 15556+00.00 TO 15612+00.00

MER-FRE STA 15612+00.00 TO 15655+00.00

SJD-MER STA 36246+00.00 TO 36302+00.00

SJD-MER STA 36246+00.00 TO 36302+00.00

CENTRAL VALLEY WYE ALIGNMENT AND TYPICAL SECTION PLANS INDEX OF DRAWINGS SHEET 3 OF 9

HSR08-05
DRAWING NO. TT-B0004
NO SCALE
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SECTION

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										S. W	ILSC	N	-
										J. A		IN	
										C. L		<u>.</u> T	┨
										DESIGNED		-v	Т
	l												
		Т	T-D	145	1-B	CENTRAL VALLEY WYE	SR	152	(NO	RTH)	ТО	ROAD	1
		Т	T-D	145	ю-В	CENTRAL VALLEY WYE	SR	152	(NO	RTH)	ТО	ROAD	1
		Т	T-D	144	1-B	CENTRAL VALLEY WYE	SR	152	(NO	RTH)	ТО	ROAD	1
		Т	T-D	144	0-В	CENTRAL VALLEY WYE	SR	152	(NO	RTH)	ТО	ROAD	1
		Т	T-D	143	1-B	CENTRAL VALLEY WYE	SR	152	(NO	RTH)	ТО	ROAD	1
		Т	T-D	143	0-В	CENTRAL VALLEY WYE	SR	152	(NO	RTH)	ТО	ROAD	1
						SEITHING THEEET MIE	1 0.1	102		,			_ '
		Т	T-D	142	1-B	CENTRAL VALLEY WYE	SR	152	(NO	RTH)	TO	ROAD	1

RECORD SET 15% DESIGN SUBMITTAL NOT FOR CONSTRUCTION





### CALIFORNIA HIGH-SPEED TRAIN PROJECT MERCED TO FRESNO SECTION

DESCRIPTION

CENTRAL VALLEY WYE ALIGNMENT AND TYPICAL SECTION PLANS INDEX OF DRAWINGS SHEET 4 OF 9

HSR08-05
DRAWING NO. TT-B0005
NO SCALE

SHEET NO.

Temporor   Control youth   War   Set   Early   Control you   Early			DESIGNED BY		CALIEODNIA HIGH-SDEE
MARINEST	1-01431-0	CENTRAL VALLET WIE	SIN 132 (NORTH) TO ROAD 19 WIE ALTERNATIVE	TRACK PROFILE	MEN-FNE SIA 14939+00.00 10 14995+00.00
Procedure   19-14-14   19-14					
PROPERTY   CONTRACT VALUE WITE   SET 125 MODEL 10 to 100 19 ME ALTERNATIVE   TOOK PLAN ALD PROPERTY   SUPPLIES OF SECONDO TO 5 100 00.00					
0.050   CR. P. FAL, VALLEY   WILE   SR   152   INCTITUTE   TO FORG   5 WYE ALTERNATIVE   TRACK PLAN ALT PROFILE   SLOT THE 576   E560-00.00 TO 9616-00.00 TO 970-00.00 TO 97					
CHORDON   CHITTRE VALUE FOR   SS 1.52 (MOTH) TO ROAD 19 STF ALTERATIVE   TRACE FLA. AND PROFILE   SUB-TRE STA SEGREDOUS TO SCHAROLOGY					
CREATE   APPEND AND PET FOR   SR 150 DOESNIN TO 100 1 NOTE A TENATOR   TRACE PLAN NOR PREFET   S. O-FREST'R RESIDENCE TO SERVE-COLOR COLORS					
PORTON   CENTRAL VALLEY WITE   SR 192 (NORTH) TO FOOD 19 NY A JURNALITY   TRACE PLAN AND PROPELLE   SUCHER STA 5005-00.00 TO 5857-00.00 TO 5					
COUNTY   C					
POINT AND PROPERTY OF CONTRAIN VALLEY NET					
CONTRAL VALLEY DVE					
			· · · · · ·		
DIAGO   DENTAL VALLEY OVE					
-01040-0 CENTRAL VALLEY OVE SR 152 (NORTH) TO ROAD 19 OVE ALTERNATIVE TRACK PLAN AND PROFILE SUB-RE STA 5506-00.00 TO 5562-00.00 P. 01050-8 CENTRAL VALLEY OVE SR 152 (NORTH) TO ROAD 19 OVE ALTERNATIVE TRACK PLAN AND PROFILE SUB-RE STA 5506-00.00 TO 5562-00.00 P. 01070-8 CENTRAL VALLEY OVE SR 152 (NORTH) TO ROAD 19 OVE ALTERNATIVE TRACK PLAN AND PROFILE SUB-RE STA 5516-00.00 TO 5676-00.00 P. 01070-8 CENTRAL VALLEY OVE SR 152 (NORTH) TO ROAD 19 OVE ALTERNATIVE TRACK PLAN AND PROFILE SUB-RE STA 5516-00.00 TO 5780-00.00 P. 01070-8 CENTRAL VALLEY OVE SR 152 (NORTH) TO ROAD 19 OVE ALTERNATIVE TRACK PLAN AND PROFILE SUB-RE STA 5736-00.00 TO 5780-00.00 P. 01000-8 CENTRAL VALLEY OVE SR 152 (NORTH) TO ROAD 19 OVE ALTERNATIVE TRACK PLAN AND PROFILE SUB-RE STA 5736-00.00 TO 5780-00.00 P. 01000-8 CENTRAL VALLEY OVE SR 152 (NORTH) TO ROAD 19 OVE ALTERNATIVE TRACK PLAN AND PROFILE SUB-RE STA 5836-00.00 TO 5880-00.00 P. 01100-8 CENTRAL VALLEY OVE SR 152 (NORTH) TO ROAD 19 OVE ALTERNATIVE TRACK PLAN AND PROFILE SUB-RE STA 5836-00.00 TO 5880-00.00 P. 01100-8 CENTRAL VALLEY OVE SR 152 (NORTH) TO ROAD 19 OVE ALTERNATIVE TRACK PLAN AND PROFILE SUB-RE STA 5010-00.00 TO 5006-00.00 P. 01100-8 CENTRAL VALLEY OVE SR 152 (NORTH) TO ROAD 19 OVE ALTERNATIVE TRACK PLAN AND PROFILE SUB-RE STA 5010-00.00 TO 6010-00.00 TO 6010-00					
DIGGO-B CENTRAL VALLEY OVE SR 152 (NORTH) TO ROAD 19 OVE ALTERNATIVE TRACK PLAN AND PROFILE SUB-FRE STA 5506+00.00 TO 5582-00.00 DIGGO-B CENTRAL VALLEY OVE SR 152 (NORTH) TO ROAD 19 OVE ALTERNATIVE TRACK PLAN AND PROFILE SUB-FRE STA 5618+00.00 TO 5618+00.00 DIGGO-B CENTRAL VALLEY OVE SR 152 (NORTH) TO ROAD 19 OVE ALTERNATIVE TRACK PLAN AND PROFILE SUB-FRE STA 5618+00.00 TO 574+00.00 DIGGO-B CENTRAL VALLEY OVE SR 152 (NORTH) TO ROAD 19 OVE ALTERNATIVE TRACK PLAN AND PROFILE SUB-FRE STA 5618+00.00 TO 5780-00.00 DIGGO-B CENTRAL VALLEY OVE SR 152 (NORTH) TO ROAD 19 OVE ALTERNATIVE TRACK PLAN AND PROFILE SUB-FRE STA 5780+00.00 TO 5780-00.00 DIGGO-B CENTRAL VALLEY OVE SR 152 (NORTH) TO ROAD 19 OVE ALTERNATIVE TRACK PLAN AND PROFILE SUB-FRE STA 5780+00.00 TO 5880-00.00 DIGGO-B CENTRAL VALLEY OVE SR 152 (NORTH) TO ROAD 19 OVE ALTERNATIVE TRACK PLAN AND PROFILE SUB-FRE STA 5780+00.00 TO 5890-00.00 DIGGO-B CENTRAL VALLEY OVE SR 152 (NORTH) TO ROAD 19 OVE ALTERNATIVE TRACK PLAN AND PROFILE SUB-FRE STA 5890-00.00 TO 5990-00.00 DIGGO-B CENTRAL VALLEY OVE SR 152 (NORTH) TO ROAD 19 OVE ALTERNATIVE TRACK PLAN AND PROFILE SUB-FRE STA 5990-00.00 DIGGO-B CENTRAL VALLEY OVE SR 152 (NORTH) TO ROAD 19 OVE ALTERNATIVE TRACK PLAN AND PROFILE SUB-FRE STA 5990-00.00 DIGGO-B CENTRAL VALLEY OVE SR 152 (NORTH) TO ROAD 19 OVE ALTERNATIVE TRACK PLAN AND PROFILE SUB-FRE STA 5990-00.00 DIGGO-B CENTRAL VALLEY OVE SR 152 (NORTH) TO ROAD 19 OVE ALTERNATIVE TRACK PLAN AND PROFILE SUB-FRE STA 5990-00.00 DIGGO-B CENTRAL VALLEY OVE SR 152 (NORTH) TO ROAD 19 OVE ALTERNATIVE TRACK PLAN AND PROFILE SUB-FRE STA 5990-00.00 DIGGO-B CENTRAL VALLEY OVE SR 152 (NORTH) TO ROAD 19 OVE ALTERNATIVE TRACK PLAN AND PROFILE SUB-FRE STA 5600-00.00 DIGGO-B CENTRAL VALLEY OVE SR 152 (NORTH) TO ROAD 19 OVE ALTERNATIVE TRACK PLAN AND PROFILE SUB-FRE STA 5600-00.00 DIGGO-B CENTRAL VALLEY OVE SR 152 (NORTH) TO ROAD 19 OVE ALTERNATIVE TRACK PLAN AND PROFILE SUB-FRE STA 5600-00.00 DIGGO-B CENTRAL VALLEY OVE SR 152 (NORTH) TO ROAD 19 OVE ALTERNATIVE TRACK PLAN AND PROFILE SUB					
DIGGO-B   CENTRAL VALLEY WYE   SR 152 (NORTH) TO ROAD 19 WYE ALTERNATIVE   TRACK PLAN AND PROFILE   SJD-FRE STA 5566-00.00 TO 5562-00.00 TO 5662-00.00 TO					
COLOU-B  CENTRAL VALLEY WYE   SR 152 (NORTH) TO ROAD 19 WYE ALTERNATIVE   TRACK PLAN AND PROFILE   SUD-FRE STA 5566+00.00 TO 5562+00.00					
DIGNO-B   CENTRAL VALLEY WYE   SR 152 (NORTH) TO ROAD 19 WYE ALTERNATIVE   TRACK PLAN AND PROFILE   SJD-FRE STA 5506-00.00 TO 5562+00.00					
DIO40-B CENTRAL VALLEY WYE SR 152 (NORTH) TO ROAD 19 WYE ALTERNATIVE TRACK PLAN AND PROFILE SJD-FRE STA 5566+00.00 TO 5562+00.00 TO 5662+00.00					
D1040-B CENTRAL VALLEY WYE SR 152 (NORTH) TO ROAD 19 WYE ALTERNATIVE TRACK PLAN AND PROFILE SJD-FRE STA 5506+00.00 TO 5562+00.00 TO 5618+00.00					
D1040-B CENTRAL VALLEY WYE SR 152 (NORTH) TO ROAD 19 WYE ALTERNATIVE TRACK PLAN AND PROFILE SUD-FRE STA 5506+00.00 TO 5562+00.00 TO 5662+00.00					
D1040-B CENTRAL VALLEY MYE SR 152 (NORTH) TO ROAD 19 MYE ALTERNATIVE TRACK PLAN AND PROFILE SJD-FRE STA 556+00.00 TO 5562+00.00 D1050-B CENTRAL VALLEY MYE SR 152 (NORTH) TO ROAD 19 MYE ALTERNATIVE TRACK PLAN AND PROFILE SJD-FRE STA 566+00.00 TO 5674+00.00 D1070-B CENTRAL VALLEY MYE SR 152 (NORTH) TO ROAD 19 MYE ALTERNATIVE TRACK PLAN AND PROFILE SJD-FRE STA 5674+00.00 TO 5730+00.00 D1080-B CENTRAL VALLEY MYE SR 152 (NORTH) TO ROAD 19 MYE ALTERNATIVE TRACK PLAN AND PROFILE SJD-FRE STA 5674+00.00 TO 5730+00.00 D1080-B CENTRAL VALLEY MYE SR 152 (NORTH) TO ROAD 19 MYE ALTERNATIVE TRACK PLAN AND PROFILE SJD-FRE STA 5730+00.00 TO 5786+00.00 D1090-B CENTRAL VALLEY MYE SR 152 (NORTH) TO ROAD 19 MYE ALTERNATIVE TRACK PLAN AND PROFILE SJD-FRE STA 5730+00.00 TO 5842+00.00 D1100-B CENTRAL VALLEY MYE SR 152 (NORTH) TO ROAD 19 MYE ALTERNATIVE TRACK PLAN AND PROFILE SJD-FRE STA 5864-00.00 TO 5842+00.00 D1110-B CENTRAL VALLEY MYE SR 152 (NORTH) TO ROAD 19 MYE ALTERNATIVE TRACK PLAN AND PROFILE SJD-FRE STA 5842+00.00 TO 5944-00.00 D1110-B CENTRAL VALLEY MYE SR 152 (NORTH) TO ROAD 19 MYE ALTERNATIVE TRACK PLAN AND PROFILE SJD-FRE STA 5954+00.00 TO 6010+00.00 D1110-B CENTRAL VALLEY MYE SR 152 (NORTH) TO ROAD 19 MYE ALTERNATIVE TRACK PLAN AND PROFILE SJD-FRE STA 6010+00.00 TO 6066+00.00 D1110-B CENTRAL VALLEY MYE SR 152 (NORTH) TO ROAD 19 MYE ALTERNATIVE TRACK PLAN AND PROFILE SJD-FRE STA 6010+00.00 TO 6066+00.00 D1110-B CENTRAL VALLEY MYE SR 152 (NORTH) TO ROAD 19 MYE ALTERNATIVE TRACK PLAN AND PROFILE SJD-FRE STA 6122+00.00 TO 6122+00.00 D1150-B CENTRAL VALLEY MYE SR 152 (NORTH) TO ROAD 19 MYE ALTERNATIVE TRACK PLAN AND PROFILE SJD-FRE STA 6122+00.00 TO 6122+00.00 D1150-B CENTRAL VALLEY MYE SR 152 (NORTH) TO ROAD 19 MYE ALTERNATIVE TRACK PLAN AND PROFILE SJD-FRE STA 6122+00.00 TO 6234+00.00 D1150-B CENTRAL VALLEY MYE SR 152 (NORTH) TO ROAD 19 MYE ALTERNATIVE TRACK PLAN AND PROFILE SJD-FRE STA 6122+00.00 TO 6234+00.00 D1150-B CENTRAL VALLEY MYE SR 152 (NORTH) TO ROAD 19 MYE ALTERNATIVE TRACK PLAN AND PROFILE SJD-FRE STA 6122+00.0			SR 152 (NORTH) TO ROAD 19 WYE ALTERNATIVE		SJD-FRE STA 6346+00.00 TO 6402+00.00
D1040-B CENTRAL VALLEY WYE SR 152 (NORTH) TO ROAD 19 WYE ALTERNATIVE TRACK PLAN AND PROFILE SJD-FRE STA 5506+00.00 TO 5562+00.00  D1050-B CENTRAL VALLEY WYE SR 152 (NORTH) TO ROAD 19 WYE ALTERNATIVE TRACK PLAN AND PROFILE SJD-FRE STA 5506+00.00 TO 5618+00.00  D1070-B CENTRAL VALLEY WYE SR 152 (NORTH) TO ROAD 19 WYE ALTERNATIVE TRACK PLAN AND PROFILE SJD-FRE STA 5618+00.00 TO 5730+00.00  D1070-B CENTRAL VALLEY WYE SR 152 (NORTH) TO ROAD 19 WYE ALTERNATIVE TRACK PLAN AND PROFILE SJD-FRE STA 5674+00.00 TO 5786+00.00  D1090-B CENTRAL VALLEY WYE SR 152 (NORTH) TO ROAD 19 WYE ALTERNATIVE TRACK PLAN AND PROFILE SJD-FRE STA 5730+00.00 TO 5842+00.00  D1100-B CENTRAL VALLEY WYE SR 152 (NORTH) TO ROAD 19 WYE ALTERNATIVE TRACK PLAN AND PROFILE SJD-FRE STA 5786+00.00 TO 5889+00.00  D1110-B CENTRAL VALLEY WYE SR 152 (NORTH) TO ROAD 19 WYE ALTERNATIVE TRACK PLAN AND PROFILE SJD-FRE STA 5842+00.00 TO 5898+00.00  D1110-B CENTRAL VALLEY WYE SR 152 (NORTH) TO ROAD 19 WYE ALTERNATIVE TRACK PLAN AND PROFILE SJD-FRE STA 5898+00.00 TO 5954+00.00  D1110-B CENTRAL VALLEY WYE SR 152 (NORTH) TO ROAD 19 WYE ALTERNATIVE TRACK PLAN AND PROFILE SJD-FRE STA 5954+00.00 TO 6010+00.00  D1130-B CENTRAL VALLEY WYE SR 152 (NORTH) TO ROAD 19 WYE ALTERNATIVE TRACK PLAN AND PROFILE SJD-FRE STA 5954+00.00 TO 6060+00.00  D1140-B CENTRAL VALLEY WYE SR 152 (NORTH) TO ROAD 19 WYE ALTERNATIVE TRACK PLAN AND PROFILE SJD-FRE STA 6010+00.00 TO 6060+00.00  D1140-B CENTRAL VALLEY WYE SR 152 (NORTH) TO ROAD 19 WYE ALTERNATIVE TRACK PLAN AND PROFILE SJD-FRE STA 6060+00.00 TO 6122+00.00  D1150-B CENTRAL VALLEY WYE SR 152 (NORTH) TO ROAD 19 WYE ALTERNATIVE TRACK PLAN AND PROFILE SJD-FRE STA 6060+00.00 TO 6122+00.00  D1150-B CENTRAL VALLEY WYE SR 152 (NORTH) TO ROAD 19 WYE ALTERNATIVE TRACK PLAN AND PROFILE SJD-FRE STA 6060+00.00 TO 6122+00.00  D1150-B CENTRAL VALLEY WYE SR 152 (NORTH) TO ROAD 19 WYE ALTERNATIVE TRACK PLAN AND PROFILE SJD-FRE STA 6122+00.00 TO 6178+00.00  D1150-B CENTRAL VALLEY WYE SR 152 (NORTH) TO ROAD 19 WYE ALTERNATIVE TRACK PLAN AND PROFILE SJD-		CENTRAL VALLEY WYE	SR 152 (NORTH) TO ROAD 19 WYE ALTERNATIVE	TRACK PLAN AND PROFILE	
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-D1040-B CENTRAL VALLEY WYE SR 152 (NORTH) TO ROAD 19 WYE ALTERNATIVE TRACK PLAN AND PROFILE SJD-FRE STA 5506+00.00 TO 5562+00.00 -D1050-B CENTRAL VALLEY WYE SR 152 (NORTH) TO ROAD 19 WYE ALTERNATIVE TRACK PLAN AND PROFILE SJD-FRE STA 5562+00.00 TO 5618+00.00 -D1060-B CENTRAL VALLEY WYE SR 152 (NORTH) TO ROAD 19 WYE ALTERNATIVE TRACK PLAN AND PROFILE SJD-FRE STA 5618+00.00 TO 5674+00.00 -D1070-B CENTRAL VALLEY WYE SR 152 (NORTH) TO ROAD 19 WYE ALTERNATIVE TRACK PLAN AND PROFILE SJD-FRE STA 5730+00.00 TO 5730+00.00 -D1080-B CENTRAL VALLEY WYE SR 152 (NORTH) TO ROAD 19 WYE ALTERNATIVE TRACK PLAN AND PROFILE SJD-FRE STA 5730+00.00 TO 5786+00.00 -D1090-B CENTRAL VALLEY WYE SR 152 (NORTH) TO ROAD 19 WYE ALTERNATIVE TRACK PLAN AND PROFILE SJD-FRE STA 5786+00.00 TO 5842+00.00 -D1100-B CENTRAL VALLEY WYE SR 152 (NORTH) TO ROAD 19 WYE ALTERNATIVE TRACK PLAN AND PROFILE SJD-FRE STA 5842+00.00 TO 5898+00.00 -D1110-B CENTRAL VALLEY WYE SR 152 (NORTH) TO ROAD 19 WYE ALTERNATIVE TRACK PLAN AND PROFILE SJD-FRE STA 5889+00.00 TO 5954+00.00 -D1120-B CENTRAL VALLEY WYE SR 152 (NORTH) TO ROAD 19 WYE ALTERNATIVE TRACK PLAN AND PROFILE SJD-FRE STA 5954+00.00 TO 5954+00.00 -D1130-B CENTRAL VALLEY WYE SR 152 (NORTH) TO ROAD 19 WYE ALTERNATIVE TRACK PLAN AND PROFILE SJD-FRE STA 5954+00.00 TO 6010+00.00 -D1130-B CENTRAL VALLEY WYE SR 152 (NORTH) TO ROAD 19 WYE ALTERNATIVE TRACK PLAN AND PROFILE SJD-FRE STA 6010+00.00 TO 6066+00.00 -D1140-B CENTRAL VALLEY WYE SR 152 (NORTH) TO ROAD 19 WYE ALTERNATIVE TRACK PLAN AND PROFILE SJD-FRE STA 6010+00.00 TO 6066+00.00 -D1140-B CENTRAL VALLEY WYE SR 152 (NORTH) TO ROAD 19 WYE ALTERNATIVE TRACK PLAN AND PROFILE SJD-FRE STA 6066+00.00 TO 6066+00.00 -D1140-B CENTRAL VALLEY WYE SR 152 (NORTH) TO ROAD 19 WYE ALTERNATIVE TRACK PLAN AND PROFILE SJD-FRE STA 6066+00.00 TO 6072+00.00 -D1140-B CENTRAL VALLEY WYE SR 152 (NORTH) TO ROAD 19 WYE ALTERNATIVE TRACK PLAN AND PROFILE SJD-FRE STA 6066+00.00 TO 6072+00.00 -D1140-B CENTRAL VALLEY WYE SR 152 (NORTH) TO ROAD 19 WYE ALTERNATIVE TRACK PLAN AND PROFILE SJD	-D1160-B	CENTRAL VALLEY WYE	SR 152 (NORTH) TO ROAD 19 WYE ALTERNATIVE	TRACK PLAN AND PROFILE	SJD-FRE STA 6178+00.00 TO 6234+00.00
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D1040-B CENTRAL VALLEY WYE SR 152 (NORTH) TO ROAD 19 WYE ALTERNATIVE TRACK PLAN AND PROFILE SJD-FRE STA 5506+00.00 TO 5562+00.00 TO 5662+00.00	-D1140-B	CENTRAL VALLEY WYE	SR 152 (NORTH) TO ROAD 19 WYE ALTERNATIVE	TRACK PLAN AND PROFILE	SJD-FRE STA 6066+00.00 TO 6122+00.00
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TRACK PLAN AND PROFILE SJD-FRE STA 5506+00.00 TO 5562+00.00 TO 5618+00.00 TO 5618+00.0	-D1110-B	CENTRAL VALLEY WYE	SR 152 (NORTH) TO ROAD 19 WYE ALTERNATIVE	TRACK PLAN AND PROFILE	SJD-FRE STA 5898+00.00 TO 5954+00.00
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-D1040-B CENTRAL VALLEY WYE SR 152 (NORTH) TO ROAD 19 WYE ALTERNATIVE TRACK PLAN AND PROFILE SJD-FRE STA 5506+00.00 TO 5562+00.00	-D1060-B	CENTRAL VALLEY WYE	SR 152 (NORTH) TO ROAD 19 WYE ALTERNATIVE	TRACK PLAN AND PROFILE	SJD-FRE STA 5618+00.00 TO 5674+00.00
	-D1050-B	CENTRAL VALLEY WYE	SR 152 (NORTH) TO ROAD 19 WYE ALTERNATIVE	TRACK PLAN AND PROFILE	SJD-FRE STA 5562+00.00 TO 5618+00.00
-D1030-B CENTRAL VALLEY WYE SR 152 (NORTH) TO ROAD 19 WYE ALTERNATIVE TRACK PLAN AND PROFILE SJD-FRE STA 5450+00.00 TO 5506+00.00	-D1040-B	CENTRAL VALLEY WYE	SR 152 (NORTH) TO ROAD 19 WYE ALTERNATIVE	TRACK PLAN AND PROFILE	SJD-FRE STA 5506+00.00 TO 5562+00.00
	-D1030-B	CENTRAL VALLEY WYE	SR 152 (NORTH) TO ROAD 19 WYE ALTERNATIVE	TRACK PLAN AND PROFILE	SJD-FRE STA 5450+00.00 TO 5506+00.00

INDEX OF DRAWINGS

TITLE

ALIGNMENT / PLAN SET

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			11 6	7100	0	CENTICAL VALLET WIL	311 132 (11011	TIT) TO NOAL	
			TT-[	166	1-B	CENTRAL VALLEY WYE	SR 152 (NOR	TH) TO ROAD	) 1
		-	TT-C	000	1 – C	CENTRAL VALLEY WYE	AVENUE 2	TO ROAD 1	3
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			TT-C	000	3-C	CENTRAL VALLEY WYE	AVENUE 2	TO ROAD 1	3
			TT-C	000	4-C	CENTRAL VALLEY WYE	AVENUE 2	TO ROAD 1	3
								SIGNED BY	T
								J. ALADIN	ı
								ECKED BY	
							IN	CHARGE	1
								C. LEMLEY	-
REV	DATE		BY	CHK	APP	DESCRIPTION		08/12/2016	

RECORD SET
15% DESIGN
SUBMITTAL
NOT FOR
CONSTRUCTION





# CALIFORNIA HIGH-SPEED TRAIN PROJECT MERCED TO FRESNO SECTION

DESCRIPTION

CENTRAL VALLEY WYE ALIGNMENT AND TYPICAL SECTION PLANS INDEX OF DRAWINGS SHEET 5 OF 9

CONTRACT NO. HSR08-05
DRAWING NO. TT-B0006
SCALE NO SCALE

SHEET NO.

TT-D1460-B	CENTRAL VALLEY WYE	SR 152 (NORTH) TO ROAD 19 WYE ALTERNATIVE	TRACK PLAN	MER-FRE STA 14995+00.00 TO 15051+00.00
TT-D1461-B	CENTRAL VALLEY WYE	SR 152 (NORTH) TO ROAD 19 WYE ALTERNATIVE	TRACK PROFILE	MER-FRE STA 14995+00.00 TO 15051+00.00
TT-D1470-B	CENTRAL VALLEY WYE	SR 152 (NORTH) TO ROAD 19 WYE ALTERNATIVE	TRACK PLAN	MER-FRE STA 15051+00.00 TO 15107+00.00
TT-D1471-B	CENTRAL VALLEY WYE	SR 152 (NORTH) TO ROAD 19 WYE ALTERNATIVE	TRACK PROFILE	MER-FRE STA 15051+00.00 TO 15107+00.00
TT-D1480-B	CENTRAL VALLEY WYE	SR 152 (NORTH) TO ROAD 19 WYE ALTERNATIVE	TRACK PLAN	MER-FRE STA 15107+00.00 TO 15163+00.00
TT-D1481-B	CENTRAL VALLEY WYE	SR 152 (NORTH) TO ROAD 19 WYE ALTERNATIVE	TRACK PROFILE	MER-FRE STA 15107+00.00 TO 15163+00.00
TT-D1490-B	CENTRAL VALLEY WYE	SR 152 (NORTH) TO ROAD 19 WYE ALTERNATIVE	TRACK PLAN	MER-FRE STA 15163+00.00 TO 15219+00.00
TT-D1491-B	CENTRAL VALLEY WYE	SR 152 (NORTH) TO ROAD 19 WYE ALTERNATIVE	TRACK PROFILE	MER-FRE STA 15163+00.00 TO 15219+00.00
TT-D1500-B	CENTRAL VALLEY WYE	SR 152 (NORTH) TO ROAD 19 WYE ALTERNATIVE	TRACK PLAN	MER-FRE STA 15219+00.00 TO 15275+00.00
TT-D1501-B	CENTRAL VALLEY WYE	SR 152 (NORTH) TO ROAD 19 WYE ALTERNATIVE	TRACK PROFILE	MER-FRE STA 15219+00.00 TO 15275+00.00
TT-D1510-B	CENTRAL VALLEY WYE	SR 152 (NORTH) TO ROAD 19 WYE ALTERNATIVE	TRACK PLAN	MER-FRE STA 15275+00.00 TO 15331+00.00
TT-D1511-B	CENTRAL VALLEY WYE	SR 152 (NORTH) TO ROAD 19 WYE ALTERNATIVE	TRACK PROFILE	MER-FRE STA 15275+00.00 TO 15331+00.00
TT-D1520-B	CENTRAL VALLEY WYE	SR 152 (NORTH) TO ROAD 19 WYE ALTERNATIVE	TRACK PLAN	MER-FRE STA 15331+00.00 TO 15387+00.00
TT-D1521-B	CENTRAL VALLEY WYE	SR 152 (NORTH) TO ROAD 19 WYE ALTERNATIVE	TRACK PROFILE	MER-FRE STA 15331+00.00 TO 15387+00.00
TT-D1530-B	CENTRAL VALLEY WYE	SR 152 (NORTH) TO ROAD 19 WYE ALTERNATIVE	TRACK PLAN	MER-FRE STA 15387+00.00 TO 15443+00.00
TT-D1531-B	CENTRAL VALLEY WYE	SR 152 (NORTH) TO ROAD 19 WYE ALTERNATIVE	TRACK PROFILE	MER-FRE STA 15387+00.00 TO 15443+00.00
TT-D1540-B	CENTRAL VALLEY WYE	SR 152 (NORTH) TO ROAD 19 WYE ALTERNATIVE	TRACK PLAN	MER-FRE STA 15443+00.00 TO 15499+00.00
TT-D1541-B	CENTRAL VALLEY WYE	SR 152 (NORTH) TO ROAD 19 WYE ALTERNATIVE	TRACK PROFILE	MER-FRE STA 15443+00.00 TO 15499+00.00
TT-D1550-B	CENTRAL VALLEY WYE	SR 152 (NORTH) TO ROAD 19 WYE ALTERNATIVE	TRACK PLAN	MER-FRE STA 15499+00.00 TO 15555+00.00
TT-D1551-B	CENTRAL VALLEY WYE	SR 152 (NORTH) TO ROAD 19 WYE ALTERNATIVE	TRACK PROFILE	MER-FRE STA 15499+00.00 TO 15555+00.00
TT-D1560-B	CENTRAL VALLEY WYE	SR 152 (NORTH) TO ROAD 19 WYE ALTERNATIVE	TRACK PLAN	MER-FRE STA 15555+00.00 TO 15611+00.00
TT-D1561-B	CENTRAL VALLEY WYE	SR 152 (NORTH) TO ROAD 19 WYE ALTERNATIVE	TRACK PROFILE	MER-FRE STA 15555+00.00 TO 15611+00.00
TT-D1570-B	CENTRAL VALLEY WYE	SR 152 (NORTH) TO ROAD 19 WYE ALTERNATIVE	TRACK PLAN	MER-FRE STA 15611+00.00 TO 15655+00.00
TT-D1571-B	CENTRAL VALLEY WYE	SR 152 (NORTH) TO ROAD 19 WYE ALTERNATIVE	TRACK PROFILE	MER-FRE STA 15611+00.00 TO 15655+00.00
TT-D1610-B	CENTRAL VALLEY WYE	SR 152 (NORTH) TO ROAD 19 WYE ALTERNATIVE	TRACK PLAN	SJD-MER STA 36570+00.00 TO 36626+00.00
TT-D1611-B	CENTRAL VALLEY WYE	SR 152 (NORTH) TO ROAD 19 WYE ALTERNATIVE	TRACK PROFILE	SJD-MER STA 36570+00.00 TO 36626+00.00
TT-D1620-B	CENTRAL VALLEY WYE	SR 152 (NORTH) TO ROAD 19 WYE ALTERNATIVE	TRACK PLAN	SJD-MER STA 36626+00.00 TO 36682+00.00
TT-D1621-B	CENTRAL VALLEY WYE	SR 152 (NORTH) TO ROAD 19 WYE ALTERNATIVE	TRACK PROFILE	SJD-MER STA 36626+00.00 TO 36682+00.00
TT-D1630-B	CENTRAL VALLEY WYE	SR 152 (NORTH) TO ROAD 19 WYE ALTERNATIVE	TRACK PLAN	SJD-MER STA 36682+00.00 TO 36738+00.00
TT-D1631-B	CENTRAL VALLEY WYE	SR 152 (NORTH) TO ROAD 19 WYE ALTERNATIVE	TRACK PROFILE	SJD-MER STA 36682+00.00 TO 36738+00.00
TT-D1640-B	CENTRAL VALLEY WYE	SR 152 (NORTH) TO ROAD 19 WYE ALTERNATIVE	TRACK PLAN	SJD-MER STA 36738+00.00 TO 36794+00.00
TT-D1641-B	CENTRAL VALLEY WYE	SR 152 (NORTH) TO ROAD 19 WYE ALTERNATIVE	TRACK PROFILE	SJD-MER STA 36738+00.00 TO 36794+00.00
TT-D1650-B	CENTRAL VALLEY WYE	SR 152 (NORTH) TO ROAD 19 WYE ALTERNATIVE	TRACK PLAN	SJD-MER STA 36794+00.00 TO 36850+00.00
TT-D1651-B	CENTRAL VALLEY WYE	SR 152 (NORTH) TO ROAD 19 WYE ALTERNATIVE	TRACK PROFILE	SJD-MER STA 36794+00.00 TO 36850+00.00
TT-D1660-B	CENTRAL VALLEY WYE	SR 152 (NORTH) TO ROAD 19 WYE ALTERNATIVE	TRACK PLAN	SJD-MER STA 36850+00.00 TO 36857+28.64
TT-D1661-B	CENTRAL VALLEY WYE	SR 152 (NORTH) TO ROAD 19 WYE ALTERNATIVE	TRACK PROFILE	SJD-MER STA 36850+00.00 TO 36857+28.64
		AVENUE 21 TO RO	AD 13 WYE ALTERNATIVE	
TT-C0001-C	CENTRAL VALLEY WYE	AVENUE 21 TO ROAD 13 WYE ALTERNATIVE	KEY MAP	SHEET 1 OF 4
TT-C0002-C	CENTRAL VALLEY WYE	AVENUE 21 TO ROAD 13 WYE ALTERNATIVE	KEY MAP	SHEET 2 OF 4
TT-C0003-C	CENTRAL VALLEY WYE	AVENUE 21 TO ROAD 13 WYE ALTERNATIVE	KEY MAP	SHEET 3 OF 4
TT-C0004-C	CENTRAL VALLEY WYE	AVENUE 21 TO ROAD 13 WYE ALTERNATIVE	KEY MAP	SHEET 4 OF 4

INDEX OF DRAWINGS

ALIGNMENT / PLAN SET

TITLE

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REV	DATE		BY	снк	APP	DESCRIPTION	DATE		/2016		
							C.		MLEY		
								KED B	SON		
							J.		ADIN		
								SNED E	MLEY		
	· ·										
			TT-[	124	10-C	CENTRAL VALLEY WYE AVENUE	21	ТО	ROAD	13	W
		-	T T – [	0123	30-C	CENTRAL VALLEY WYE AVENUE	21	ТО	ROAD	13	W
		-	TT-[	122	20-C	CENTRAL VALLEY WYE AVENUE	21	ТО	ROAD	13	W
			T T – [	121	0-C	CENTRAL VALLEY WYE AVENUE	21	ТО	ROAD	13	W
		-	TT-C	120	0-C	CENTRAL VALLEY WYE AVENUE	21	ТО	ROAD	13	W
		-	TT-[	0119	0-C	CENTRAL VALLEY WYE AVENUE	21	ТО	ROAD	13	W
		-	TT-[	2118	30-C	CENTRAL VALLEY WYE AVENUE	21	ТО	ROAD	13	W
		-	TT-E	0117	70-C	CENTRAL VALLEY WYE AVENUE	21	ТО	ROAD	13	W

RECORD SET 15% DESIGN SUBMITTAL NOT FOR CONSTRUCTION





### CALIFORNIA HIGH-SPEED TRAIN PROJECT MERCED TO FRESNO SECTION

CENTRAL VALLEY WYE ALIGNMENT AND TYPICAL SECTION PLANS INDEX OF DRAWINGS SHEET 6 OF 9

CONTRACT NO. HSR08-05
DRAWING NO. TT-B0007
SCALE NO SCALE

SHEET NO.

DRAWING NO.	SECTION	ALIGNMENT / PLAN SET	TITLE	DESCRIPTION
TT-B0020-C	CENTRAL VALLEY WYE	AVENUE 21 TO ROAD 13 WYE ALTERNATIVE	TYPICAL SECTIONS	SHEET 1 OF 8
TT-B0021-C	CENTRAL VALLEY WYE	AVENUE 21 TO ROAD 13 WYE ALTERNATIVE	TYPICAL SECTIONS	SHEET 2 OF 8
T-B0022-C	CENTRAL VALLEY WYE	AVENUE 21 TO ROAD 13 WYE ALTERNATIVE	TYPICAL SECTIONS	SHEET 3 OF 8
T-B0023-C	CENTRAL VALLEY WYE	AVENUE 21 TO ROAD 13 WYE ALTERNATIVE	TYPICAL SECTIONS	SHEET 4 OF 8
T-B0024-C	CENTRAL VALLEY WYE	AVENUE 21 TO ROAD 13 WYE ALTERNATIVE	TYPICAL SECTIONS	SHEET 5 OF 8
T-B0025-C	CENTRAL VALLEY WYE	AVENUE 21 TO ROAD 13 WYE ALTERNATIVE	TYPICAL SECTIONS	SHEET 6 OF 8
T-B0026-C	CENTRAL VALLEY WYE	AVENUE 21 TO ROAD 13 WYE ALTERNATIVE	TYPICAL SECTIONS	SHEET 7 OF 8
T-B0027-C	CENTRAL VALLEY WYE	AVENUE 21 TO ROAD 13 WYE ALTERNATIVE	TYPICAL SECTIONS	SHEET 8 OF 8
T-B0050-C	CENTRAL VALLEY WYE	AVENUE 21 TO ROAD 13 WYE ALTERNATIVE	SB TRACK SAN JOSE TO FRESNO GEOMETRY DATA	SHEET 1 OF 9
T-B0051-C	CENTRAL VALLEY WYE	AVENUE 21 TO ROAD 13 WYE ALTERNATIVE	SB TRACK SAN JOSE TO FRESNO GEOMETRY DATA	SHEET 2 OF 9
Г-В0052-С	CENTRAL VALLEY WYE	AVENUE 21 TO ROAD 13 WYE ALTERNATIVE	SB TRACK SAN JOSE TO FRESNO GEOMETRY DATA	SHEET 3 OF 9
T-B0053-C	CENTRAL VALLEY WYE	AVENUE 21 TO ROAD 13 WYE ALTERNATIVE	NB TRACK SAN JOSE TO FRESNO GEOMETRY DATA	SHEET 4 OF 9
T-B0054-C	CENTRAL VALLEY WYE	AVENUE 21 TO ROAD 13 WYE ALTERNATIVE	NB TRACK SAN JOSE TO FRESNO GEOMETRY DATA	SHEET 5 OF 9
Г-В0055-С	CENTRAL VALLEY WYE	AVENUE 21 TO ROAD 13 WYE ALTERNATIVE	NB TRACK SAN JOSE TO FRESNO GEOMETRY DATA	SHEET 6 OF 9
Г-В0056-С	CENTRAL VALLEY WYE	AVENUE 21 TO ROAD 13 WYE ALTERNATIVE	SB TRACK MERCED TO FRESNO GEOMETRY DATA	SHEET 7 OF 9
Г-В0057-С	CENTRAL VALLEY WYE	AVENUE 21 TO ROAD 13 WYE ALTERNATIVE	NB TRACK MERCED TO FRESNO GEOMETRY DATA	SHEET 8 OF 9
-B0058-C	CENTRAL VALLEY WYE	AVENUE 21 TO ROAD 13 WYE ALTERNATIVE	NB & SB TRACK SAN JOSE TO MERCED GEOMETRY DATA	SHEET 9 OF 9
-D1010-C	CENTRAL VALLEY WYE	AVENUE 21 TO ROAD 13 WYE ALTERNATIVE	TRACK PLAN AND PROFILE	SJD-FRE STA 5338+00.00 TO 5394+00.
-D1020-C	CENTRAL VALLEY WYE	AVENUE 21 TO ROAD 13 WYE ALTERNATIVE	TRACK PLAN AND PROFILE	SJD-FRE STA 5394+00.00 TO 5450+00.
-D1030-C	CENTRAL VALLEY WYE	AVENUE 21 TO ROAD 13 WYE ALTERNATIVE	TRACK PLAN AND PROFILE	SJD-FRE STA 5450+00.00 TO 5506+00.
-D1040-C	CENTRAL VALLEY WYE	AVENUE 21 TO ROAD 13 WYE ALTERNATIVE	TRACK PLAN AND PROFILE	SJD-FRE STA 5506+00.00 TO 5562+00.
-D1050-C	CENTRAL VALLEY WYE	AVENUE 21 TO ROAD 13 WYE ALTERNATIVE	TRACK PLAN AND PROFILE	SJD-FRE STA 5562+00.00 TO 5618+00.
-D1060-C	CENTRAL VALLEY WYE	AVENUE 21 TO ROAD 13 WYE ALTERNATIVE	TRACK PLAN AND PROFILE	SJD-FRE STA 5618+00.00 TO 5674+00.
-D1070-C	CENTRAL VALLEY WYE	AVENUE 21 TO ROAD 13 WYE ALTERNATIVE	TRACK PLAN AND PROFILE	SJD-FRE STA 5674+00.00 TO 5730+00.
-D1080-C	CENTRAL VALLEY WYE	AVENUE 21 TO ROAD 13 WYE ALTERNATIVE	TRACK PLAN AND PROFILE	SJD-FRE STA 5730+00.00 TO 5786+00.
-D1090-C	CENTRAL VALLEY WYE	AVENUE 21 TO ROAD 13 WYE ALTERNATIVE	TRACK PLAN AND PROFILE	SJD-FRE STA 5786+00.00 TO 5842+00.
-D1100-C	CENTRAL VALLEY WYE	AVENUE 21 TO ROAD 13 WYE ALTERNATIVE	TRACK PLAN AND PROFILE	SJD-FRE STA 5842+00.00 TO 5898+00.
-D1110-C	CENTRAL VALLEY WYE	AVENUE 21 TO ROAD 13 WYE ALTERNATIVE	TRACK PLAN AND PROFILE	SJD-FRE STA 5898+00.00 TO 5954+00.
-D1120-C	CENTRAL VALLEY WYE	AVENUE 21 TO ROAD 13 WYE ALTERNATIVE	TRACK PLAN AND PROFILE	SJD-FRE STA 5954+00.00 TO 6010+00.
-D1130-C	CENTRAL VALLEY WYE	AVENUE 21 TO ROAD 13 WYE ALTERNATIVE	TRACK PLAN AND PROFILE	SJD-FRE STA 6010+00.00 TO 6066+00.
-D1140-C	CENTRAL VALLEY WYE	AVENUE 21 TO ROAD 13 WYE ALTERNATIVE	TRACK PLAN AND PROFILE	SJD-FRE STA 6066+00.00 TO 6122+00.
-D1150-C	CENTRAL VALLEY WYE	AVENUE 21 TO ROAD 13 WYE ALTERNATIVE	TRACK PLAN AND PROFILE	SJD-FRE STA 6122+00.00 TO 6178+00.
-D1160-C	CENTRAL VALLEY WYE	AVENUE 21 TO ROAD 13 WYE ALTERNATIVE	TRACK PLAN AND PROFILE	SJD-FRE STA 6178+00.00 TO 6234+00.
-D1170-C	CENTRAL VALLEY WYE	AVENUE 21 TO ROAD 13 WYE ALTERNATIVE	TRACK PLAN AND PROFILE	SJD-FRE STA 6234+00.00 TO 6290+00.
-D1180-C	CENTRAL VALLEY WYE	AVENUE 21 TO ROAD 13 WYE ALTERNATIVE	TRACK PLAN AND PROFILE	SJD-FRE STA 6290+00.00 TO 6346+00.
-D1190-C	CENTRAL VALLEY WYE	AVENUE 21 TO ROAD 13 WYE ALTERNATIVE	TRACK PLAN AND PROFILE	SJD-FRE STA 6346+00.00 TO 6402+00.
-D1200-C	CENTRAL VALLEY WYE	AVENUE 21 TO ROAD 13 WYE ALTERNATIVE	TRACK PLAN AND PROFILE	SJD-FRE STA 6402+00.00 TO 6458+00.
-D1210-C	CENTRAL VALLEY WYE	AVENUE 21 TO ROAD 13 WYE ALTERNATIVE	TRACK PLAN AND PROFILE	SJD-FRE STA 6458+00.00 TO 6514+00.
-D1220-C	CENTRAL VALLEY WYE	AVENUE 21 TO ROAD 13 WYE ALTERNATIVE	TRACK PLAN AND PROFILE	SJD-FRE STA 6514+00.00 TO 6570+00.
Γ-D1230-C	CENTRAL VALLEY WYE	AVENUE 21 TO ROAD 13 WYE ALTERNATIVE	TRACK PLAN AND PROFILE	SJD-FRE STA 6570+00.00 TO 6626+00.
Γ-D1240-C	CENTRAL VALLEY WYE	AVENUE 21 TO ROAD 13 WYE ALTERNATIVE	TRACK PLAN AND PROFILE	SJD-FRE STA 6626+00.00 TO 6682+00.

INDEX OF DRAWINGS

SECTION

TT-D1250-C CENTRAL VALLEY WYE

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DESCRIPTION

		DESIGNED BY C. LEMLEY DRAWN BY DRAWN BY 157 DESIGN		CALIFORNIA HIGH-SPEED
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TT-D1661-C	CENTRAL VALLEY WYE	AVENUE 21 TO ROAD 13 WYE ALTERNATIVE	TRACK PROFILE	SJD-MER STA 36548+00.00 TO 36567+19.00
TT-D1660-C	CENTRAL VALLEY WYE	AVENUE 21 TO ROAD 13 WYE ALTERNATIVE	TRACK PROFILE	SJD-MER STA 36492+00.00 TO 36546+00.00 SJD-MER STA 36548+00.00 TO 36567+19.00
TT-D1650-C	CENTRAL VALLEY WYE	AVENUE 21 TO ROAD 13 WYE ALTERNATIVE	TRACK PROFILE	SJD-MER STA 36492+00.00 TO 36548+00.00 SJD-MER STA 36492+00.00 TO 36548+00.00
TT-D1641-C	CENTRAL VALLEY WYE	AVENUE 21 TO ROAD 13 WYE ALTERNATIVE  AVENUE 21 TO ROAD 13 WYE ALTERNATIVE	TRACK PROFILE  TRACK PLAN	SJD-MER STA 36436+00.00 TO 36492+00.00 SJD-MER STA 36492+00.00 TO 36548+00.00
	CENTRAL VALLEY WYE	AVENUE 21 TO ROAD 13 WYE ALTERNATIVE	TRACK PLAN	SJD-MER STA 36436+00.00 TO 36492+00.00 SJD-MER STA 36436+00.00 TO 36492+00.00
TT-D1631-C	CENTRAL VALLEY WYE	AVENUE 21 TO ROAD 13 WYE ALTERNATIVE	TRACK PROFILE	
TT-D1630-C	CENTRAL VALLEY WYE	AVENUE 21 TO ROAD 13 WYE ALTERNATIVE	TRACK PLAN	SJD-MER STA 36380+00.00 TO 36436+00.00 SJD-MER STA 36380+00.00 TO 36436+00.00
TT-D1621-C	CENTRAL VALLEY WYE	AVENUE 21 TO ROAD 13 WYE ALTERNATIVE	TRACK PROFILE	SJD-MER STA 36324+00.00 TO 36380+00.00
TT-D1620-C	CENTRAL VALLEY WYE	AVENUE 21 TO ROAD 13 WYE ALTERNATIVE	TRACK PLAN	SJD-MER STA 36324+00.00 TO 36380+00.00
TT-D1611-C	CENTRAL VALLEY WYE	AVENUE 21 TO ROAD 13 WYE ALTERNATIVE	TRACK PROFILE	SJD-MER STA 36269+99.76 TO 36324+00.00
TT-D1610-C	CENTRAL VALLEY WYE	AVENUE 21 TO ROAD 13 WYE ALTERNATIVE	TRACK PLAN	SJD-MER STA 36269+99.76 TO 36324+00.00
TT-D1550-C	CENTRAL VALLEY WYE	AVENUE 21 TO ROAD 13 WYE ALTERNATIVE	TRACK PLAN AND PROFILE	MER-FRE STA 15624+00.00 TO 15655+00.00
TT-D1540-C	CENTRAL VALLEY WYE	AVENUE 21 TO ROAD 13 WYE ALTERNATIVE	TRACK PLAN AND PROFILE	MER-FRE STA 15568+00.00 TO 15624+00.00
TT-D1530-C	CENTRAL VALLEY WYE	AVENUE 21 TO ROAD 13 WYE ALTERNATIVE	TRACK PLAN AND PROFILE	MER-FRE STA 15512+00.00 TO 15568+00.00
TT-D1520-C	CENTRAL VALLEY WYE	AVENUE 21 TO ROAD 13 WYE ALTERNATIVE	TRACK PLAN AND PROFILE	MER-FRE STA 15456+00.00 TO 15512+00.00
TT-D1510-C	CENTRAL VALLEY WYE	AVENUE 21 TO ROAD 13 WYE ALTERNATIVE	TRACK PLAN AND PROFILE	MER-FRE STA 15400+00.00 TO 15456+00.00
TT-D1500-C	CENTRAL VALLEY WYE	AVENUE 21 TO ROAD 13 WYE ALTERNATIVE	TRACK PLAN AND PROFILE	MER-FRE STA 15344+00.00 TO 15400+00.00
TT-D1490-C	CENTRAL VALLEY WYE	AVENUE 21 TO ROAD 13 WYE ALTERNATIVE	TRACK PLAN AND PROFILE	MER-FRE STA 15288+00.00 TO 15344+00.00
TT-D1480-C	CENTRAL VALLEY WYE	AVENUE 21 TO ROAD 13 WYE ALTERNATIVE	TRACK PLAN AND PROFILE	MER-FRE STA 15232+00.00 TO 15288+00.00
TT-D1470-C	CENTRAL VALLEY WYE	AVENUE 21 TO ROAD 13 WYE ALTERNATIVE	TRACK PLAN AND PROFILE	MER-FRE STA 15176+00.00 TO 15232+00.00
TT-D1460-C	CENTRAL VALLEY WYE	AVENUE 21 TO ROAD 13 WYE ALTERNATIVE	TRACK PLAN AND PROFILE	MER-FRE STA 15120+00.00 TO 15176+00.00
TT-D1451-C	CENTRAL VALLEY WYE	AVENUE 21 TO ROAD 13 WYE ALTERNATIVE	TRACK PROFILE	MER-FRE STA 15064+00.00 TO 15120+00.00
TT-D1450-C	CENTRAL VALLEY WYE	AVENUE 21 TO ROAD 13 WYE ALTERNATIVE	TRACK PLAN	MER-FRE STA 15064+00.00 TO 15120+00.00
TT-D1441-C	CENTRAL VALLEY WYE	AVENUE 21 TO ROAD 13 WYE ALTERNATIVE	TRACK PROFILE	MER-FRE STA 15008+00.00 TO 15064+00.00
TT-D1440-C	CENTRAL VALLEY WYE	AVENUE 21 TO ROAD 13 WYE ALTERNATIVE	TRACK PLAN	MER-FRE STA 15008+00.00 TO 15064+00.00
TT-D1431-C	CENTRAL VALLEY WYE	AVENUE 21 TO ROAD 13 WYE ALTERNATIVE	TRACK PROFILE	MER-FRE STA 14952+00.00 TO 15008+00.00
TT-D1430-C	CENTRAL VALLEY WYE	AVENUE 21 TO ROAD 13 WYE ALTERNATIVE	TRACK PLAN	MER-FRE STA 14952+00.00 TO 15008+00.00
TT-D1421-C	CENTRAL VALLEY WYE	AVENUE 21 TO ROAD 13 WYE ALTERNATIVE	TRACK PROFILE	MER-FRE STA 14896+00.00 TO 14952+00.00
TT-D1420-C	CENTRAL VALLEY WYE	AVENUE 21 TO ROAD 13 WYE ALTERNATIVE	TRACK PLAN	MER-FRE STA 14896+00.00 TO 14952+00.00
TT-D1411-C	CENTRAL VALLEY WYE	AVENUE 21 TO ROAD 13 WYE ALTERNATIVE	TRACK PROFILE	MER-FRE STA 14840+42.06 TO 14896+00.00
TT-D1410-C	CENTRAL VALLEY WYE	AVENUE 21 TO ROAD 13 WYE ALTERNATIVE	TRACK PLAN	MER-FRE STA 14840+42.06 TO 14896+00.00
TT-D1330-C	CENTRAL VALLEY WYE	AVENUE 21 TO ROAD 13 WYE ALTERNATIVE	TRACK PLAN AND PROFILE	SJD-FRE STA 7130+00.00 TO 7147+86.07
TT-D1320-C	CENTRAL VALLEY WYE	AVENUE 21 TO ROAD 13 WYE ALTERNATIVE	TRACK PLAN AND PROFILE	SJD-FRE STA 7074+00.00 TO 7130+00.00
TT-D1310-C	CENTRAL VALLEY WYE	AVENUE 21 TO ROAD 13 WYE ALTERNATIVE	TRACK PLAN AND PROFILE	SJD-FRE STA 7018+00.00 TO 7074+00.00
TT-D1300-C	CENTRAL VALLEY WYE	AVENUE 21 TO ROAD 13 WYE ALTERNATIVE	TRACK PLAN AND PROFILE	SJD-FRE STA 6962+00.00 TO 7018+00.00
TT-D1290-C	CENTRAL VALLEY WYE	AVENUE 21 TO ROAD 13 WYE ALTERNATIVE	TRACK PLAN AND PROFILE	SJD-FRE STA 6906+00.00 TO 6962+00.00
TT-D1280-C	CENTRAL VALLEY WYE	AVENUE 21 TO ROAD 13 WYE ALTERNATIVE	TRACK PLAN AND PROFILE	SJD-FRE STA 6850+00.00 TO 6906+00.00
TT-D1270-C	CENTRAL VALLEY WYE	AVENUE 21 TO ROAD 13 WYE ALTERNATIVE	TRACK PLAN AND PROFILE	SJD-FRE STA 6794+00.00 TO 6850+00.00
TT-D1260-C	CENTRAL VALLEY WYE	AVENUE 21 TO ROAD 13 WYE ALTERNATIVE	TRACK PLAN AND PROFILE	SJD-FRE STA 6738+00.00 TO 6794+00.00
11-D1250-C	CENTRAL VALLEY WYE	AVENUE ZI TO ROAD IS WYE ALTERNATIVE	TRACK PLAN AND PROFILE	SJD-FRE STA 6682+00.00 TO 6738+00.00

PARSONS

CALIFORNIA

INDEX OF DRAWINGS

TITLE

TRACK PLAN AND PROFILE

ALIGNMENT / PLAN SET

AVENUE 21 TO ROAD 13 WYE ALTERNATIVE

DRAWN BY
J. ALADIN

CHECKED BY
S. WILSON

N CHARGE
C. LEMLEY

08/12/2016

15% DESIGN

SUBMITTAL

NOT FOR

CONSTRUCTION

### CALIFORNIA HIGH-SPEED TRAIN PROJECT CONTRACT NO. HSRO8-0 MERCED TO FRESNO SECTION

DESCRIPTION

SJD-FRE STA 6682+00.00 TO 6738+00.00

CENTRAL VALLEY WYE ALIGNMENT AND TYPICAL SECTION PLANS INDEX OF DRAWINGS SHEET 7 OF 9

<b>6</b> I	HSRO8-C
	DRAWING NO.
	TT-B000

SCALE NO SCALE SHEET NO.

70.000.00

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16.							DESIGNED BY
•							C. LEMLEY
							DRAWN BY
							J. ALADIN
							CHECKED BY
56							S. WILSON
22							IN CHARGE
p00422							C. LEMLEY
0							DATE
б	REV	DATE	BY	CHK	APP	DESCRIPTION	08/12/2016

RECORD SET
15% DESIGN
SUBMITTAL
NOT FOR
CONSTRUCTION





# CALIFORNIA HIGH-SPEED TRAIN PROJECT MERCED TO FRESNO SECTION

CENTRAL VALLEY WYE ALIGNMENT AND TYPICAL SECTION PLANS INDEX OF DRAWINGS SHEET 8 OF 9

HSR08-05
DRAWING NO. TT-B0009
NO SCALE
SHEET NO.

DRAWING NO.	SECTION	ALIGNMENT / PLAN SET	TITLE	DESCRIPTION
		SR 152 (NORTH) TO	ROAD 11 WYE ALTERNATIVE	
TT-C4001-D	CENTRAL VALLEY WYE	SR 152 (NORTH) TO ROAD 11 WYE ALTERNATIVE	KEY MAP	SHEET 1 OF 3
TT-C4002-D	CENTRAL VALLEY WYE	SR 152 (NORTH) TO ROAD 11 WYE ALTERNATIVE	KEY MAP	SHEET 2 OF 3
TT-C4003-D	CENTRAL VALLEY WYE	SR 152 (NORTH) TO ROAD 11 WYE ALTERNATIVE	KEY MAP	SHEET 3 OF 3
TT-B0020-D	CENTRAL VALLEY WYE	SR 152 (NORTH) TO ROAD 11 WYE ALTERNATIVE	TYPICAL SECTION	SHEET 1 OF 11
TT-B0021-D	CENTRAL VALLEY WYE	SR 152 (NORTH) TO ROAD 11 WYE ALTERNATIVE	TYPICAL SECTION	SHEET 2 OF 11
TT-B0022-D	CENTRAL VALLEY WYE	SR 152 (NORTH) TO ROAD 11 WYE ALTERNATIVE	TYPICAL SECTION	SHEET 3 OF 11
TT-B0023-D	CENTRAL VALLEY WYE	SR 152 (NORTH) TO ROAD 11 WYE ALTERNATIVE	TYPICAL SECTION	SHEET 4 OF 11
TT-B0024-D	CENTRAL VALLEY WYE	SR 152 (NORTH) TO ROAD 11 WYE ALTERNATIVE	TYPICAL SECTION	SHEET 5 OF 11
TT-B0025-D	CENTRAL VALLEY WYE	SR 152 (NORTH) TO ROAD 11 WYE ALTERNATIVE	TYPICAL SECTION	SHEET 6 OF 11
TT-B0026-D	CENTRAL VALLEY WYE	SR 152 (NORTH) TO ROAD 11 WYE ALTERNATIVE	TYPICAL SECTION	SHEET 7 OF 11
TT-B0027-D	CENTRAL VALLEY WYE	SR 152 (NORTH) TO ROAD 11 WYE ALTERNATIVE	TYPICAL SECTION	SHEET 8 OF 11
TT-B0028-D	CENTRAL VALLEY WYE	SR 152 (NORTH) TO ROAD 11 WYE ALTERNATIVE	TYPICAL SECTION	SHEET 9 OF 11
TT-B0029-D	CENTRAL VALLEY WYE	SR 152 (NORTH) TO ROAD 11 WYE ALTERNATIVE	TYPICAL SECTION	SHEET 10 OF 11
TT-B0030-D	CENTRAL VALLEY WYE	SR 152 (NORTH) TO ROAD 11 WYE ALTERNATIVE	TYPICAL SECTION	SHEET 11 OF 11
TT-B0050-D	CENTRAL VALLEY WYE	SR 152 (NORTH) TO ROAD 11 WYE ALTERNATIVE	SB TRACK SAN JOSE TO FRESNO GEOMETRY DATA	SHEET 1 OF 7
TT-B0051-D	CENTRAL VALLEY WYE	SR 152 (NORTH) TO ROAD 11 WYE ALTERNATIVE	SB TRACK SAN JOSE TO FRESNO GEOMETRY DATA	SHEET 2 OF 7
TT-B0052-D	CENTRAL VALLEY WYE	SR 152 (NORTH) TO ROAD 11 WYE ALTERNATIVE	NB TRACK SAN JOSE TO FRESNO GEOMETRY DATA	SHEET 3 OF 7
TT-B0053-D	CENTRAL VALLEY WYE	SR 152 (NORTH) TO ROAD 11 WYE ALTERNATIVE	NB TRACK SAN JOSE TO FRESNO GEOMETRY DATA	SHEET 4 OF 7
TT-B0054-D	CENTRAL VALLEY WYE	SR 152 (NORTH) TO ROAD 11 WYE ALTERNATIVE	SB TRACK MERCED TO FRESNO GEOMETRY DATA	SHEET 5 OF 7
TT-B0055-D	CENTRAL VALLEY WYE	SR 152 (NORTH) TO ROAD 11 WYE ALTERNATIVE	NB TRACK MERCED TO FRESNO GEOMETRY DATA	SHEET 6 OF 7
TT-B0056-D	CENTRAL VALLEY WYE	SR 152 (NORTH) TO ROAD 11 WYE ALTERNATIVE	SB & NB TRACK SAN JOSE TO MERCED GEOMETRY DATA	SHEET 7 OF 7
TT-D1010-D	CENTRAL VALLEY WYE	SR 152 (NORTH) TO ROAD 11 WYE ALTERNATIVE	TRACK PLAN AND PROFILE	SJD-FRE STA 5338+00.00 TO 5394+00.0
TT-D1020-D	CENTRAL VALLEY WYE	SR 152 (NORTH) TO ROAD 11 WYE ALTERNATIVE	TRACK PLAN AND PROFILE	SJD-FRE STA 5394+00.00 TO 5450+00.0
TT-D1030-D	CENTRAL VALLEY WYE	SR 152 (NORTH) TO ROAD 11 WYE ALTERNATIVE	TRACK PLAN AND PROFILE	SJD-FRE STA 5450+00.00 TO 5506+00.0
TT-D1040-D	CENTRAL VALLEY WYE	SR 152 (NORTH) TO ROAD 11 WYE ALTERNATIVE	TRACK PLAN AND PROFILE	SJD-FRE STA 5506+00.00 TO 5562+00.0
TT-D1050-D	CENTRAL VALLEY WYE	SR 152 (NORTH) TO ROAD 11 WYE ALTERNATIVE	TRACK PLAN AND PROFILE	SJD-FRE STA 5562+00.00 TO 5618+00.0
TT-D1060-D	CENTRAL VALLEY WYE	SR 152 (NORTH) TO ROAD 11 WYE ALTERNATIVE	TRACK PLAN AND PROFILE	SJD-FRE STA 5618+00.00 TO 5674+00.0
TT-D1070-D	CENTRAL VALLEY WYE	SR 152 (NORTH) TO ROAD 11 WYE ALTERNATIVE	TRACK PLAN AND PROFILE	SJD-FRE STA 5674+00.00 TO 5730+00.0
TT-D1080-D	CENTRAL VALLEY WYE	SR 152 (NORTH) TO ROAD 11 WYE ALTERNATIVE	TRACK PLAN AND PROFILE	SJD-FRE STA 5730+00.00 TO 5786+00.0
TT-D1090-D	CENTRAL VALLEY WYE	SR 152 (NORTH) TO ROAD 11 WYE ALTERNATIVE	TRACK PLAN AND PROFILE	SJD-FRE STA 5786+00.00 TO 5842+00.0
TT-D1100-D	CENTRAL VALLEY WYE	SR 152 (NORTH) TO ROAD 11 WYE ALTERNATIVE	TRACK PLAN AND PROFILE	SJD-FRE STA 5842+00.00 TO 5898+00.0
TT-D1110-D	CENTRAL VALLEY WYE	SR 152 (NORTH) TO ROAD 11 WYE ALTERNATIVE	TRACK PLAN AND PROFILE	SJD-FRE STA 5898+00.00 TO 5954+00.0
TT-D1120-D	CENTRAL VALLEY WYE	SR 152 (NORTH) TO ROAD 11 WYE ALTERNATIVE	TRACK PLAN AND PROFILE	SJD-FRE STA 5954+00.00 TO 6010+00.0
TT-D1130-D	CENTRAL VALLEY WYE	SR 152 (NORTH) TO ROAD 11 WYE ALTERNATIVE	TRACK PLAN AND PROFILE	SJD-FRE STA 6010+00.00 TO 6066+00.0
TT-D1140-D	CENTRAL VALLEY WYE	SR 152 (NORTH) TO ROAD 11 WYE ALTERNATIVE	TRACK PLAN AND PROFILE	SJD-FRE STA 6066+00.00 TO 6122+00.0
TT-D1150-D	CENTRAL VALLEY WYE	SR 152 (NORTH) TO ROAD 11 WYE ALTERNATIVE	TRACK PLAN AND PROFILE	SJD-FRE STA 6122+00.00 TO 6178+00.0
TT-D1160-D	CENTRAL VALLEY WYE	SR 152 (NORTH) TO ROAD 11 WYE ALTERNATIVE	TRACK PLAN AND PROFILE	SJD-FRE STA 6178+00.00 TO 6234+00.0
TT-D1170-D	CENTRAL VALLEY WYE	SR 152 (NORTH) TO ROAD 11 WYE ALTERNATIVE	TRACK PLAN AND PROFILE	SJD-FRE STA 6234+00.00 TO 6290+00.0
TT-D1180-D	CENTRAL VALLEY WYE	SR 152 (NORTH) TO ROAD 11 WYE ALTERNATIVE	TRACK PLAN AND PROFILE	SJD-FRE STA 6290+00.00 TO 6346+00.0
TT-D1190-D	CENTRAL VALLEY WYE	SR 152 (NORTH) TO ROAD 11 WYE ALTERNATIVE	TRACK PLAN AND PROFILE	SJD-FRE STA 6346+00.00 TO 6402+00.0

INDEX OF DRAWINGS

INDEX OF DRAWINGS

16-AUG-201610:02

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CONSTRUCTION






# CALIFORNIA HIGH-SPEED TRAIN PROJECT MERCED TO FRESNO SECTION

CENTRAL VALLEY WYE
ALIGNMENT AND TYPICAL SECTION PLANS
INDEX OF DRAWINGS
SHEET 9 OF 9

CONTRACT NO. HSR08-05	
DRAWING NO. TT-B0010	
NO SCALE	
SHEET NO.	

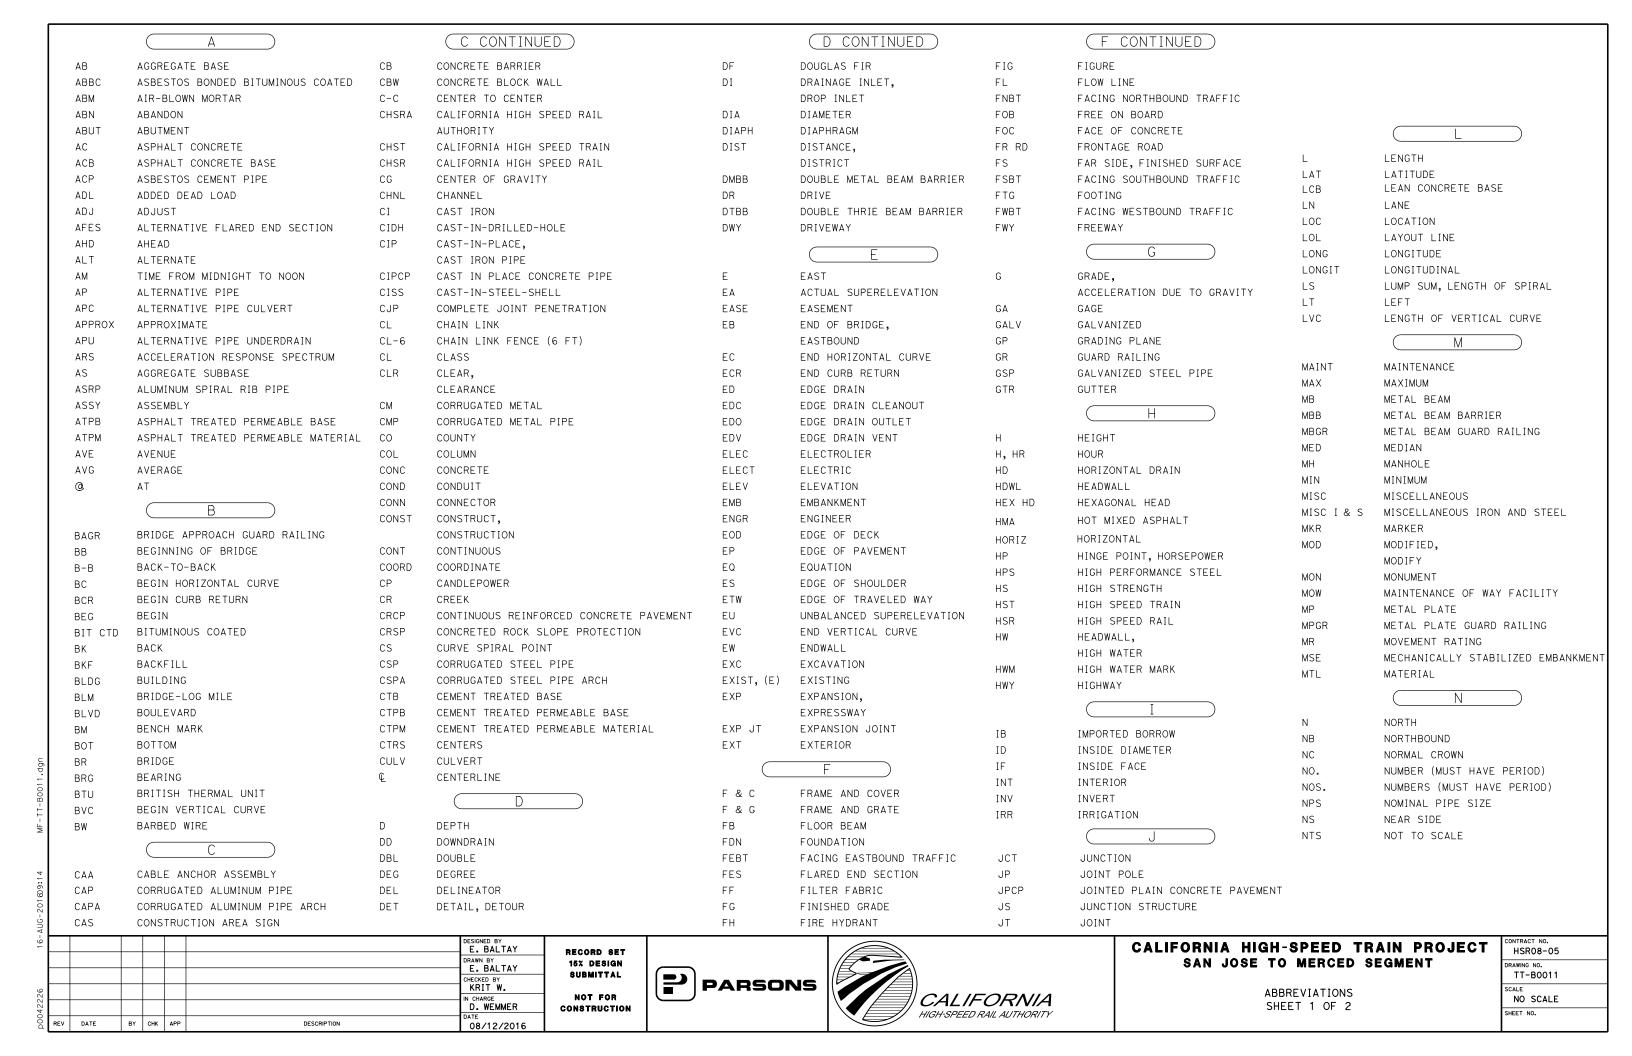

	0		( P CONTINUED			(S CONTINUED)		(T CONTINUED)
ОС	OVERCROSSING	PVI	POINT OF VERTICAL IN	NTERSECTION	SJM	SAN JOSE TO MERCED	TS	TRANSVERSE, TRAFFIC SIGNAL,
ocs	OVERHEAD CONTACT SYSTEM	PVMT	PAVEMENT		SJV	SAN JOAQUIN VALLEY		TUBULAR STEEL, TANGENT SPIRAL POINT
OD	OUTSIDE DIAMETER	PVT	POINT OF VERTICAL T	ANGENT	S	STATION LINE	TYP	TYPICAL
OF	OUTSIDE FACE		Q		SM	SELECTED MATERIAL		
OG	ORIGINAL GROUND		<u> </u>		SPEC	SPECIAL, SPECIFICATIONS		
OGAC	OPEN GRADED ASPHALT CONCRETE	QTY	QUANTITY		SPP	SLOTTED PLASTIC PIPE	UC	UNDERCROSSING
ОН	OVERHEAD		R		SR	STATE ROUTE	UD	UNDERDRAIN
0-0	OUT TO OUT				SRS	STANDALONE RADIO SITE	UON	UNLESS OTHERWISE NOTED
OPP	OPPOSITE	R	RADIUS		SS	SLOPE STAKE, SUBSTATION	UP	UNDERPASS
	P	R & D	REMOVE AND DISPOSE		SSBM	STRAP AND SADDLE BRACKET METHOD	UPRR	UNION PACIFIC RAILROAD
		R & S	REMOVE AND SALVAGE		SSD	STRUCTURAL SECTION DRAIN	UXO	UNIVERSAL CROSSOVER
Р	PAGE	R/C	RATE OF CHANGE		SSPA	STRUCTURAL STEEL PLATE ARCH		V
PAP	PERFORATED ALUMINUM PIPE	RCA	REINFORCED CONCRETE	ARCH	SSPP	STRUCTURAL STEEL PLATE PIPE		
PB	PULL BOX, PHASE BREAK	RCB	REINFORCED CONCRETE	BOX	SSPPA	STRUCTURAL STEEL PLATE PIPE ARCH	V	DESIGN SPEED, VALVE
PC	POINT OF CURVATURE, PRECAST	RCP	REINFORCED CONCRETE	PIPE	SSRP	STEEL SPIRAL RIB PIPE	VAR	VARIABLE
PCC	POINT OF COMPOUND CURVE,	RCPA	REINFORCED CONCRETE	PIPE ARCH	ST	STREET, SPIRAL TANGENT POINT	VC	VERTICAL CURVE
	PORTLAND CEMENT CONCRETE	RD	ROAD		STA	STATION	VCP	VITRIFIED CLAY PIPE
PCP	PERFORATED CONCRETE PIPE,	REINF	REINFORCED, REINFORC	EMENT,	STBB	SINGLE THRIE BEAM BARRIER	VERT	VERTICAL
	PRESTRESSED CONCRETE PIPE		REINFORCING		STD	STANDARD	VIA	VIADUCT
PCVC	POINT OF COMPOUND VERTICAL CURVE	REL	RELOCATE		STR	STRUCTURE	VOL	VOLUME
PED	PEDESTRIAN	REPL	REPLACEMENT		SURF	SURFACING		W
PED OC	PEDESTRIAN OVERCROSSING	RET	RETAINING		SW	SIDEWALK, SOUND WALL		
PED UC	PEDESTRIAN UNDERCROSSING	REV	REVISED		SWR	SEWER	W	WEST, WIDTH
PERM MTL	PERMEABLE MATERIAL	RDWY	ROADWAY		SWS	SWITCHING STATION	WB	WESTBOUND
PG	PROFILE GRADE	RM	ROAD-MIXED		SYM	SYMMETRICAL	WCB	WORLD COORDINATE BEARING
PG&E	PACIFIC GAS AND ELECTRIC	RP	RADIUS POINT,		S4S	SURFACE 4 SIDES	WH	WEEP HOLE
PI	POINT OF INTERSECTION		REFERENCE POINT			T	WM	WIRE MESH
PITO	POINT OF INTERSECTION TURNOUT	RR	RAILROAD				WS	WATER SURFACE
PJP	PARTIAL JOINT PENETRATION	RSP	ROCK SLOPE PROTECTI	ON	Т	SEMI-TANGENT	WSP	WELDED STEEL PIPE
₽, PL	PLATE	RT	RIGHT		TAB	TABLET	WΤ	WEIGHT
P/L	PROPERTY LINE	RTE	ROUTE		TAN	TANGENT	W∨	WATER VALVE
РМ	POST MILE,	RW	REDWOOD,		TBB	THRIE BEAM BARRIER	WW	WINGWALL
	TIME FROM NOON TO MIDNIGHT		RETAINING WALL		TBD	TO BE DETERMINED	WWLOL	WINGWALL LAYOUT LINE
PN	PAVING NOTCH	R/W	RIGHT-OF-WAY		TBR	TIMBER		X
POB	POINT OF BEGINNING	RWY	RAILWAY		TC	TOP OF CURB, TRAIN CONTROL		
POC	POINT OF HORIZONTAL CURVE		S		TCB	TRAFFIC CONTROL BOX	X SEC	CROSS SECTION
POE	POINT OF END				TCE	TEMPORARY CONSTRUCTION EASEMENT	XING	CROSSING
POT	POINT OF TANGENT	S	SOUTH, SUPPLEMENT		TEL	TELEPHONE	XO	CROSSOVER
POVC	POINT OF VERTICAL CURVE	SAE	STRUCTURE APPROACH	EMBANKMENT	TEMP	TEMPORARY		Y
PP	PIPE PILE, PLASTIC PIPE,	SALV	SALVAGE		TG	TOP OF GRADE		
20:	POWER POLE	SAPP	STRUCTURAL ALUMINUM	PLATE PIPE	TM	TECHNICAL MEMORANDUM	YR	YEAR
PPL	PREFORMED PERMEABLE LINER	SB	SOUTHBOUND	OUDVE DOTT	TO	TURNOUT	YRS	YEARS
PPP	PERFORATED PLASTIC PIPE	SC	SAND CUSHION, SPIRAL		TOT	TOTAL		
PRC	POINT OF REVERSE CURVE	SCSP	SLOTTED CORRUGATED	SIEEL PIPE	TP	TELEPHONE POLE		
PRF	PAVEMENT REINFORCING FABRIC	SD	STORM DRAIN		TPB	TREATED PERMEABLE BASE		
PRVC	POINT OF REVERSE VERTICAL CURVE	SEC	SECOND, SECTION		TPF	TRACTION POWER FACILITY		
PS&E	PLANS, SPECIFICATIONS AND ESTIMATES	SEP	SEPARATION		TPM	TREATED PERMEABLE MATERIAL		
PS, P/S	POINT OF SWITCH, PRESTRESSED,	SG	SUBGRADE		TPSS	TRACTION POWER SUBSTATION		
505	PARALLELING STATION	SHLD	SHOULDER		T/R	TOP OF RAIL		
PSP	PERFORATED STEEL PIPE	SHT	SHEET		TRANS	TRANSITION		
PT	POINT OF TANGENCY	SIM	SIMILAR		TRK	TRACK		
PVC	POLYVINYL CHLORIDE,	SJD	SAN JOSE DIRIDON ST.	AIION				
	POINT OF VERTICAL CURVE			r				
		DESIGNED E E. BAL	TAY RECORD SET				CA	LIFORNIA HIGH-SPEED TRAIN PRO-
		DRAWN BY	TAY 15% DESIGN					SAN JOSE TO MERCED SEGMENT
		CHECKED B	SUBMITTAL	[P]	SONS			
		KRIT IN CHARGE				CALIFORNIA		ABBREVIATIONS

NOT FOR CONSTRUCTION

D. WEMMER

DESCRIPTION


BY CHK APP


DATE 08/12/2016 PROJECT CONTRACT NO. HSRO8-05
ENT CRAWING NO. TT-B0012


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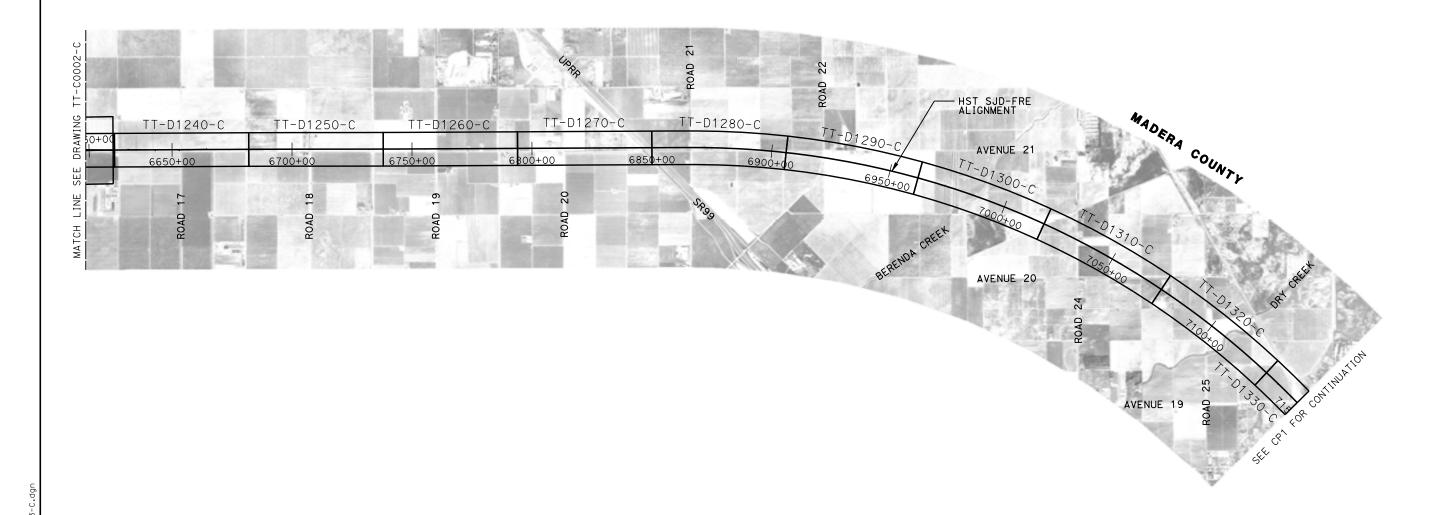
SCALE NO SCALE

ABBREVIATIONS SHEET 2 OF 2



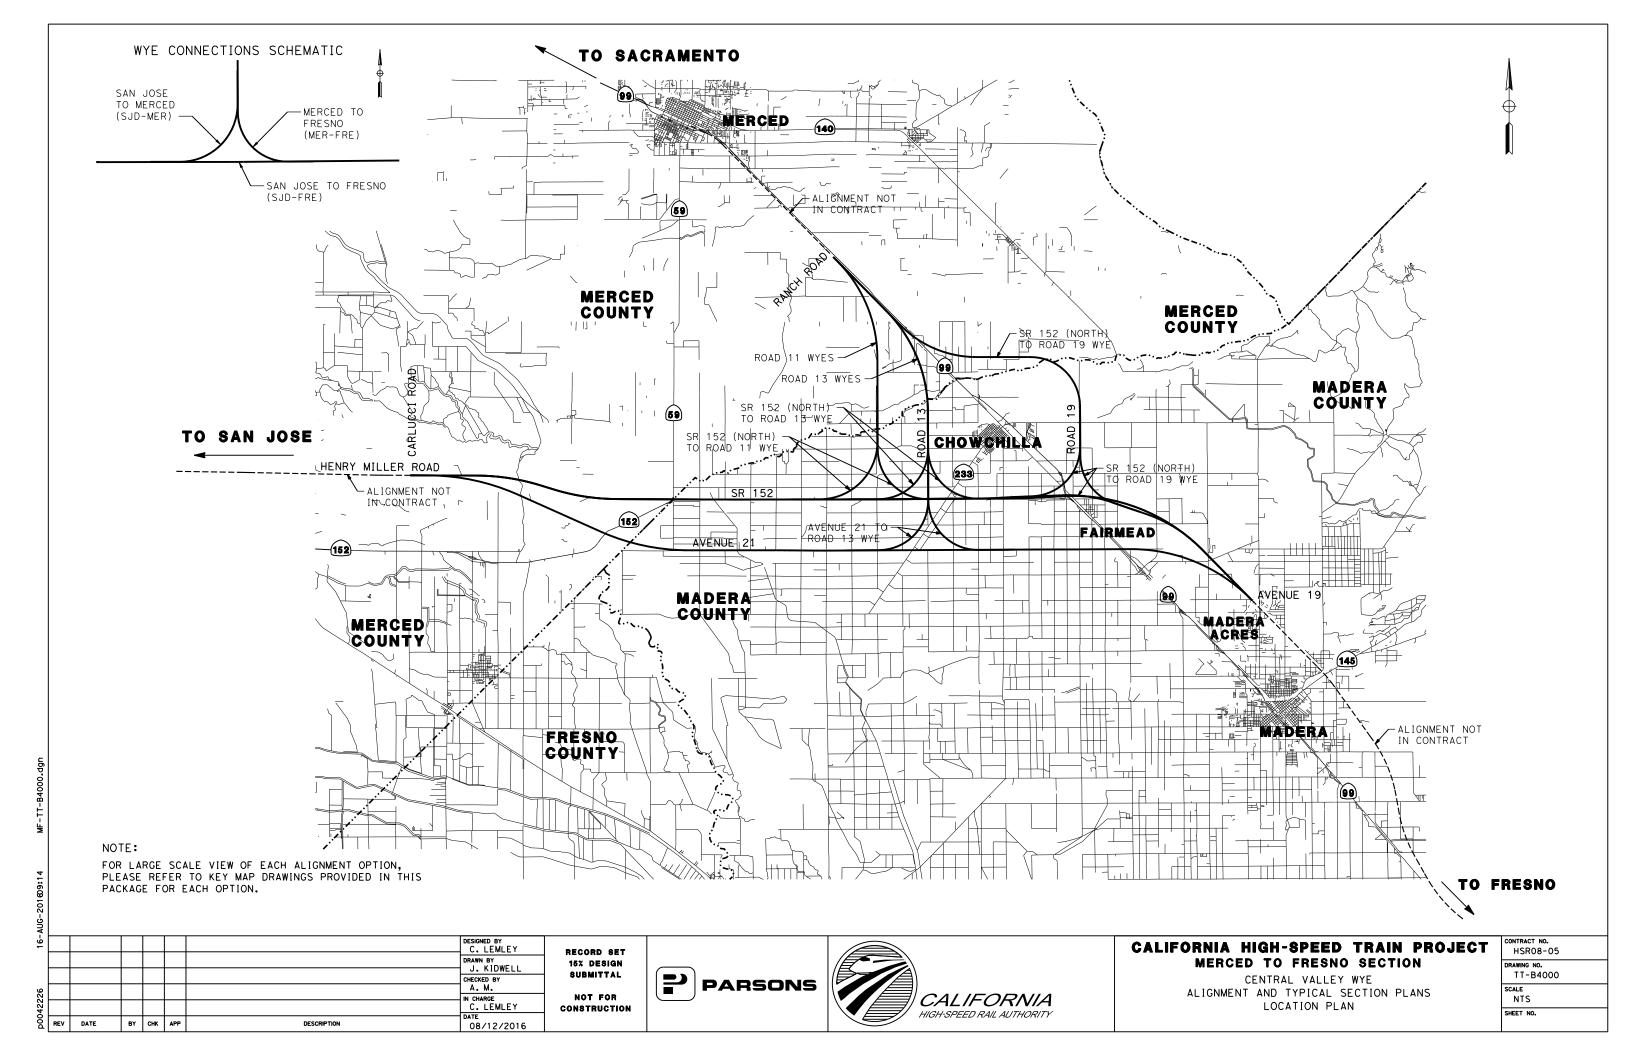

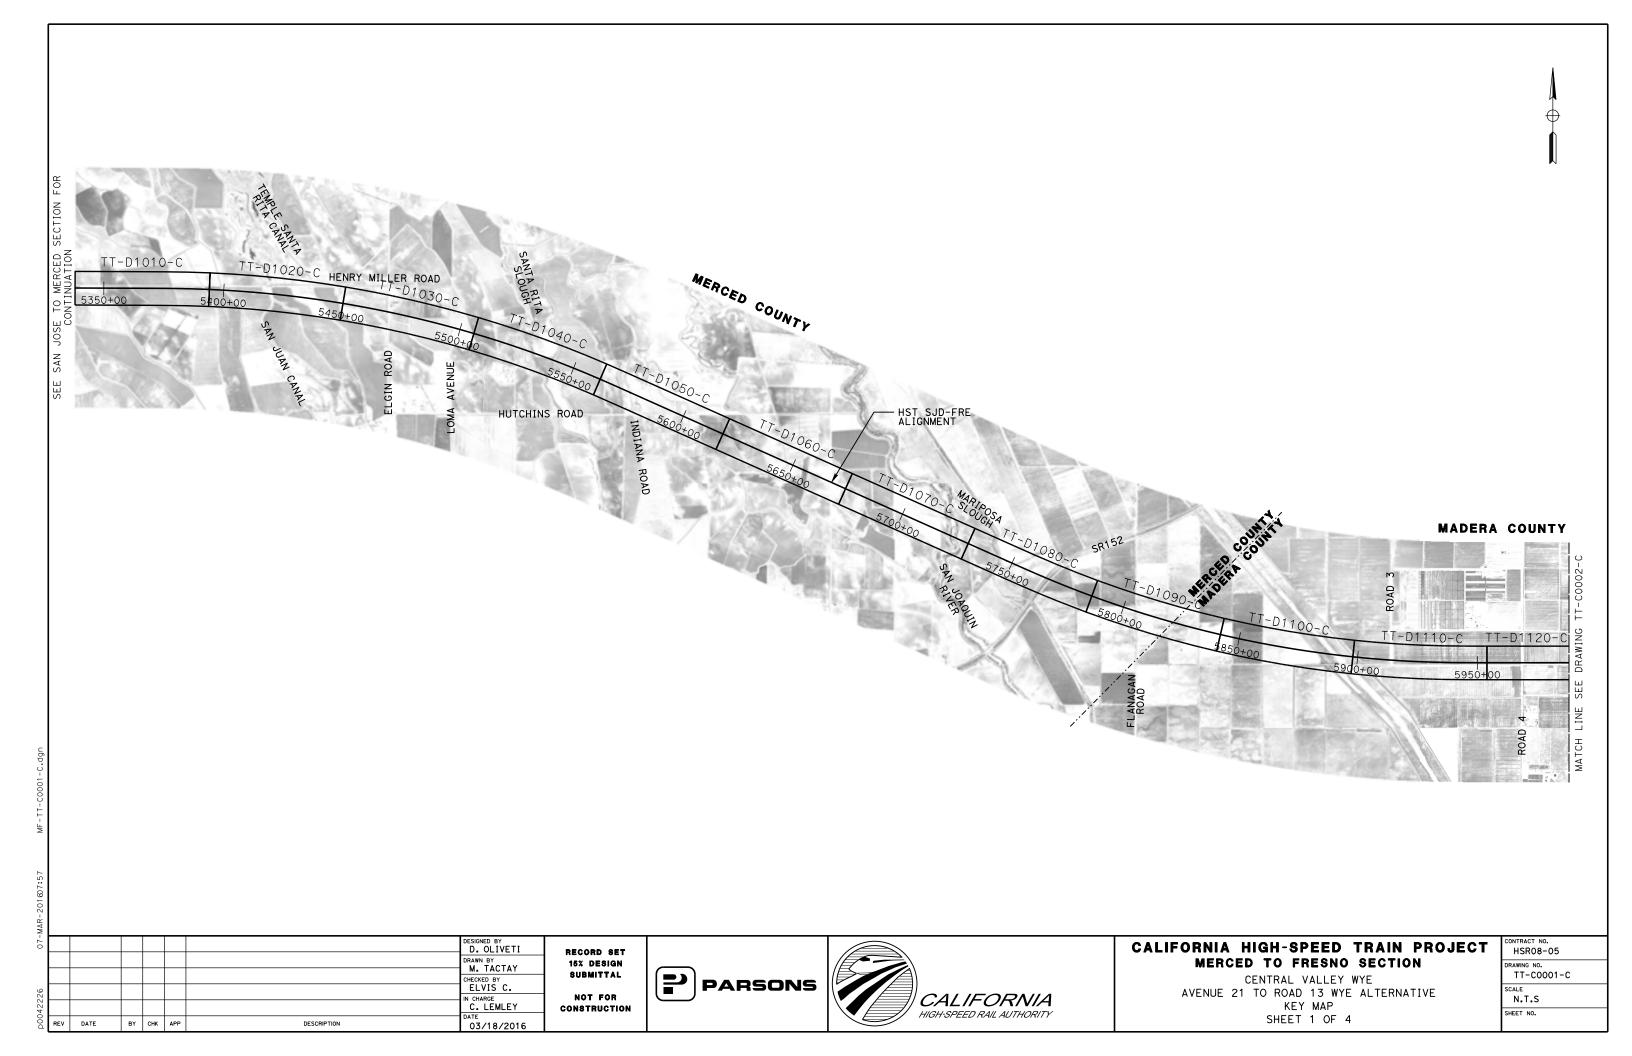

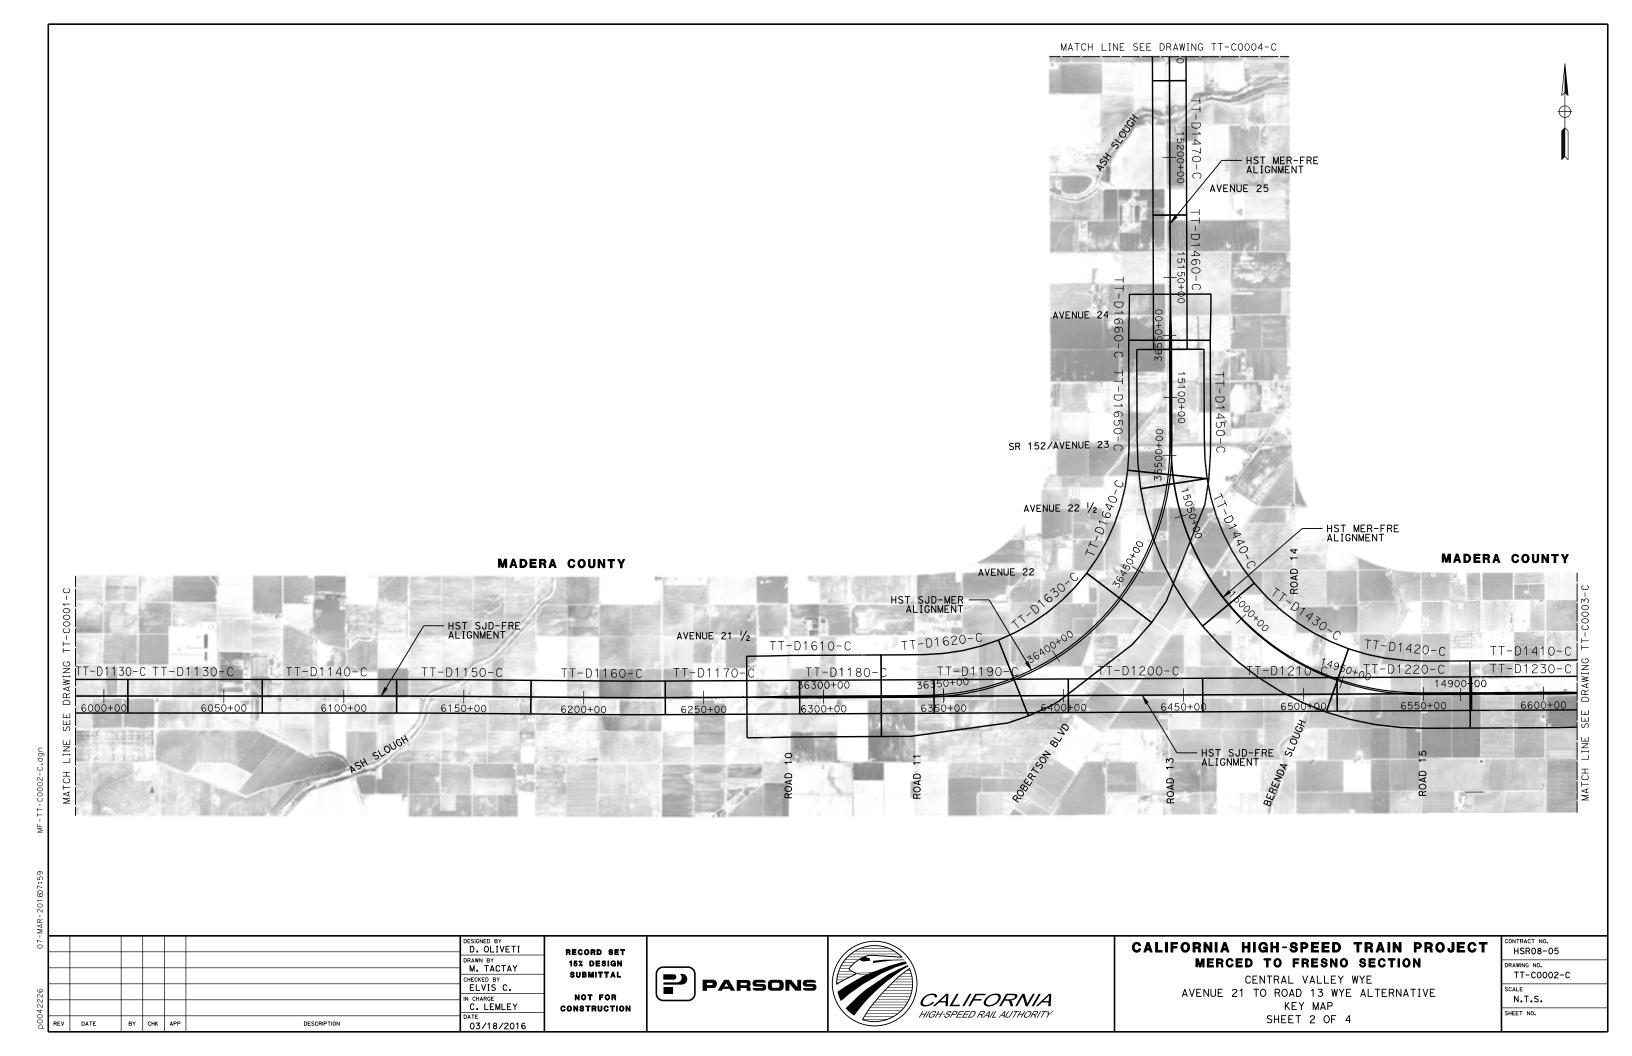

ΜĀ								
0							D. OLIVETI	
							DRAWN BY M. TACTAY	
							CHECKED BY	
922							ELVIS C. IN CHARGE	
7							C. LEMLEY	0
Д	REV	DATE	BY	СНК	APP	DESCRIPTION	03/18/2016	

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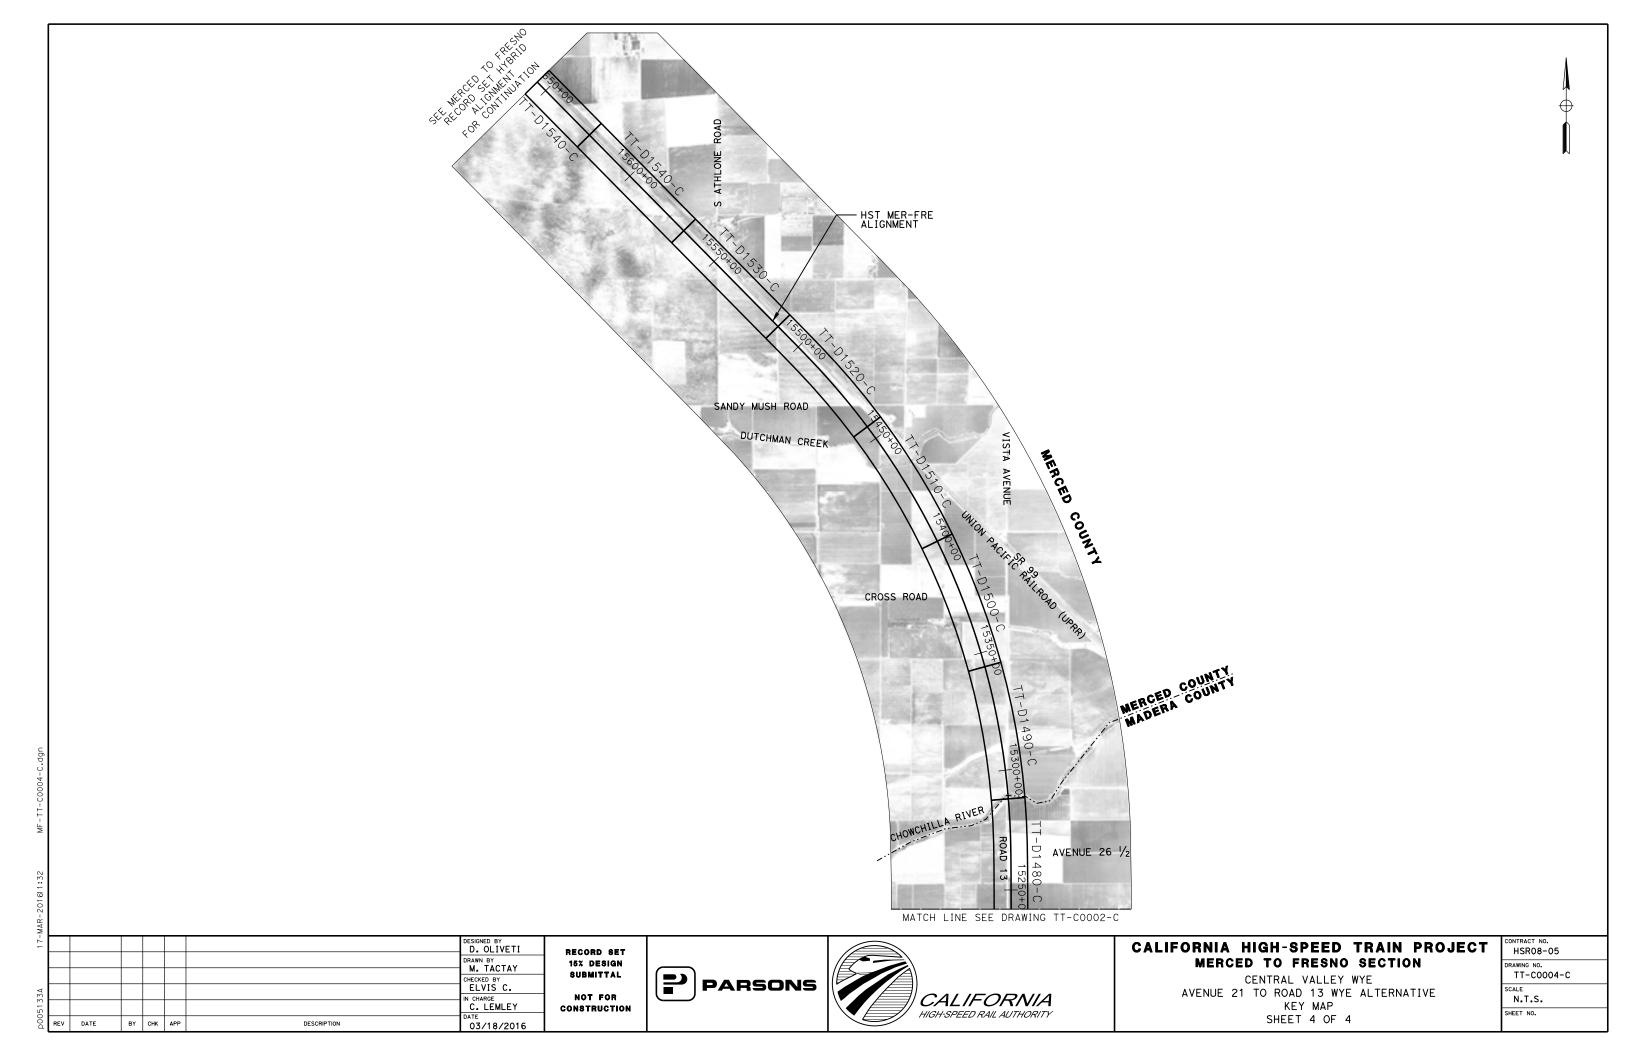





# CALIFORNIA HIGH-SPEED TRAIN PROJECT MERCED TO FRESNO SECTION

CENTRAL VALLEY WYE
AVENUE 21 TO ROAD 13 WYE ALTERNATIVE
KEY MAP
SHEET 3 OF 4

CONTRACT NO.
HSR08-05
DRAWING NO.
TT-C0003-C
SCALE
N.T.S.
SHEET NO.



### SECTION A-A

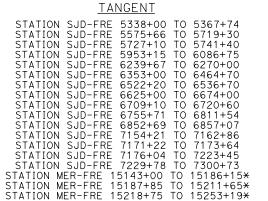

# STATION MER-FRE 15507+89 TO 15655+00\* SUPERELEVATED

STATION SJD-FRE 5367+74 TO 5575+66 STATION SJD-FRE 5753+40 TO 5764+15 STATION SJD-FRE 5768+95 TO 5804+86 STATION SJD-FRE 5806+11 TO 5881+10 STATION SJD-FRE 5900+90 TO 5953+15 STATION SJD-FRE 6226+72 TO 6239+67 STATION SJD-FRE 6674+00 TO 6709+10 STATION SJD-FRE 6720+60 TO 6755+71 STATION SJD-FRE 6857+07 TO 7106+55 STATION SJD-FRE 7108+95 TO 7154+21 STATION MER-FRE 15266+15 TO 15285+30× STATION MER-FRE 15266+15 TO 15285+30× STATION MER-FRE 15264+70 TO 15309+58× STATION MER-FRE 15437+60 TO 15473+47× STATION MER-FRE 15476+20 TO 15507+89× STATION MER-FRE 15476+20

#### HST R/W HST R/W HST R/W VARIES 100.00' MIN TANGENT | SUPERELEVATED € NB HST € SB HST OCS POLE TRACK TRACK VARIES VARIES 10.67 16.50 10.67 25.00' 25.00' TYP TYP -AR FENCE 3.00' WALKWAY AR FENCE WALKWAY 15.00 15.00 MIN MIN OG --CABLE DUCT EMBANKMENT HEIGHT VARIES FINISH GRADE 3.00' DIA (TYP) -TRAPEZOIDAL DITCH (TYP)

# SECTION A-A TWO TRACKS ON EMBANKMENT

#### **GENERAL TYPICAL SECTION NOTES:**

- TRACK, OCS POLES AND FOUNDATIONS, CABLE DUCTS AND DRAINAGE ARE SCHEMATIC AND DO NOT REPRESENT DESIGN.
- 2. RIGHT-OF-WAY REQUIRED FOR THE HST GUIDEWAY WILL DEPEND UPON CONDITIONS ALONG THE ALIGNMENT, INCLUDING, BUT NOT LIMITED TO, TERRAIN WHERE CUT/FILL SLOPES, RETAINING STRUCTURES, AND ACCESS ARE REQUIRED.
- 3. SEE STRUCTURES, VIADUCT AND TUNNEL PLANS FOR DETAILED CROSS SECTIONS OF
- 4. RIGHT-OF-WAY TO BE PLACED A MINIMUM OF 15.00' FROM PIER FOUNDATION, OR AS INDICATED IN THE SECTIONS, WHICHEVER YIELDS THE LARGEST RIGHT OF WAY.
- 5. TRACK BALLASTED EXCEPT ON STRUCTURES OVER 1000'.
- 6. ALL STATION LIMITS ARE TAKEN FROM SOUTHBOUND ALIGNMENT STATIONING.
- 7. TANGENT AND SUPERELEVATION SPLIT SECTION IS FOR THE PURPOSE OF ILLUSTRATION ONLY.
- 8. SEE CIVIL AND GRADE SEPARATION PLANS FOR PERMANENT ACCESS AND UTILITY EASEMENTS.
- 9. 6' BENCH REQUIRED ON EMBANKMENT HEIGHT OVER 30' (NOT SHOWN).

# \* TYPICAL SECTION IS VIEWED IN THE DIRECTION OF DECREASING STATIONING.


### SECTION B-B

#### **TANGENT**

STATION SJD-FRE 6086+75 TO 6117+33 STATION SJD-FRE 6156+67 TO 6200+12 STATION SJD-FRE 6464+70 TO 6495+90 STATION SJD-FRE 6497+10 TO 6518+60 STATION SJD-FRE 6812+99 TO 6842+89 STATION SJD-FRE 7162+86 TO 7171+22\* STATION SJD-FRE 7223+45 TO 7229+78\*

#### SUPERELEVATED

STATION SJD-FRE 6117+33 TO 6126+30 STATION SJD-FRE 6127+55 TO 6132+55 STATION SJD-FRE 6140+30 TO 6156+67 STATION SJD-FRE 6200+12 TO 6226+72 STATION MER-FRE 15268+72 TO 15285+30\* STATION MER-FRE 15294+90 TO 15297+70\*

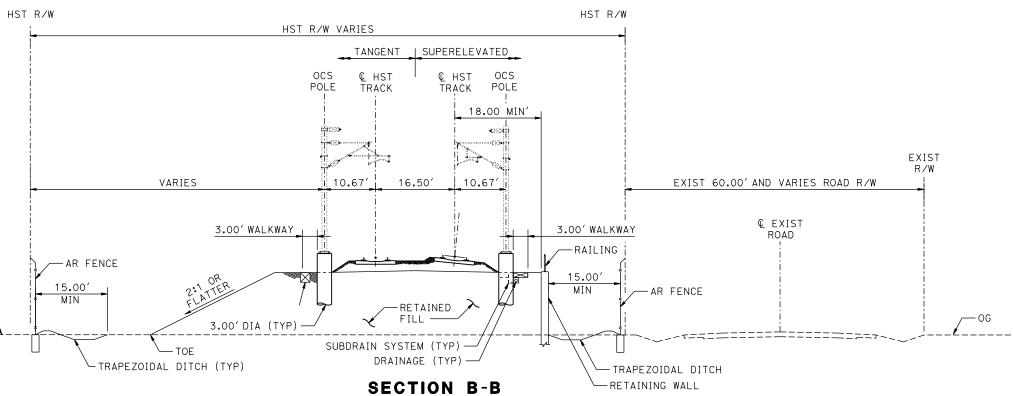

# TYPICAL SECTION WITH RETAINED FILL

NOTE: SECTION WITH RETAINING WALL ON LEFT NOT SHOWN

⋝								
- / 0							DESIGNED BY D. OLIVETI	
							DRAWN BY M. TACTAY	
							CHECKED BY	
922							N. OUM IN CHARGE	
0422							C. LEMLEY	C.
DQ	REV	DATE	BY	СНК	APP	DESCRIPTION	03/18/2016	

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# CALIFORNIA HIGH-SPEED TRAIN PROJECT MERCED TO FRESNO SECTION

CENTRAL VALLEY WYE
AVENUE 21 TO ROAD 13 WYE ALTERNATIVE
TYPICAL SECTIONS
SHEEET 1 OF 8

CONTRACT NO. HSRO8-05
DRAWING NO. TT-B0020-C
SCALE N.T.S.
SHEET NO.

#### **TANGENT**

STATION SJD-FRE 5719+30 TO 5727+10 STATION SJD-FRE 5741+40 TO 5747+55 STATION SJD-FRE 6495+90 TO 6497+10 STATION SJD-FRE 6518+60 TO 6522+20 STATION SJD-FRE 6811+54 TO 6812+99 STATION SJD-FRE 6842+89 TO 6852+69 STATION SJD-FRE 7173+64 TO 7176+04 STATION MER-FRE 15188+15 TO 15187+85\* STATION MER-FRE 15211+65 TO 15218+785\*

#### SUPERELEVATED

STATION SJD-FRE 5747+55 TO 5753+40 STATION SJD-FRE 5764+15 TO 5768+95 STATION SJD-FRE 5804+86 TO 5806+11 STATION SJD-FRE 5881+10 TO 5900+90 STATION SJD-FRE 6126+30 TO 6127+55 STATION SJD-FRE 6132+55 TO 6140+30 STATION SJD-FRE 7106+55 TO 7108+95 STATION MER-FRE 15036+01 TO 15038+41\* STATION MER-FRE 15052+52 TO 15054+72\* STATION MER-FRE 15264+70 TO 15266+15\* STATION MER-FRE 15285+30 TO 15294+90\* STATION MER-FRE 15309+58 TO 15312+88\* STATION MER-FRE 15435+20 TO 15437+60\*

#### HST R/W HST R/W HST R/W VARIES 50.00' TANGENT | SUPERELEVATED € NB HST © SB HST TRACK OCS POLE TRACK POLE 15.00′ 15.00 MIN (SEE NOTE 4) MIN (SEE NOTE 4) 10.67 6.08 10.67 16.50' 5.08 MIN 3.00' WALKWAY WALKWAY RAILING --RAILING CABLE DUCT VARIES (SEE NOTE 3 CONC BOX GIRDER !」□ -CONC COLUMN VIADUCT

SECTION C-C TWO TRACKS ON AERIAL STRUCTURE

#### SECTION D-D


**TANGENT** 

NONE

#### SUPERELEVATED

STATION MER-FRE 14942+95 TO 14946+06\* STATION MER-FRE 14970+75 TO 14972+80\* STATION SJD-MER 36476+37 TO 36479+27

\*TYPICAL SECTION IS VIEWED IN THE DIRECTION OF DECREASING STATIONING

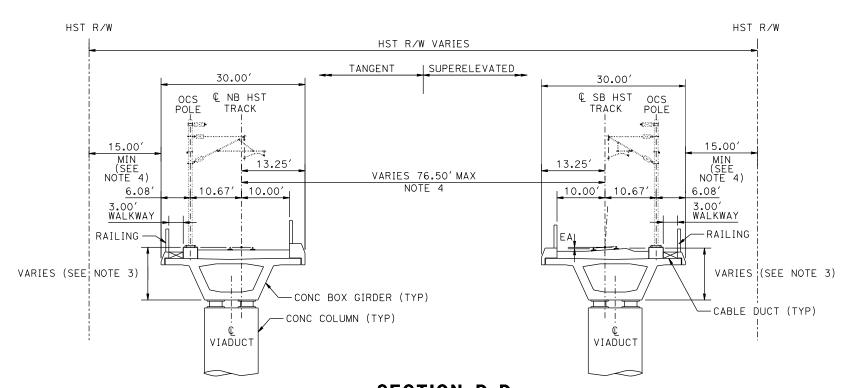

SECTION D-D
TWO TRACKS ON SINGLE TRACK AERIAL STRUCTURE
WITH WIDE TRACK CENTERS

| DESIGNED BY | D. OLIVETI | DRAWN BY | M. TACTAY | CHECKED BY | N. OUM | N. OUM | IN CHARGE | C. LEMLEY | DATE | BY CHK | APP | DESCRIPTION | DATE |

RECORD SET
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CONSTRUCTION





# CALIFORNIA HIGH-SPEED TRAIN PROJECT MERCED TO FRESNO SECTION

CENTRAL VALLEY WYE

AVENUE 21 TO ROAD 13 WYE ALTERNATIVE

TYPICAL SECTIONS

SHEET 2 OF 8


NOTE:

1. SEE DRAWING TT-B0020-C FOR GENERAL TYPICAL SECTION NOTES.


CONTRACT NO.
HSR08-05
DRAWING NO.
TT-B0021-C
SCALE
N.T.S.
SHEET NO.

MF-TT-B0021-C.

7-MAR-201608:01

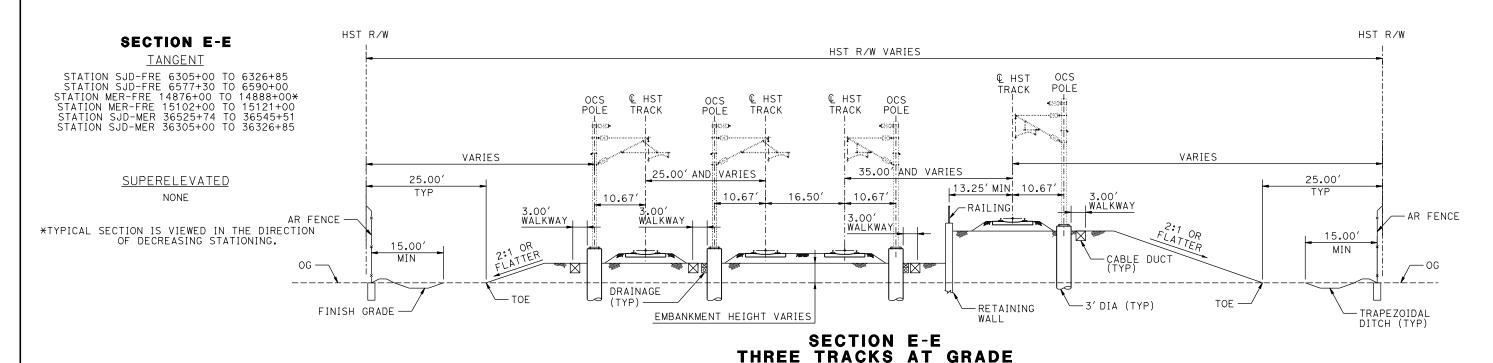

ONE TRACK ON RETAINED FILL NOTE: OPTIONAL RETAINING WALL TO OUTSIDE OF HST TRACK NOT SHOWN

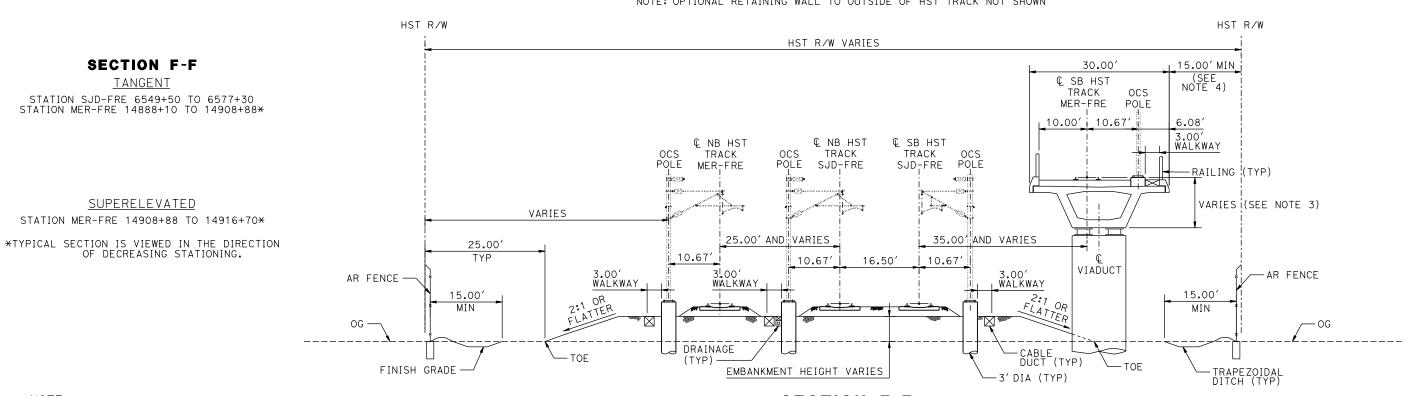

#### NOTE:

1. SEE DRAWING TT-B0020-C FOR GENERAL TYPICAL SECTION NOTES.

SECTION F-F

TANGENT

SUPERELEVATED

OF DECREASING STATIONING.

SECTION F-F THREE TRACKS AT GRADE ONE TRACK ON AERIAL STRUCTURE

-								
-10							D. OLIVETI	RECORD SET
							DRAWN BY	15% DESIGN
							CHECKED BY ELVIS C.	SUBMITTAL
42226							IN CHARGE C. LEMLEY	NOT FOR
p004	REV	DATE	BY	СНК	APP	DESCRIPTION	DATE 03/18/2016	CONSTRUCTION
ш							03/10/2016	


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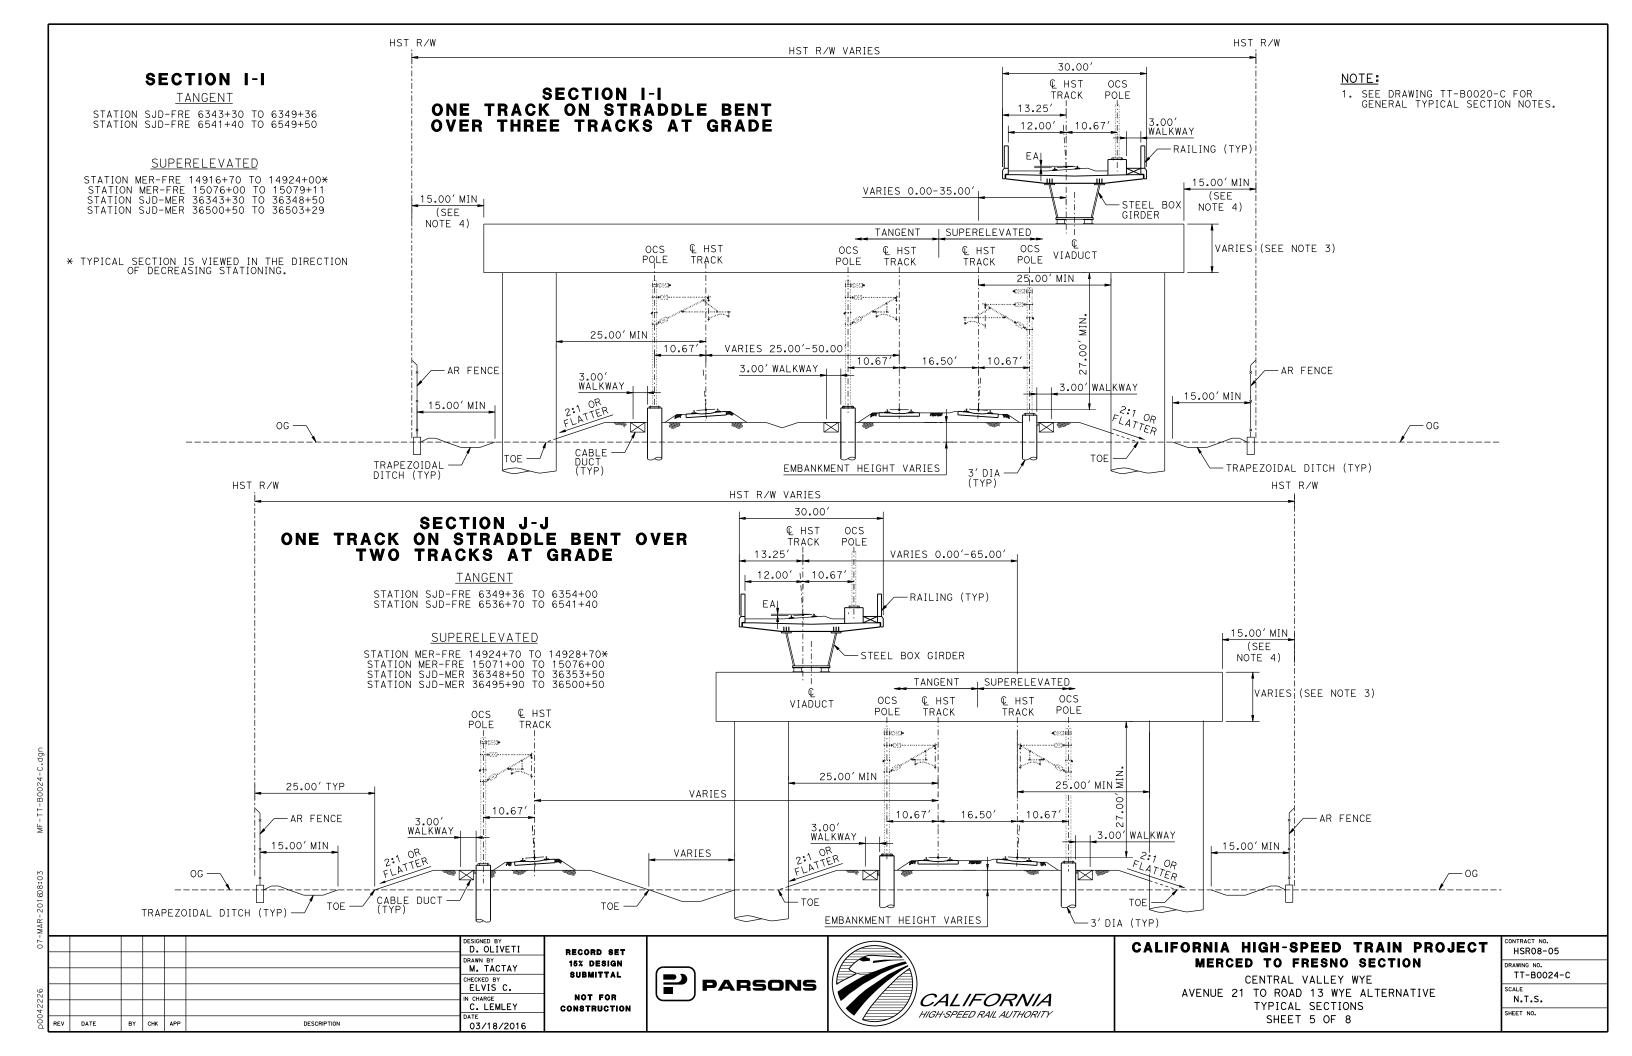



### CALIFORNIA HIGH-SPEED TRAIN PROJECT MERCED TO FRESNO SECTION

CENTRAL VALLEY WYE AVENUE 21 TO ROAD 13 WYE ALTERNATIVE TYPICAL SECTIONS SHEET 3 OF 8

_	CONTRACT NO.
ı	HSR08-05
	DRAWING NO.
	TT-B0022-C
	SCALE
	N.T.S.
	SHEET NO.




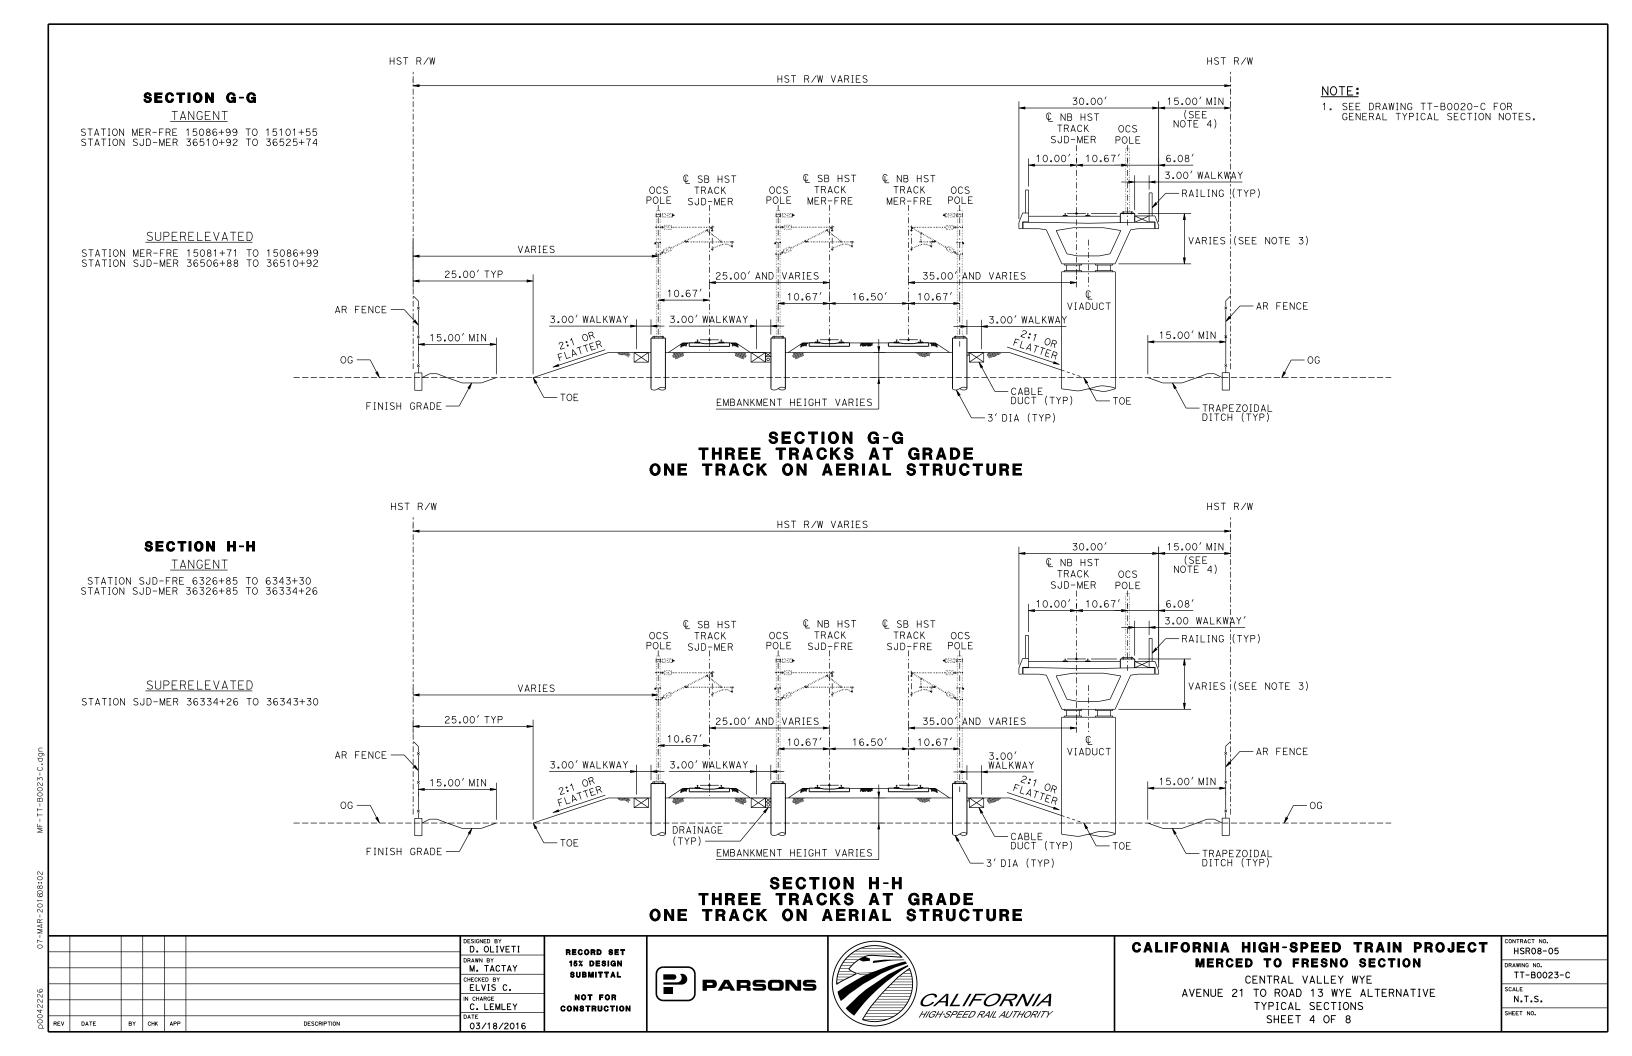

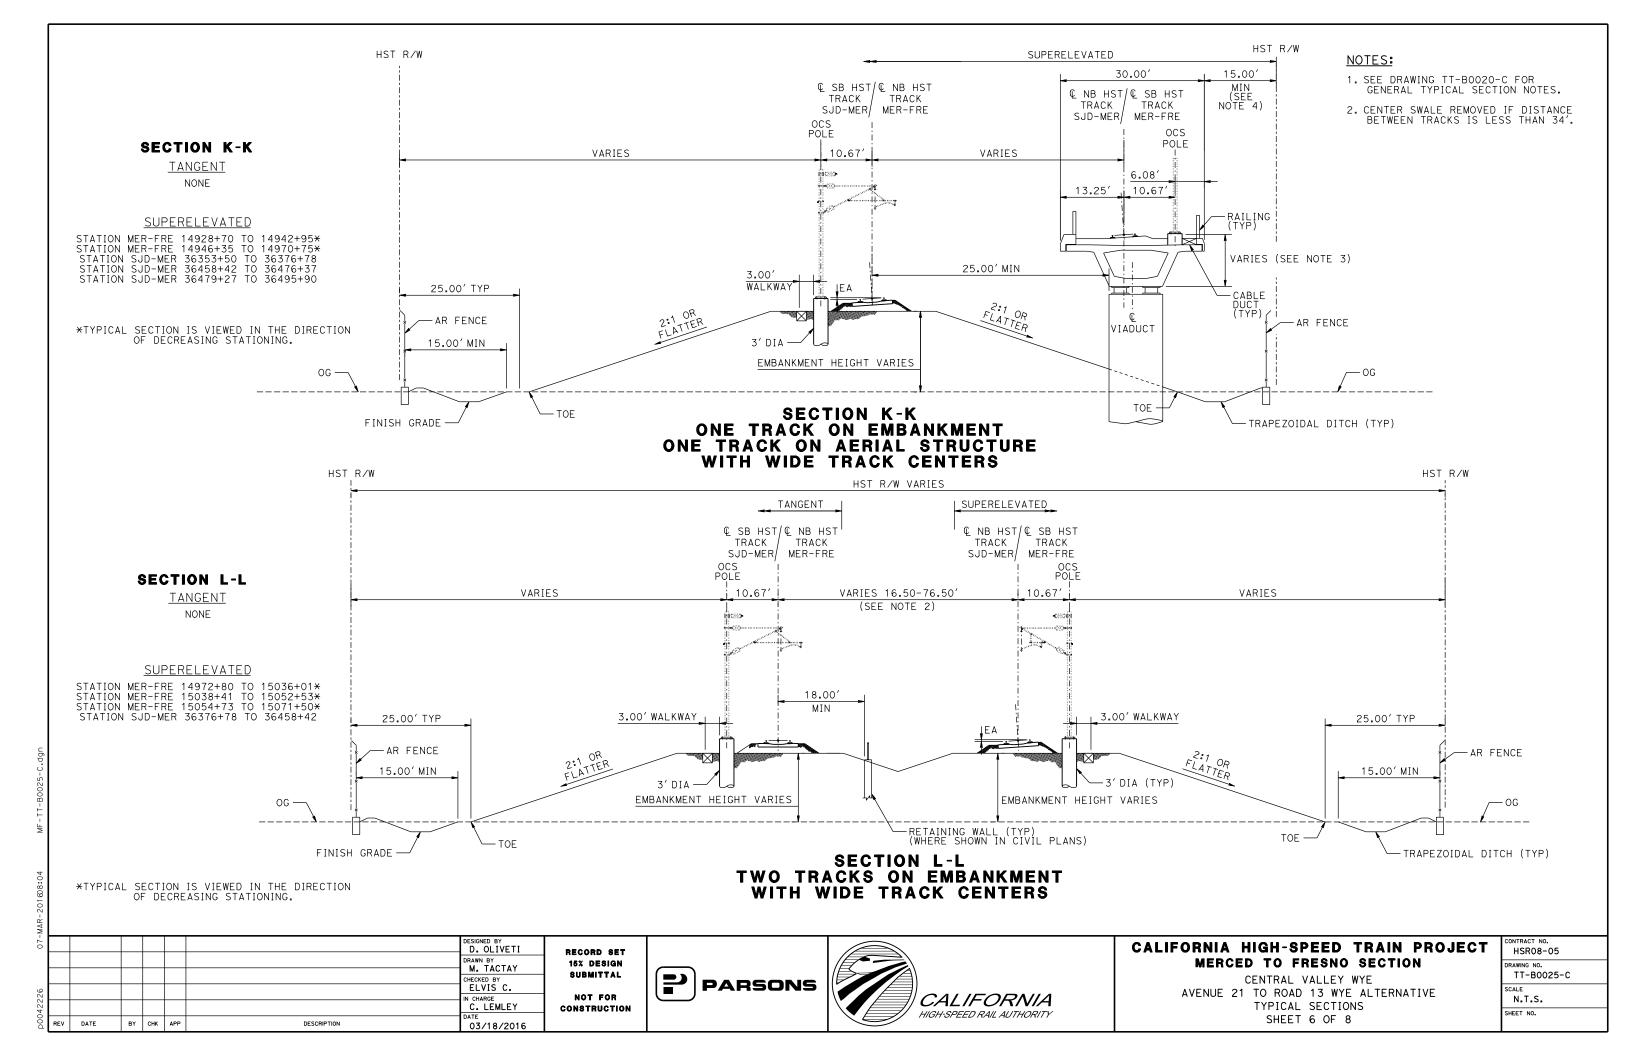

### NOTE:

1. SEE DRAWING TT-B0020-C FOR GENERAL TYPICAL SECTION NOTES.

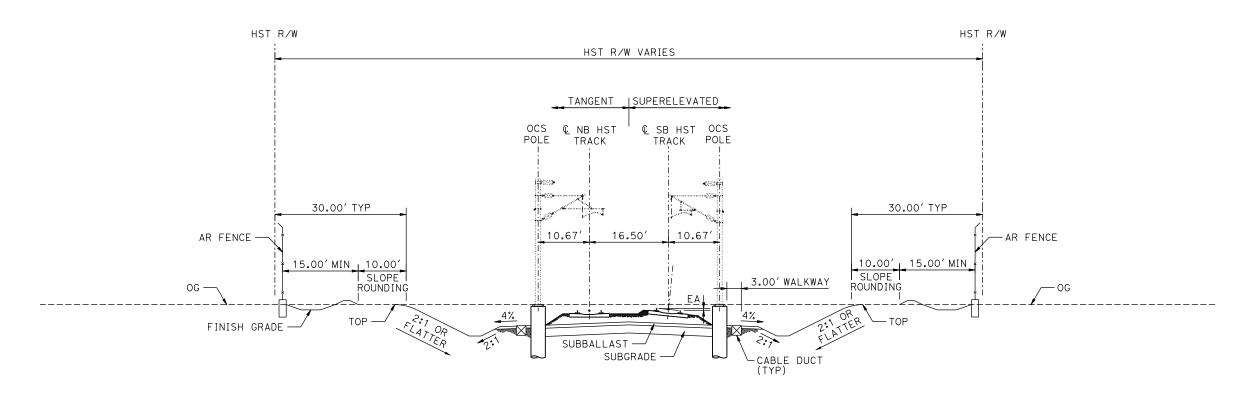

### SECTION M-M TWO TRACKS IN CUT

TANGENT NONE

STATION MER-FRE 15473+47 TO 15476+20

MAR								
-70							Designed by D. OLIVETI	
							DRAWN BY M. TACTAY	•
							CHECKED BY ELVIS C.	
12226							IN CHARGE C. LEMLEY	C
2004	REV	DATE	BY	СНК	APP	DESCRIPTION	DATE 03/18/2016	

RECORD SET
15% DESIGN
SUBMITTAL
NOT FOR
CONSTRUCTION





# CALIFORNIA HIGH-SPEED TRAIN PROJECT MERCED TO FRESNO SECTION

CENTRAL VALLEY WYE
AVENUE 21 TO ROAD 13 WYE ALTERNATIVE
TYPICAL SECTIONS
SHEET 7 OF 8

CONTRACT NO.
HSR08-05
DRAWING NO.
TT-B0026-C
SCALE
N.T.S.
SHEET NO.

### NOTE:


1. SEE DRAWING TT-B0020-C FOR GENERAL TYPICAL SECTION NOTES.


### SECTION 0-0 FOUR TRACKS ON TWO AERIAL STRUCTURES

TANGENT NONE

<u>SUPERELEVATED</u>

STATION MER-FRE 15079+11 TO 15081+71
STATION SJD-MER 36503+28 TO 36505+88

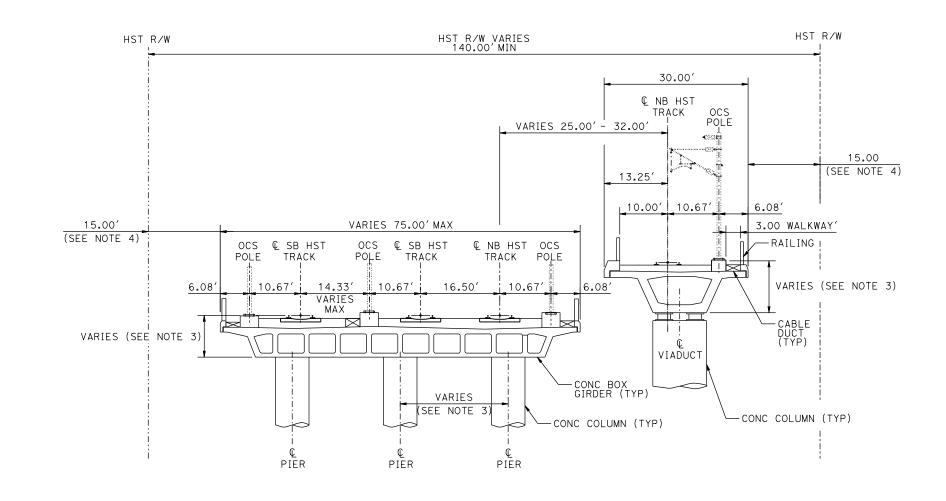

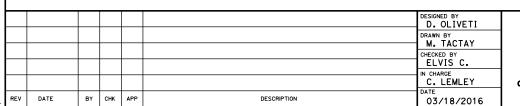

RECORD SET
15% DESIGN
SUBMITTAL
NOT FOR
CONSTRUCTION





# CALIFORNIA HIGH-SPEED TRAIN PROJECT MERCED TO FRESNO SECTION

CENTRAL VALLEY WYE
AVENUE 21 TO ROAD 13 WYE ALTERNATIVE
TYPICAL SECTIONS
SHEET 8 OF 8

CONTRACT NO.
HSR08-05
DRAWING NO.
TT-B0027-C
SCALE
N.T.S.
SHEET NO.

5:54 MF-TT-B0027-C.dg

12-MAR-201806.34

CURVE	ELEMENT	POINT	CTATION	COORD	INATES	RADIUS	LENGTH	DELTA		_	DESIGN	ACTUAL	UNBALANCED	, wcb	WCB (0°	'00'00")
NUMBER	ELEMENT	POINT TYPE	STATION	NORTHING	EASTING	(FT)	(FT)	Δ	K	P	SPEED (MPH)	SUPERELEVATION (EA) (IN)	SUPERELEVATION (EU) (IN)	(0°00′00") (TANGENT)	START ANGLE	END ANGLE
	TANGENT	POB	5338+00.00	1858051.11	6509106.39		2974.09							S 89° 46′01" E		
	TANGENT	TS	5367+74.09	1858039.02	6512080.45											
	CLOTHOID	TS	5367+74.09	1858039.02	6512080.45											
	CLOTHOID	SPI	5378+74.11	1858034.54	6513180.46		1650	1° 01 ′39''	824.99	2.47					S 89°46′01" E	S 88°44′22"
	CLOTHOID	SC	5384+24.09	1858022.44	6513730.35											
	100	60	F704+04-00	1050000 11	0547770 75		1				<u> </u>					
21-13	ARC	SC PI	5384+24.09 5472+76.87	1858022.44 1857827.68	6513730.35 6522580.99	46000	17491.7	21° 47′13"			250	3.75	1.68		S 88° 44′22" E	S 66°57′09"
SJD-FRE 1 SB	ARC	CC	5472+76.87	1812033.58	6512718.35	46000	17491.7	21 47 13			250	3.75	1.08		5 88 44 22 E	2 66 21 09
	ARC	cs	5559+15.79	1854361.86	6530727.14											
	Aite	03	333713.13	1031301:00	0330121311											
	CLOTHOID	CS	5559+15.79	1854361.86	6530727.14											
	CLOTHOID	SPI	5564+65.81	1854146.53	6531233.25		1650	1° 01 ′39''	824.99	2.47					S 66° 57′09" E	S 65°55′29"
	CLOTHOID	ST	5575+65.79	1853697.8	6532237.58											
		II.				1										
	TANGENT	ST	5575+65.79	1853697.8	6532237.58		17188.97							S 65° 55′29" E		
	TANGENT	TS	5747+54.76	1846685.82	6547931.30											
					I		1	1				I		I		
	CLOTHOID	TS	5747+54.76	1846685.82	6547931.30			0 ( 11							0 ( 11	0 ( 11
	CLOTHOID	SPI	5758+54.78	1846237.08	6548935.63		1650	1° 03′00''	824.99	2.52					S 65° 55′29" E	S 66°58′30"
	CLOTHOID	SC	5764+04.76	1846021.95	6549441.83											
	ARC	SC	5764+04.76	1846021.95	6549441.83			T					T			
21-13	ARC	PI	5851+42.24	1842604.42	6557483.23	45016.5	17260.35	21° 58′07''			250	4.00	1.55		S 66° 58′30" E	S 88°56′36"
21-13 SJD-FRE 2 SB	ARC	CC	3337772727	1887452.14	6567049.35	1001010					200	1200	1,000		3 00 00 00 2	0 00 00 00
	ARC	CS	5936+65.11	1842443.29	6566219.23											
		<u> </u>														
	CLOTHOID	CS	5936+65.11	1842443.29	6566219.23											
	CLOTHOID	SPI	5942+15.13	1842433.15	6566769.15		1650	1° 03′00''	824.99	2.52					S 88° 56′36" E	S 89°59′36"
	CLOTHOID	ST	5953+15.11	1842433.02	6567869.17											
					T	Г		T			T	T	I		1	
	TANGENT	ST	5953+15.11	1842433.02	6567869.17		16417.55							S 89° 59′36" E		
	TANGENT	TS	6117+32.66	1842431.14	6584286.72											
	CLOTHOID	TC	6117170 00	10/10/21 1/	6594296 72											
	CLOTHOID	TS SPI	6117+32.66 6124+99.33	1842431.14 1842431.05	6584286.72 6585053.39		1150	0° 06′11''	575.00	0.17					S 89°59′36" E	S 89°53′26"
	CLOTHOID	SC SC	6124+99.33	1842430.32	6585436.72		1150	0 00 11	313.00	0.17					3 03 33 30 E	3 09 33 20
	320111010		0120102.00	1012700.02	0000700.12							<u> </u>	1	<u> </u>		
	ARC	SC	6128+82.66	1842430.32	6585436.72											
21-13	ARC	PI	6137+00.01	1842428.75	6586254.06	320000	1634.69	0°17′34"			250	0.50	0.28		S 89°53′26" E	S 89° 35′52"
21-13 SJD-FRE 3 SB	ARC	CC		1522430.9	6584824.95											
2 28	ARC	CS	6145+17.35	1842423.02	6587071.39											

D. OLIVETI M. TACTAY ELVIS C. N CHARGE
C. LEMLEY 10/30/2015 BY CHK APP DESCRIPTION

RECORD SET 15% DESIGN SUBMITTAL NOT FOR CONSTRUCTION





### CALIFORNIA HIGH-SPEED TRAIN PROJECT MERCED TO FRESNO SECTION

CENTRAL VALLEY WYE AVENUE 21 TO ROAD 13 WYE ALTERNATIVE SB TRACK SAN JOSE TO FRESNO GEOMETRY DATA SHEET 1 OF 9

HSR08-05 TT-B0050-C NO SCALE SHEET NO.

CURVE	000		OORDINATES PADIUS		71115	LENGTH	DELTA			DESIGN	SIGN ACTUAL		WCB	WCB (0°	°00′00")		
NUMBER	ELEMENT	POINT TYPE	STATION	NORTHING		ring (F	DIUS FT)	(FT)		K	P	SPEED (MPH)	SUPERELEVATION (EA) (IN)	UNBALANCED SUPERELEVATION (EU) (IN)	WCB (0° 00′00") (TANGENT)	START ANGLE	END ANGLE
	CLOTHOID	CS	6145+17.35	1842423.02													
	CLOTHOID	SPI	6149+00.69	1842420.32				1150	0° 06′11''	575.00	0.17					S 89° 35′52" E	S 89°29′41"
	CLOTHOID	ST	6156+67.35	1842413.50		21.35											
											1						
	TANGENT	ST	6156+67.35	1842413.56	65882	21.35		4344.28							S 89°29′41" E		
	TANGENT	TS	6200+11.63	1842375.20	65925	65.46											
		1		1	'	-	'		1	1	1	-1		1			
	CLOTHOID	TS	6200+11.63	1842375.20	65925	65.46											
	CLOTHOID	SPI	6207+78.30	1842368.50	65933	332.1		1150	0°09′53"	575.00	0.28					S 89°29′41" E	S 89° 39′34''
	CLOTHOID	SC	6211+61.63	1842366.22	65937	15.43											
				I					T				1			1	T
	ARC	SC	6211+61.63	1842366.22													
21-13 SJD-FRE 4 SB	ARC	PI	6219+89.30	1842361.3			016.5	1655.32	0° 28′27''			250	1.00	0.25		S 89° 39′34" E	S 89°51′59"
4 SB	ARC	CC		2042379.19													
	ARC	CS	6228+16.96	1842363.2	65953	(0.74											
	CL OTHOLD	0.0	6228+16.96	1040767.0	05057	70.74											
	CLOTHOID	CS	6232+00.29	1842363.2				1150	0°09′53''	575.00	0.28					S 89°51′59" E	S 89°42′06"
	CLOTHOID	SPI ST	6232+00.29	1842368.12				1130	0 09 53	373.00	0.20					3 69 51 59 E	3 89 42 06
	CLOTHOID	31	0239+00.90	1042300.12	.   65965	20.13											
	TANGENT	ST	6239+66.96	1842368.12	65965	20.73		43433.03							S 89° 42′06" E		
	TANGENT	TS	6673+99.99	1842594.3				10 100 100							0 00 12 00 2		
											1					1	1
	CLOTHOID	TS	6673+99.99	1842594.3	66399	53.17											
	CLOTHOID	SPI	6681+66.65	1842598.33	66407	19.83		1150	0°03′36''	575.00	0.10					S 89° 42′06" E	S 89°45′41"
	CLOTHOID	SC	6685+49.99	1842599.93	66411	03.16											
	ARC	SC	6685+49.99	1842599.93	66411	03.16											
21-13 SJD-FRE	ARC	PI	6691+55.16	1842602.45		08.33 550	0000	1210.35	0°07′34"			250	0.25	0.20		S 89°45′41" E	S 89°53′15"
5 SB	ARC	CC		1292604.69	66433	92.77											
	ARC	CS	6697+60.33	1842603.6	66423	313.5											
	01.0711010	0.5	0007100 77	1010007.6	00.40	14.7.5					I					T	
	CLOTHOID	CS	6697+60.33	1842603.64				1150	0°03′36"	E75.00	0.10					S 89°53′15" E	S 89°56′51"
	CLOTHOID	SPI ST	6701+43.67 6709+10.33	1842604.39 1842605.09				1150	0 03 36	575.00	0.10					5 89 53 15 E	2 89 20 21
	CLOTHOID	31	0109+10.33	1842803.03	00434	103.3											
	TANGENT	ST	6709+10.33	1842605.09	66434	163.5		1150							S 89° 56′51" E		
	TANGENT	TS	6720+60.33	1842606.15				. 150							3 33 30 31 2		
		1		1	1				1	1	1		1	1	1	1	<u>I</u>
	CLOTHOID	TS	6720+60.33	1842606.15	66446	613.5											
	CLOTHOID	SPI	6728+27.00	1842606.85	66453	80.16		1150	0°03′36"	575.00	0.10					S 89° 56′51" E	S 89° 53′15"
21-13	CLOTHOID	SC	6732+10.33	1842607.60	66457	763.5											
SJD-FRE 6 SB		·			<u> </u>		<u>'</u>		·	<u> </u>		·		·			
0 00	ARC	SC	6732+10.33	1842607.60	66457	763.5											
	ARC	PI	6738+15.51	1842608.79	66463	68.67 550	0000	1210.35	0°07′34"			250	0.25	0.20		S 89° 53′15" E	S 89° 45′41" I
				nec	GNED BY	1			ı				<u> </u>				CONTRACT NO.
				D	OLIVETI	RECORD SET					\		0	ALIFORNIA HI			GI HSR08-05
				м	TACTAY	15% DESIGN Submittal									TO FRESNO S Entral valley W		DRAWING NO. TT-B0051

TRACK ALIGNMENT DATA SUMMARY TABLE - AVENUE 21 TO ROAD 13 WYE - SOUTHBOUND TRACK SAN JOSE TO FRESNO

BY CHK APP

DESCRIPTION

SUBMITTAL NOT FOR N CHARGE
C. LEMLEY CONSTRUCTION 10/30/2015

ELVIS C.





# MERCED TO FRESNO SECTION

CENTRAL VALLEY WYE AVENUE 21 TO ROAD 13 WYE ALTERNATIVE SB TRACK SAN JOSE TO FRESNO GEOMETRY DATA SHEET 2 OF 9

HSR08-05
DRAWING NO.
TT-B0051-C
SCALE
NO SCALE
SHEET NO.

### TRACK ALIGNMENT DATA SUMMARY TABLE - AVENUE 21 TO ROAD 13 WYE - SOUTHBOUND TRACK SAN JOSE TO FRESNO

CURVE		POINT		COORD	INATES	RADIUS	LENGTH	DELTA			DESIGN	ACTUAL	UNBALANCED	WCB	WCB (O°	00'00")
NUMBER	ELEMENT	POINT TYPE	STATION	NORTHING	EASTING	(FT)	(FT)	Δ	K	P	SPEED (MPH)	SUPERELEVATION (EA) (IN)	UNBALANCED SUPERELEVATION (EU) (IN)	WCB (0°00′00") (TANGENT)	START ANGLE	END ANGLE
	ARC	CC		2392606.54	6644684.23											
21-13	ARC	CS	6744+20.68	1842611.31	6646973.84											
SJD-FRE 6 SB									•							
6 2B	CLOTHOID	CS	6744+20.68	1842611.31	6646973.84											
	CLOTHOID	SPI	6748+04.01	1842612.90	6647357.17		1150	0°03′36''	575.00	0.10					S 89°45′41" E	S 89°42′06" E
	CLOTHOID	ST	6755+70.68	1842616.90	6648123.82											
				T	T		I	1				T	1	T		
	TANGENT	ST	6755+70.68	1842616.90	6648123.82		10136.64							S 89° 42′06" E		
	TANGENT	TS	6857+07.32	1842669.69	6658260.33											
	CLOTHOID	TS	6857+07.32	1842669.69	6658260.33											
	CLOTHOID	SPI	6868+74.02	1842675.77	6659427.01		1750	1° 25′57''	874.98	3.65					S 89°42′06" E	S 88°51′58" E
	CLOTHOID	SC	6874+57.32	1842664.22	6660010.27											
									•							
	ARC	SC	6874+57.32	1842664.22	6660010.27											
21-13 SJD-FRE 7 SB	ARC	PI	7012+13.26	1842391.99	6673763.52	35000	26213.65	42° 54′44''			250	4.75	2.39		S 88°51′58" E	S 45°57′13" E
7 SB	ARC	СС		1807671.08	6659317.61											
	ARC	CS	7136+70.97	1832828.31	6683650.99											
	CLOTHOID	0.5	7136+70.97	1072020 74	6683650.99									I		
	CLOTHOID	CS	7141+41.64	1832828.31	6683989.3		1115.10	1° 1 4′38''	355.26	7.05					S 45°57′13" E	S 44°42′35" E
	CLOTHOID	SPI POE	7147+86.07	1832501.08	6683989.3		1115.10	1 14 38	333.26	3.65					3 43 37 13 E	3 44 42 33 E
	CLOTHOID	FOE	1141+86.01	1832043.07	0004442.69											

٦Ľ							D. OLIVETI	
L							DRAWN BY M. TACTAY	
L							CHECKED BY	
							IN CHARGE	
							C. LEMLEY	
Ŀ	REV	DATE	BY	CHK	APP	DESCRIPTION	10/30/2015	

RECORD SET
15% DESIGN
SUBMITTAL
NOT FOR
CONSTRUCTION





# CALIFORNIA HIGH-SPEED TRAIN PROJECT MERCED TO FRESNO SECTION

CENTRAL VALLEY WYE
AVENUE 21 TO ROAD 13 WYE ALTERNATIVE
SB TRACK SAN JOSE TO FRESNO GEOMETRY DATA
SHEET 3 OF 9

CONTRACT NO. HSR08-05
DRAWING NO.
TT-B0052-C
SCALE
NO SCALE

CURVE NUMBER	FLEMENT	POINT		COORD	INATES	DADILIC	LENGTH	DELTA			DESIGN	ACTUAL	UNBALANCED	WCB	WCB (0°00′00")	
	ELEMENT	POINT TYPE	STATION	NORTHING	EASTING	RADIUS (FT)	LENGTH (FT)	DELTA	K	Р	DESIGN SPEED (MPH)	ACTUAL SUPERELEVATION (EA) (IN)	UNBALANCED SUPERELEVATION (EU) (IN)	WCB (0°00′00") (TANGENT)	START ANGLE	END ANGLE
	TANGENT	РОВ	5338+00.00	1858067.61	6509106.46		2974.09							S 89°46′01" E		
	TANGENT	TS	5367+74.09	1858055.52	6512080.52											
		1			1	1		1	1	1	1		1			
	CLOTHOID	TS	5367+74.09	1858055.52	6512080.52											
	CLOTHOID	SPI	5378+74.11	1858051.04	6513180.53		1650	1° 01 ′38''	824.99	2.47					S 89°46′01" E	S 88°44′23"
	CLOTHOID	SC	5384+24.09	1858038.95	6513730.42											
	ARC	SC	5384+24.09	1858038.95	6513730.42											
21-13 SJD-FRE	ARC	PI	5472+80.35	1857844.17	6522584.54	46016.5	17498.57	21° 47′16''			250	3.75	1.68		S 88° 44′23" E	S 66°57′07"
1 NB	ARC	СС		1812033.58	6512718.35											
	ARC	CS	5559+22.66	1854376.93	6530733.87											
	CLOTHOID	CS	5559+22.66	1854376.93	6530733.87											
	CLOTHOID	SPI	5564+72.67	1854161.6	6531239.98		1650	1° 01 ′38''	824.99	2.47					S 66° 57′07" E	S 65°55′29′
	CLOTHOID	ST	5575+72.66	1853712.86	6532244.31											
		·														
	TANGENT	ST	5575+72.66	1853712.86	6532244.31		17188.97							S 65°55′29" E		
	TANGENT	TS	5747+61.63	1846700.88	6547938.03											
	CLOTHOID	TS	5747+61.63	1846700.88	6547938.03											
	CLOTHOID	SPI	5758+61.65	1846252.15	6548942.36		1650	1° 03′02''	824.99	2.52					S 65°55′29" E	S 66°58′31′
	CLOTHOID	SC	5764+11.63	1846037.02	6549448.56											
													_			
	ARC	SC	5764+11.63	1846037.02	6549448.56											
21-13 SJD-FRE	ARC	PI	5851+45.59	1842620.91	6557486.75	45000	17253.42	21° 58′04''			250	4.00	1.56		S 66°58′31" E	S 88°56′35′
2 NB	ARC	СС		1887452.14	6567049.35											
	ARC	CS	5936+65.05	1842459.8	6566219.23											
	CLOTHOID	CS	5936+65.05	1842459.8	6566219.23											
	CLOTHOID	SPI	5942+15.06	1842449.65	6566769.15		1650	1° 03′02''	824.99	2.52					S 88°56′35" E	S 89°59′36
	CLOTHOID	ST	5953+15.05	1842449.52	6567869.17											
						1			1			T	1			
	TANGENT	ST	5953+15.05	1842449.52	6567869.17		16417.61							S 89°59′36" E		
	TANGENT	TS	6117+32.66	1842447.64	6584286.78											
					I	I		T		T		T				
	CLOTHOID	TS	6117+32.66	1842447.64	6584286.78											
	CLOTHOID	SPI	6124+99.32	1842447.55	6585053.45		1150	0° 06′11''	575	0.17					S 89°59′36" E	S 89°53′26′
	CLOTHOID	SC	6128+82.66	1842446.82	6585436.78											
		T			T	I	Γ	I		I		T	1			
	ARC	SC	6128+82.66	1842446.82	6585436.78											
21-13 SJD-FRE 3 NB	ARC	PI	6137+00.08	1842445.25	6586254.2	320016.5	1634.83	0°17′34"			250	0.50	0.28		S 89°53′26" E	S 89° 35′52"
3 NB	ARC	CC		1522430.9	6584825.01											
-	ARC	CS	6145+17.49	1842439.51	6587071.6										i e	

TRACK ALIGNMENT DATA SUMMARY TABLE - AVENUE 21 TO ROAD 13 WYE - NORTHBOUND TRACK SAN JOSE TO FRESNO

D. OLIVETI DRAWN BY
M. TACTAY ELVIS C. N CHARGE 10/30/2015 BY CHK APP DESCRIPTION

RECORD SET 15% DESIGN SUBMITTAL NOT FOR CONSTRUCTION





### CALIFORNIA HIGH-SPEED TRAIN PROJECT MERCED TO FRESNO SECTION

CENTRAL VALLEY WYE AVENUE 21 TO ROAD 13 WYE ALTERNATIVE NB TRACK SAN JOSE TO FRESNO GEOMETRY DATA SHEET 4 OF 9

HSR08-05	
DRAWING NO. TT-B0053-C	
NO SCALE	
SHEET NO.	

DATE

BY CHK APP

DESCRIPTION

SUBMITTAL NOT FOR CONSTRUCTION

ELVIS C.

C. LEMLEY

10/30/2015





CENTRAL VALLEY WYE AVENUE 21 TO ROAD 13 WYE ALTERNATIVE NB TRACK SAN JOSE TO FRESNO GEOMETRY DATA SHEET 5 OF 9

HSR08-05							
DRAWING NO.							
TT-B0054-C							
SCALE							
NO SCALE							
SHEET NO.							

CURVE

NUMBER

21-13 SJD-FRE 6 NB

21-13 SJD-FRE 7 NB

ELEMENT

ARC

CLOTHOID

CLOTHOID

CLOTHOID

TANGENT

TANGENT

CLOTHOID

CLOTHOID

CLOTHOID

ARC

ARC

ARC

CLOTHOID

CLOTHOID

CLOTHOID

TYPE

CS

CS

SPI

ST

ST

TS

TS

SPI

SC

SC

PΙ

CC

CS

CS

SPI

POE

3							
23							D. OLIVETI
							DRAWN BY M. TACTAY
							CHECKED BY ELVIS C.
DCC   C							IN CHARGE  C. LEMLEY
DOG.	REV	DATE	BY	СНК	APP	DESCRIPTION	10/30/201

SET IGN ΓAL OR CTION



TRACK ALIGNMENT DATA SUMMARY TABLE - AVENUE 21 TO ROAD 13 WYE - NORTHBOUND TRACK SAN JOSE TO FRESNO

575

874.98

355.23

0.1

3.64

3.64

DELTA

Δ

0°03′36"

1° 25′54"

42° 54′49"

1°14′36"

LENGTH

(FT)

1150

10136.64

1750

26226.84

1115.04

(FT)

35016.5

DESIGN SPEED

(MPH)

250

ACTUAL SUPERELEVATION (EA) (IN)

4.75

UNBALANCED SUPERELEVATION (EU) (IN)

2.39

WCB

(0°00′00")

(TANGENT)

S 89° 42′06" E

WCB (0°00′00")

END ANGLE

S 89°42′06" E

S 88°52′00" E

S 45°57′11" E

S 44° 42′35" E

START ANGLE

S 89°45′41" E

S 89°42′06" E

S 88°52′00" E

S 45°57′11" E



### CALIFORNIA HIGH-SPEED TRAIN PROJECT MERCED TO FRESNO SECTION

CENTRAL VALLEY WYE AVENUE 21 TO ROAD 13 WYE ALTERNATIVE NB TRACK SAN JOSE TO FRESNO GEOMETRY DATA SHEET 6 OF 9

CONTRACT NO. HSR08-05
DRAWING NO. TT-B0055-C
NO SCALE
SHEET NO.

.IVETI	RECORD S
CTAY	15% DESI
BY C.	SUBMITT
MLEY	NOT FO

COORDINATES

EASTING

6646973.71

6646973.71

6647357.04

6648123.70

6648123.70

6658260.24

6658260.24

6659426.93

6660010.18

6660010.18

6673770.40

6659317.61

6683662.76

6683662.76

6684001.05

6684454.42

NORTHING

1842627.81

1842627.81

1842629.40

1842633.40

1842633.40

1842686.19

1842686.19

1842692.27

1842680.73

1842680.73

1842408.52

1807671.08

1832839.89

1832839.89

1832512.66

1832054.68

STATION

6744+20.49

6744+20.49

6748+03.82

6755+70.49

6755+70.49

6857+07.17

6857+07.17

6868+73.87

6874+57.17

6874+57.17

7012+20.07

7136+84.00

7136+84.00

7141+54.66

7147+99.04

						D. OLIVETI
						DRAWN BY M. TACTAY
						CHECKED BY
						IN CHARGE C. LEMLEY
REV	DATE	BY	СНК	APP	DESCRIPTION	10/30/2015

RECORD SET
15% DESIGN
SUBMITTAL
NOT FOR
CONSTRUCTION





# CALIFORNIA HIGH-SPEED TRAIN PROJECT MERCED TO FRESNO SECTION

CENTRAL VALLEY WYE
AVENUE 21 TO ROAD 13 WYE ALTERNATIVE
SB TRACK MERCED TO FRESNO GEOMETRY DATA
SHEET 7 OF 9

	CONTRACT NO. HSR08-05									
	DRAWING NO. TT-B0056-C									
	NO SCALE									
	SHEET NO.									

CLIDVE		DOTHE			K ALIGNMENT D INATES						DESIGN	ΔΩΤΙΙΔΙ	UNBALANCED	, WCB	WCB (0°	°00′00")
CURVE NUMBER	ELEMENT	POINT TYPE	STATION	NORTHING	EASTING	RADIUS (FT)	LENGTH (FT)	DELTA △	K	Р	SPEED (MPH)	SUPERELEVATION (EA) (IN)	SUPERELEVATION (EU) (IN)	(0°00′00'') (TANGENT)	START ANGLE	END ANGLE
	TANGENT	POB	14862+09.67	1842522.53	6632886.24		4678.66							S 89°42′06" W		
	TANGENT	TS	14908+88.34	1842498.16	6628207.64											
			I	1		1					-1					1
	CLOTHOID	TS	14908+88.34	1842498.16	6628207.64											
	CLOTHOID	SPI	14918+88.61	1842492.95	6627207.38		1500	4° 08′31"	749.87	9.03					S 89°42′06" W	N 86°09′24" N
	CLOTHOID	SC	14923+88.34	1842526.49	6626708.26											
	ARC	SC	14923+88.34	1842526.49	6626708.26											
21-13 MER-FRE	ARC	PI	15013+74.28	1843128.82	6617742.52	10375	14810.85	81° 47′34''			150	6.00	2.67		N 86°09′24" W	N 4°21′50" W
1 SB	ARC	CC		1852878.15	6627403.70											
	ARC	CS	15071+99.18	1852088.71	6617058.78											
		T	ı	ı	T	T	T	1					1			1
	CLOTHOID	CS	15071+99.18	1852088.71	6617058.78											
	CLOTHOID	SPI	15076+99.43	1852587.51	6617020.71		1500	4° 08′31"	749.87	9.03					N 4°21′50" W	N 0°13′19" W
	CLOTHOID	ST	15086+99.18	1853587.78	6617016.83											
			T	T	T	T	T	I					T		T	T
	TANGENT	ST	15086+99.18	1853587.78	6617016.83		16620.06							N 0°13′19" W		
	TANGENT	TS	15253+19.25	1870207.72	6616952.43											
	01.0711010	TC	45057.40.05	1070007 70	6646050 47											
	CLOTHOID	TS	15253+19.25	1870207.72	6616952.43		2250	2° 08′55''	1104.05	7.07					N 0°13′19" W	N 0° 00/4 4" W
	CLOTHOID	SPI SC	15268+19.36 15275+69.25	1871707.82	6616946.62 6616915.59		2250	2 08 55	1124.95	7.03					N 0 13 19 W	N 2°22′14" W
	CLOTHOID	30	15275+69.25	1012431.20	0010913.39											
	ARC	SC	15275+69.25	1872457.28	6616915.59											
21-13	ARC	PI	15385+02.72	1883381.39	6616463.35	30000	20969.31	40° 02′54''			250	5.75	2.58		N 2°22′14" W	N 42° 25′09" V
MER-FRE 2 SB	ARC	CC	13333.02.12	1871216.38	6586941.27	3000	20303.01	10 02 31			200	3.13	2.00		11 2 22 11 11	11 12 23 33 1
2 00	ARC	CS	15485+38.56	1891452.82	6609088.20											
	CLOTHOID	CS	15485+38.56	1891452.82	6609088.20											
	CLOTHOID	SPI	15492+88.66	1892006.56	6608582.23		2250	2° 08′55"	1124.95	7.03					N 42°25′09" W	N 44° 34′03" V
	CLOTHOID	ST	15507+88.56	1893075.28	6607529.52											
		1	1	1	1	1		1			1	1	1		1	ı
	TANGENT	ST	15507+88.56	1893075.28	6607529.52		14711.44							N 44° 34′03" W		
	TANGENT	POE	15655+00.00	1903556.04	6597205.76											

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CURVE	EL EMENT	POINT	CTATION	COORD	INATES	RADIUS	LENGTH	DELTA			DESIGN	ACTUAL SUPERELEVATION	UNBALANCED	WCB (0°00′00")	WCB (O	°00′00")
NUMBER	ELEMENT	POINT TYPE	STATION	NORTHING	EASTING	(FT)	(FT)	Δ	K	P	SPEED (MPH)	(EA) (IN)	UNBALANCED SUPERELEVATION (EU) (IN)	(TANGENT)	START ANGLE	END ANGLE
	TANGENT	POB	24859+53.49	1842600.62	6633190.21		5041.47							S 89°42′06" W		
	TANGENT	TS	24909+94.96	1842574.36	6628148.81											
		1					1	1	1	1					ı	1
	CLOTHOID	TS	24909+94.96	1842574.36	6628148.81											
	CLOTHOID	SPI	24919+95.24	1842569.15	6627148.54		1500	4° 10′19''	749.87	9.10					S 89°42′06" W	N 86°07′35" \
	CLOTHOID	SC	24924+94.96	1842602.94	6626649.43											
	ARC	SC	24924+94.96	1842602.94	6626649.43											
21-13 MER-FRE	ARC	PI	25014+06.46	1843204.96	6617758.29	10300	14692.94	81° 43′56''			150	6.00	2.74		N 86°07′35" W	N 4°23′39" W
1 NB	ARC	СС		1852879.41	6627345.26											
	ARC	CS	25071+87.90	1852090.27	6617075.53											
	CLOTHOID	CS	25071+87.90	1852090.27	6617075.53											
	CLOTHOID	SPI	25076+88.15	1852589.06	6617037.2		1500	4° 10′19''	749.87	9.10					N 4°23′39"W	N 0°13′19" W
	CLOTHOID	ST	25086+87.90	1853589.33	6617033.33											
	TANGENT	ST	25086+87.90	1853589.33	6617033.33		16618.58							N 0°13′19" W		
	TANGENT	TS	25253+06.48	1870207.78	6616968.93											
									T.						T.	
	CLOTHOID	TS	25253+06.48	1870207.78	6616968.93											
	CLOTHOID	SPI	25268+06.59	1871707.88	6616963.12		2250	2°08′51"	1124.95	7.03					N 0°13′19" W	N 2°22′10" W
	CLOTHOID	SC	25275+56.48	1872457.34	6616932.11											
						1			I	1					1	ı
	ARC	SC	25275+56.48	1872457.34	6616932.11											
21-13 MER-FRE	ARC	PI	25384+96.66	1883388.17	6616479.81	30016.5	20982.08	40°03′03''			250	5.75	2.58		N 2° 22′10" W	N 42°25′13" \
2 NB	ARC	CC		1871216.38	6586941.27											
	ARC	CS	25485+38.56	1891464.4	6609099.97											
						T		Γ	I	1	1	I	Γ	Г	T	I
	CLOTHOID	CS	25485+38.56	1891464.4	6609099.97											
	CLOTHOID	SPI	25492+88.66	1892018.14	6608593.98		2250	2°08′51"	1124.95	7.03					N 42° 25′13" W	N 44°34′03" \
	CLOTHOID	ST	25507+88.56	1893086.85	6607541.28											
				40076		I		I							T	I
	TANGENT	ST	25507+88.56	1893086.85	6607541.28		14711.45							N 44° 34′03" W		
	TANGENT	POE	25655+00.00	1903567.62	6597217.51											

TRACK ALIGNMENT DATA SUMMARY TABLE - AVENUE 21 TO ROAD 13 WYE - NORTHBOUND TRACK MERCED TO FRESNO

						D. OLIVETI	
						DRAWN BY M. TACTAY	
						CHECKED BY ELVIS C.	
						IN CHARGE C. LEMLEY	(
REV	DATE	BY	СНК	APP	DESCRIPTION	DATE 10/30/2015	

RECORD SET 15% DESIGN SUBMITTAL NOT FOR CONSTRUCTION





### CALIFORNIA HIGH-SPEED TRAIN PROJECT MERCED TO FRESNO SECTION

CENTRAL VALLEY WYE AVENUE 21 TO ROAD 13 WYE ALTERNATIVE NB TRACK MERCED TO FRESNO GEOMETRY DATA SHEET 8 OF 9

Γ	CONTRACT NO. HSRO8-05
	DRAWING NO. TT-B0057-C
	NO SCALE
	SHEET NO.

TRACK ALIGNMENT DATA SUMMARY TABLE - AVENUE 21 TO ROAD 13 WYE - SOUTHBOUND TRACK SAN JOSE TO MERCED

CURVE NUMBER	ELEMENT	POINT	CTATION	COORD	INATES	RADIUS	LENGTH	DELTA	V	D	DESIGN	ACTUAL SUPERELEVATION	UNBALANCED SUPERELEVATION	WCB (0°00′00")	WCB (0°	00′00")
NUMBER		TYPE	STATION	NORTHING	EASTING	(FT)	(FT)	Δ			SPEED (MPH)	(EA) (IN)	(EU) (IN)	(TANGENT)	START ANGLE	END ANGLE
	TANGENT	POB	46291+67.21	1842360.21	6601721.09		4269.09							N 89°42′06" E		
	TANGENT	TS	46334+36.30	1842382.45	6605990.12											
	CLOTHOID	TS	46334+36.30	1842382.45	6605990.12											
	CLOTHOID	SPI	46344+36.58	1842387.65	6606990.38		1500	4° 08′29''	749.87	9.03					N 89° 42′06" E	N 85° 33′37" E
	CLOTHOID	SC	46349+36.30	1842426.38	6607489.13											
	ARC	SC	46349+36.30	1842426.38	6607489.13											
21-13 S ID-MER	ARC	PI	46438+99.55	1843120.22	6616425.48	10376.5	14785.53	81° 38′28''			150	6.00	2.67		N 85° 33′37" E	N 3°55′09" E
SJD-MER 1 NB	ARC	CC		1852771.74	6606685.89											
	ARC	CS	46497+21.83	1852062.5	6617038.12											
	CLOTHOID	CS	46497+21.83	1852062.5	6617038.12											
	CLOTHOID	SPI	46502+22.08	1852561.58	6617072.31		1500	4° 08′29''	749.87	9.03					N 3°55′09" E	N 0°13′19" W
	CLOTHOID	ST	46512+21.83	1853561.85	6617068.44											
													,			
	TANGENT	ST	46512+21.83	1853561.85	6617068.44		3459.74							N 0°13′19" W		
	TANGENT	POE	46546+81.57	1857021.56	6617055.03											

						DESIGNED BY D. OLIVETI	_
						DRAWN BY M. TACTAY	
						CHECKED BY ELVIS C.	
						IN CHARGE	
						C. LEMLEY	
REV	DATE	BY	снк	APP	DESCRIPTION	10/30/2015	

RECORD SET 15% DESIGN SUBMITTAL NOT FOR CONSTRUCTION








### CALIFORNIA HIGH-SPEED TRAIN PROJECT MERCED TO FRESNO SECTION


CENTRAL VALLEY WYE AVENUE 21 TO ROAD 13 WYE ALTERNATIVE NB & SB TRACK SAN JOSE TO MERCED GEOMETRY DATA SHEET 9 OF 9


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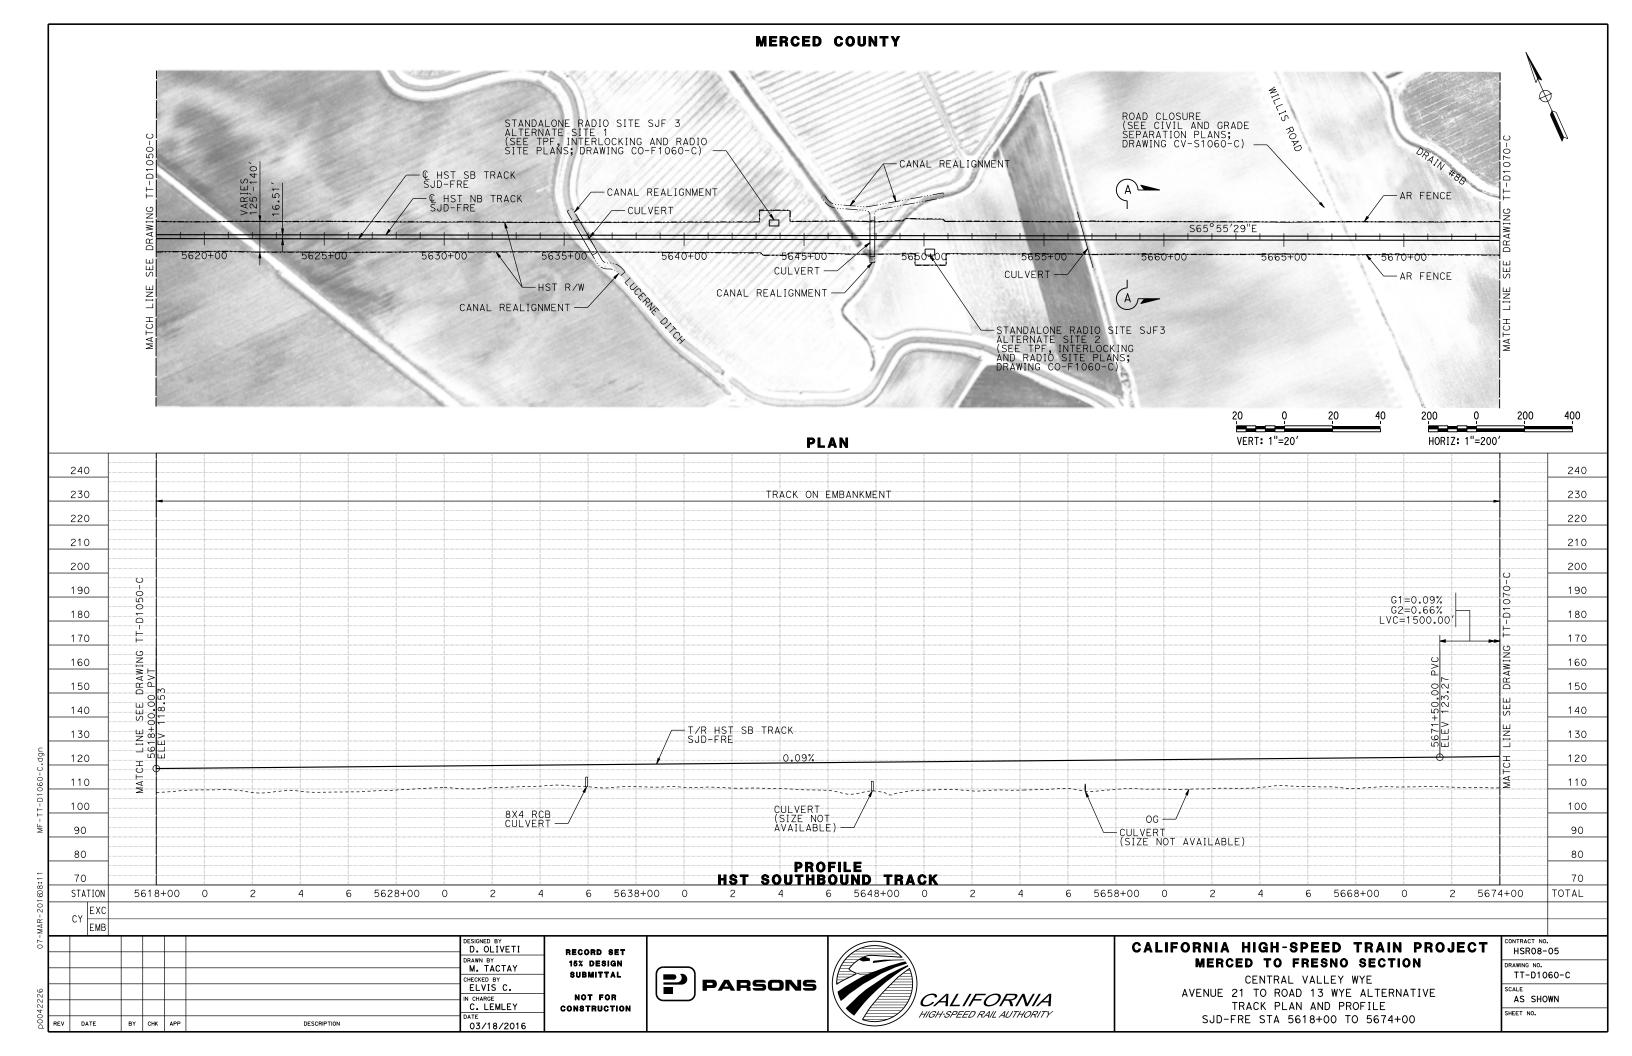


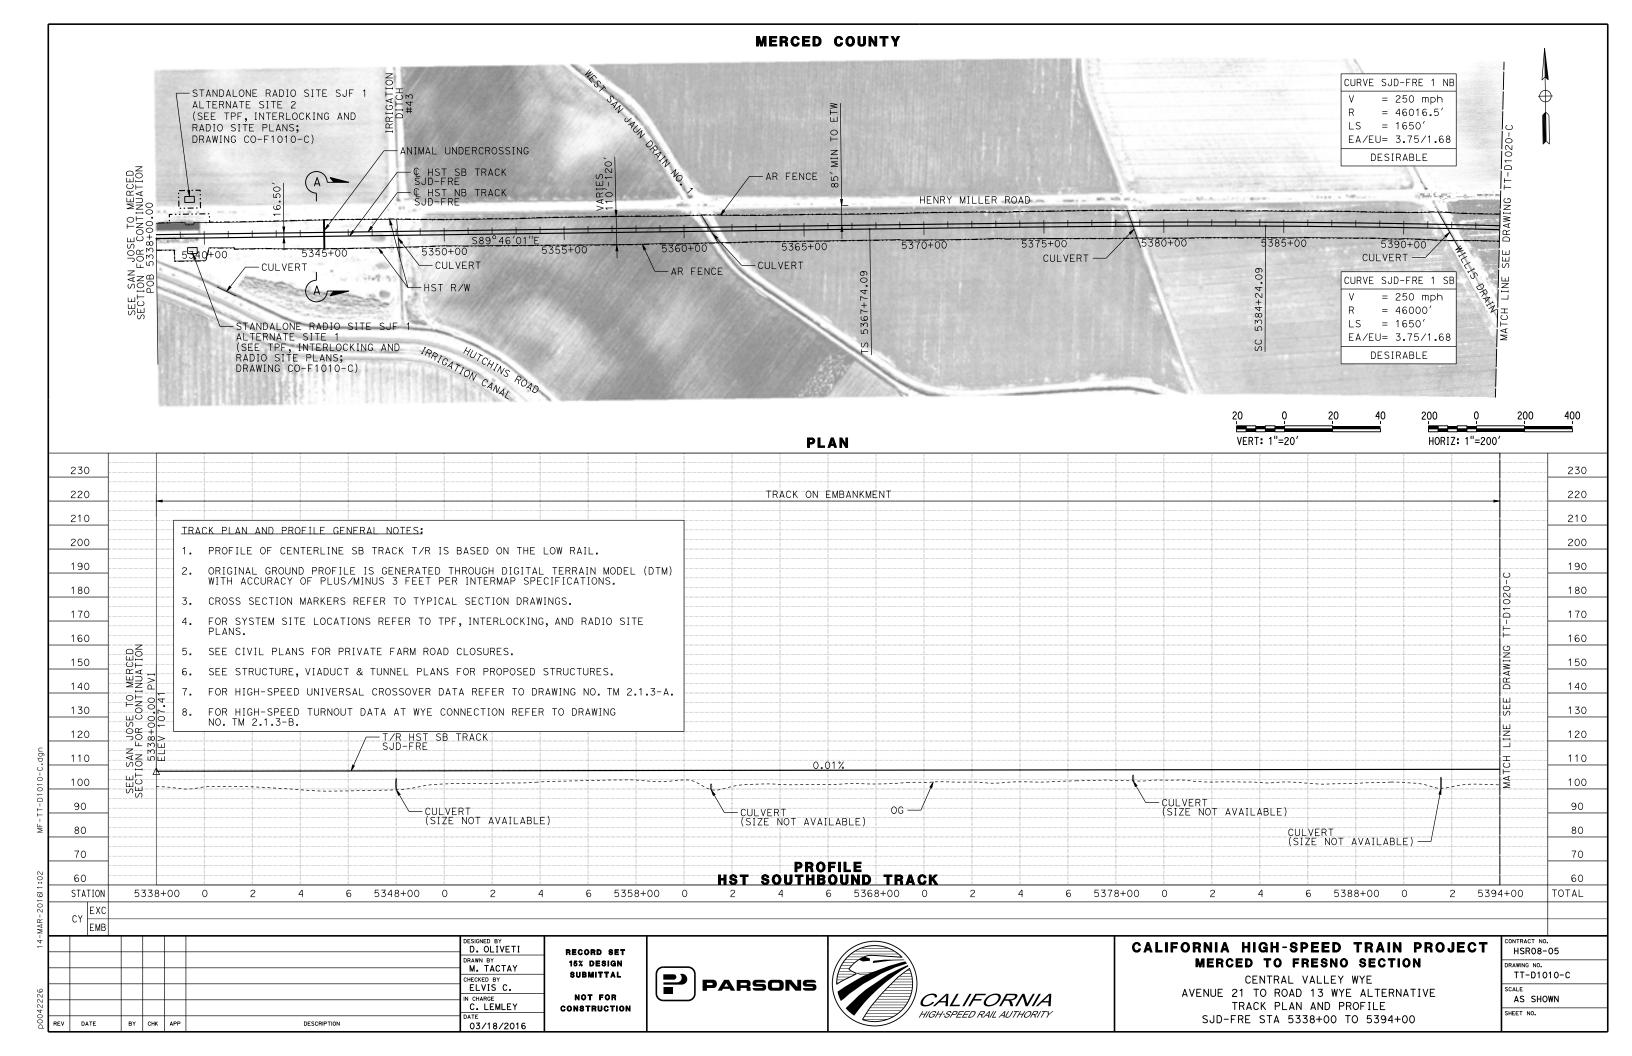


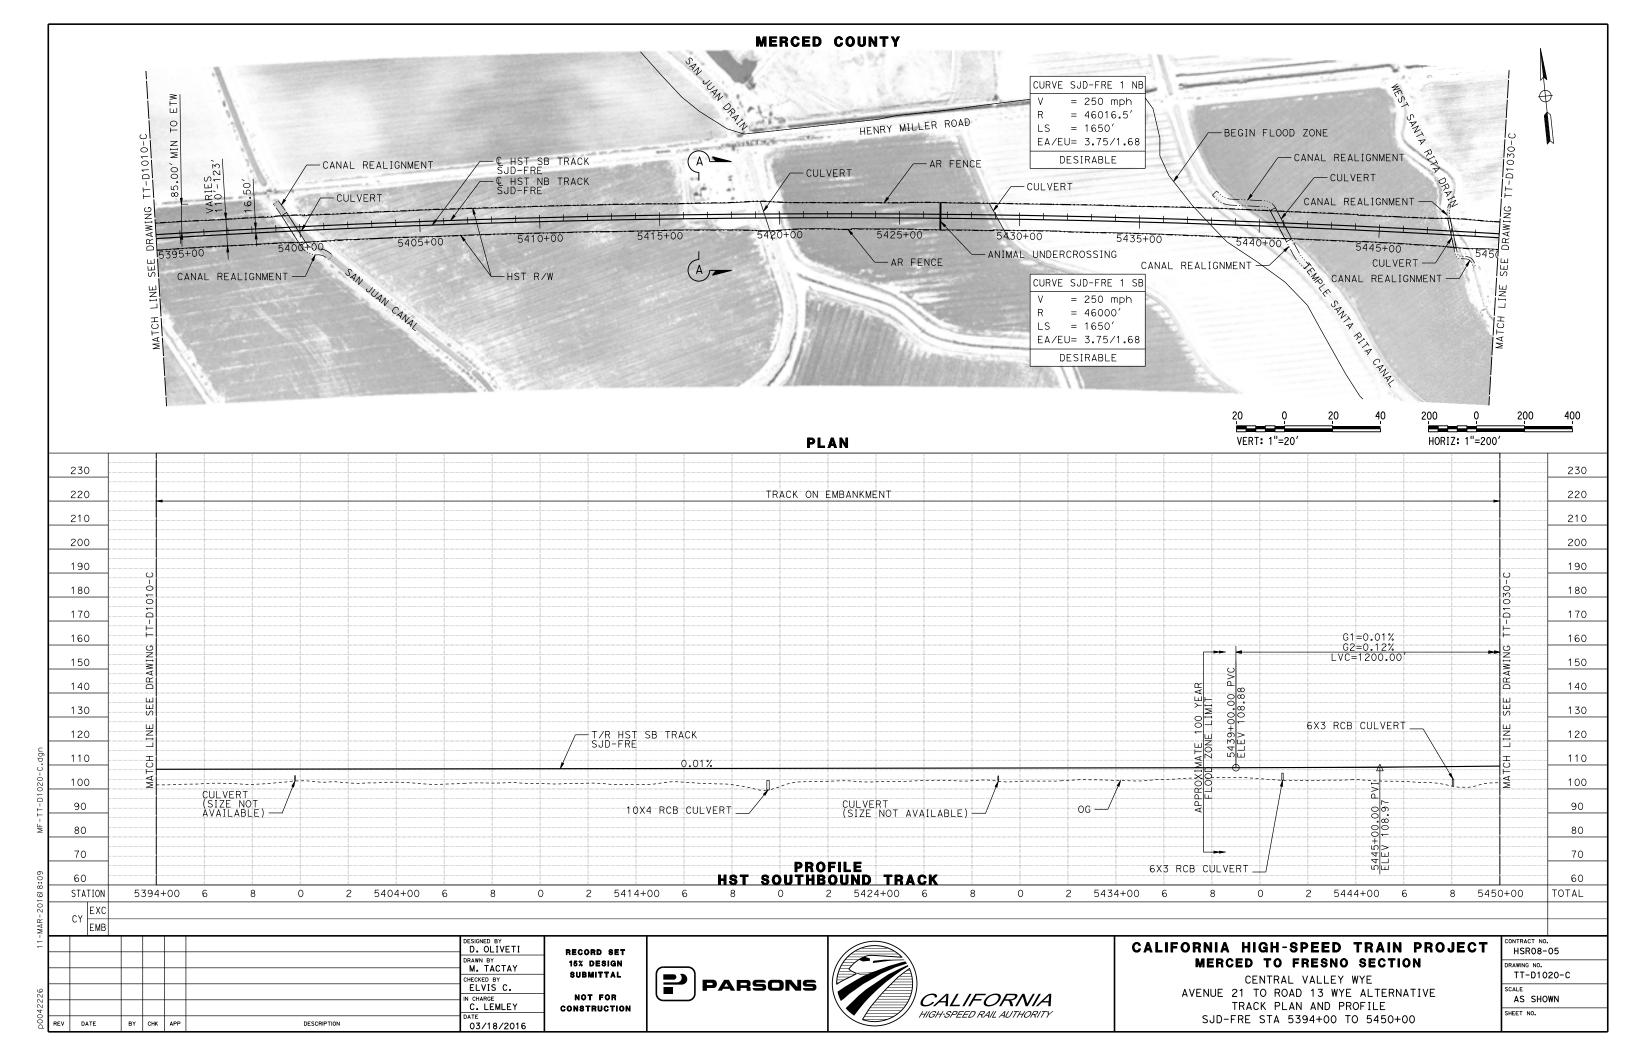


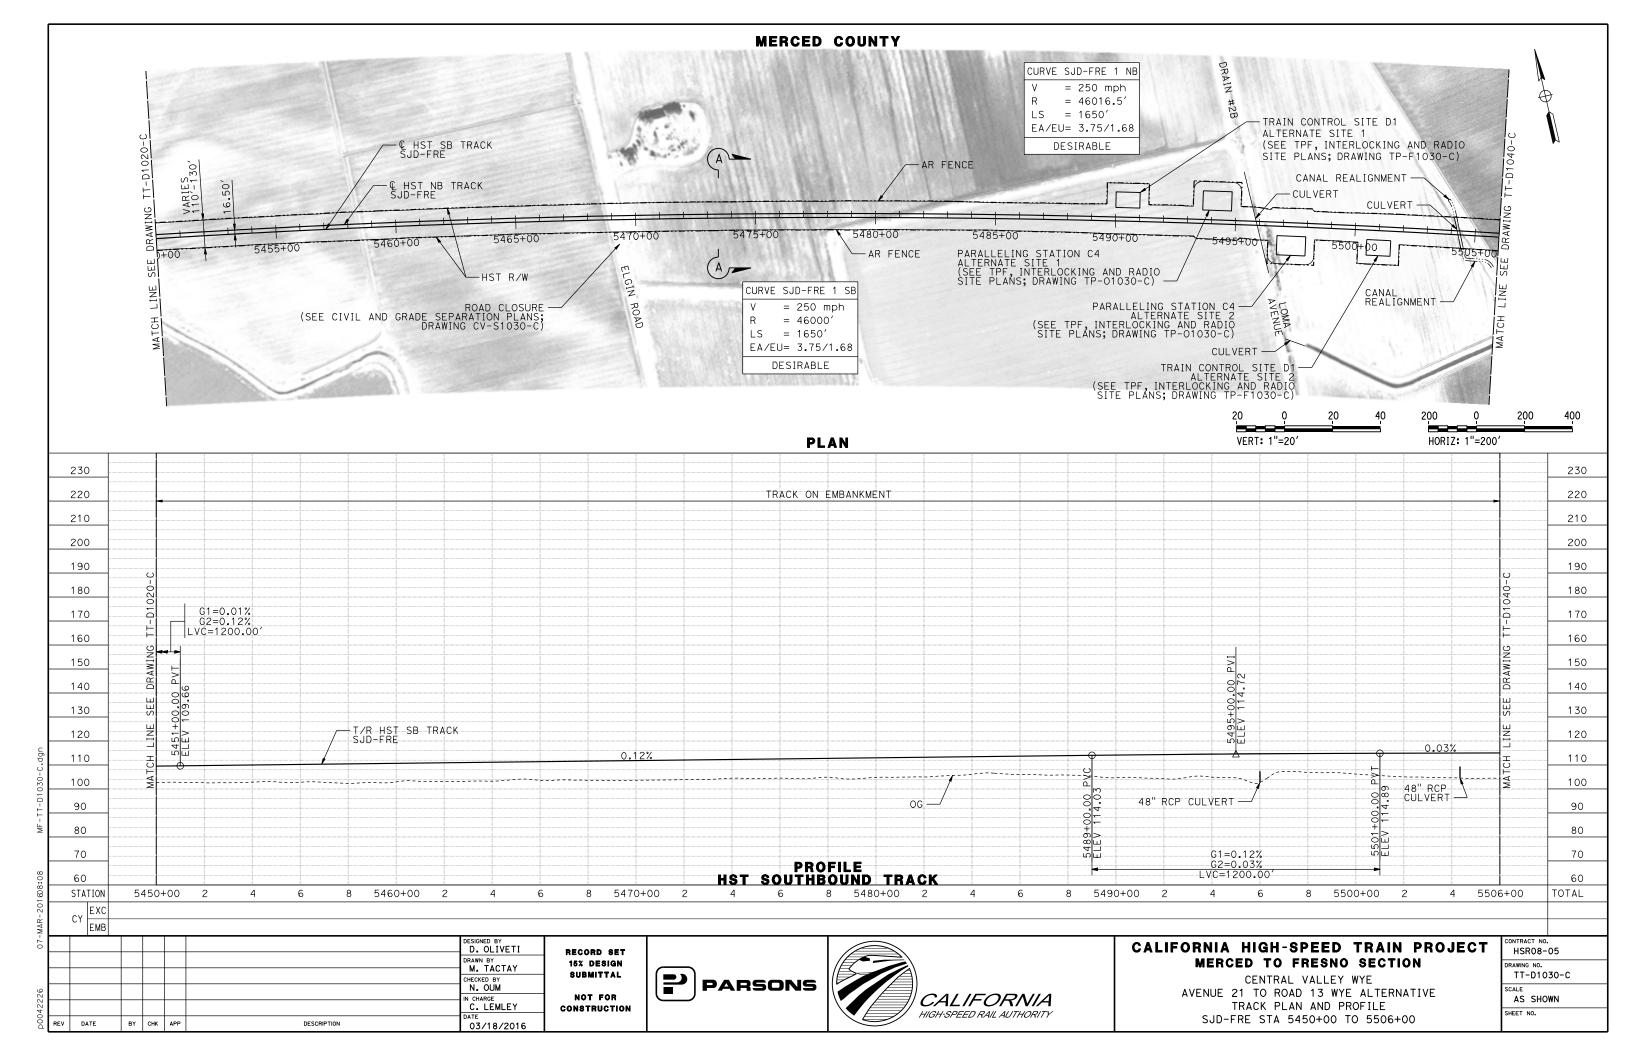


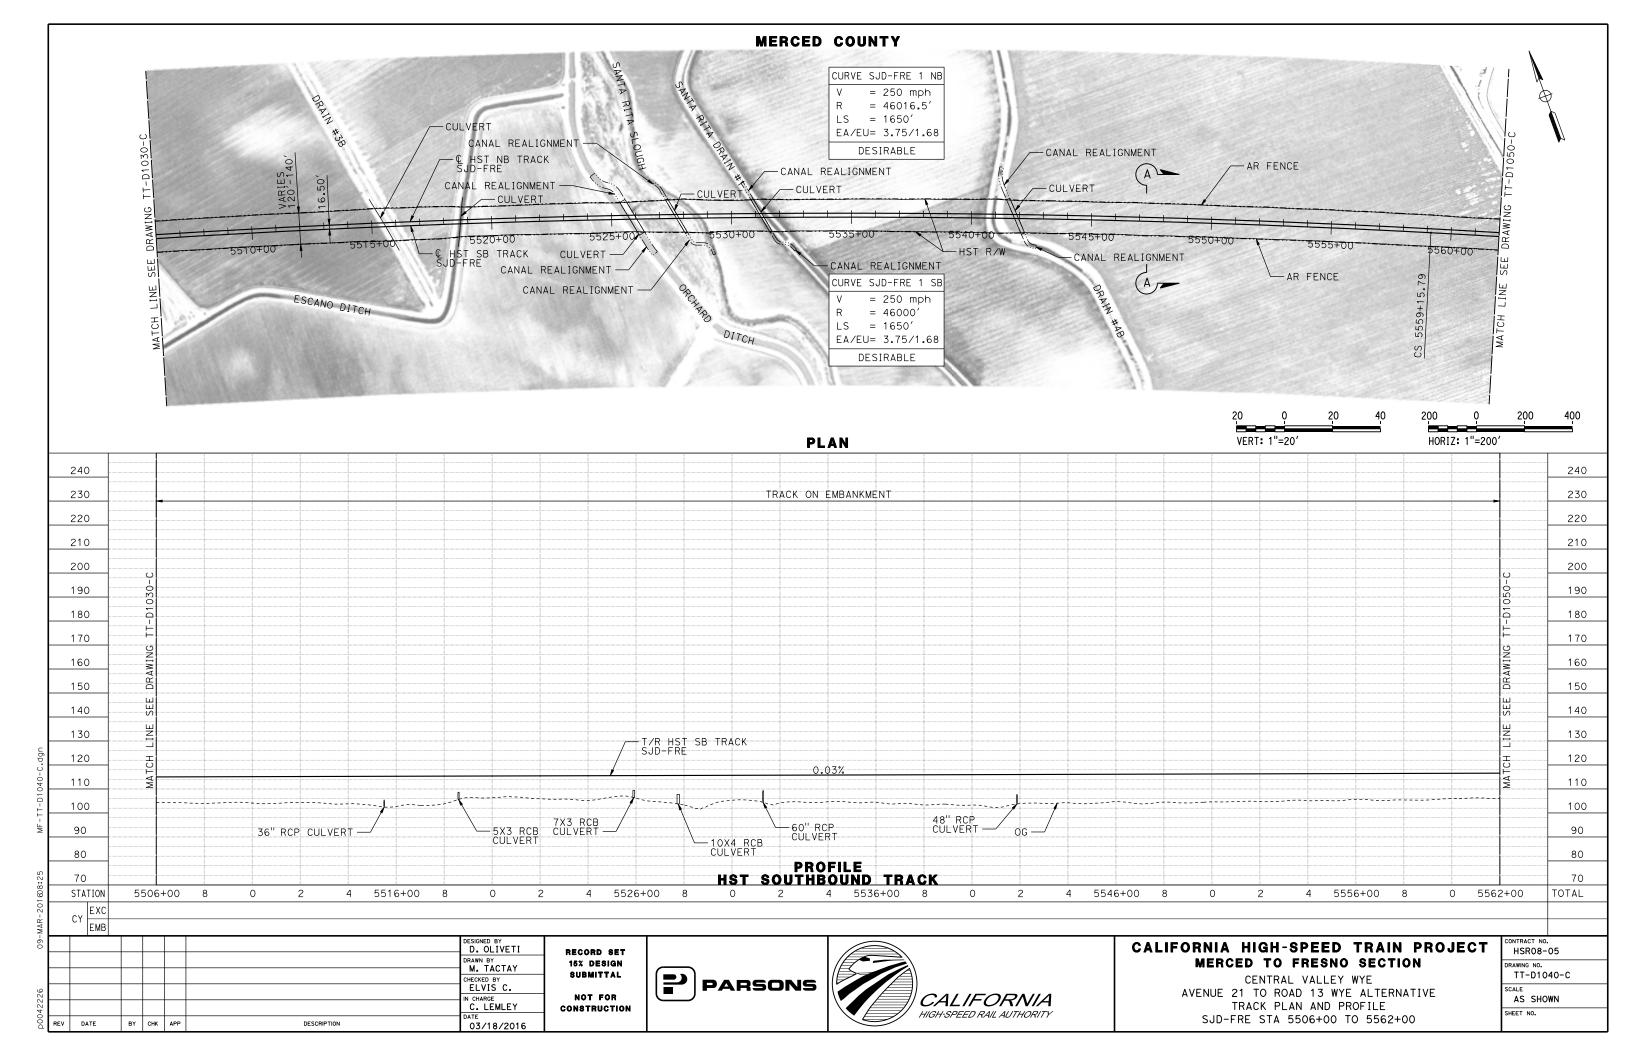


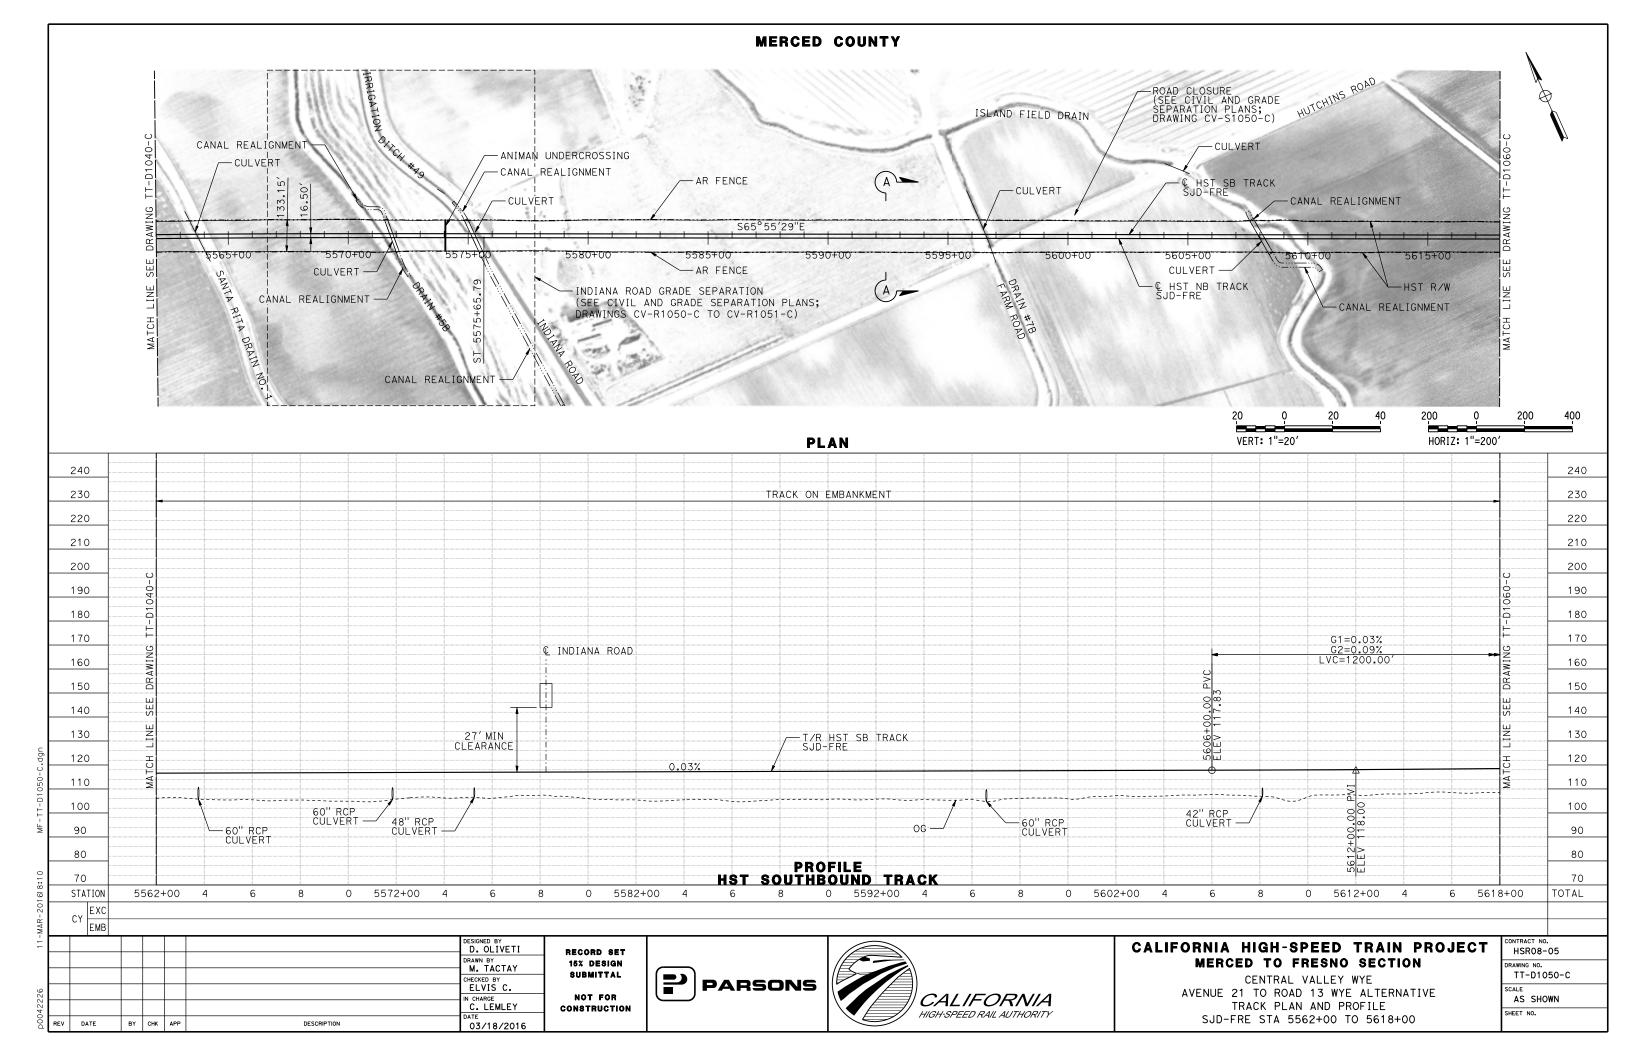


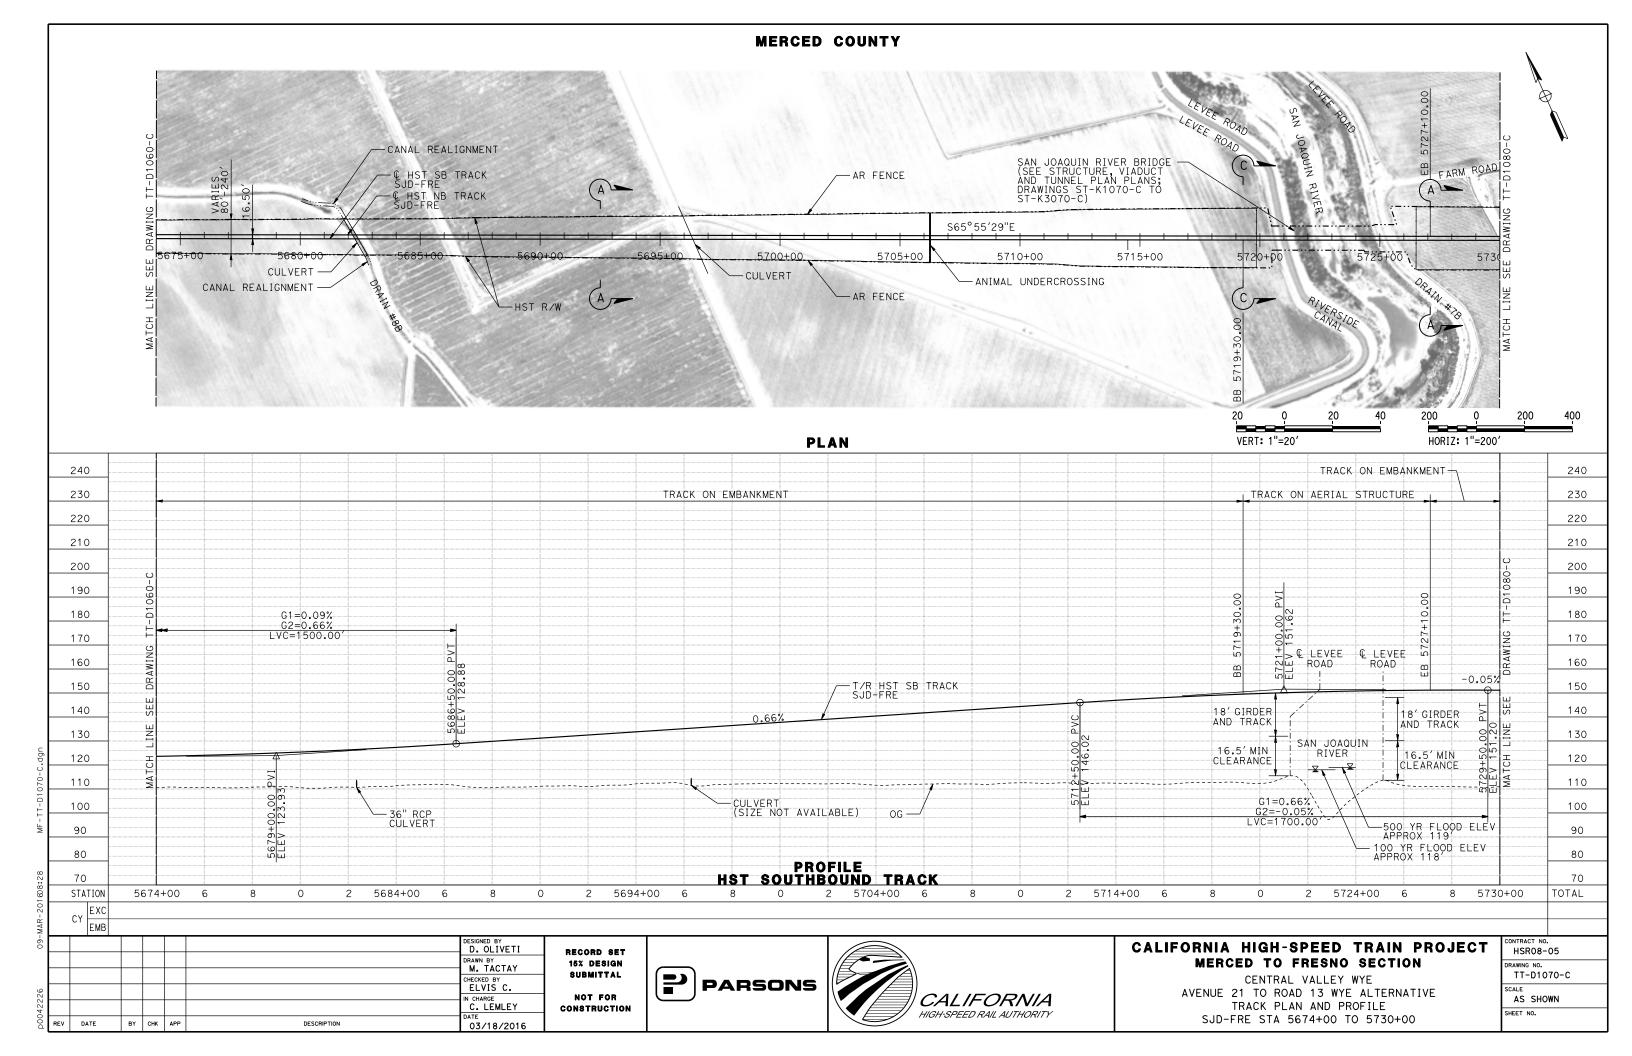


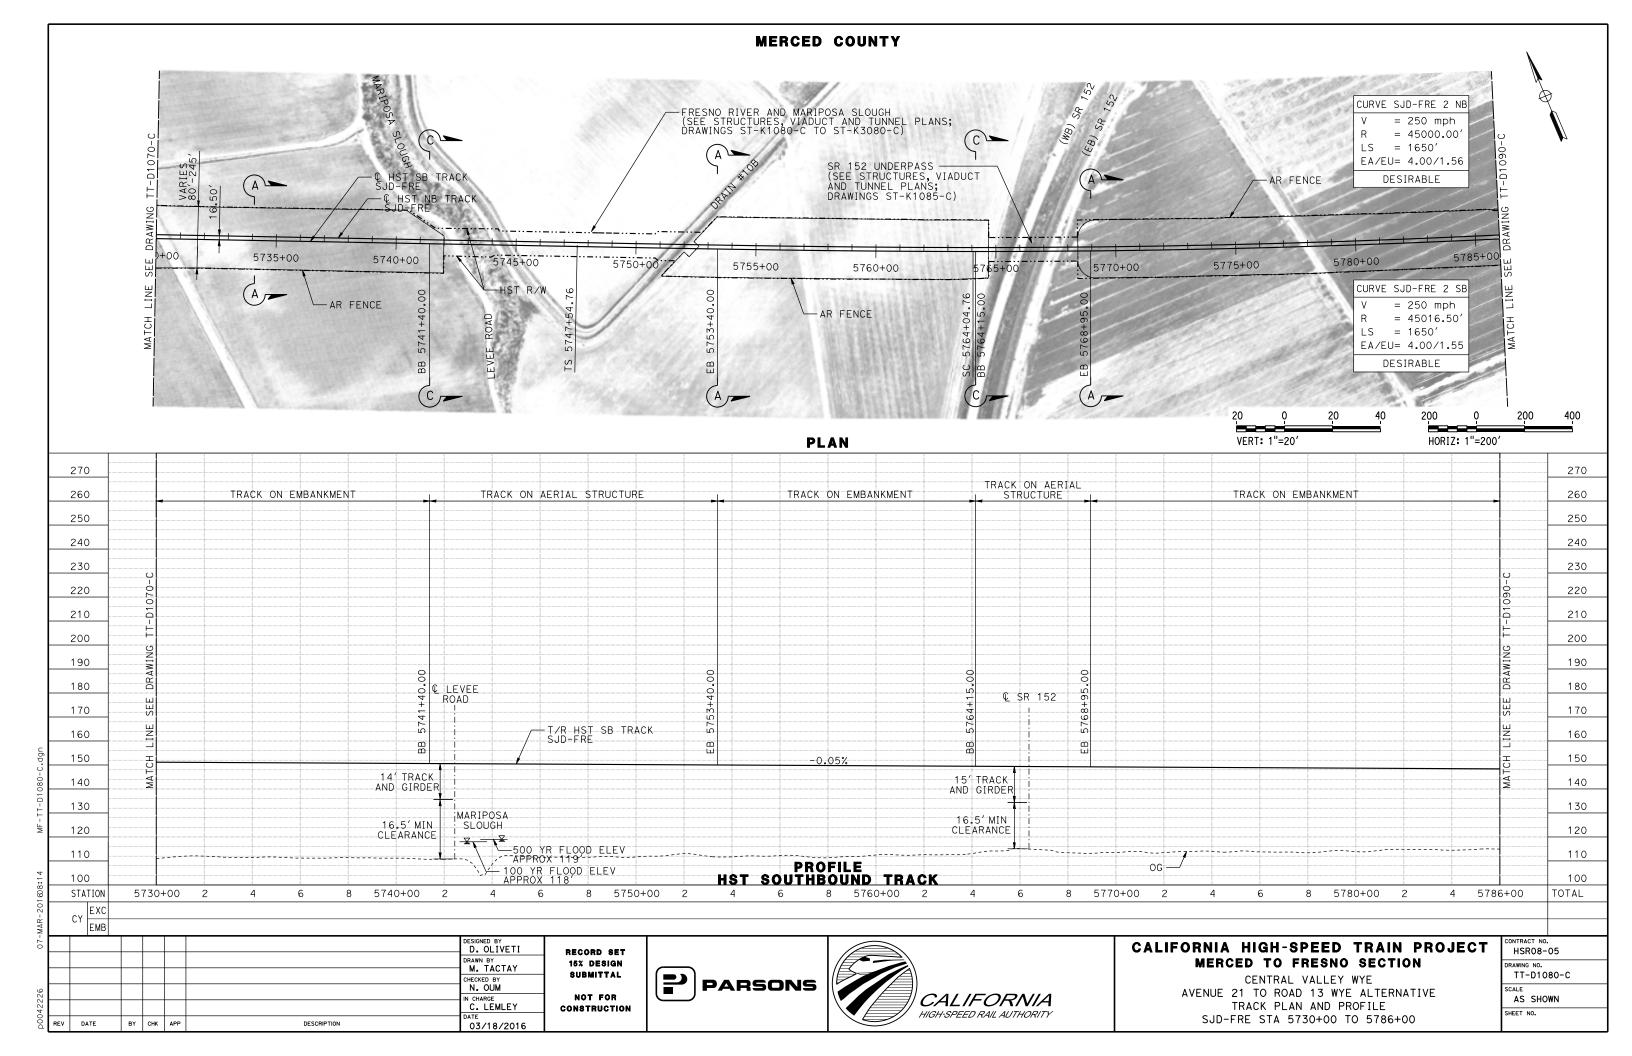


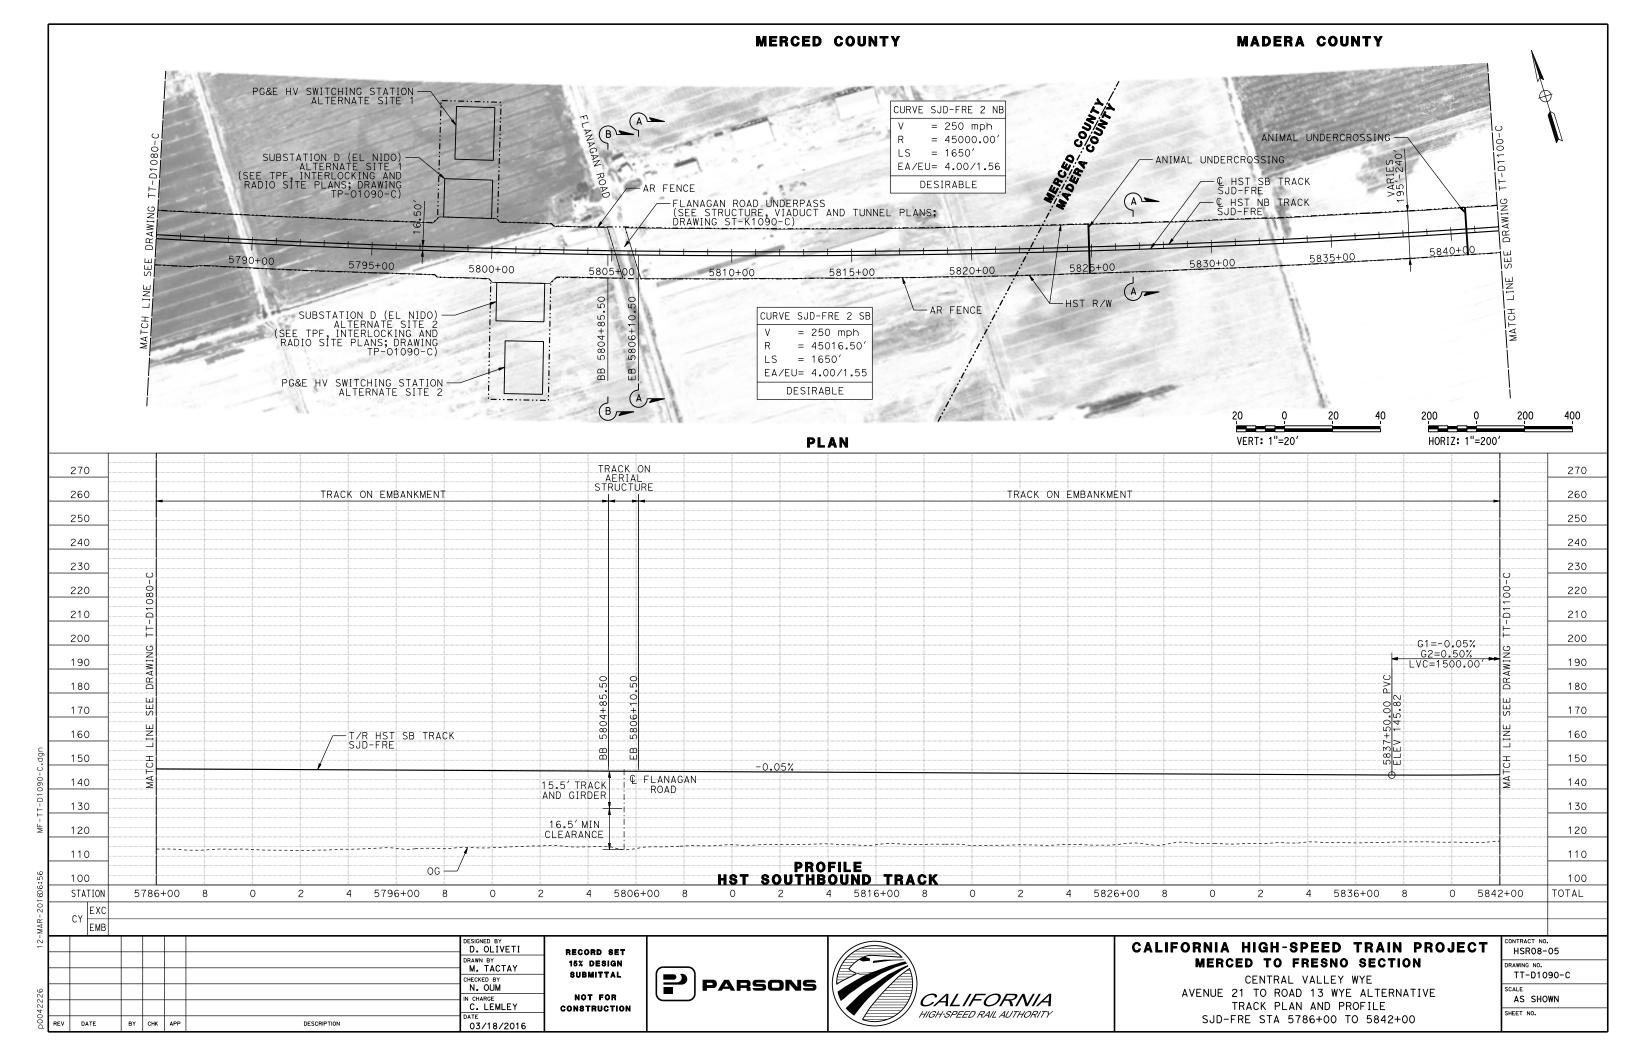


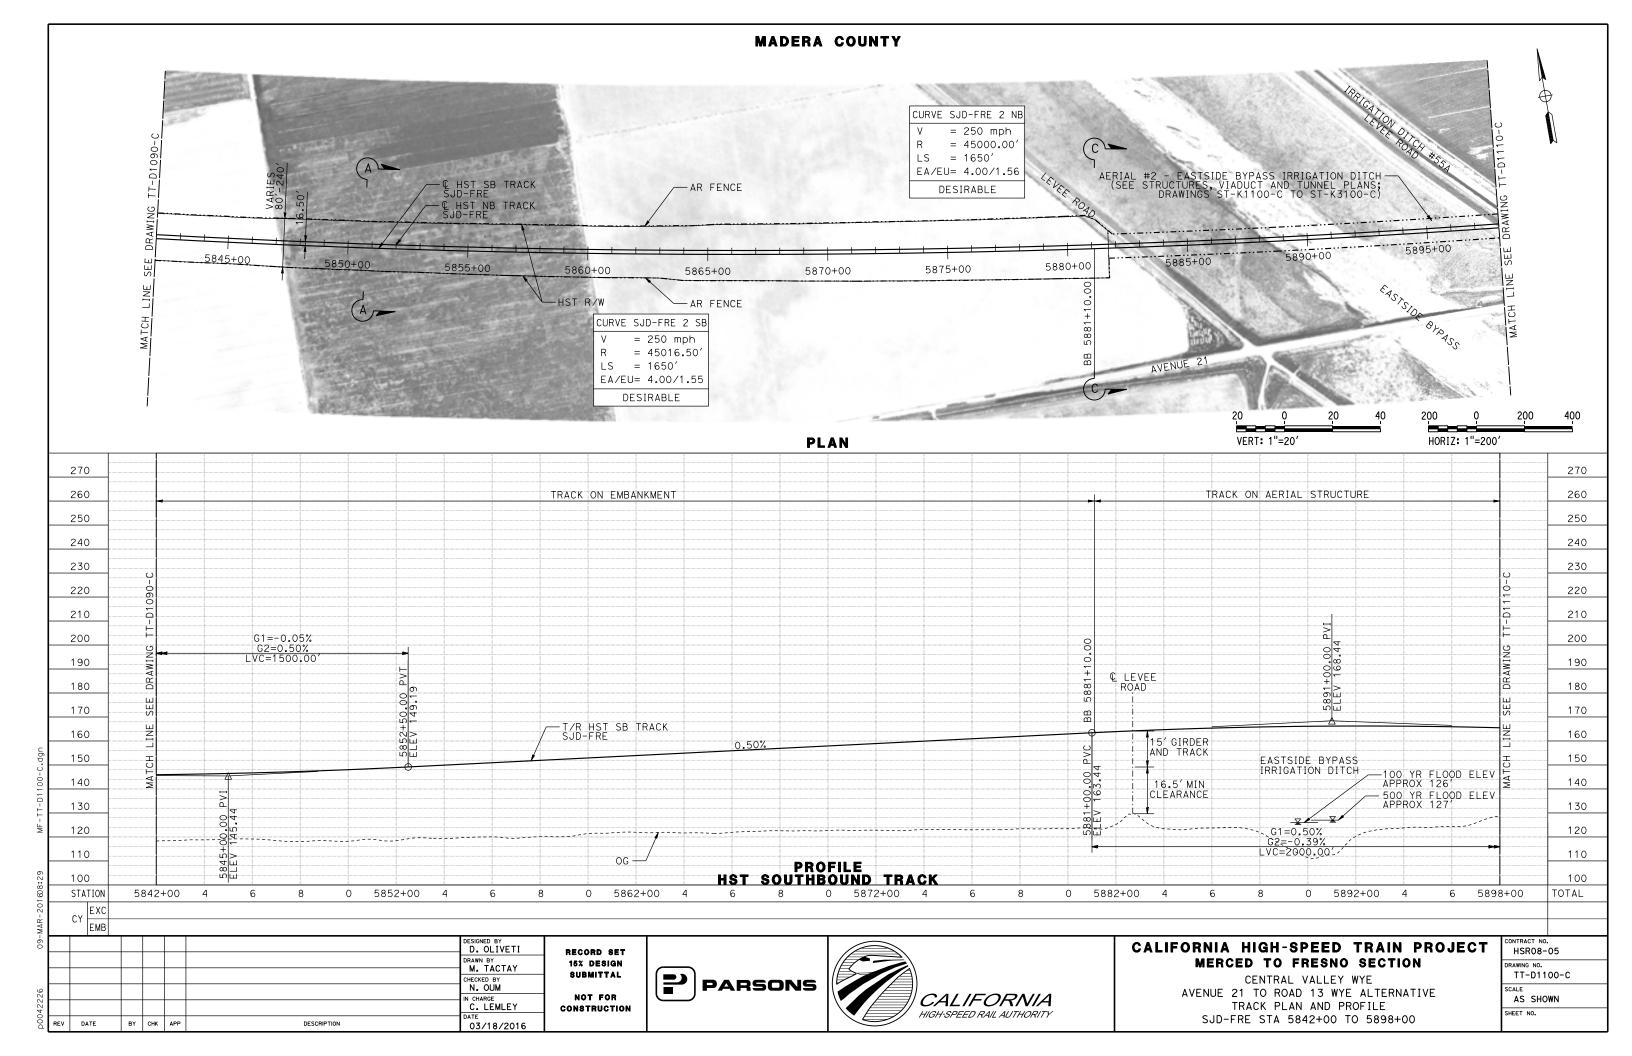


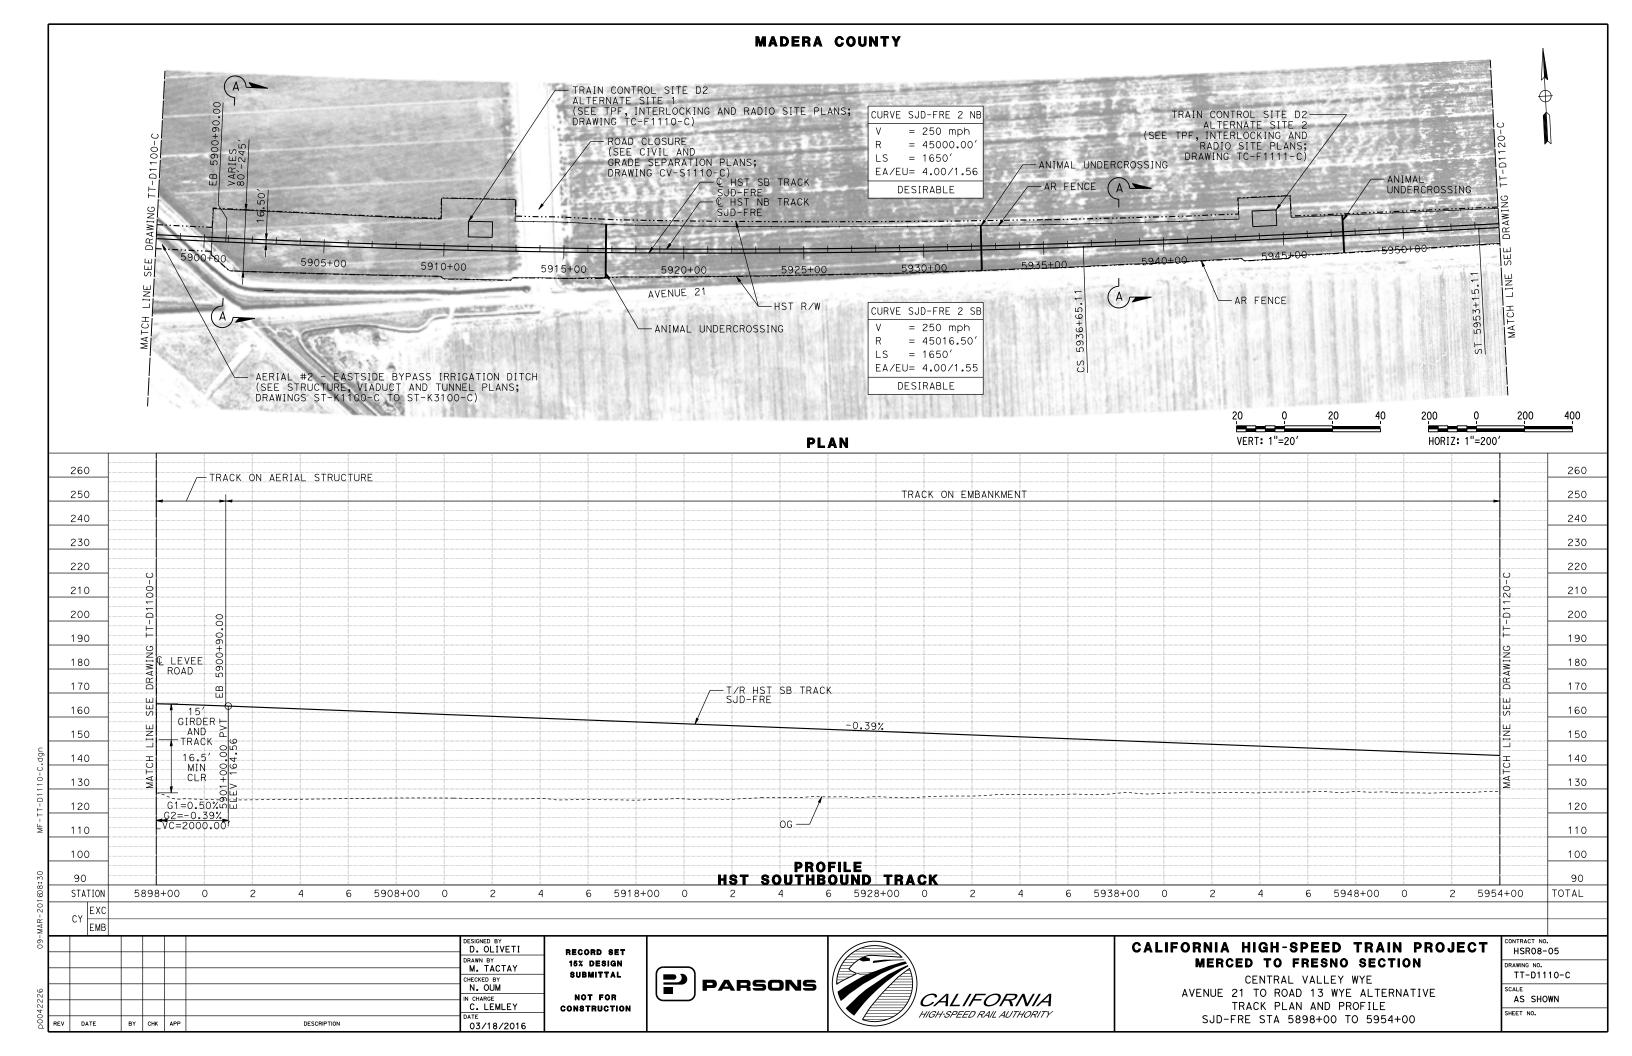


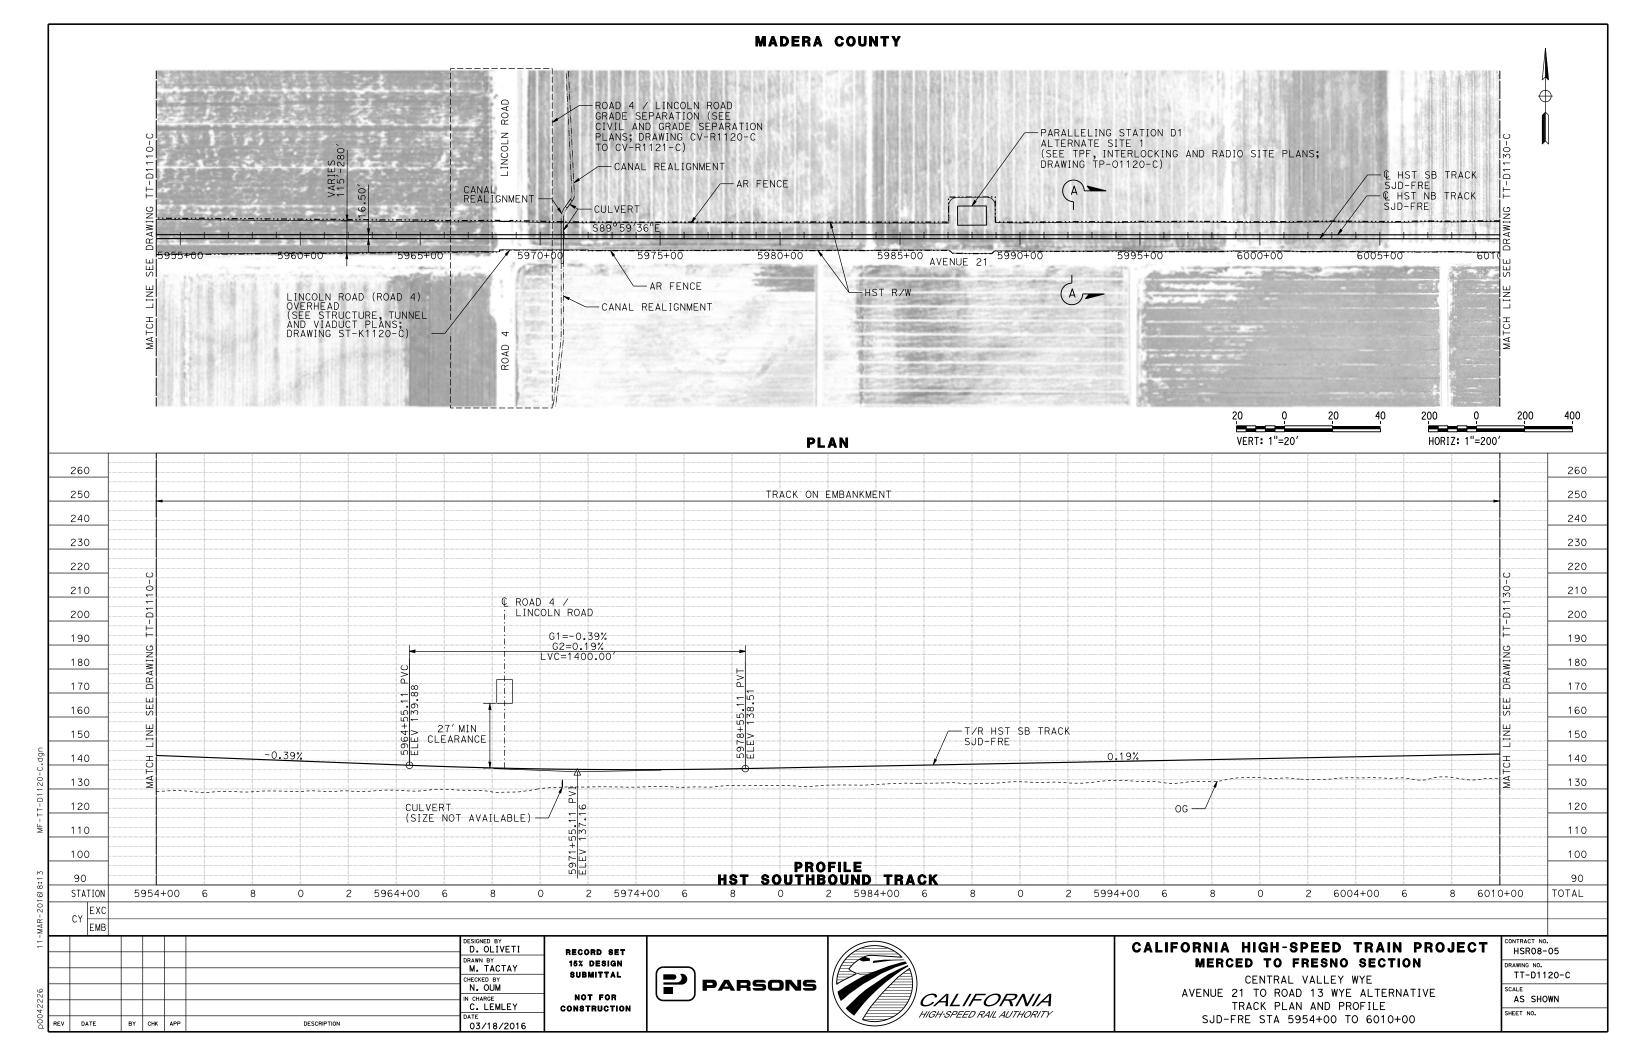


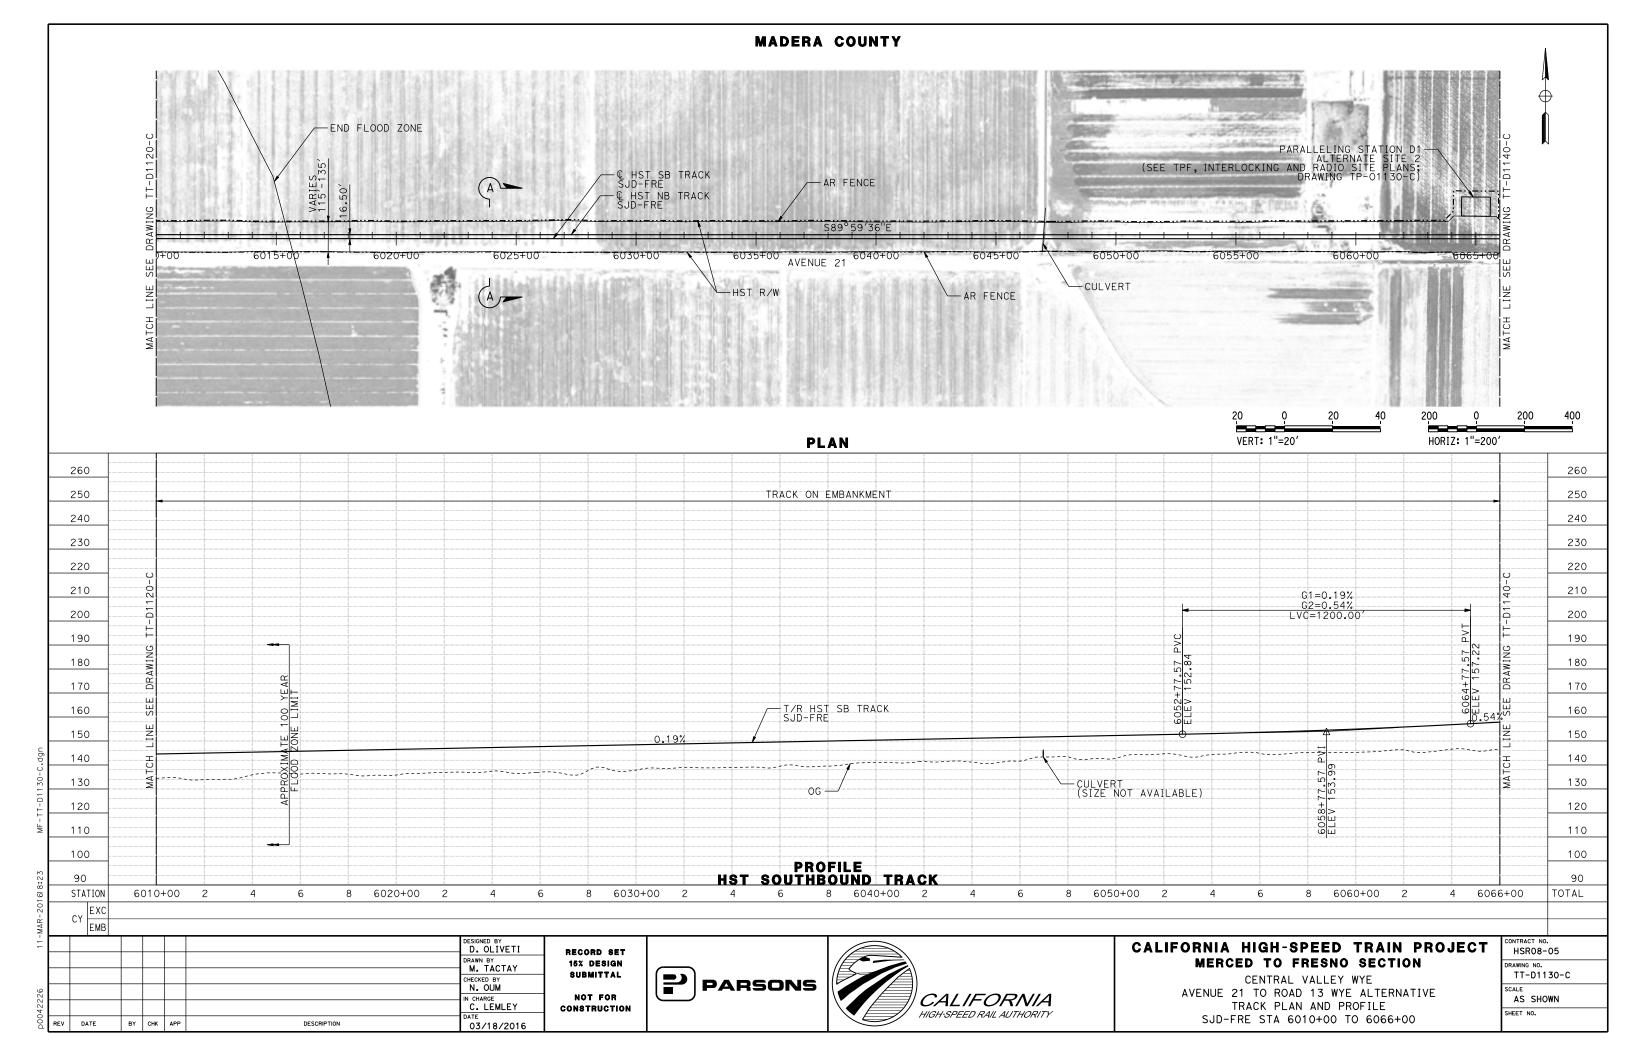


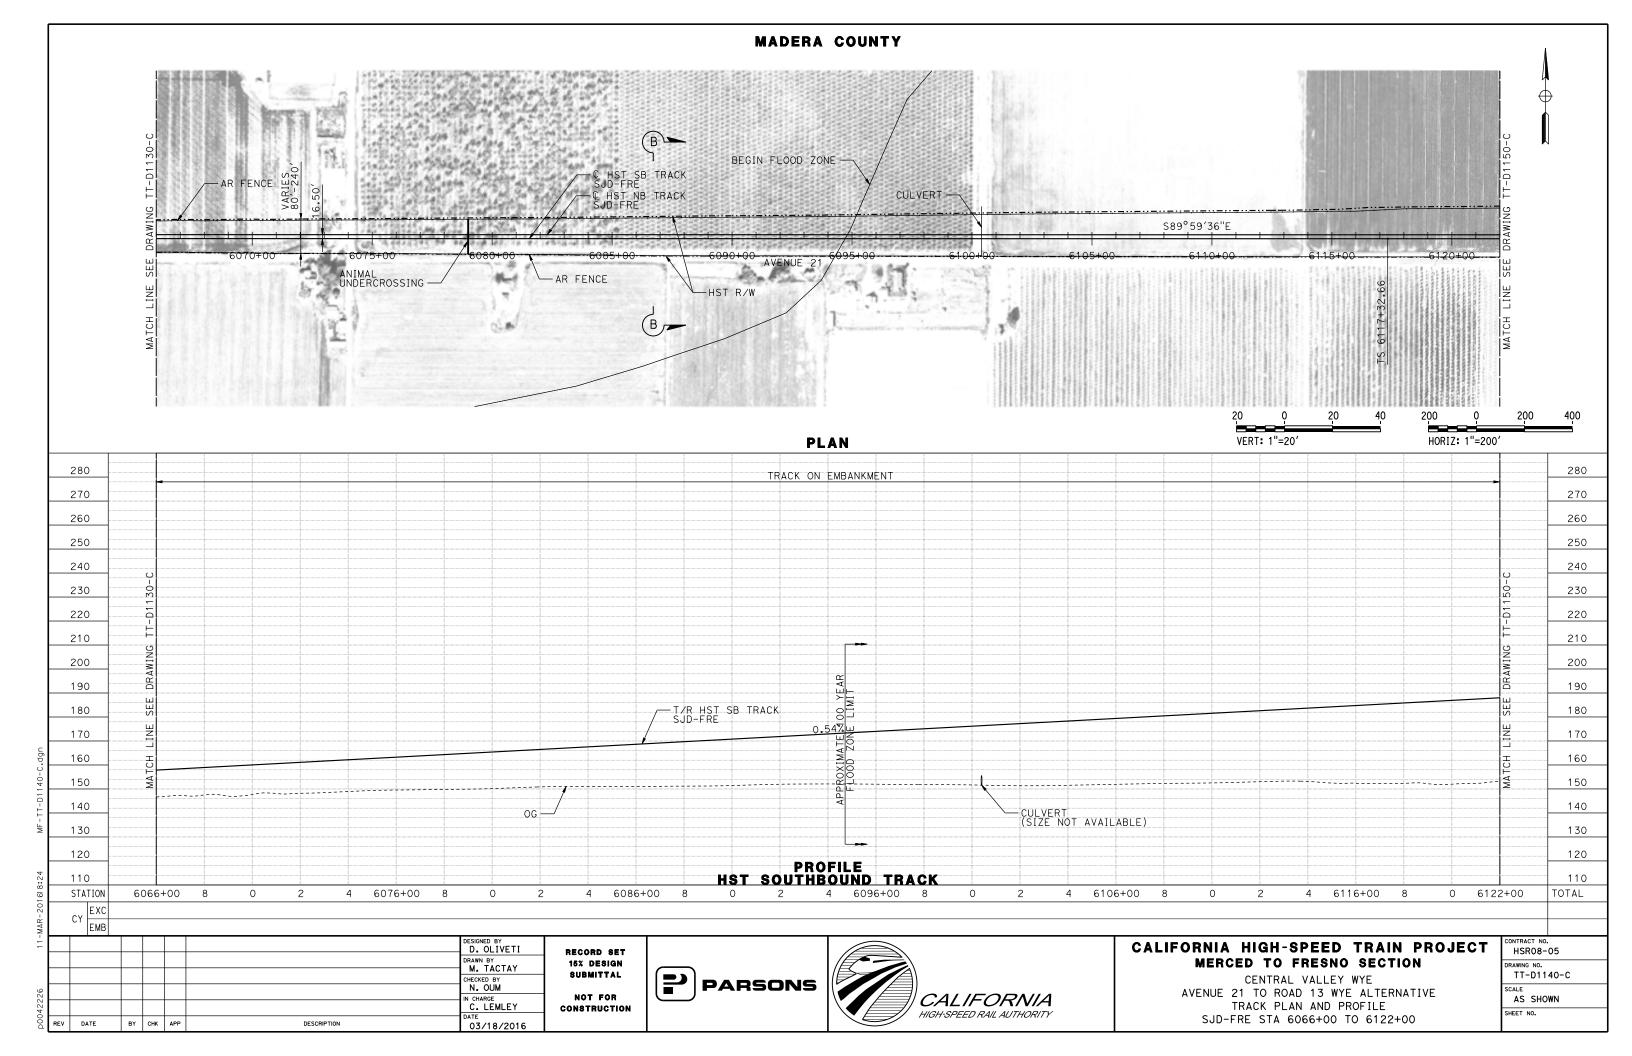


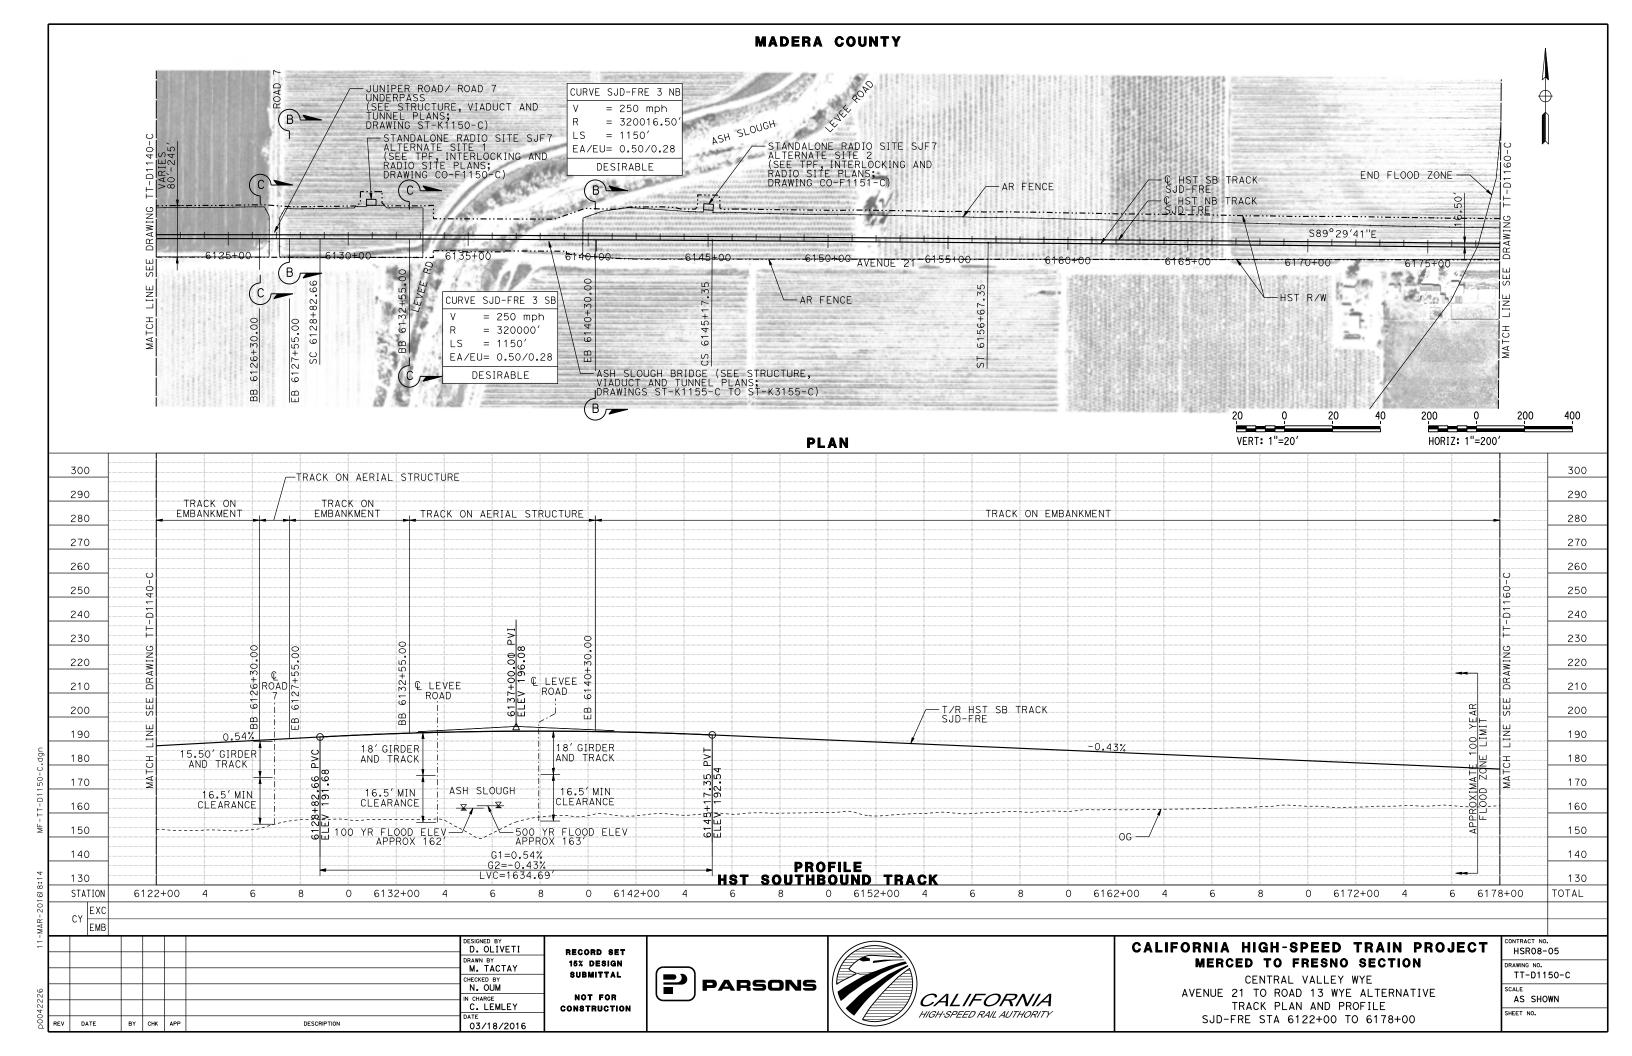


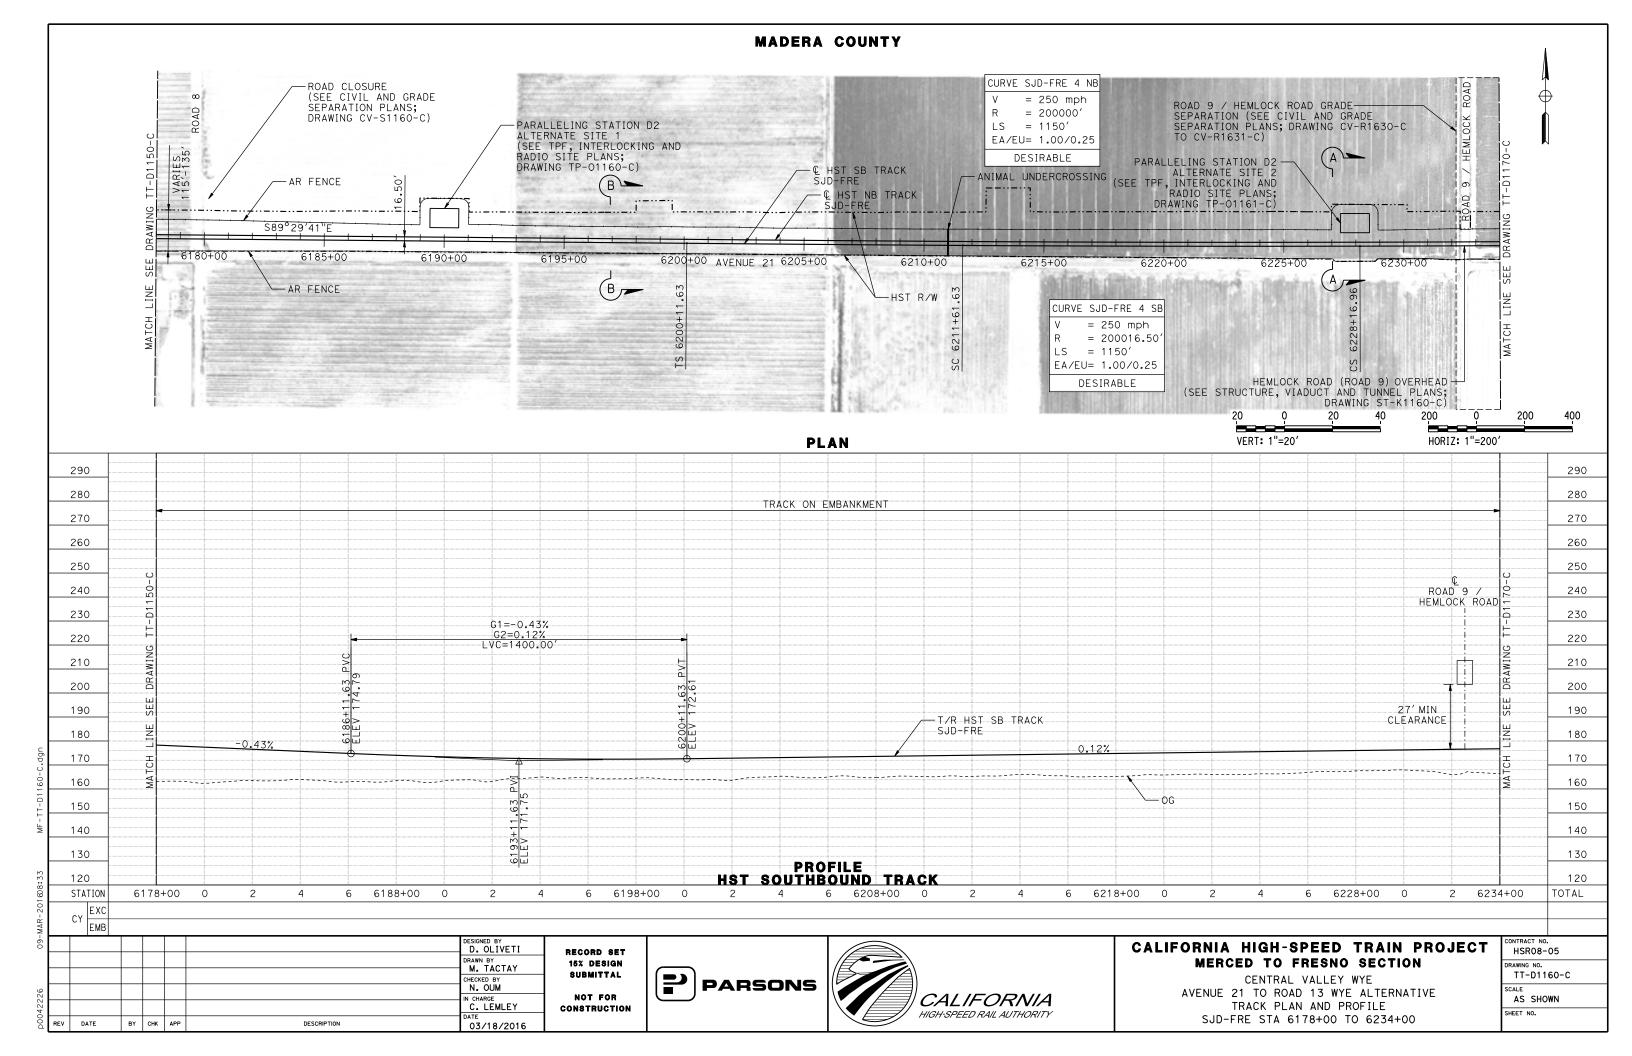


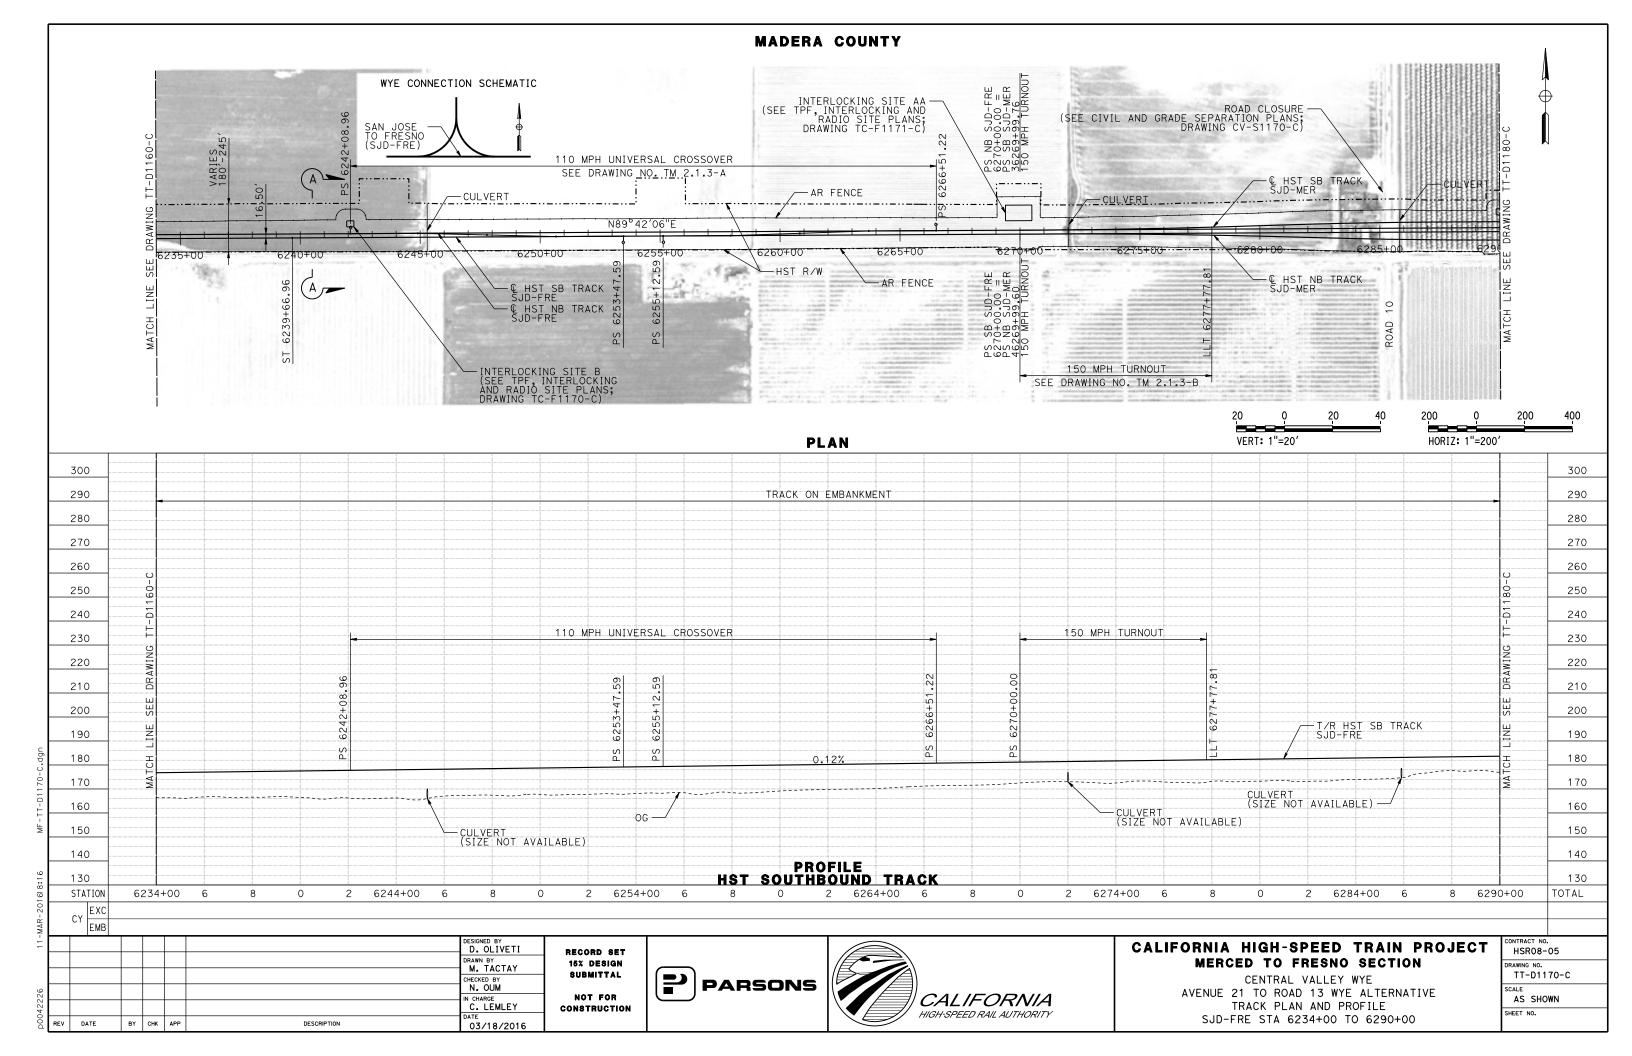


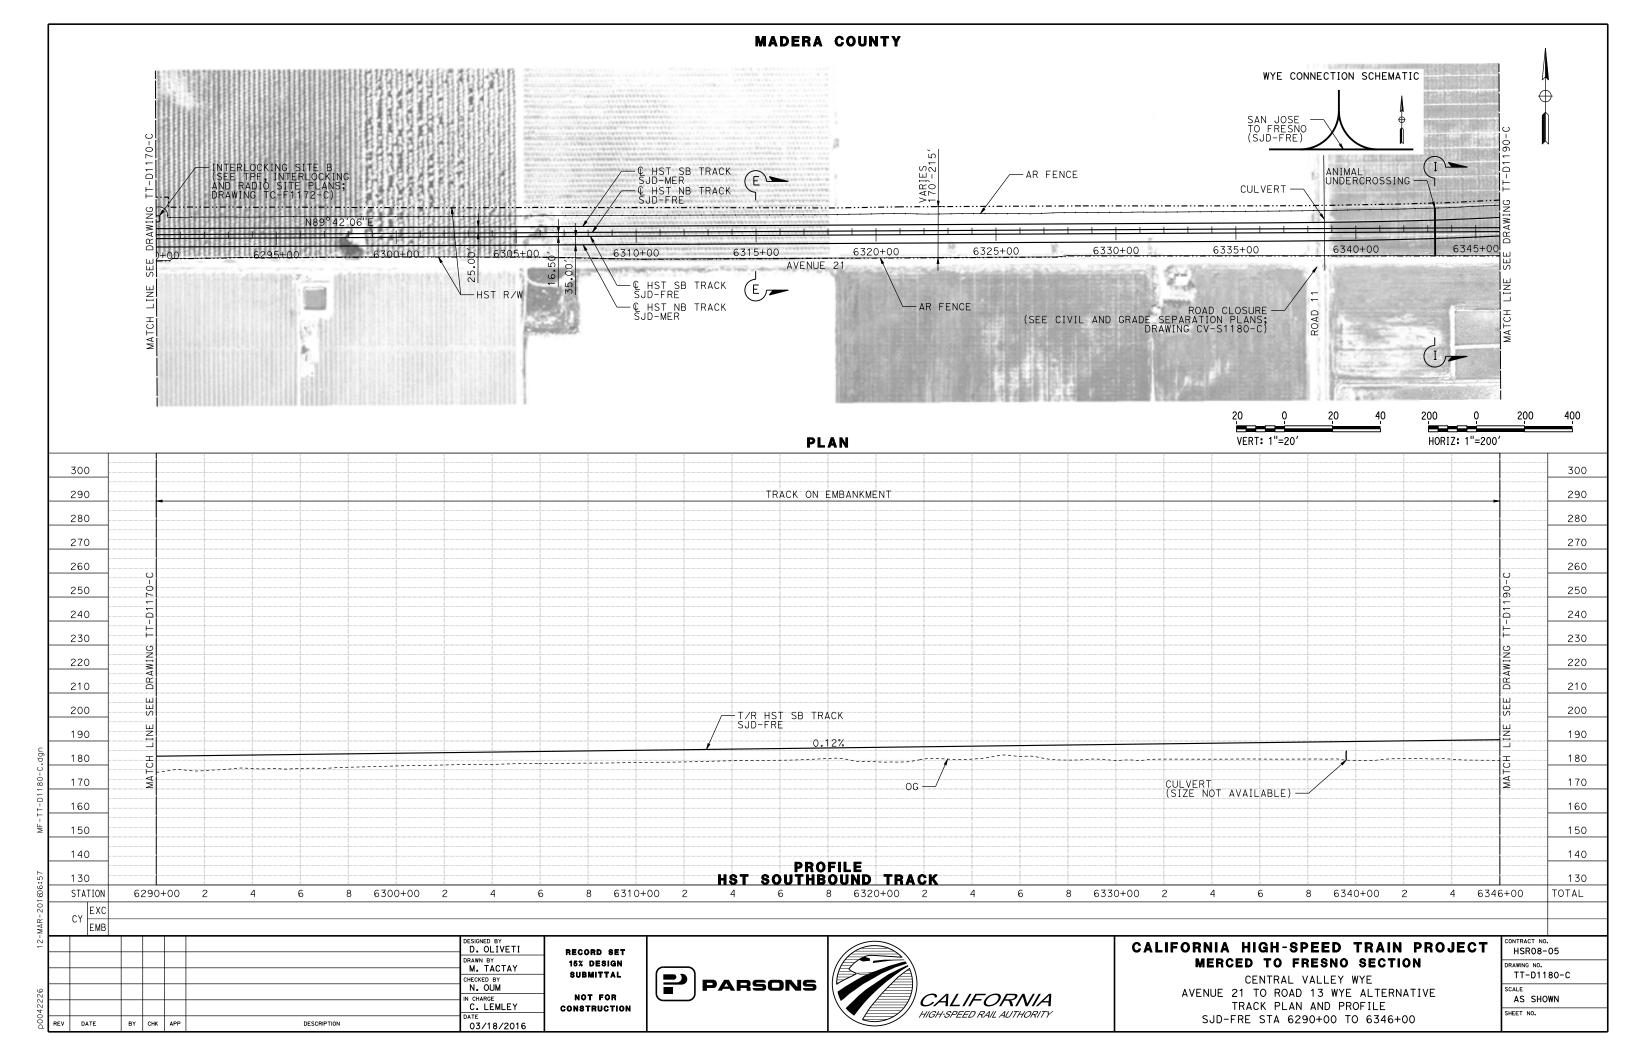


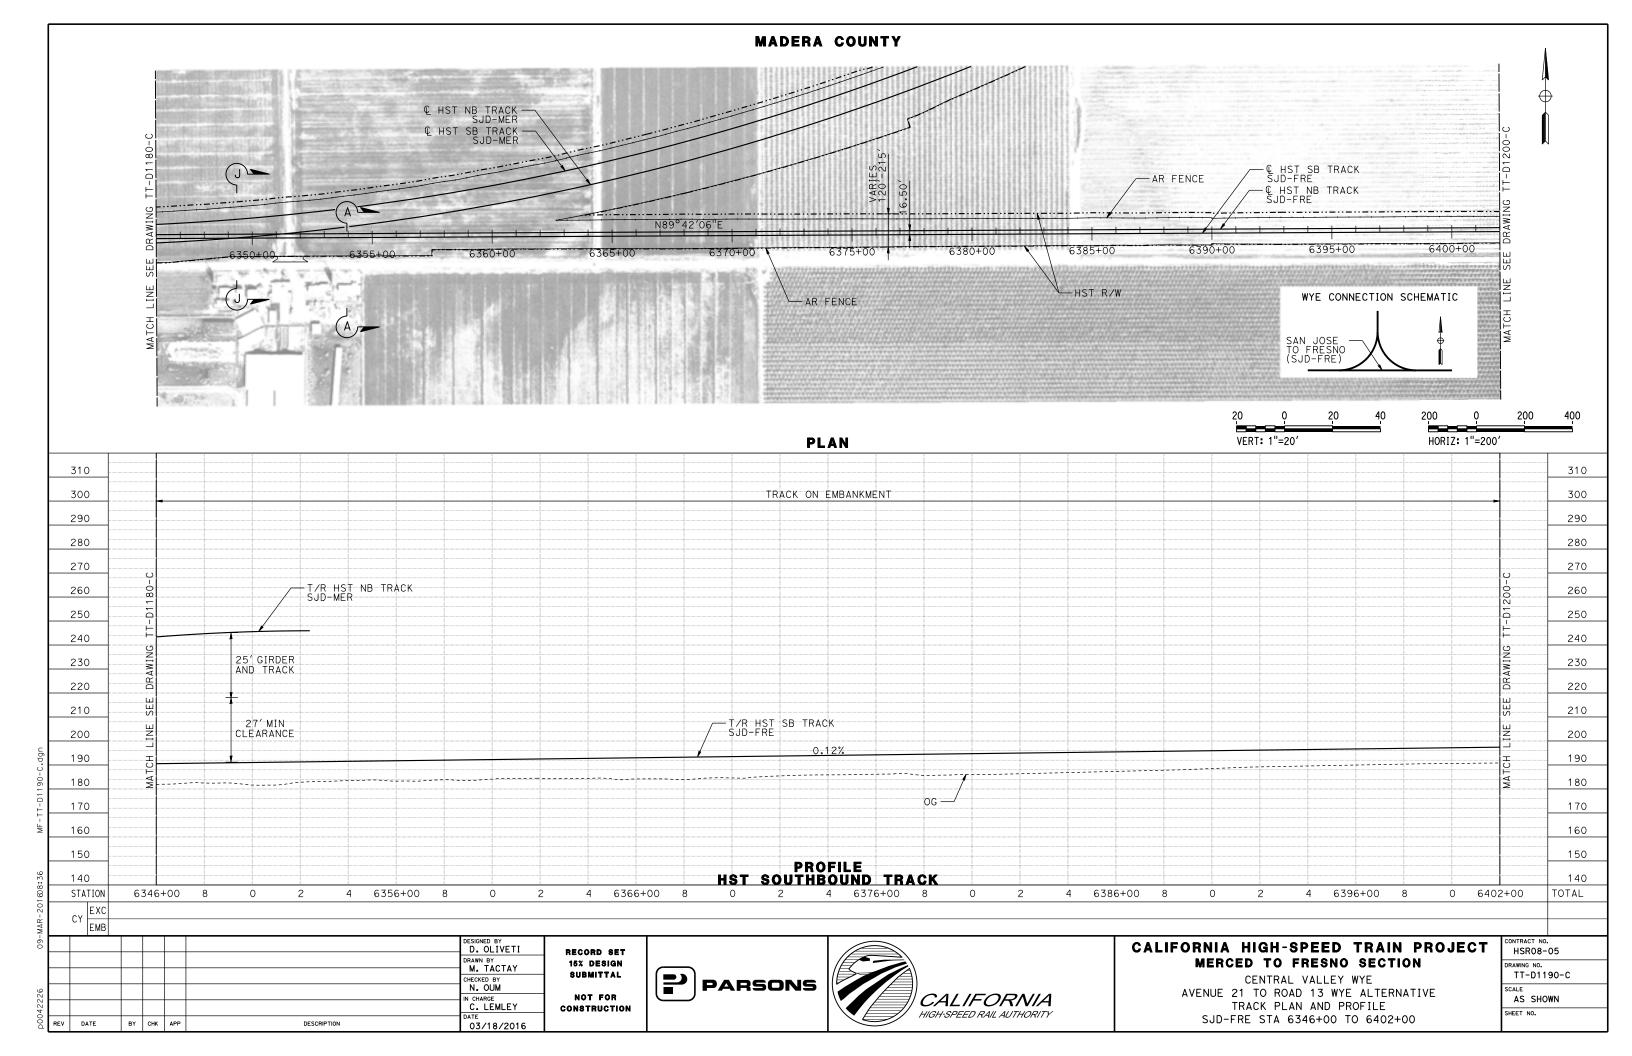


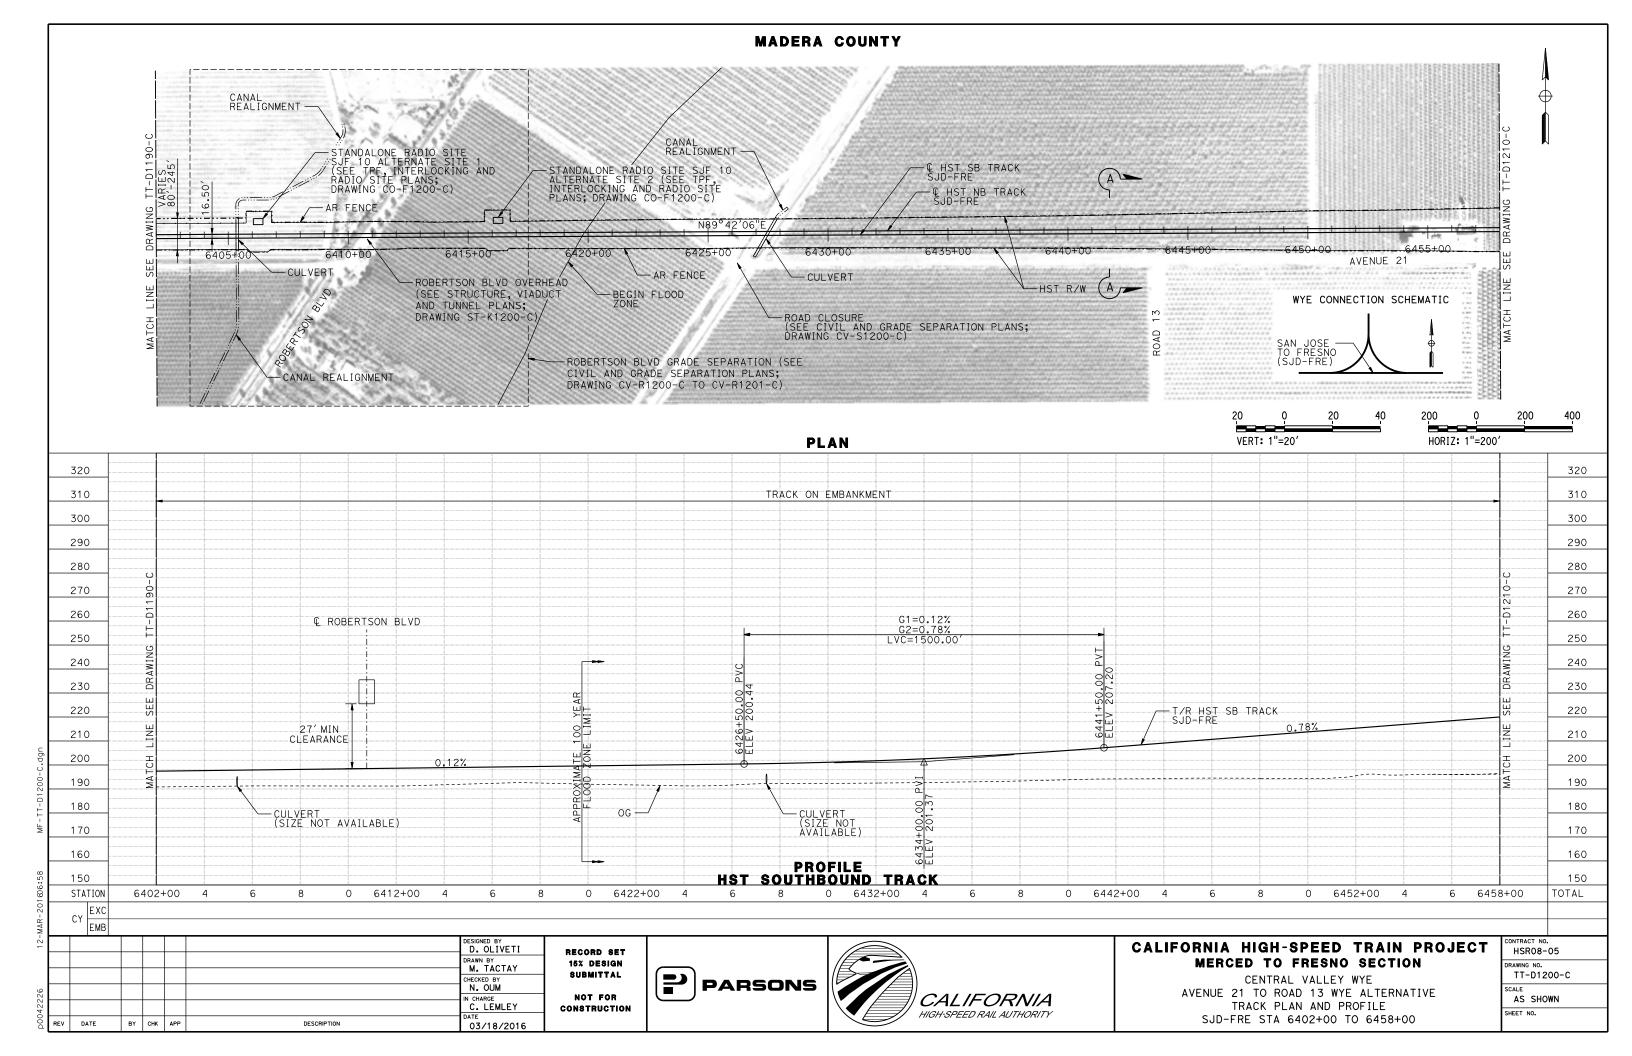


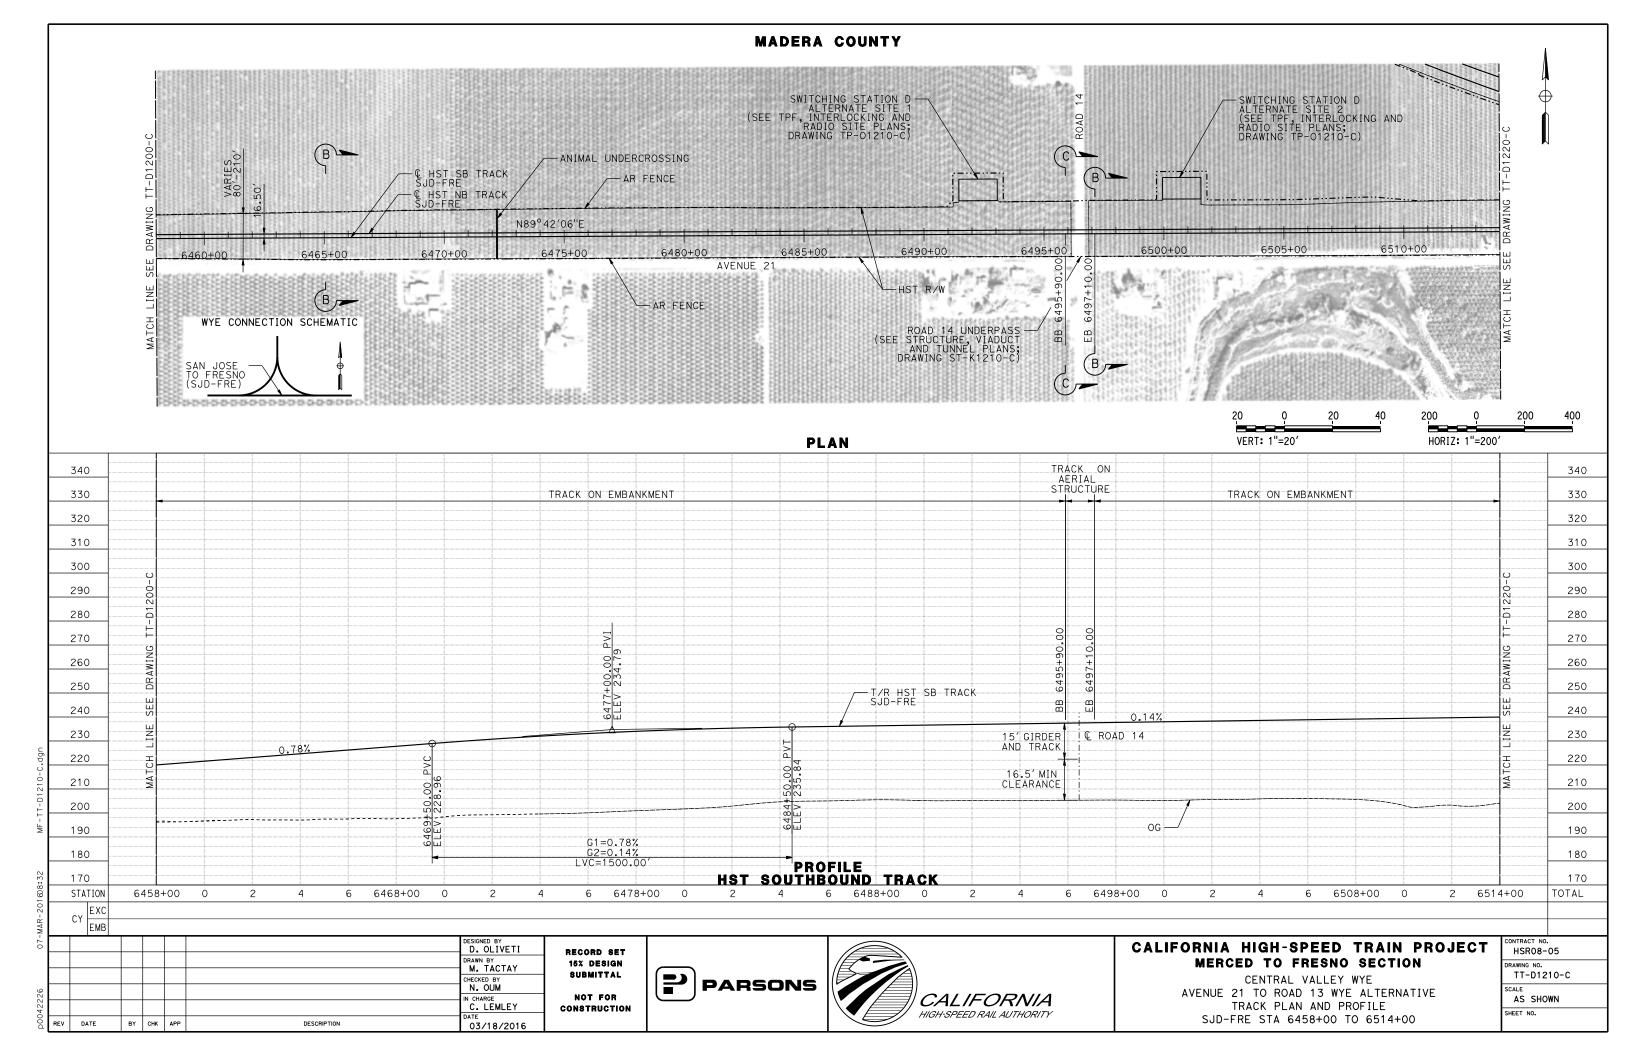


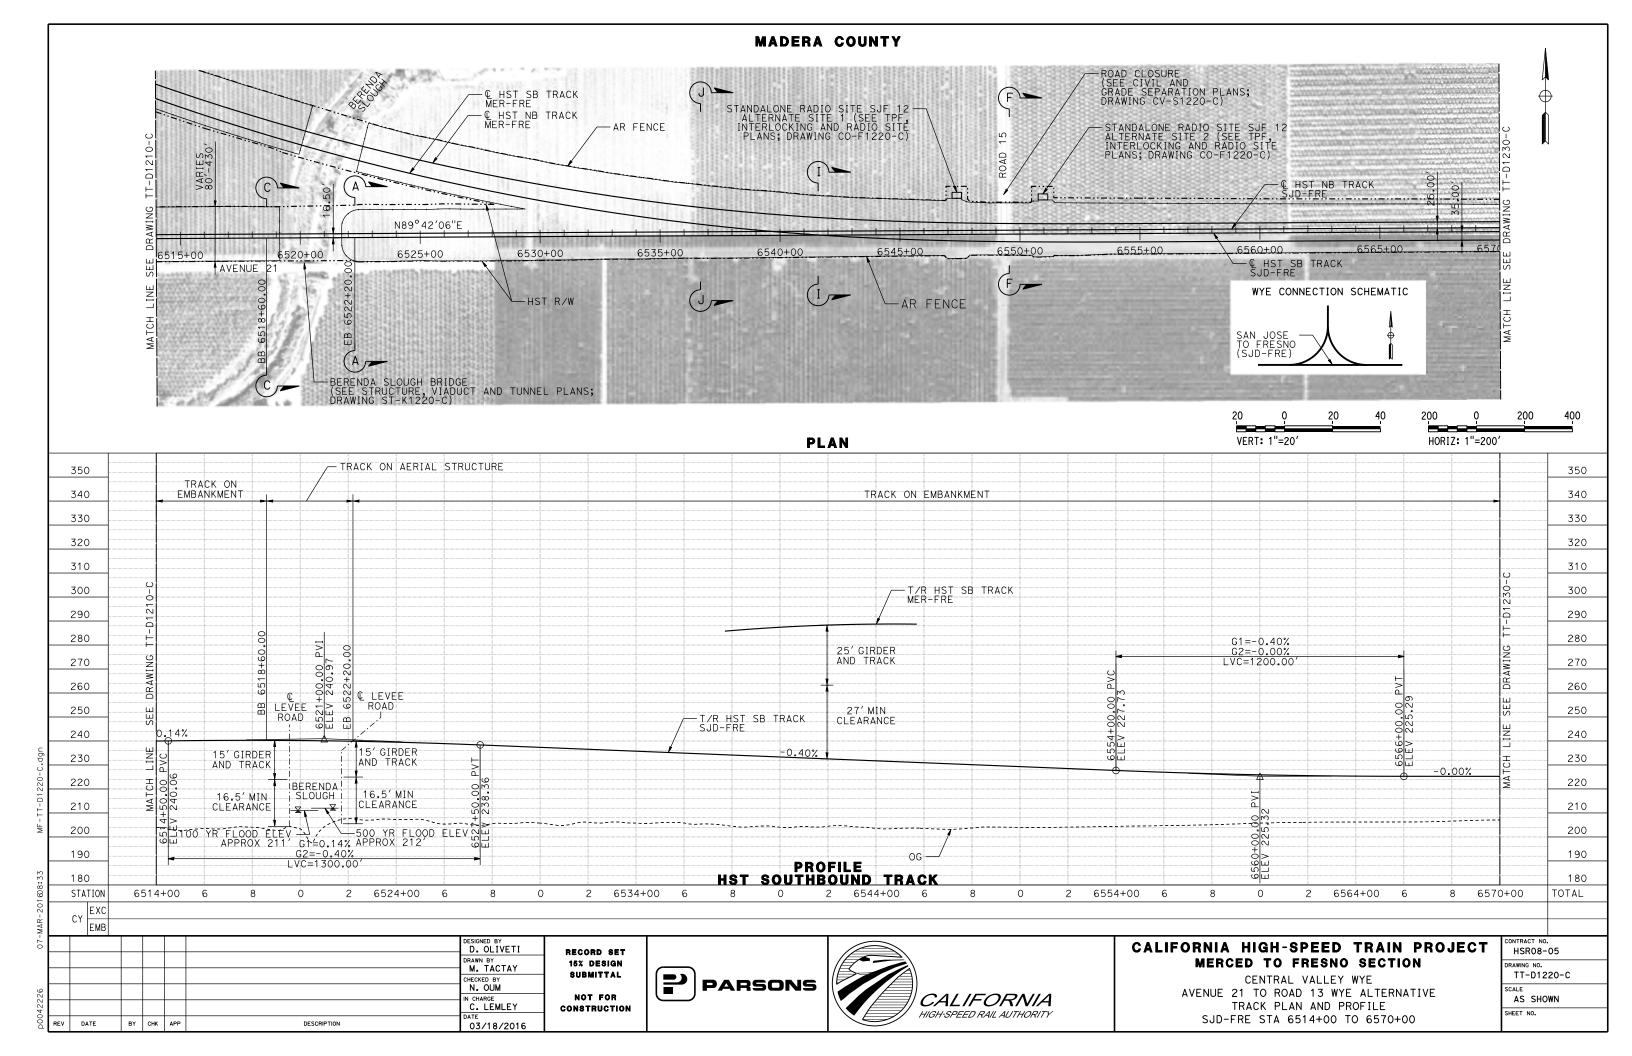


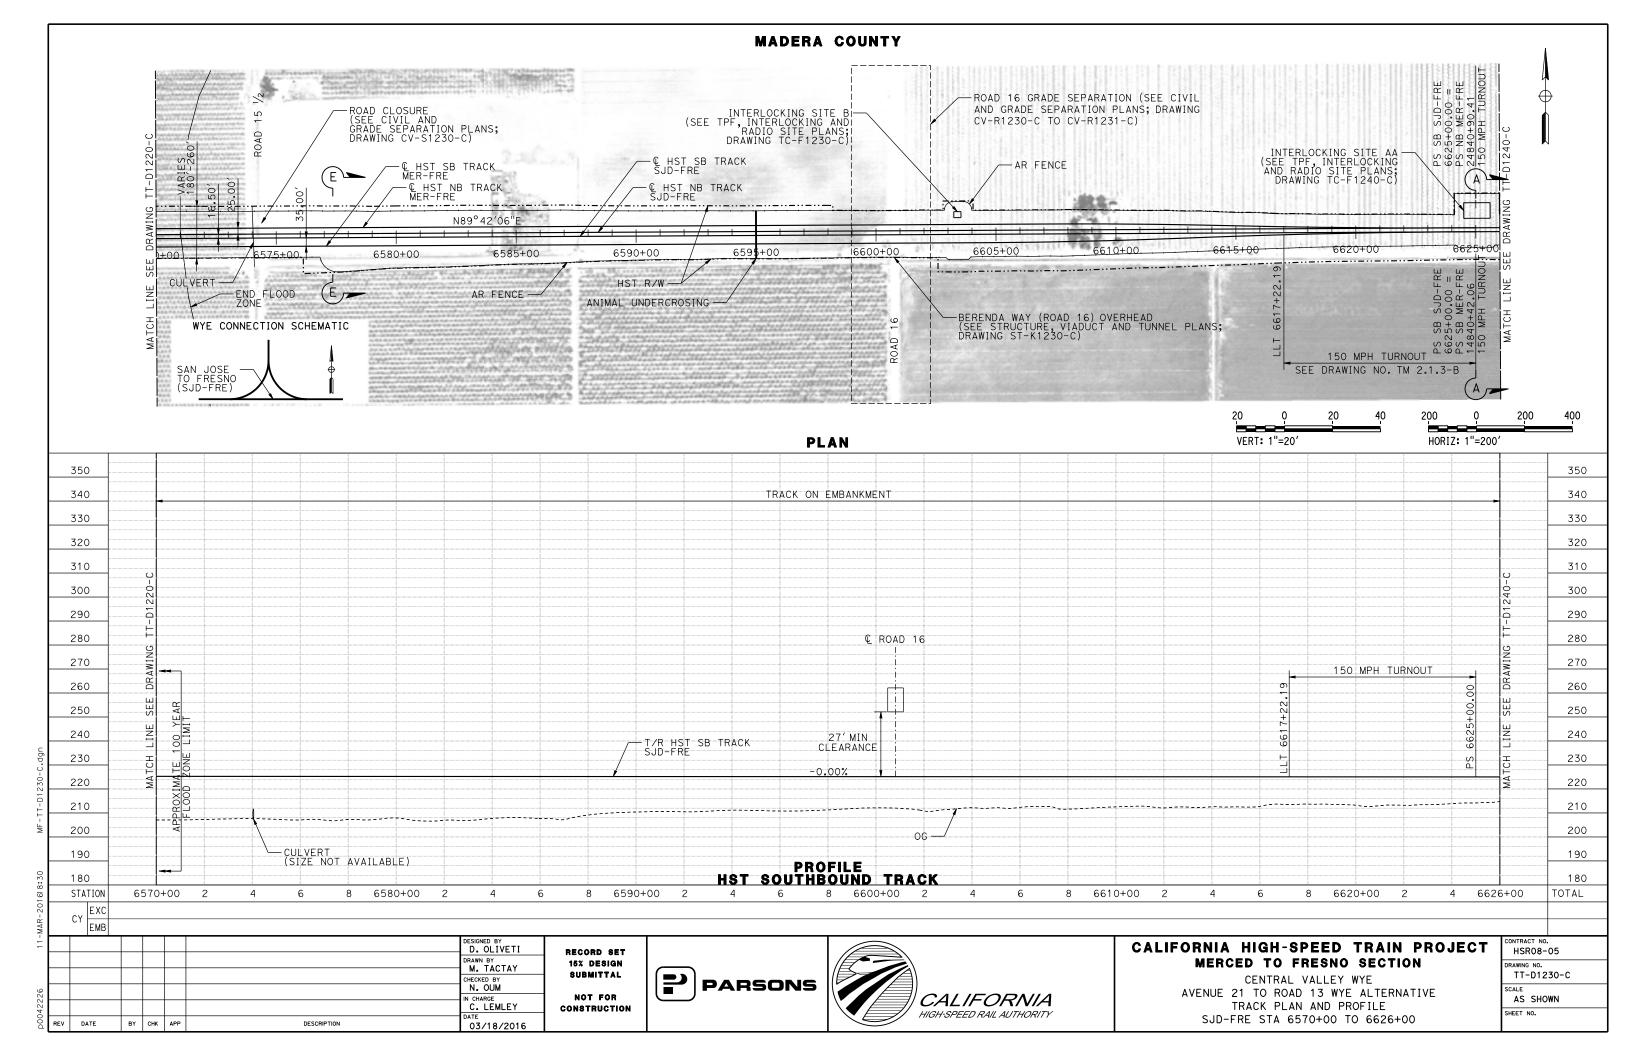


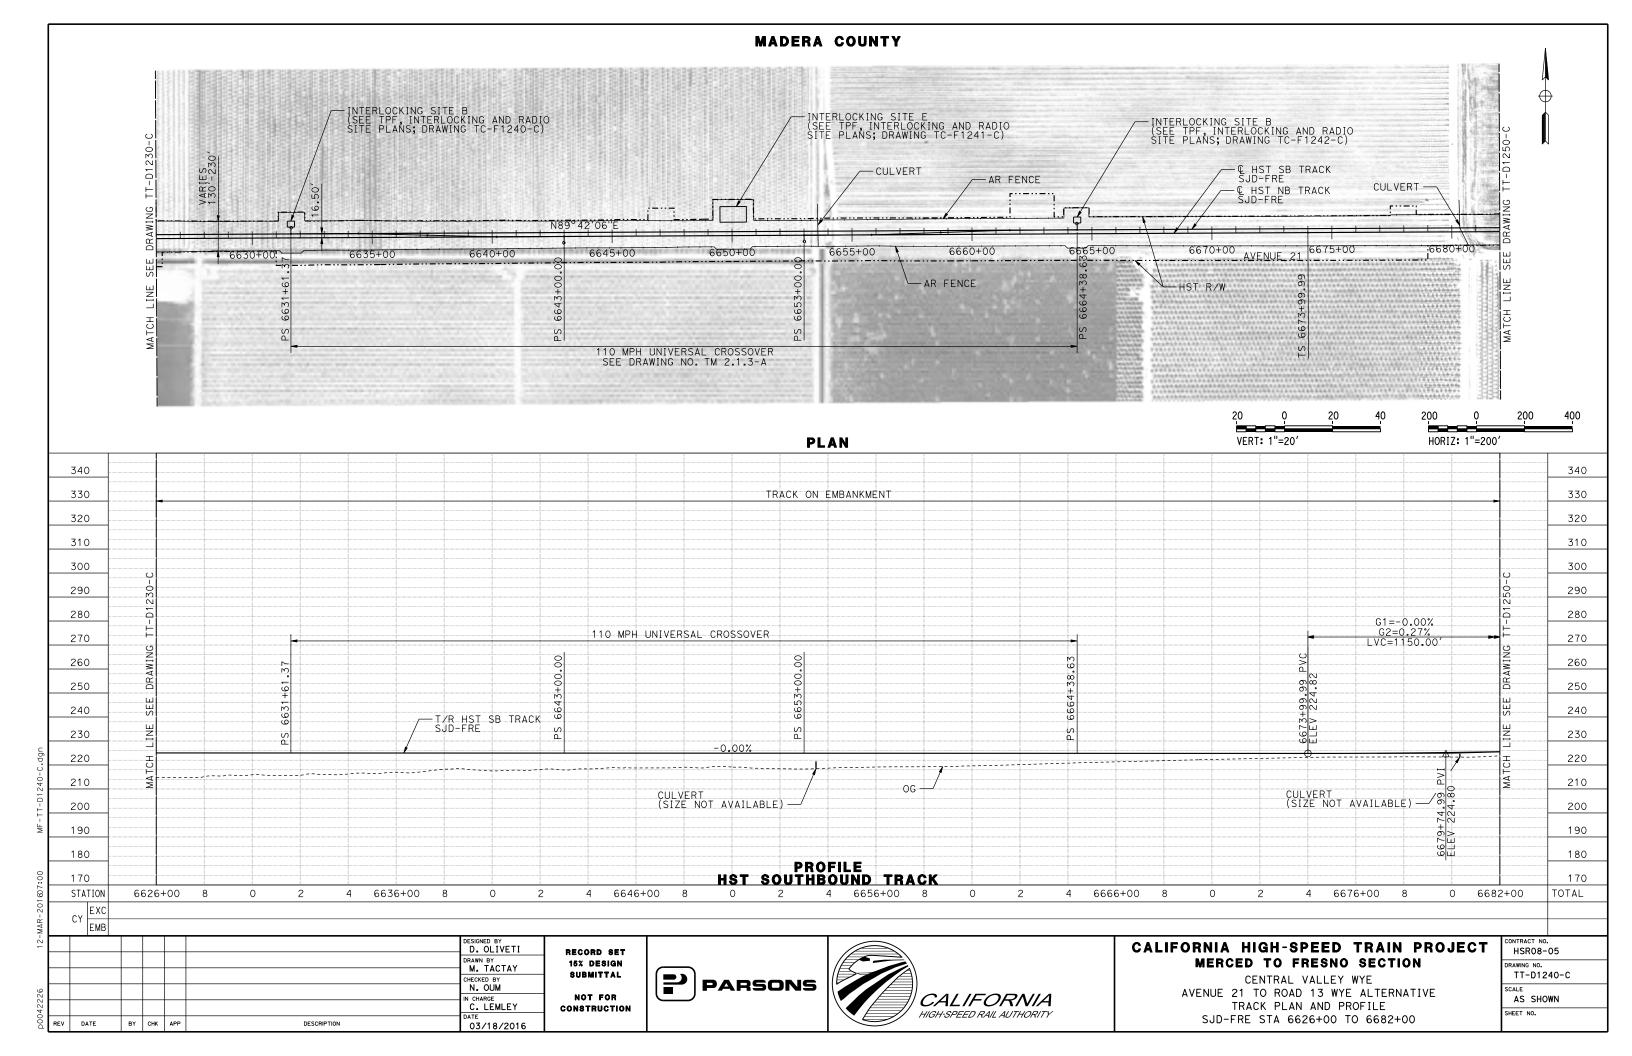


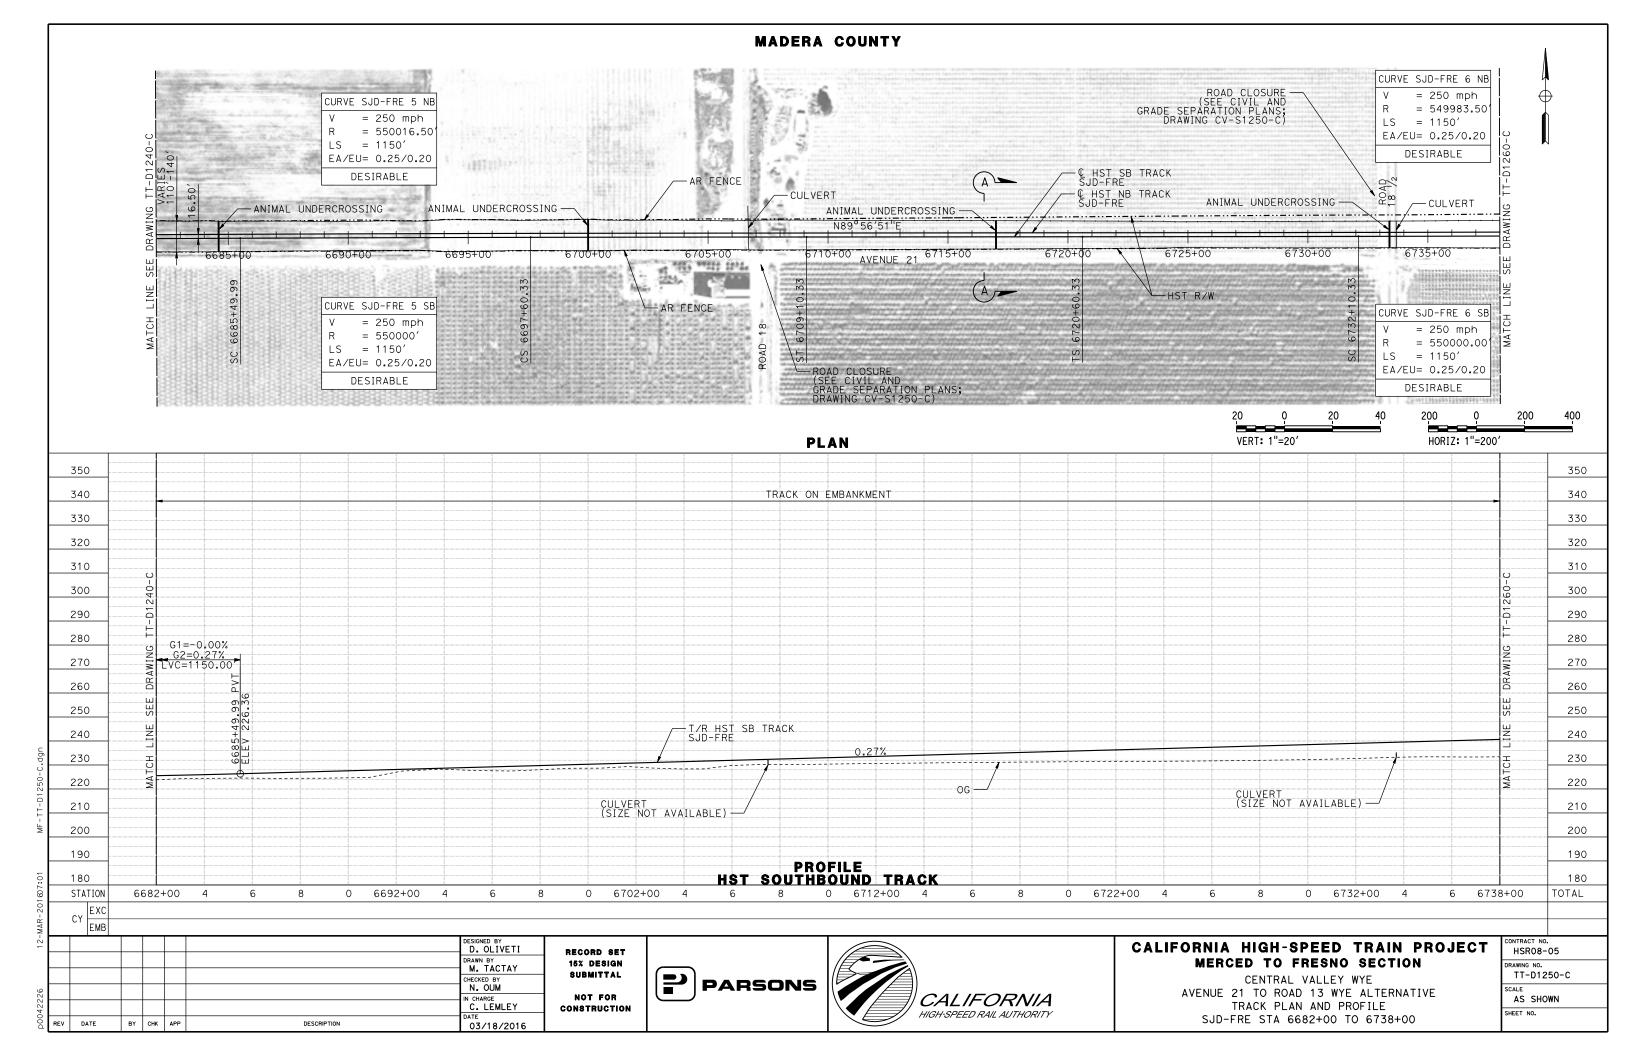


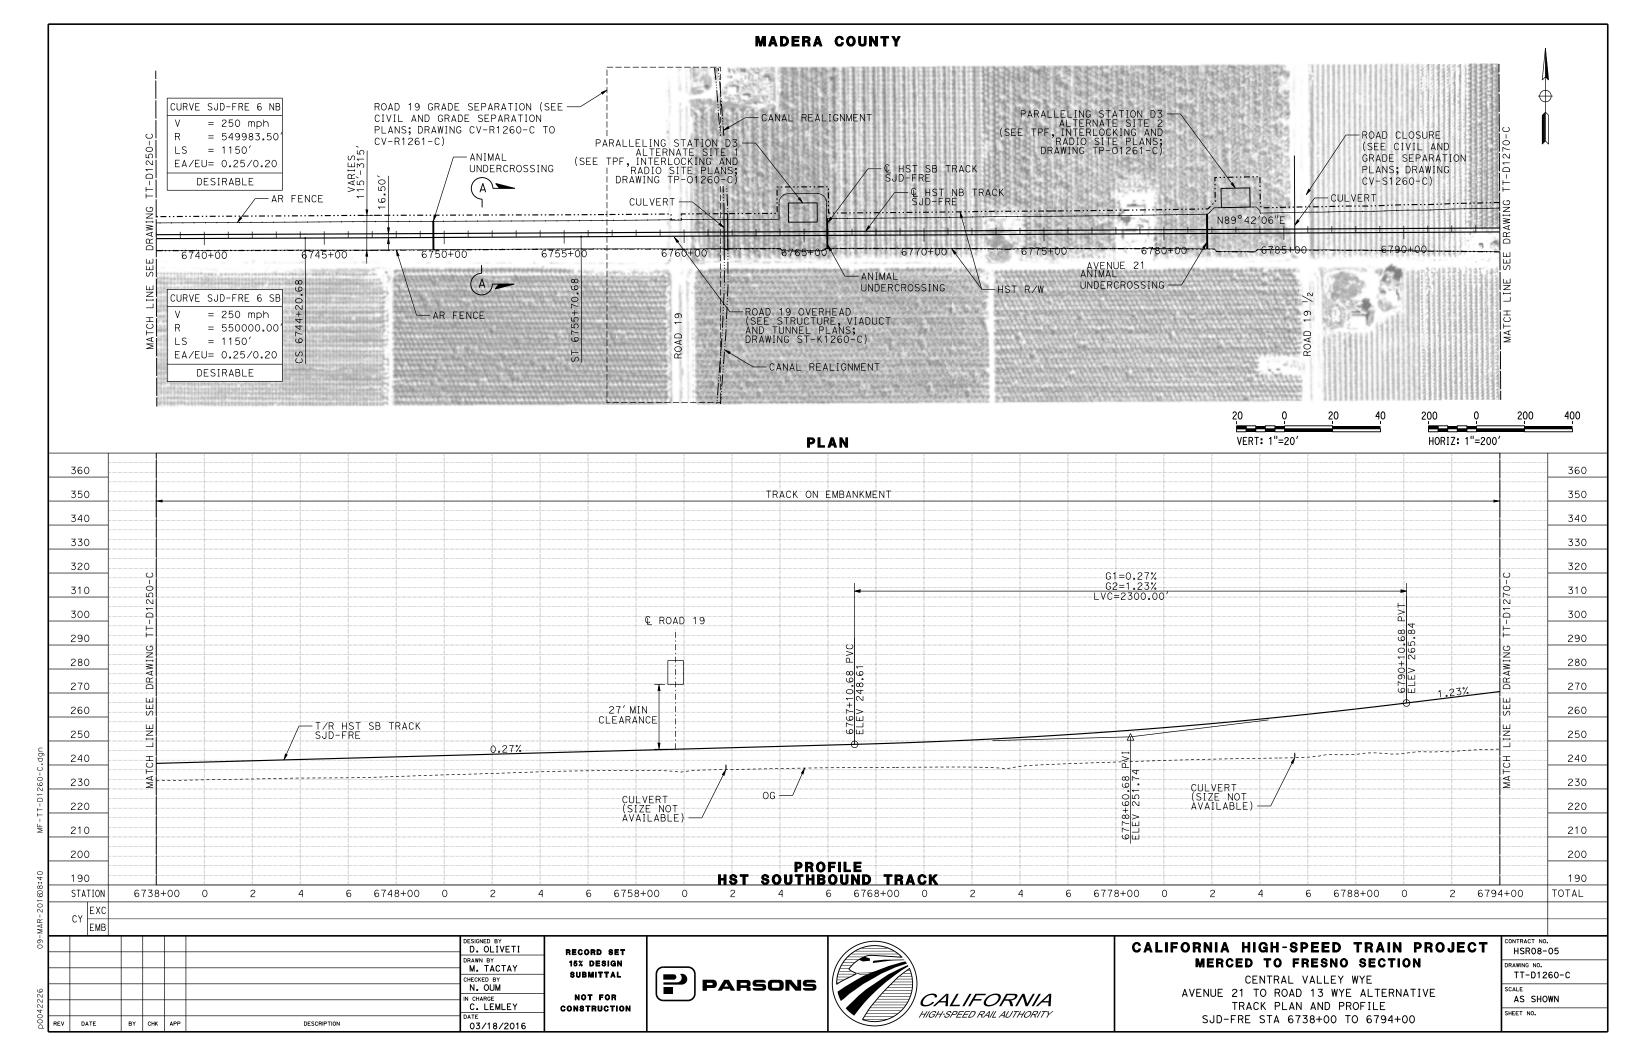


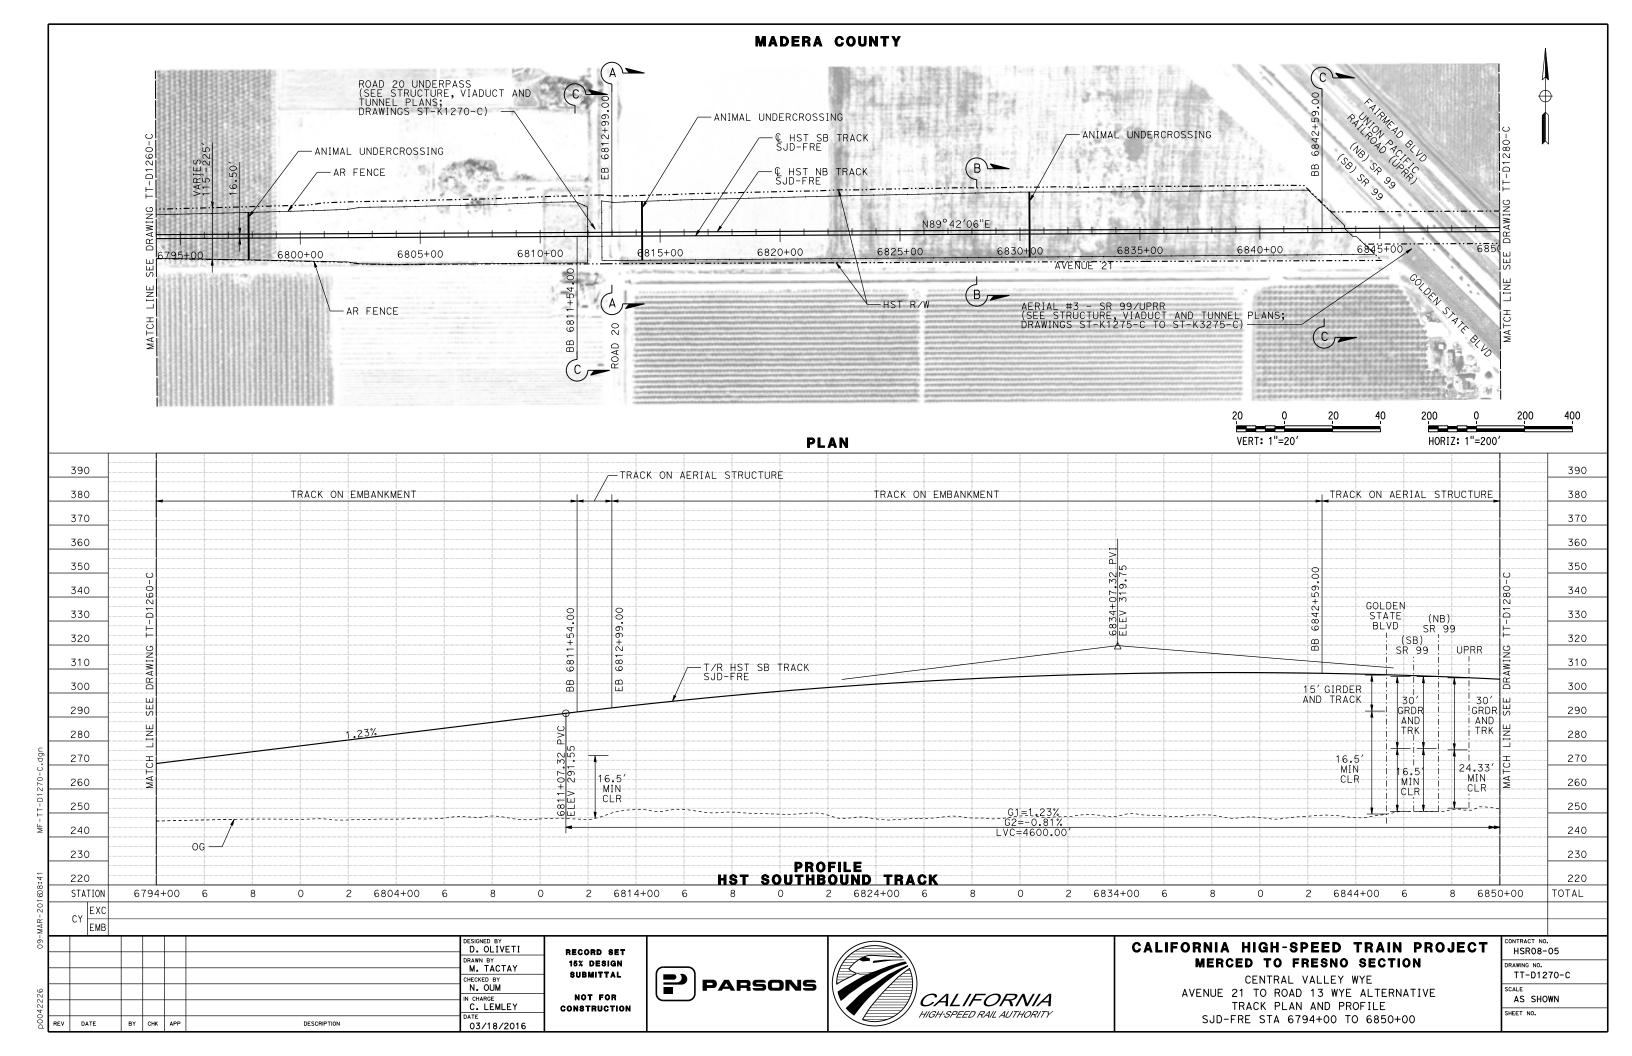


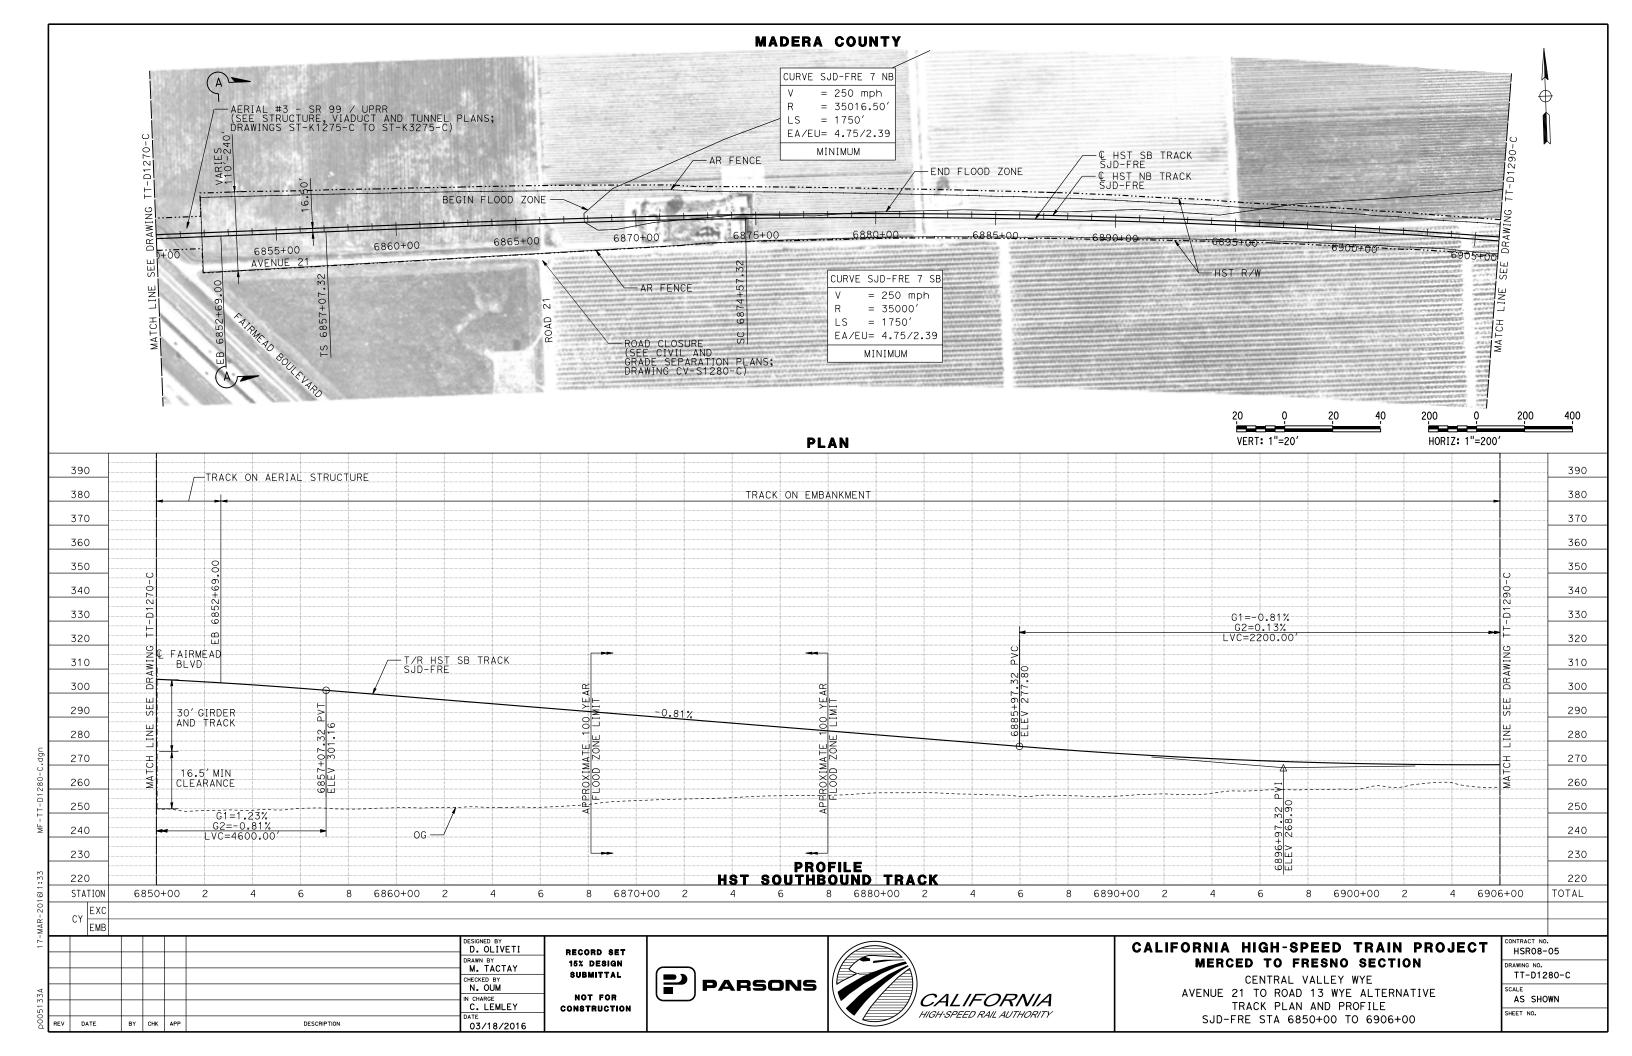


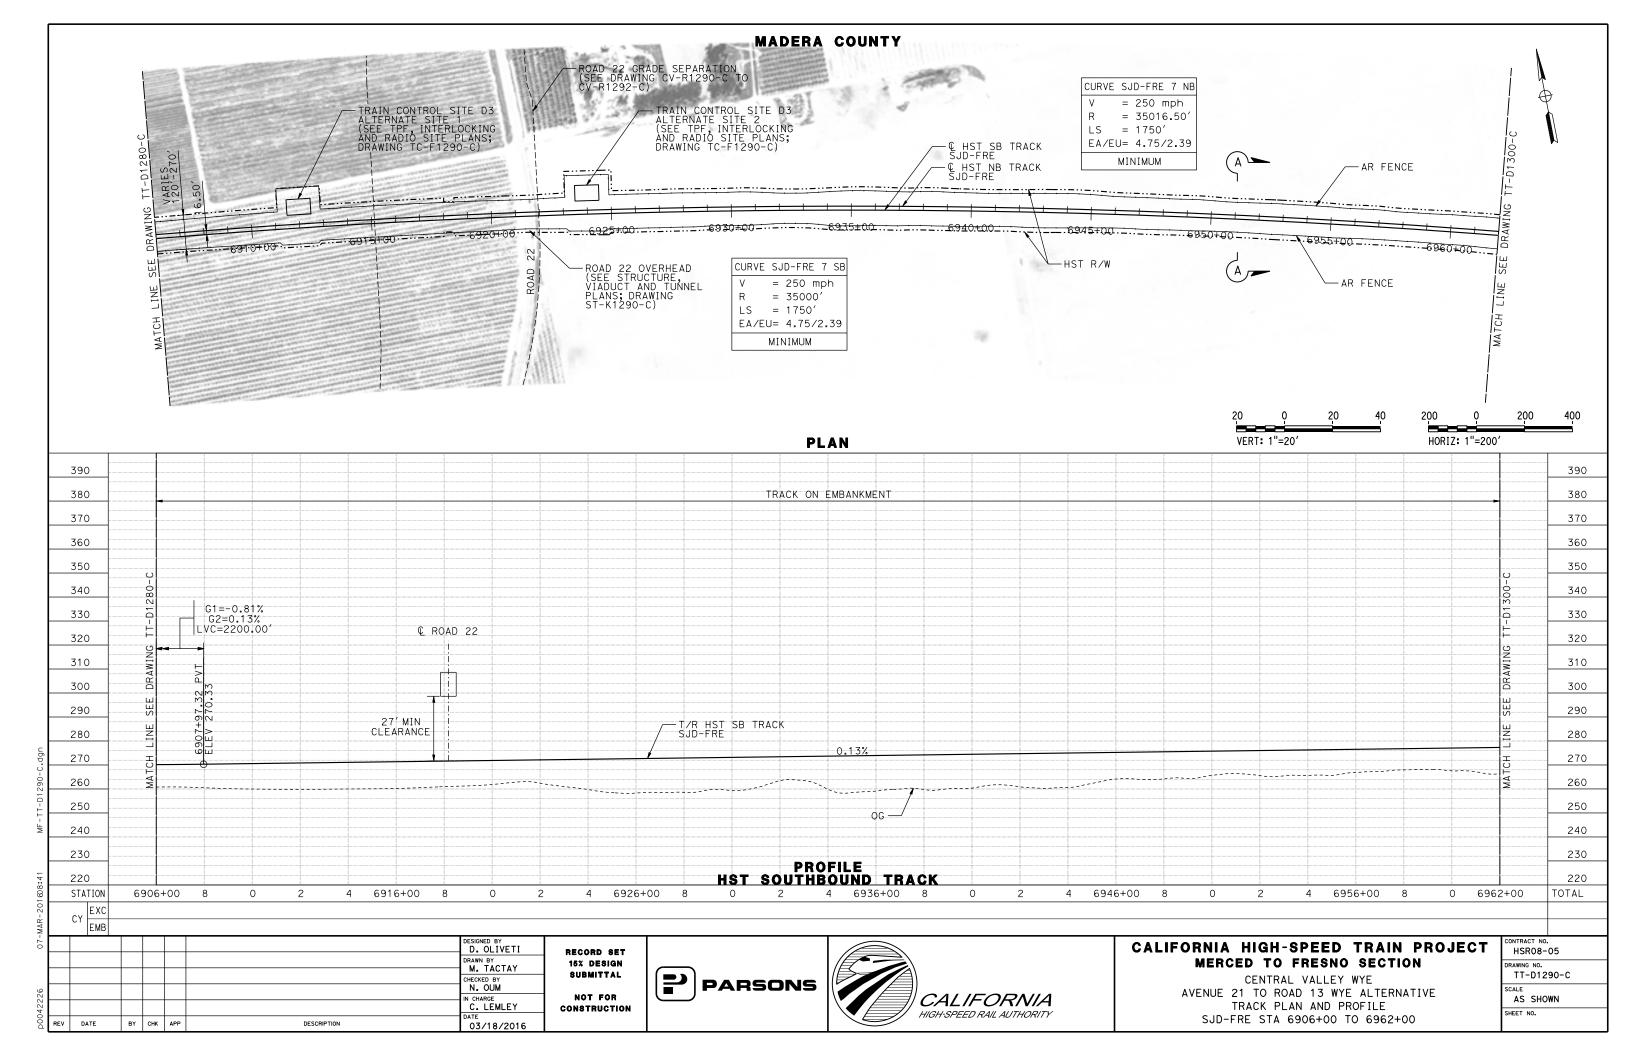

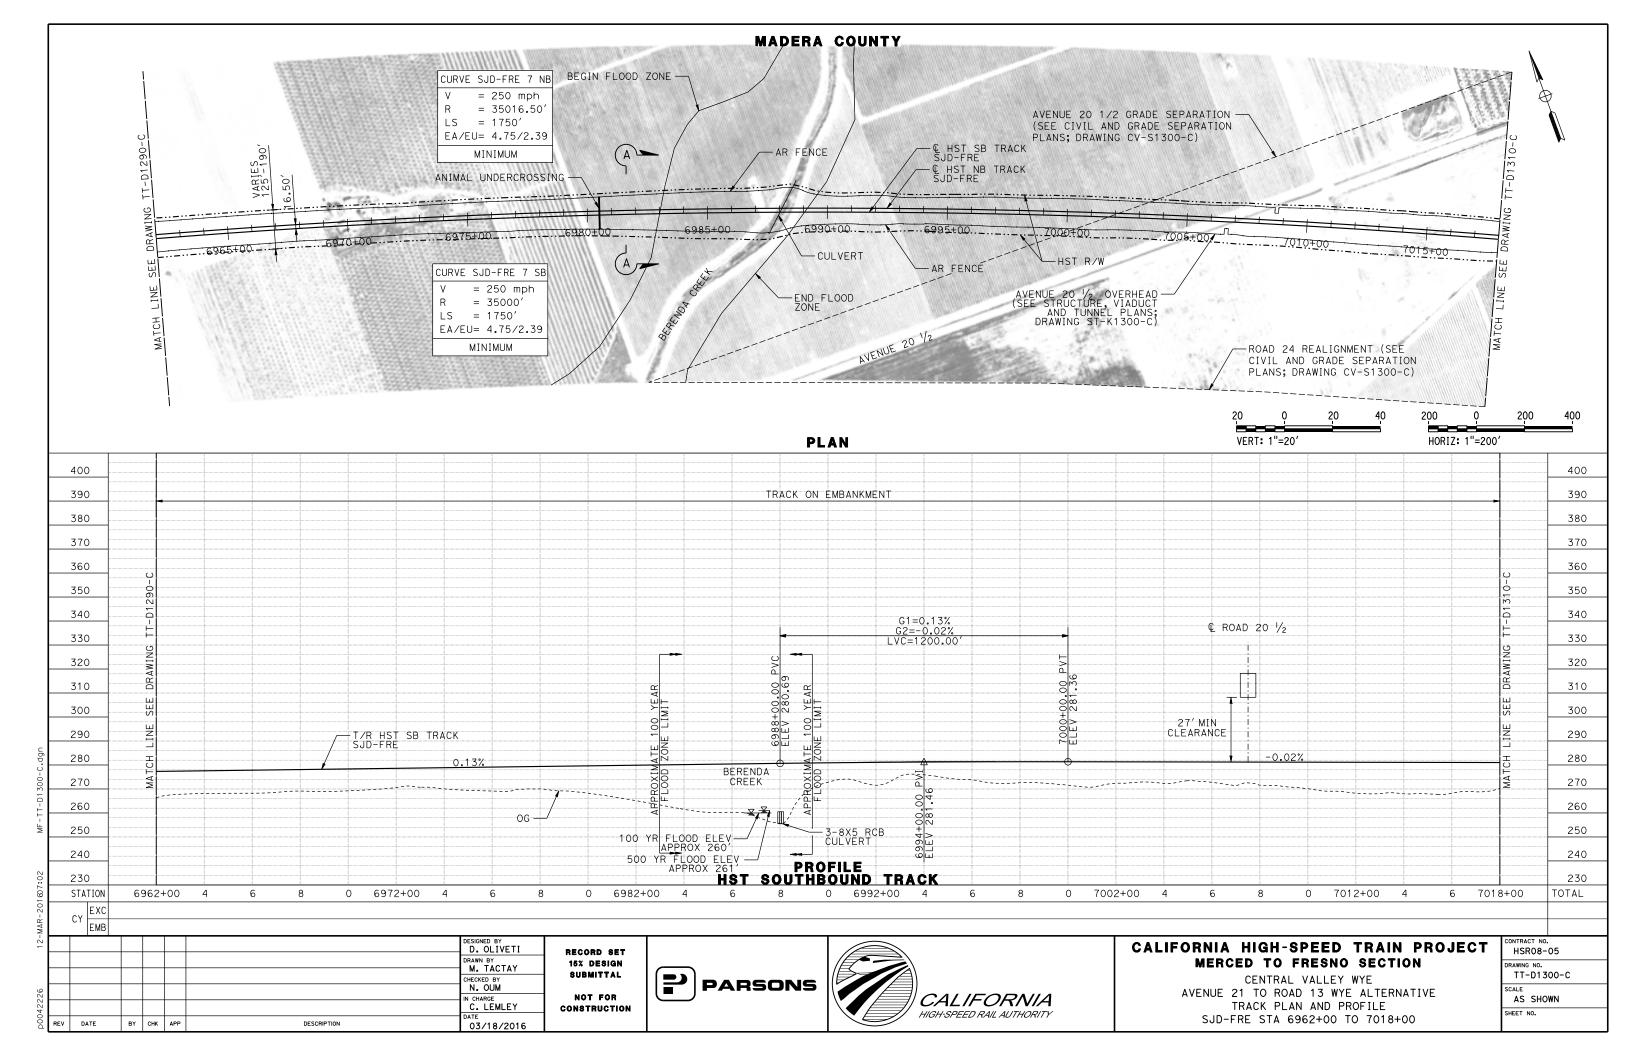

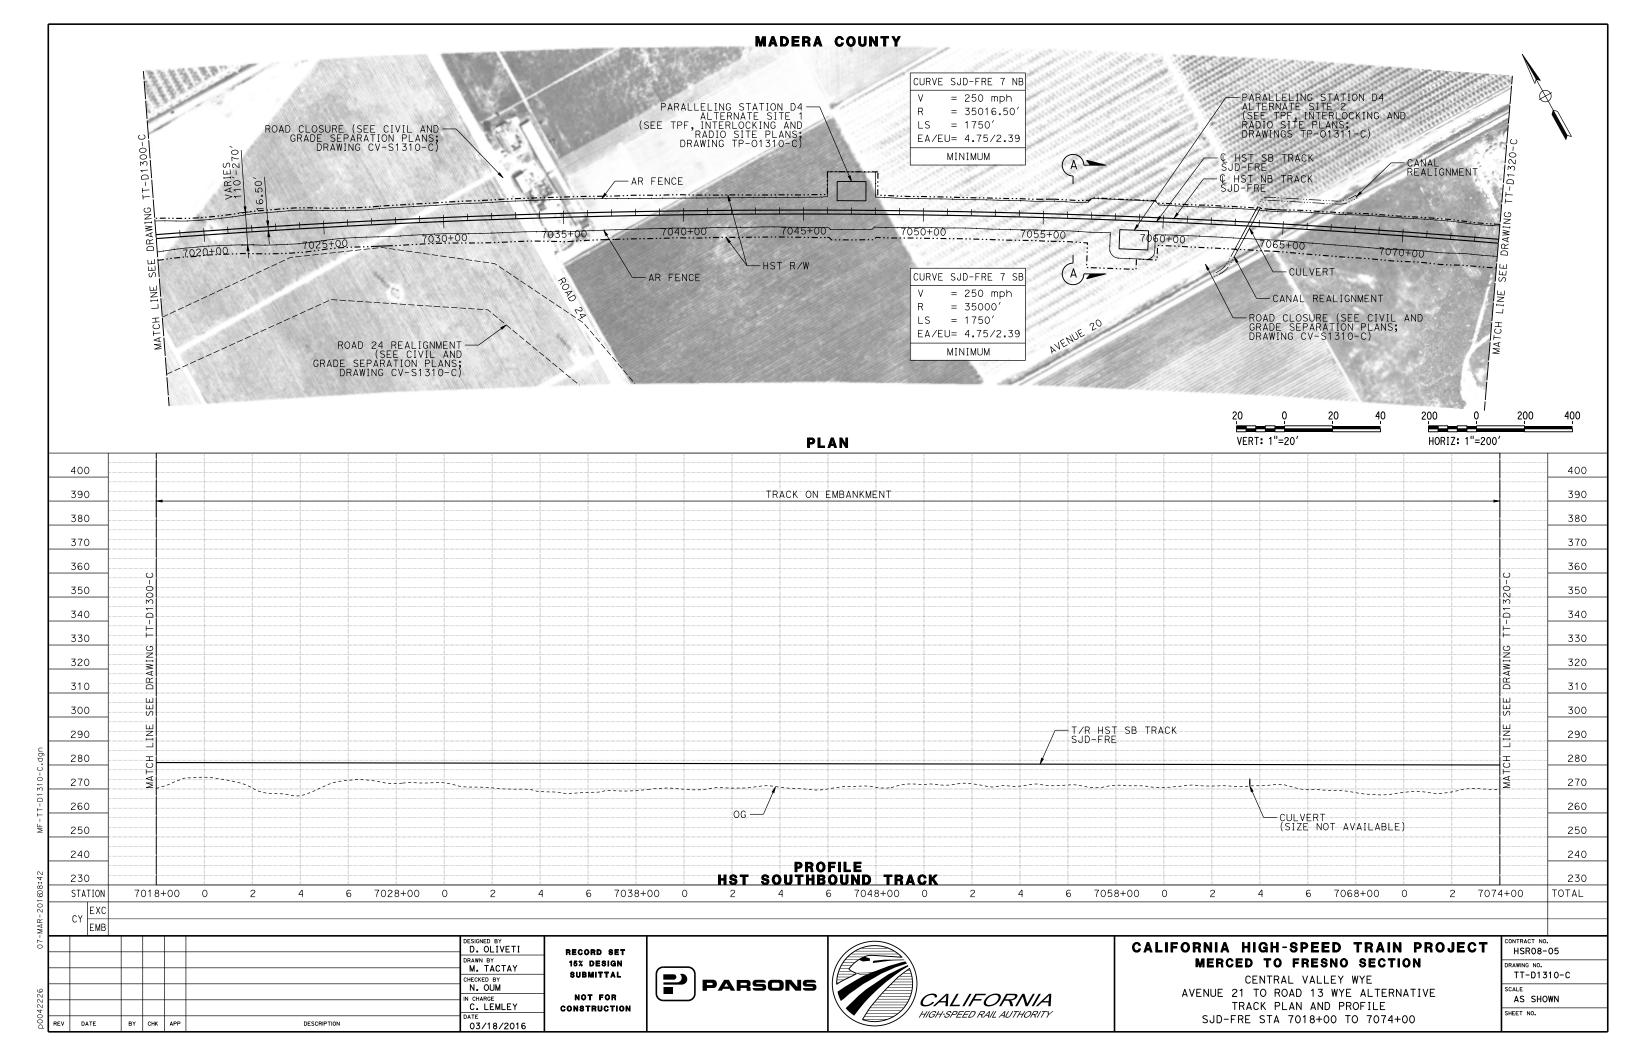

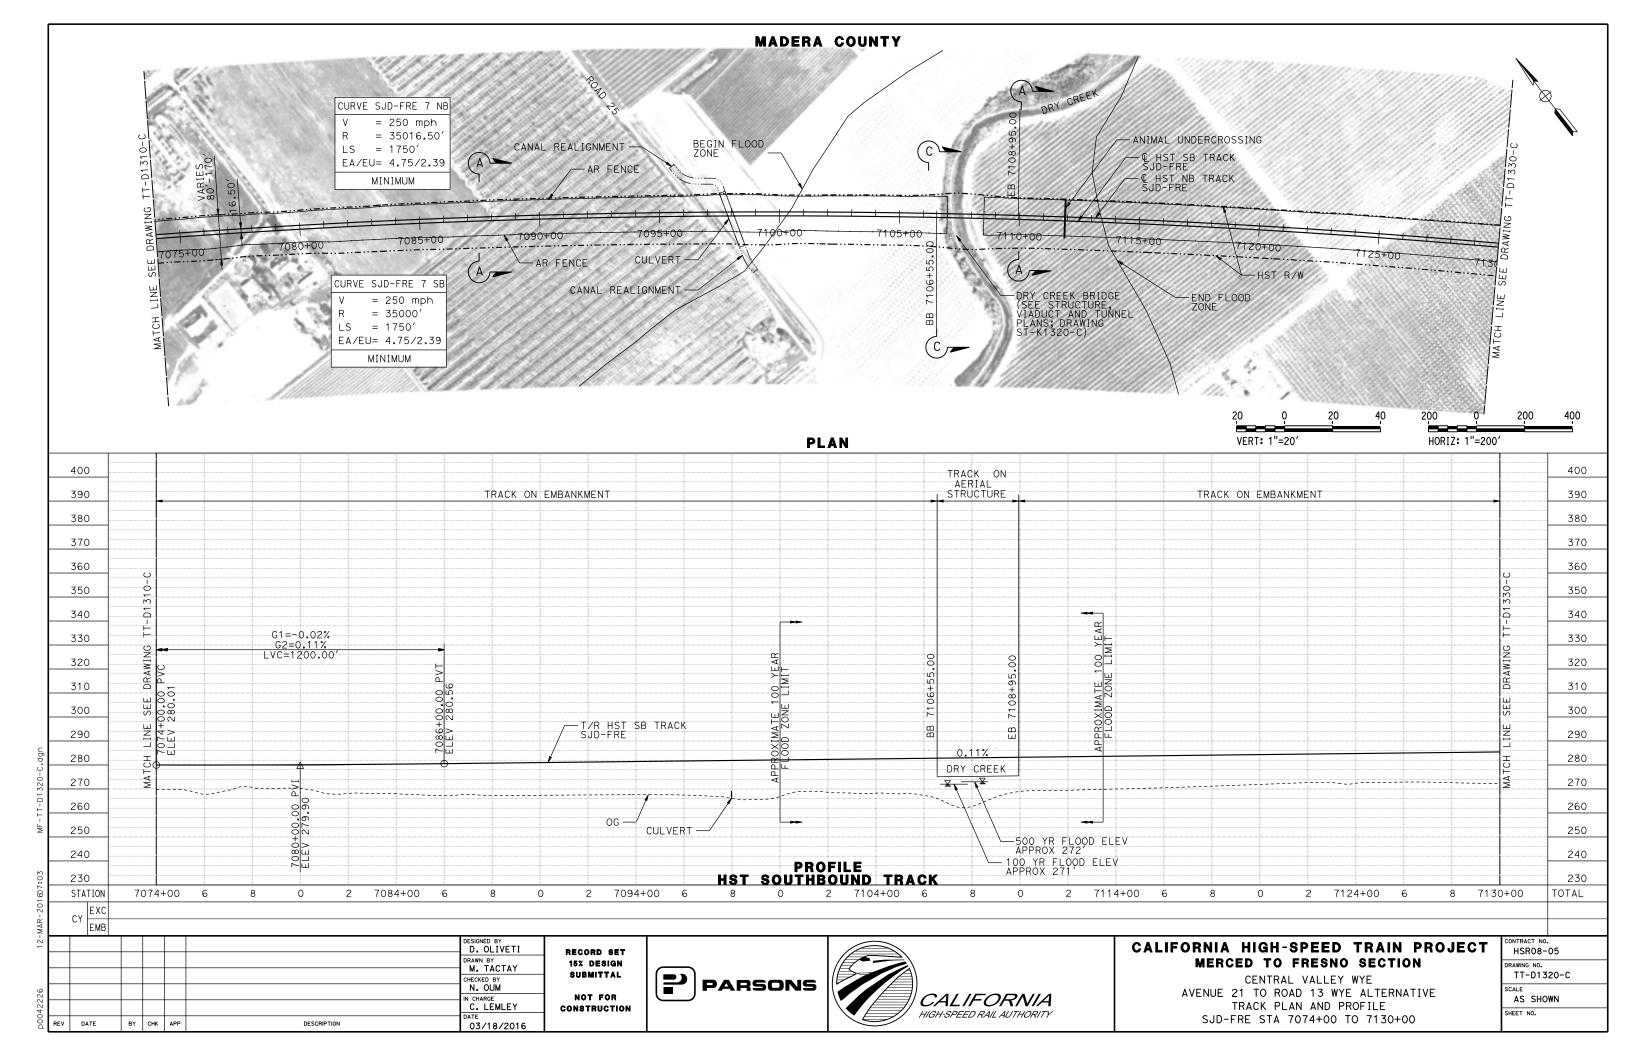

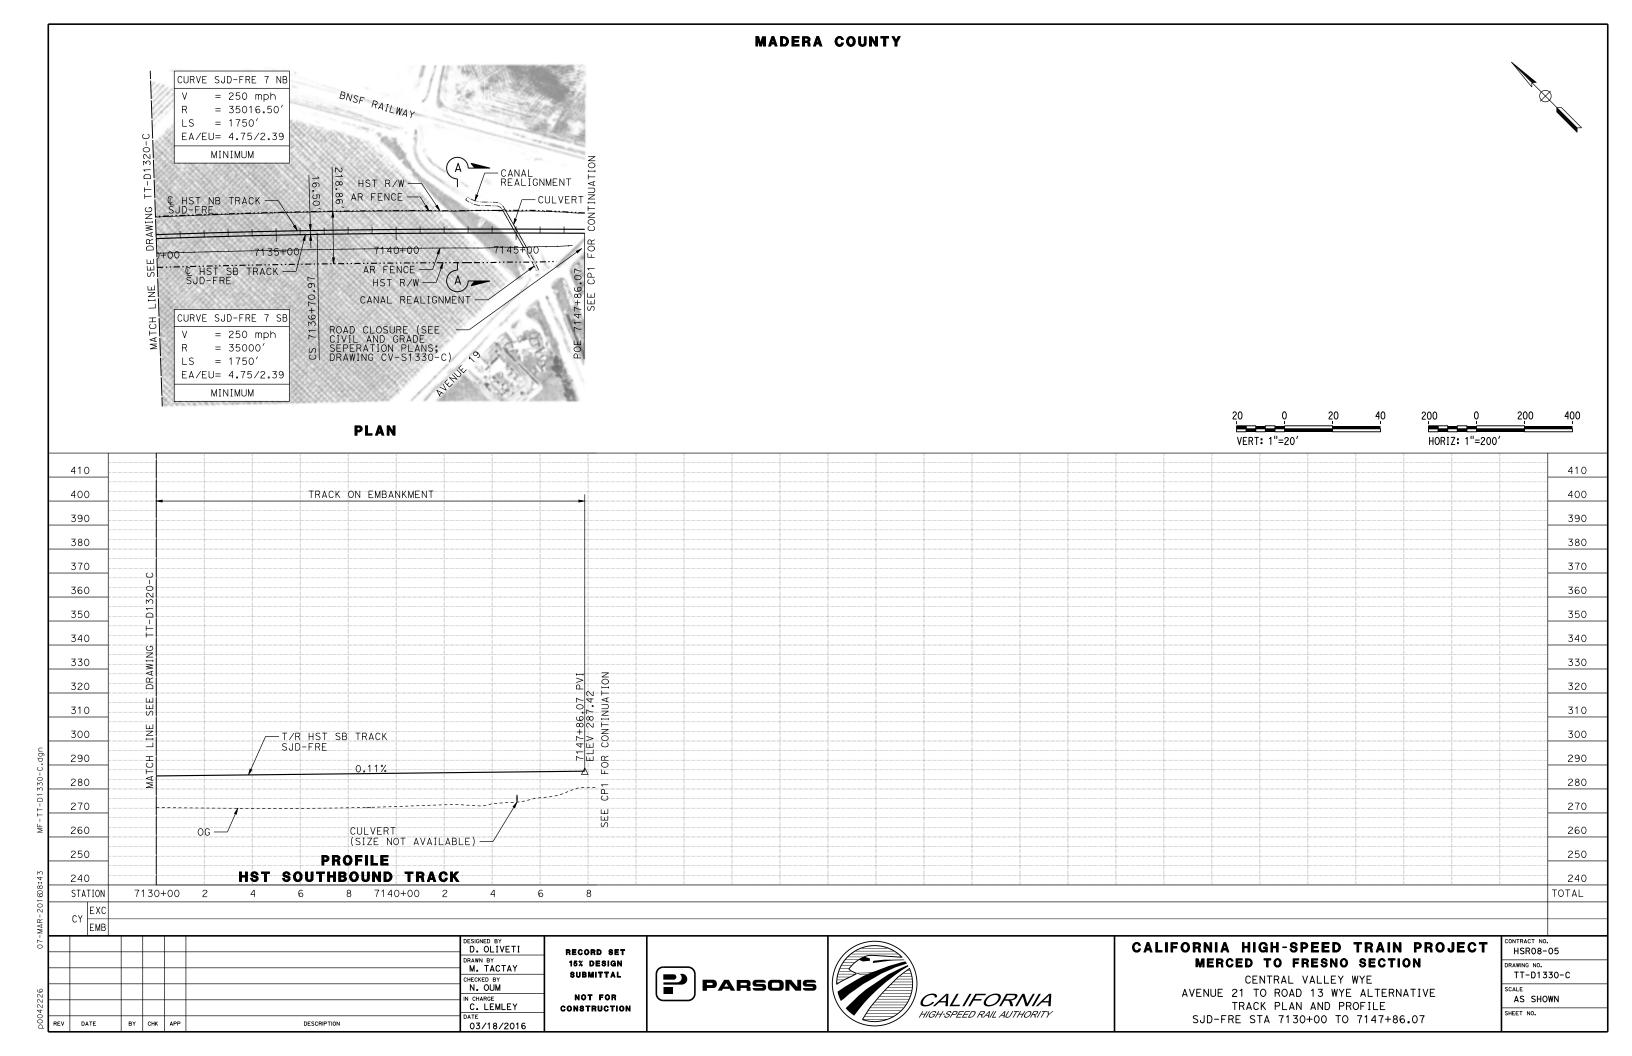


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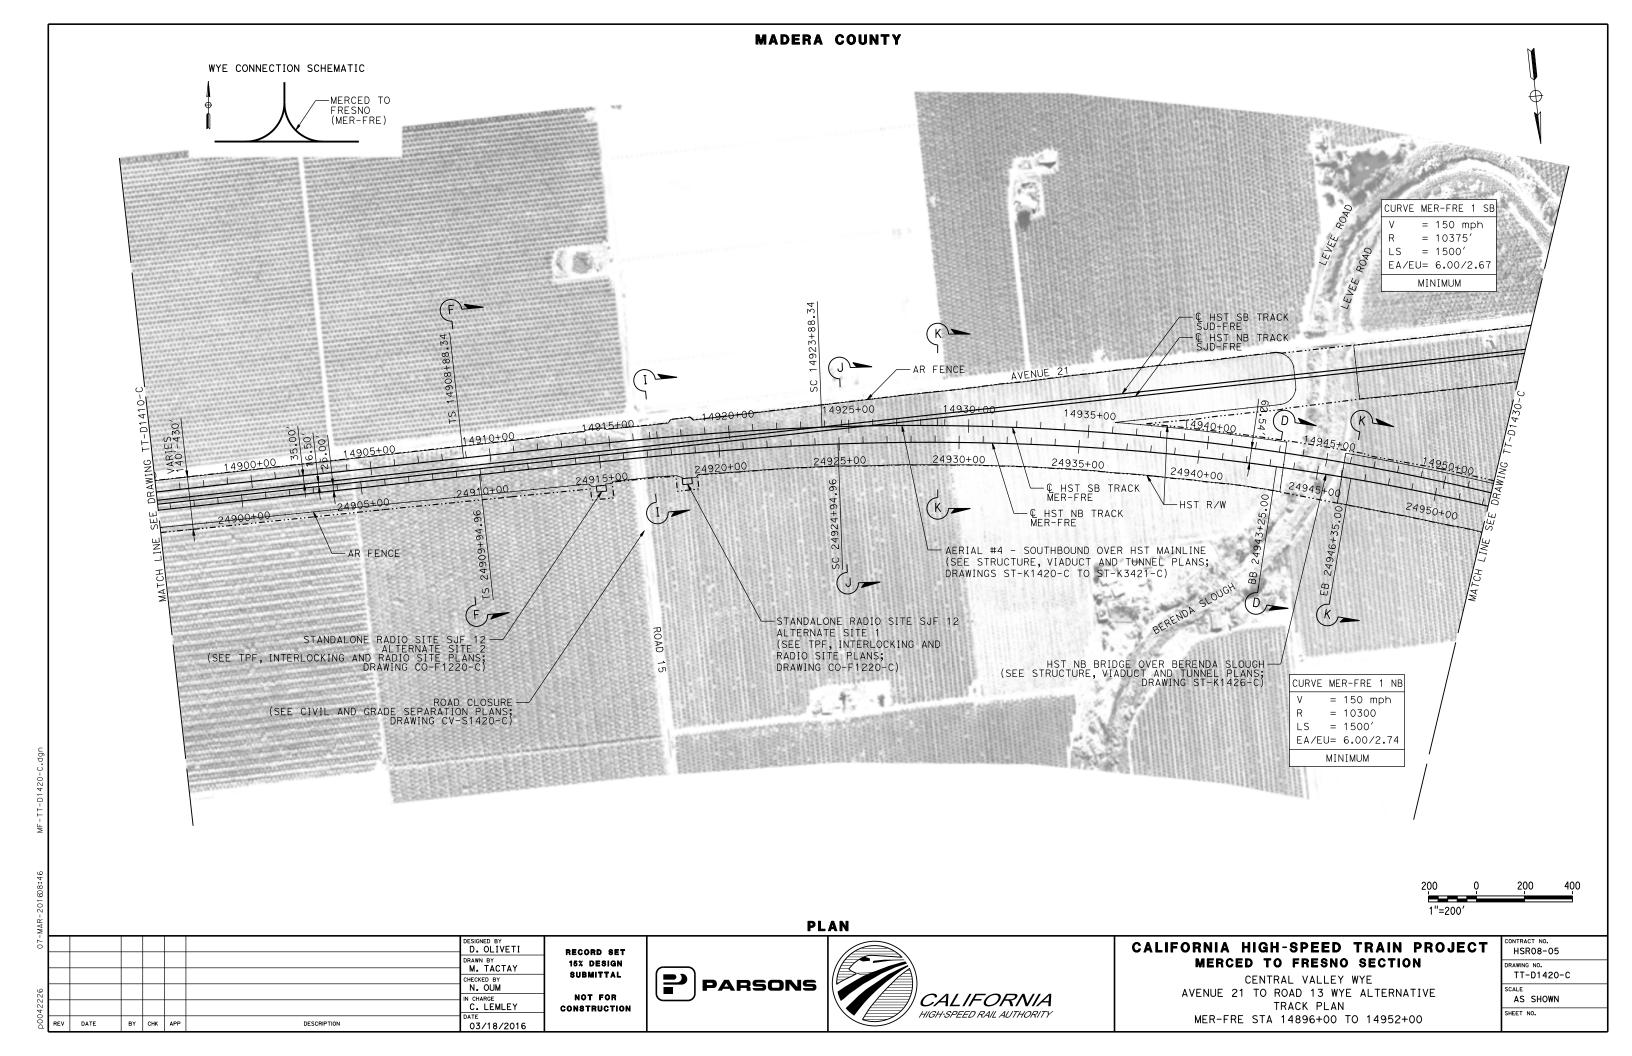
BY CHK APP


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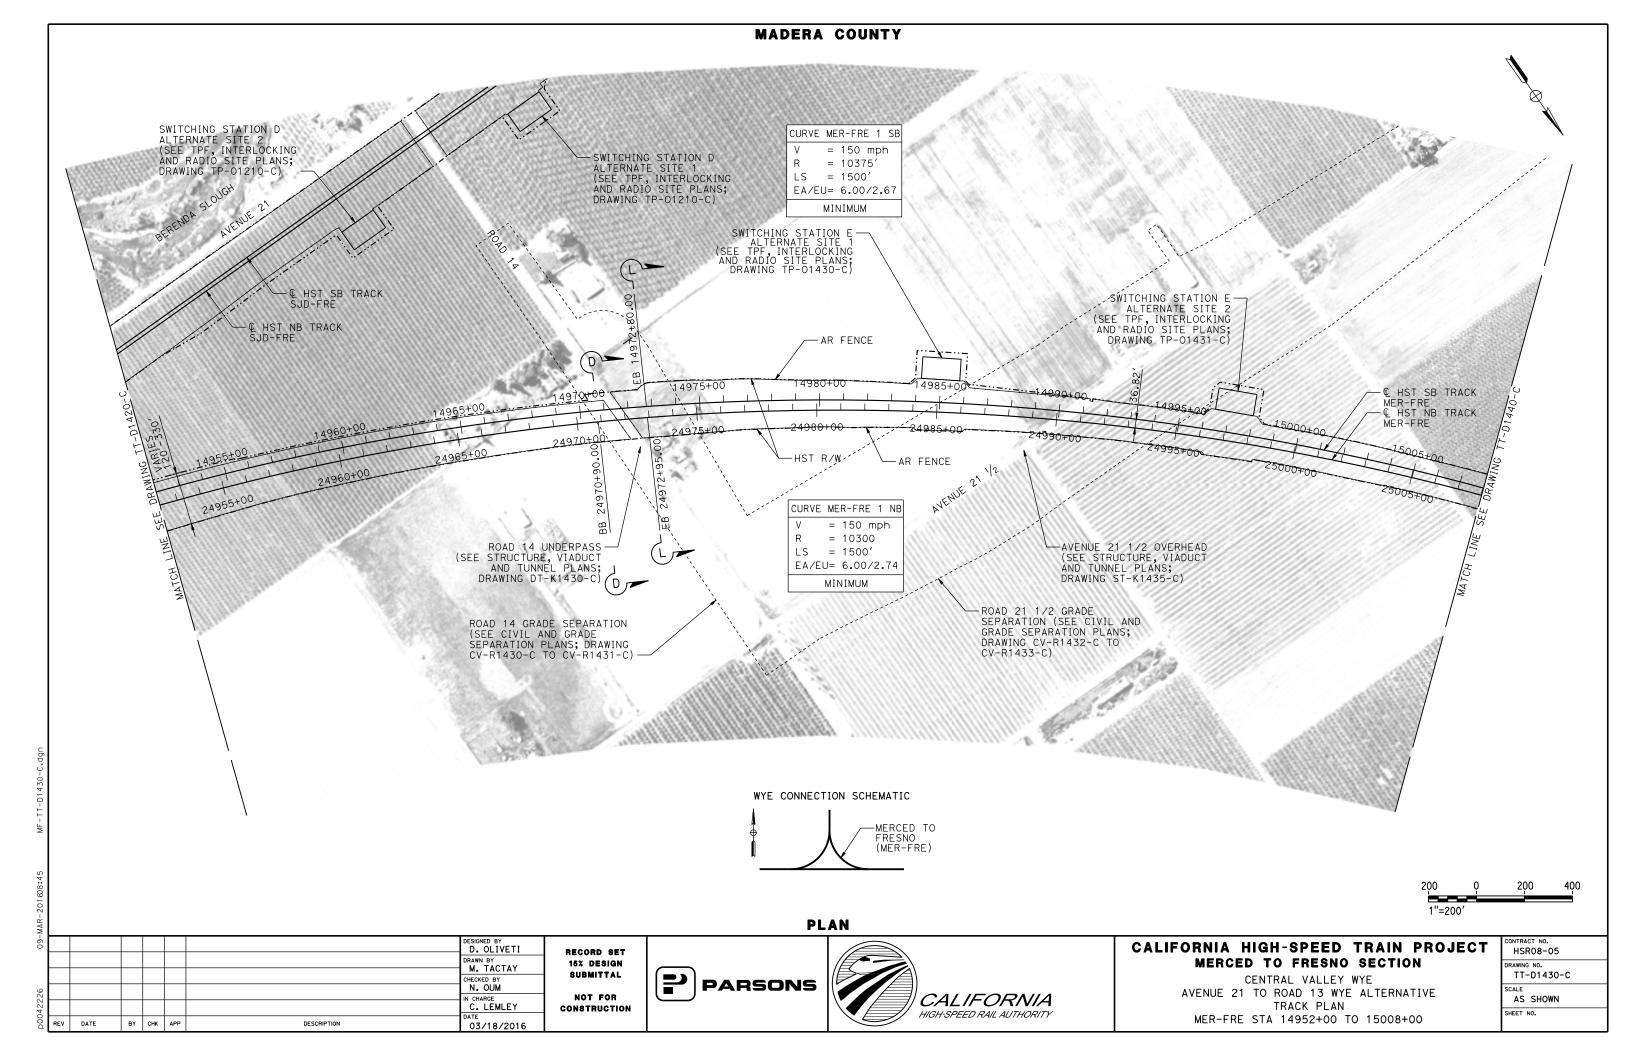
03/18/2016


MER-FRE STA 14840+00 TO 14896+00







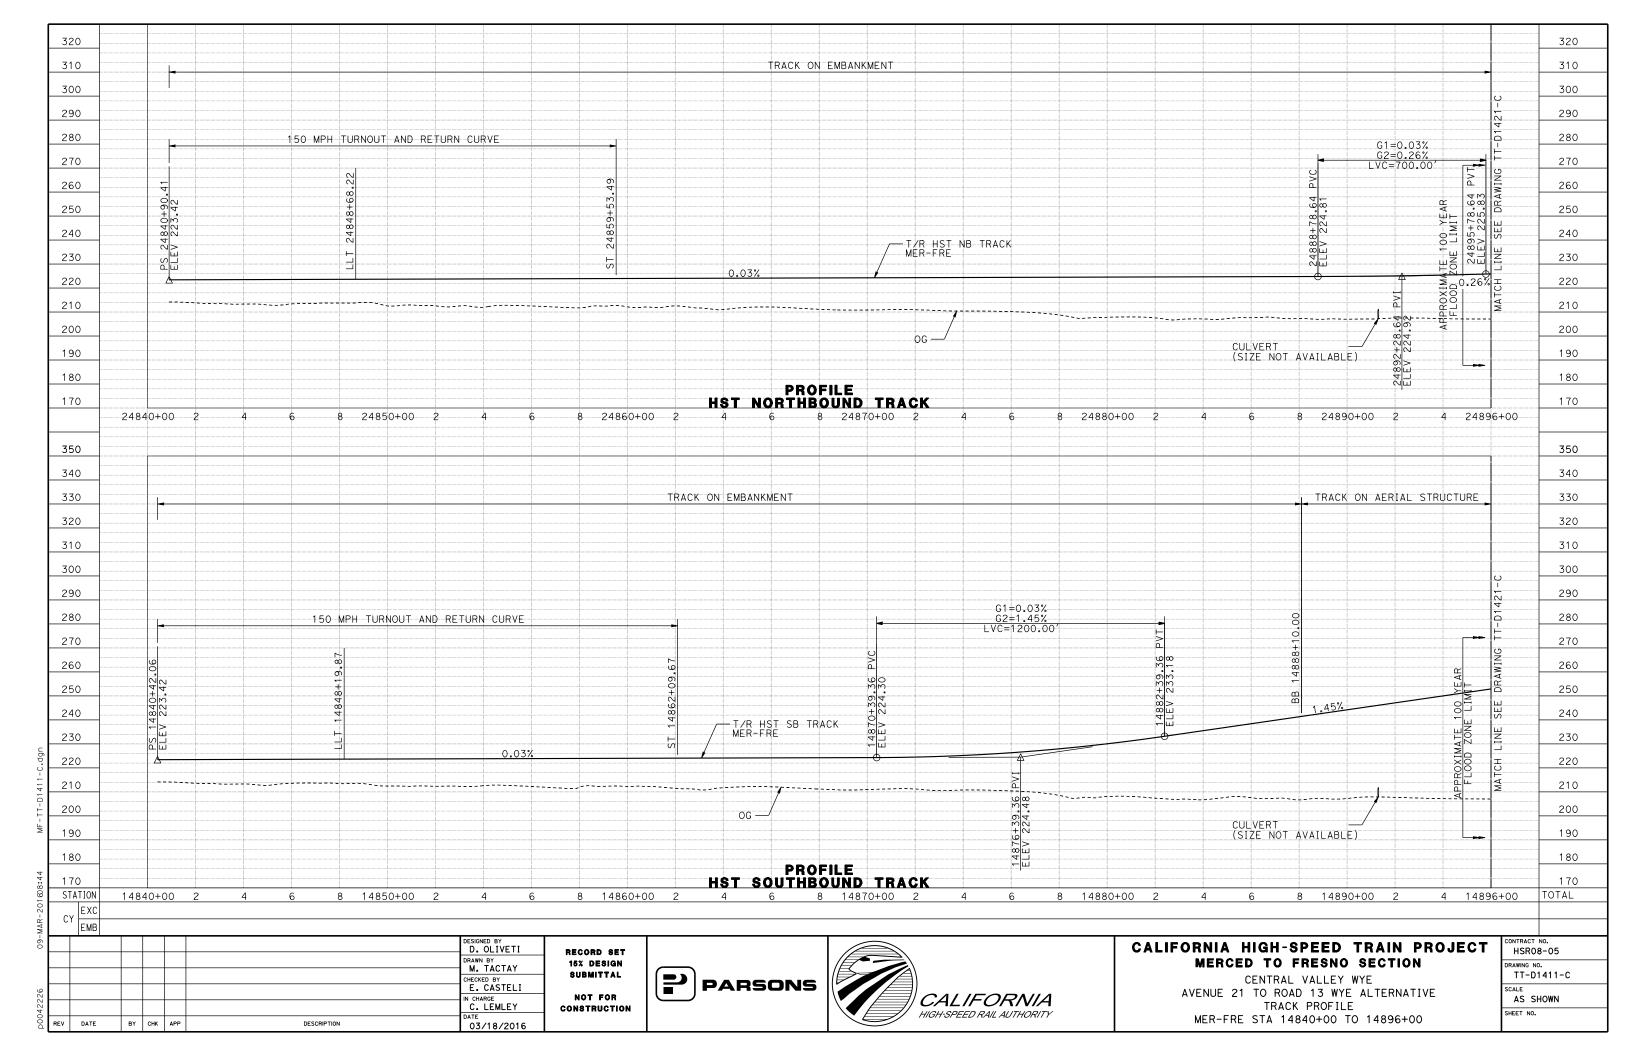

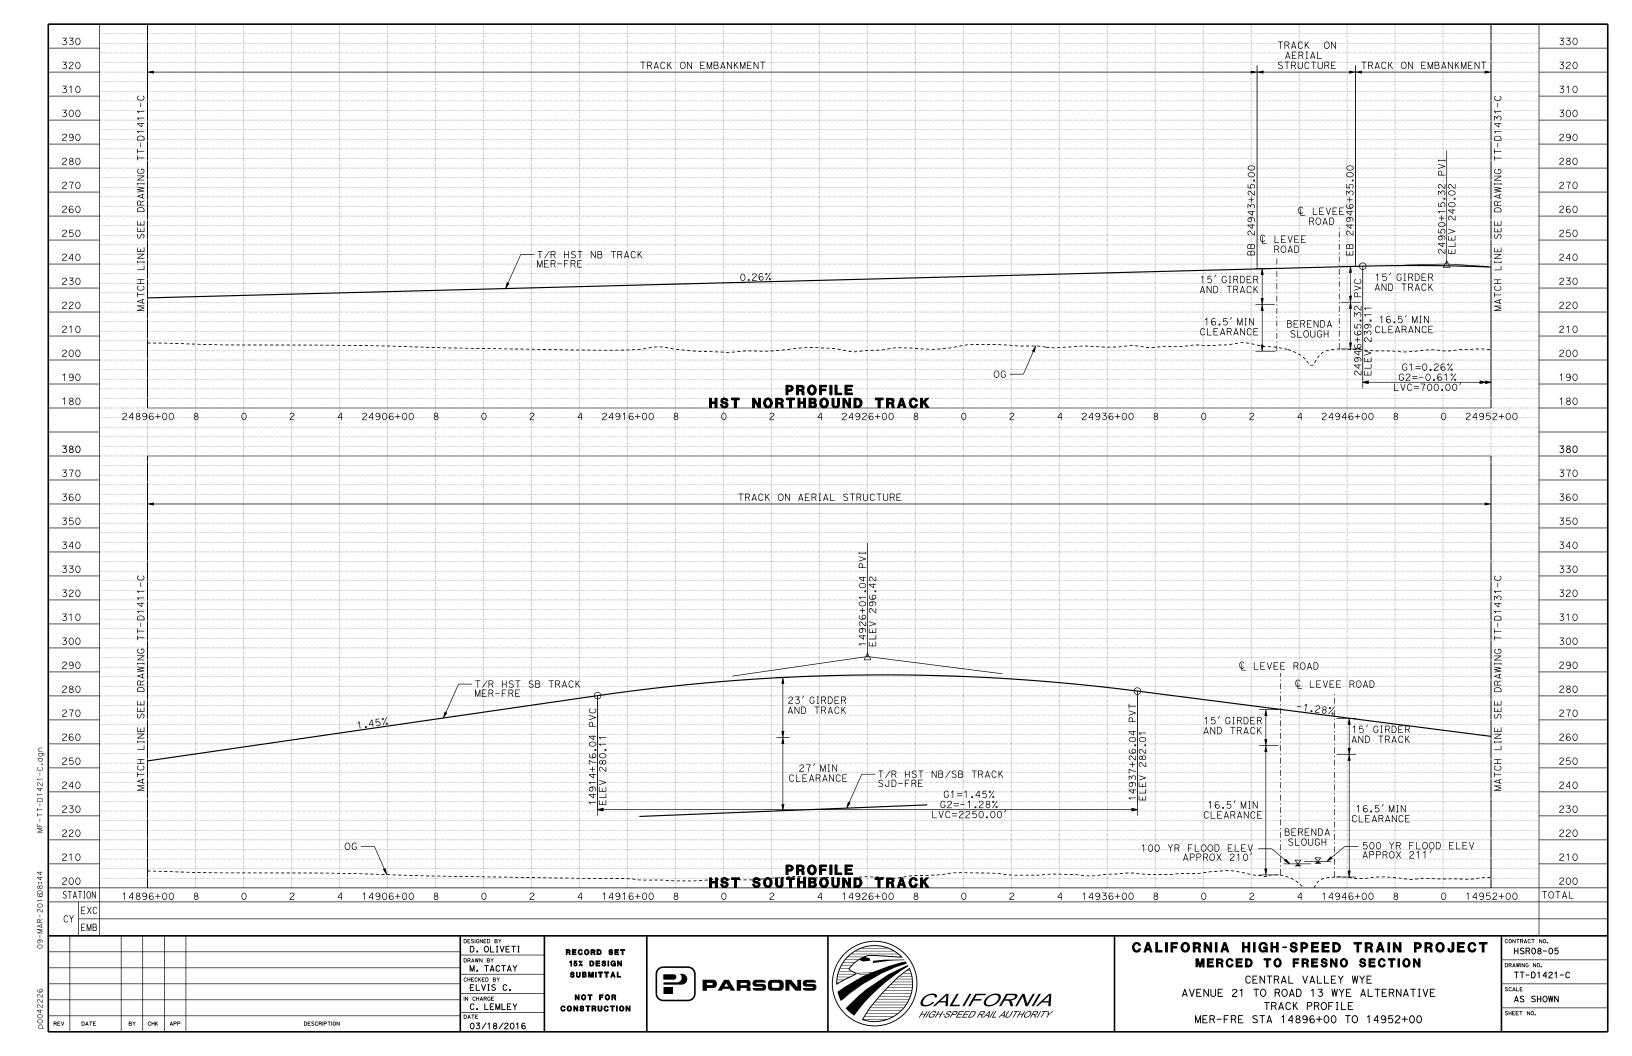

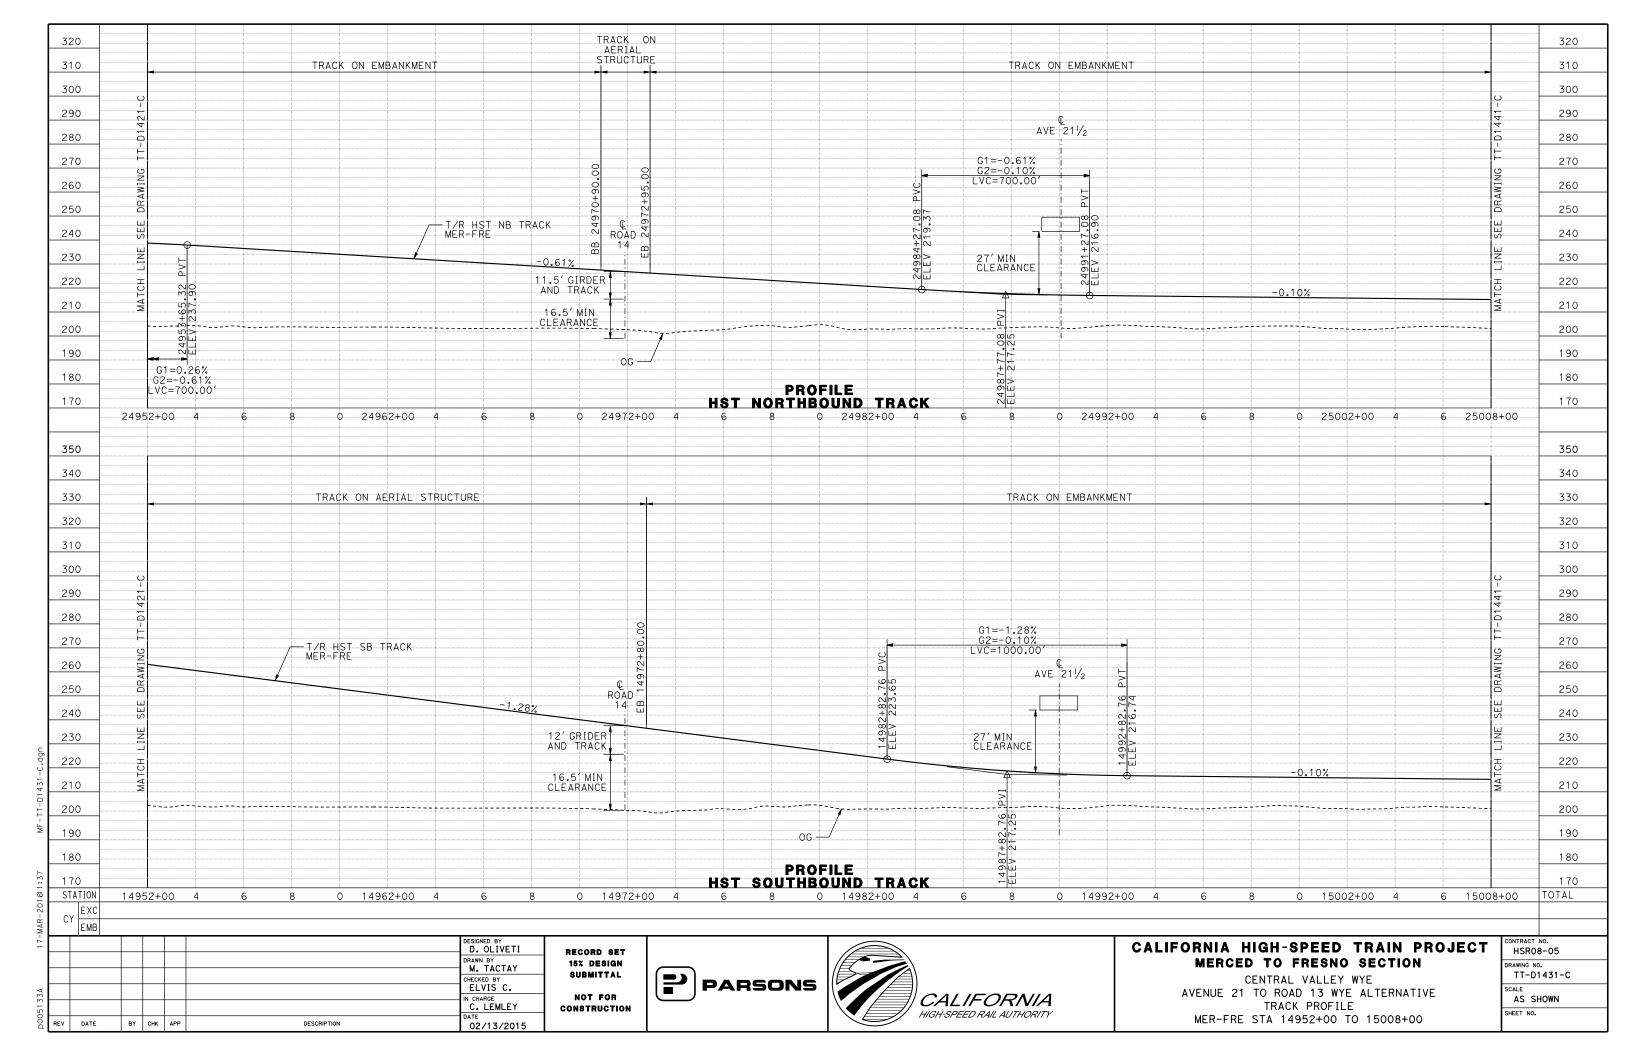


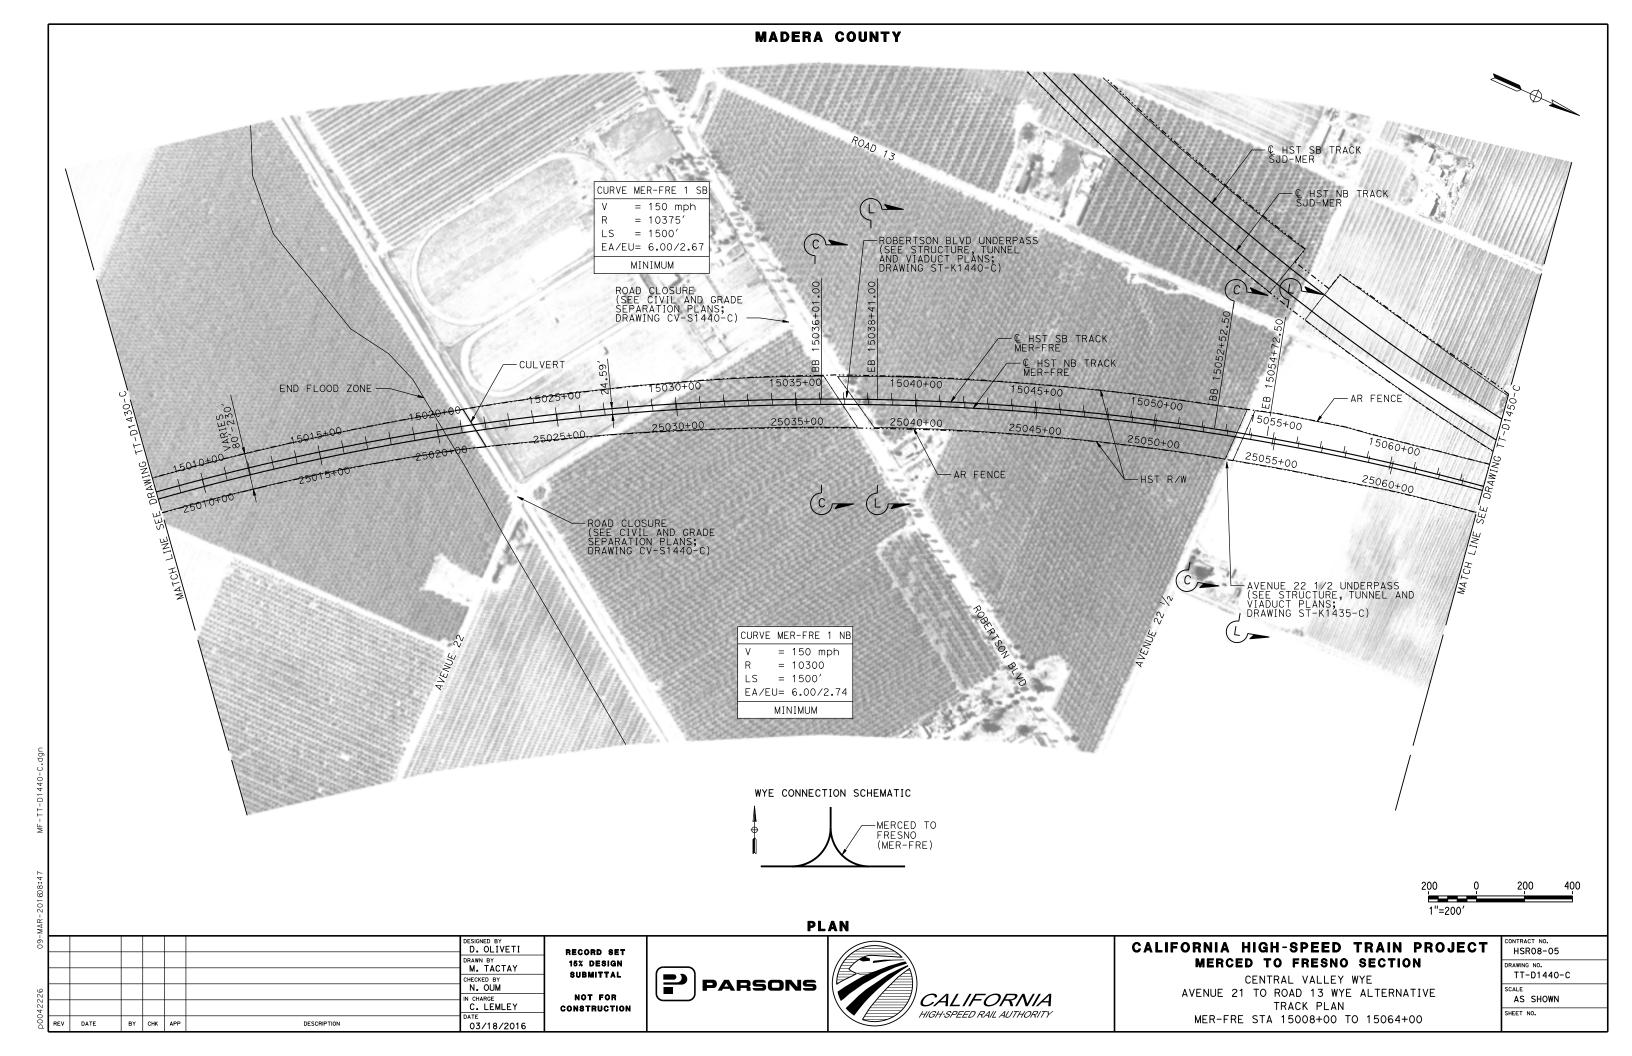

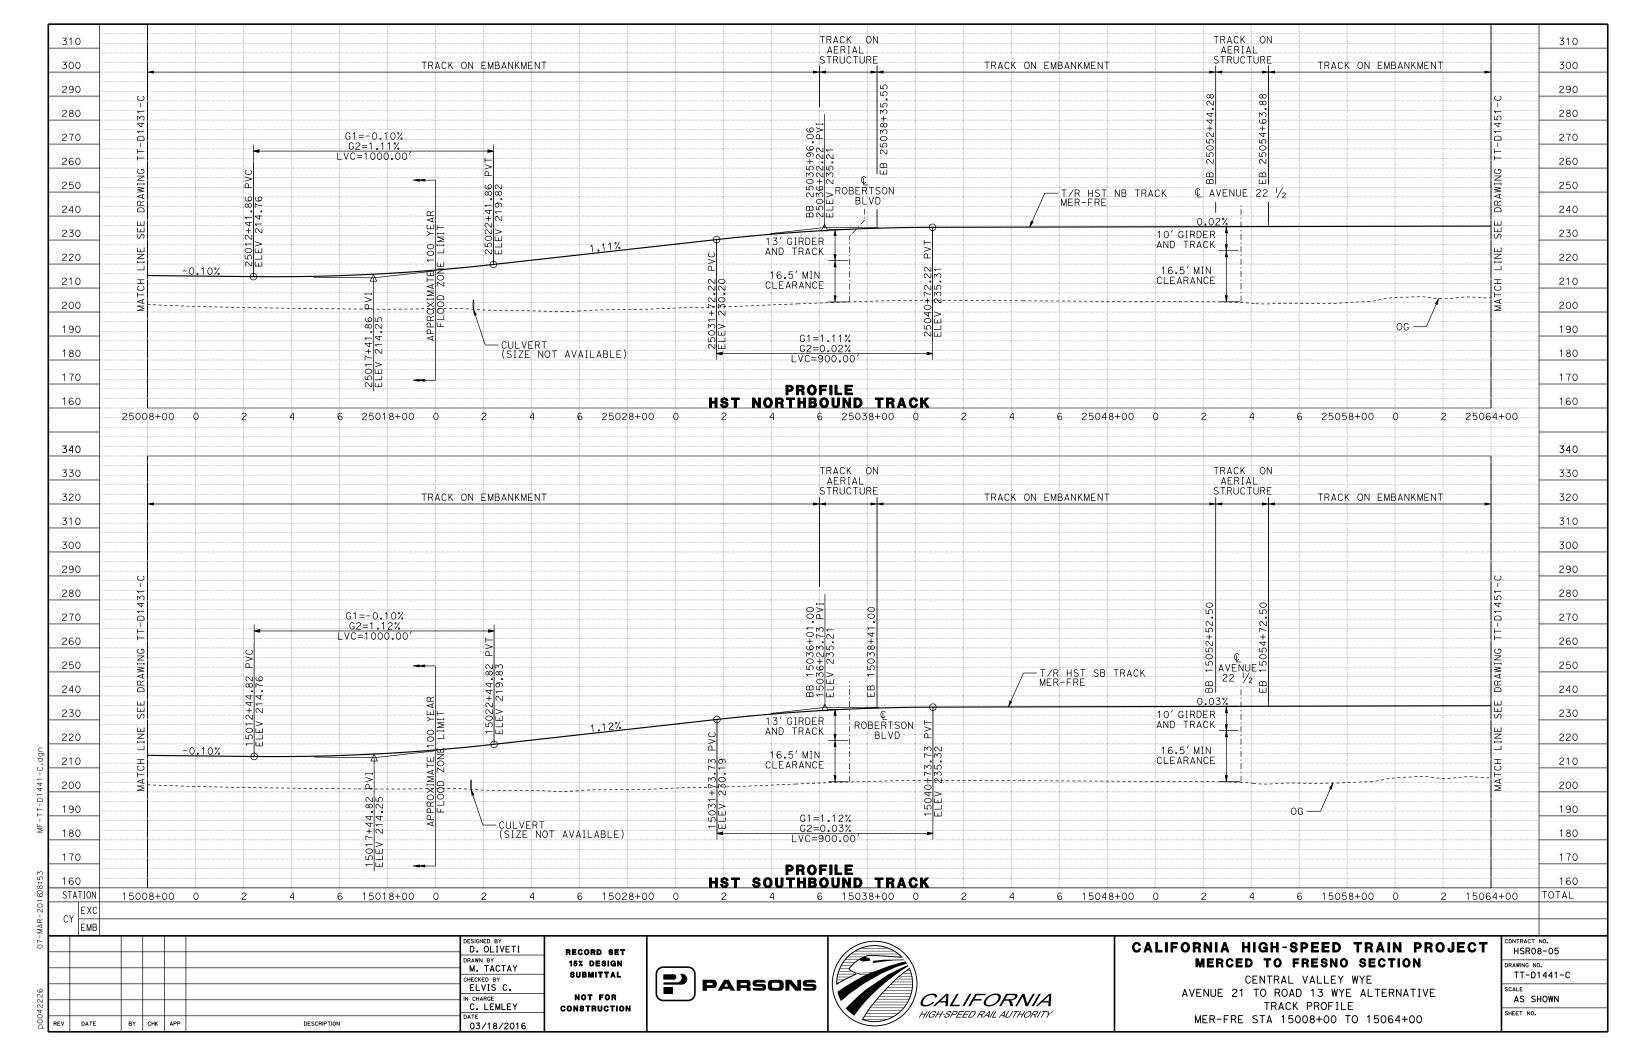





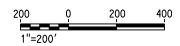

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| DESIGNED BY | D. OLIVETI | DRAWN BY | M. TACTAY | CHECKED BY | N. OUM | IN CHARGE | C. LEMLEY | DATE | BY CHK | APP | DESCRIPTION | DATE | D

RECORD SET
15% DESIGN
SUBMITTAL
NOT FOR
CONSTRUCTION








## CALIFORNIA HIGH-SPEED TRAIN PROJECT MERCED TO FRESNO SECTION


CENTRAL VALLEY WYE
AVENUE 21 TO ROAD 13 WYE ALTERNATIVE
TRACK PLAN
MER-FRE STA 15064+00 TO 15120+00


HSR08-05
DRAWING NO.
TT-D1450-C
SCALE
AS SHOWN
SHEET NO.

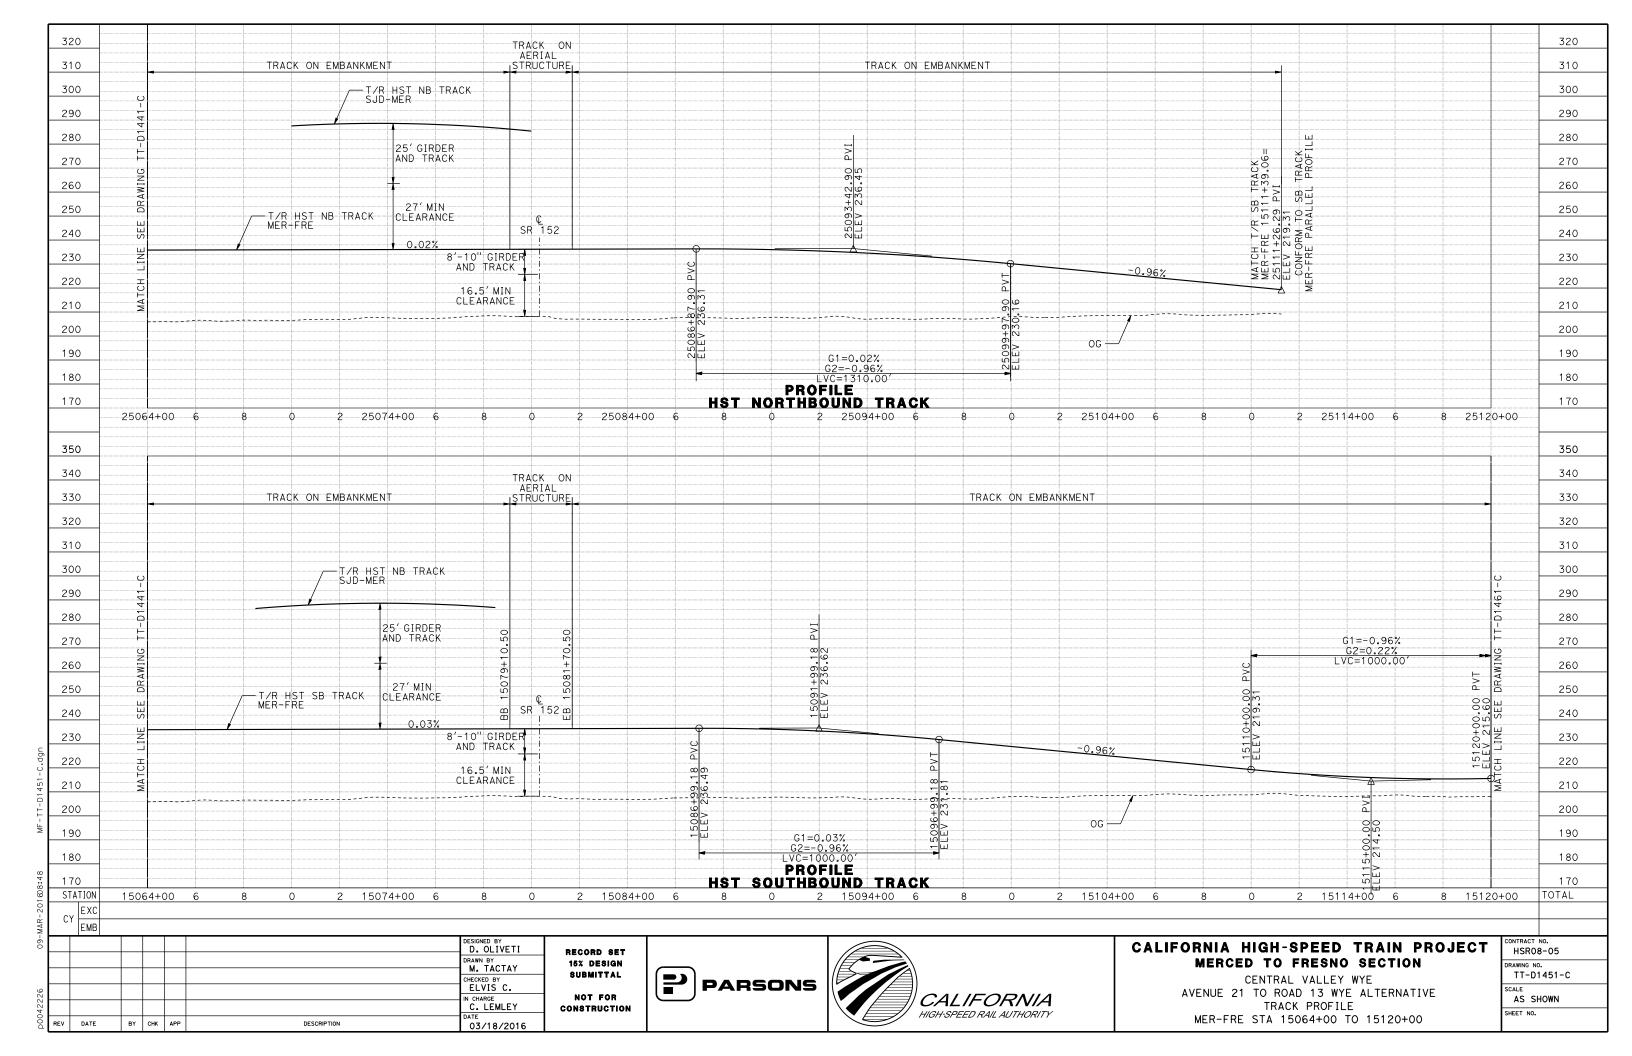


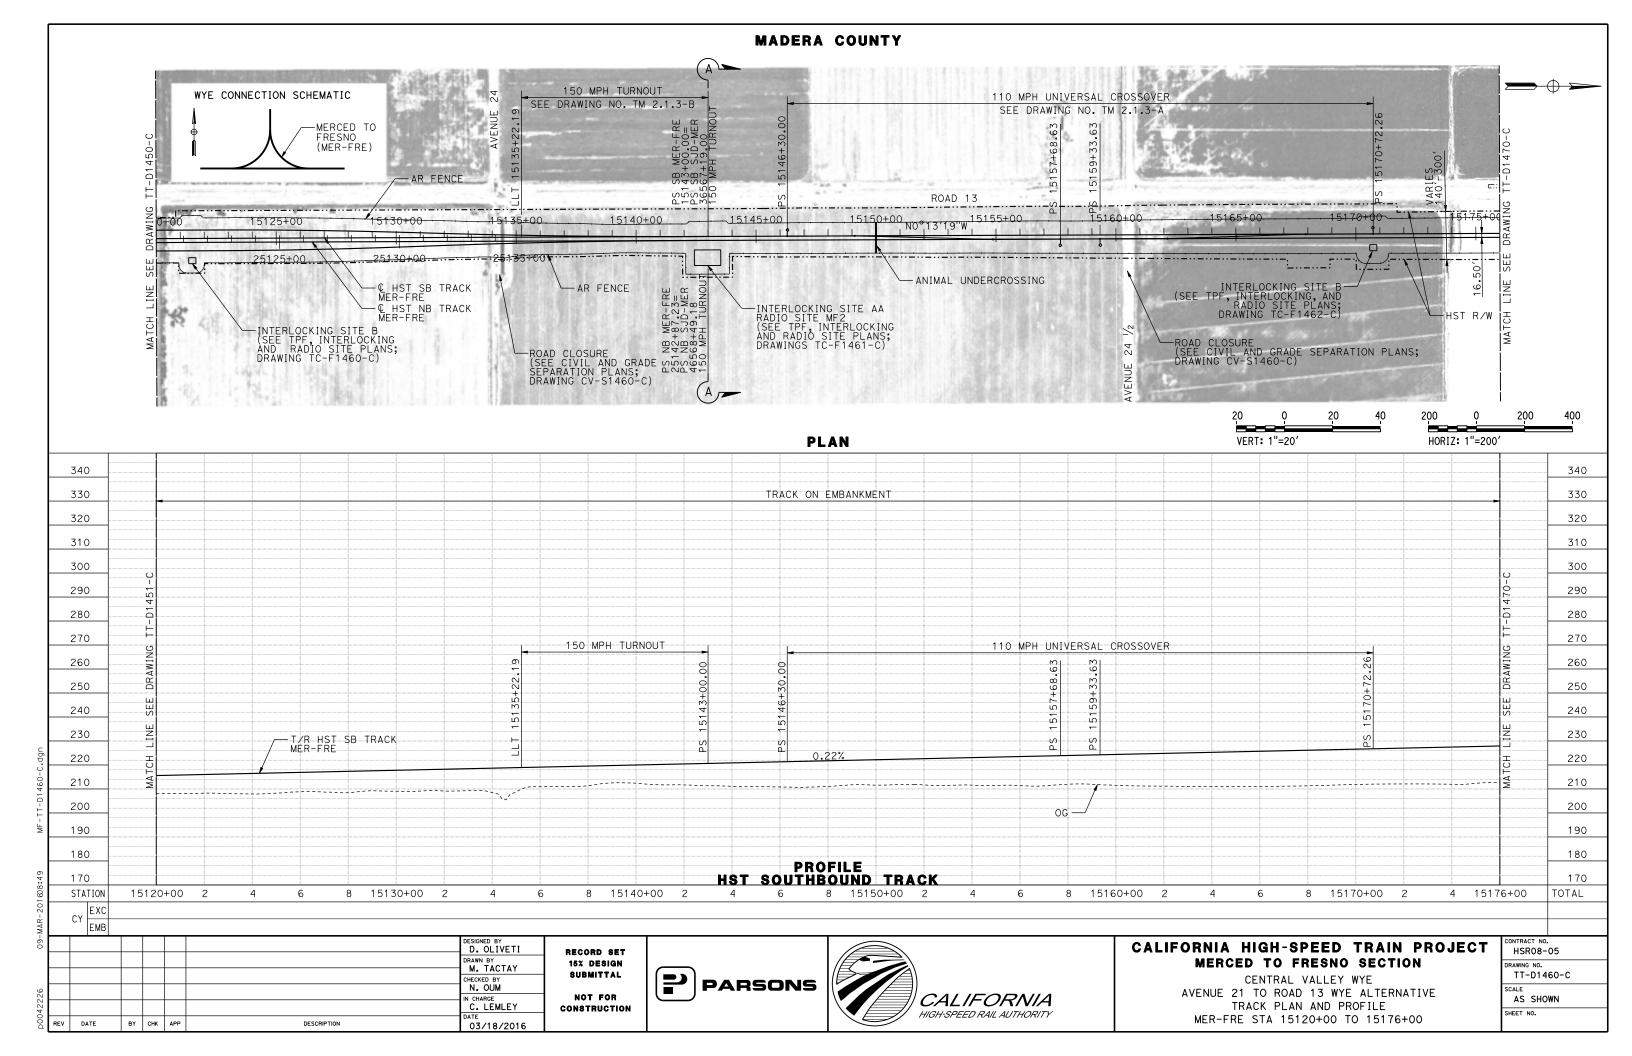


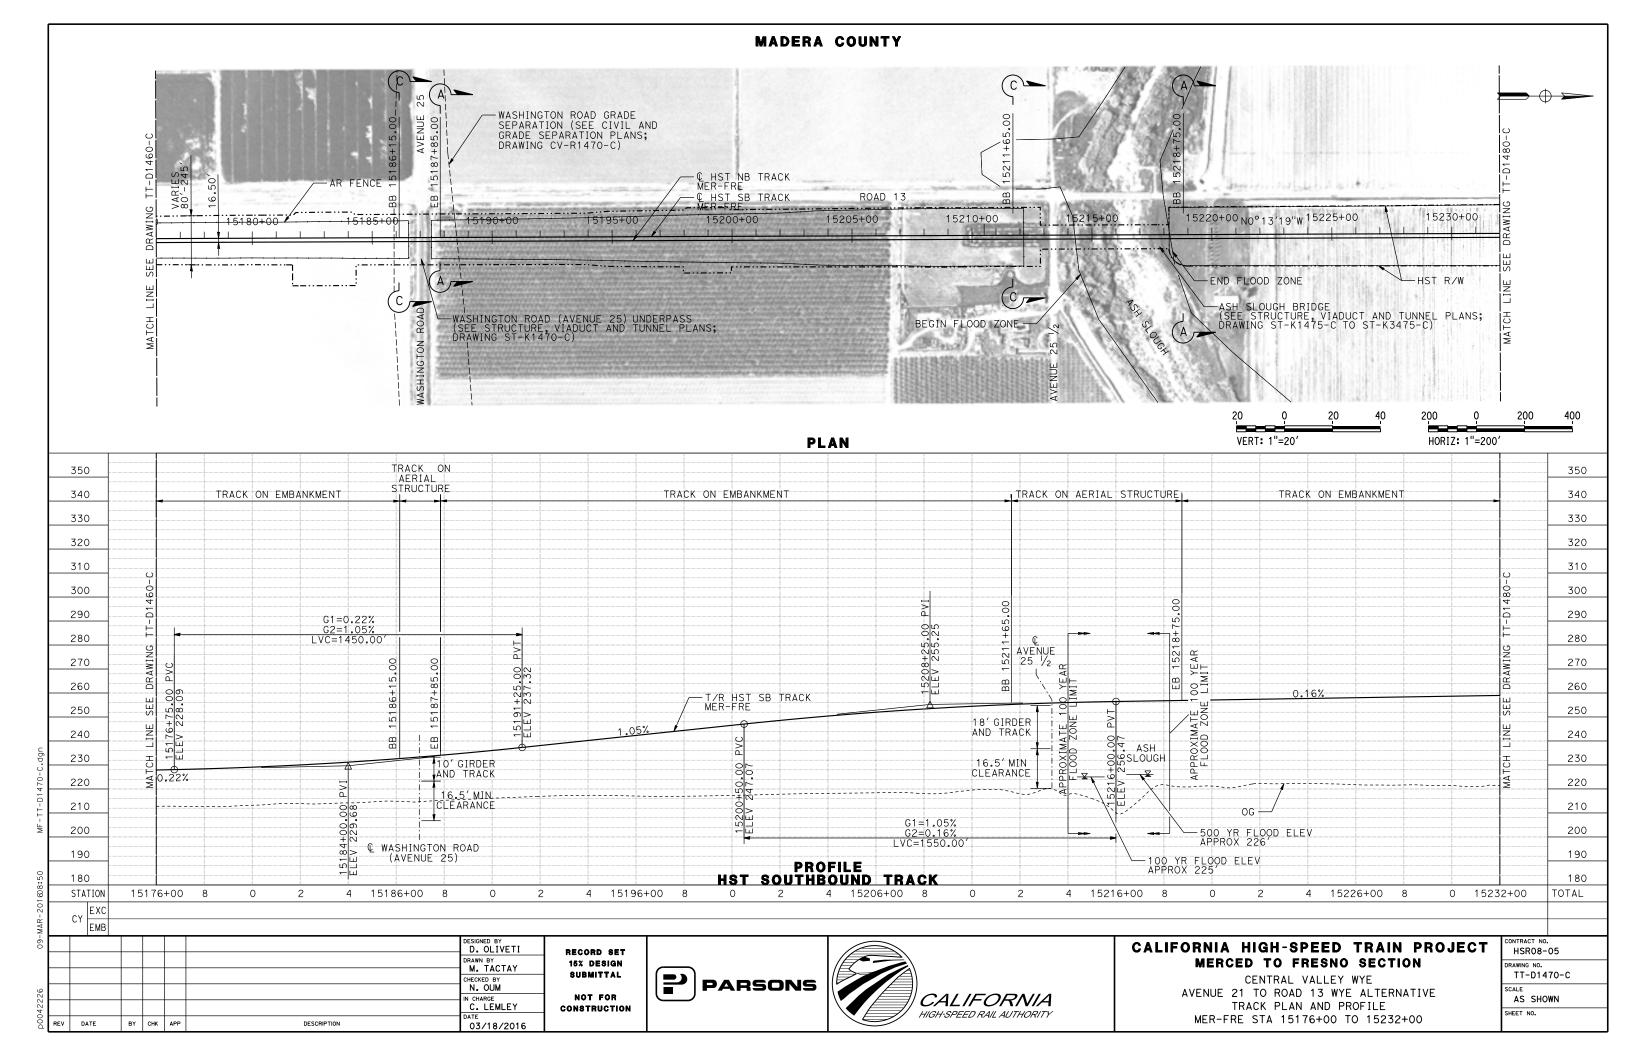


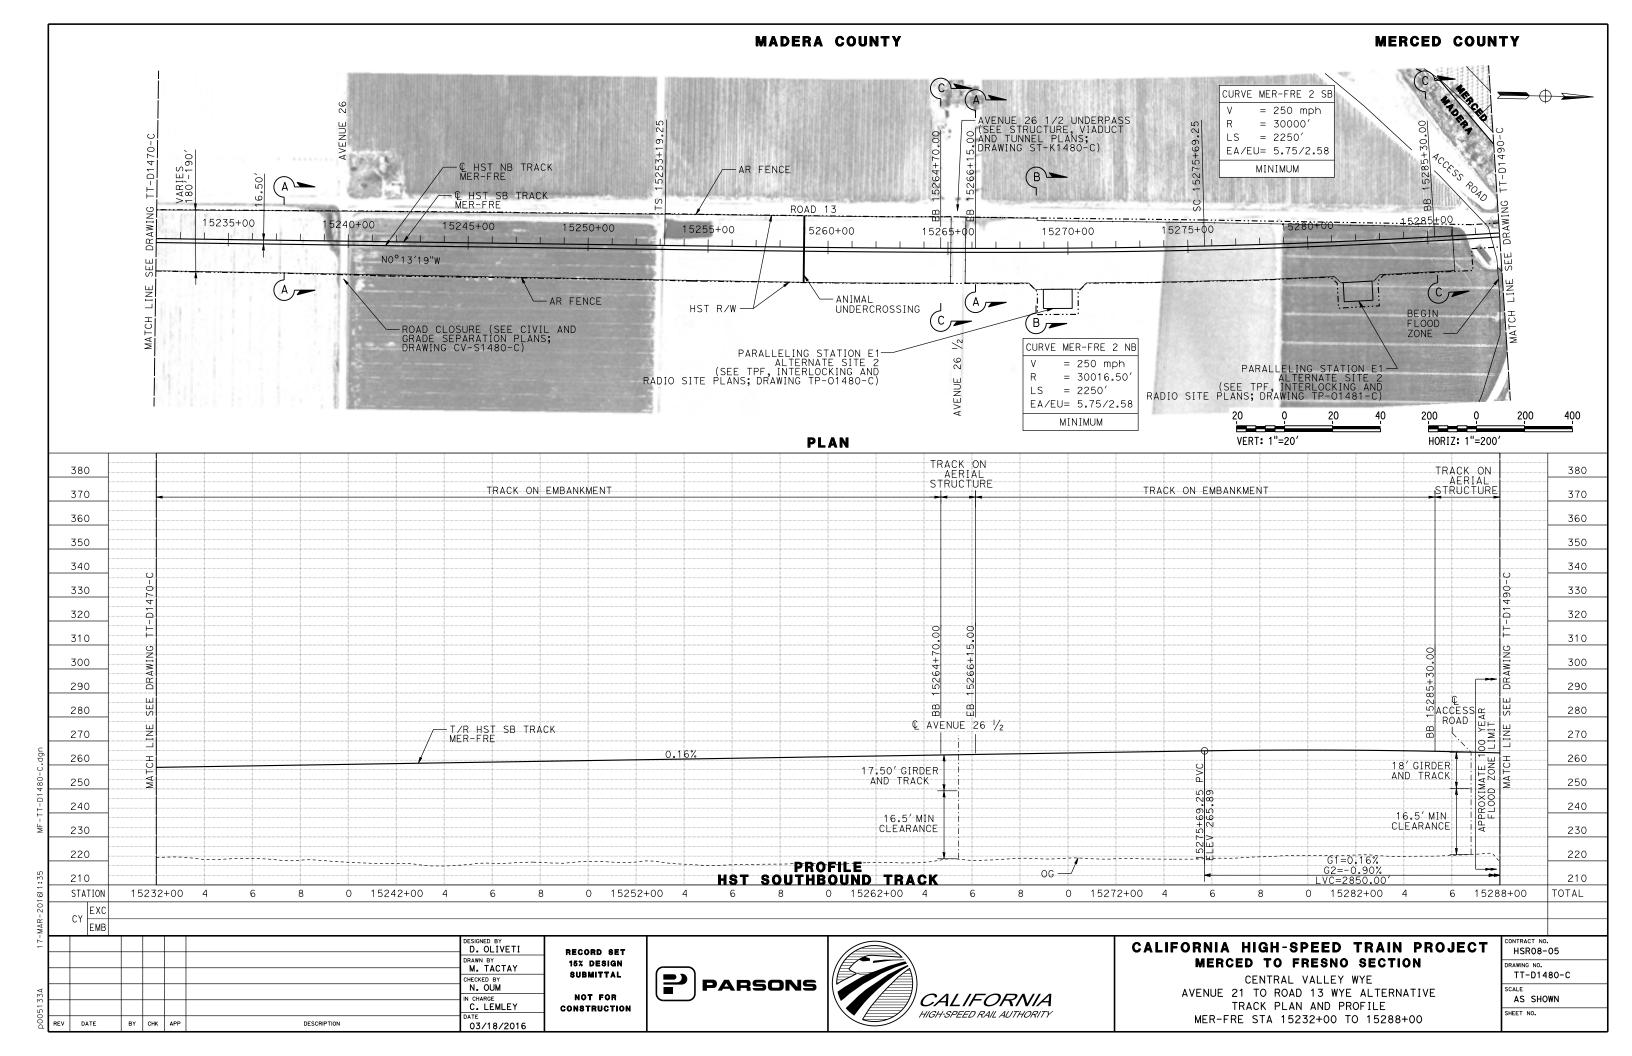


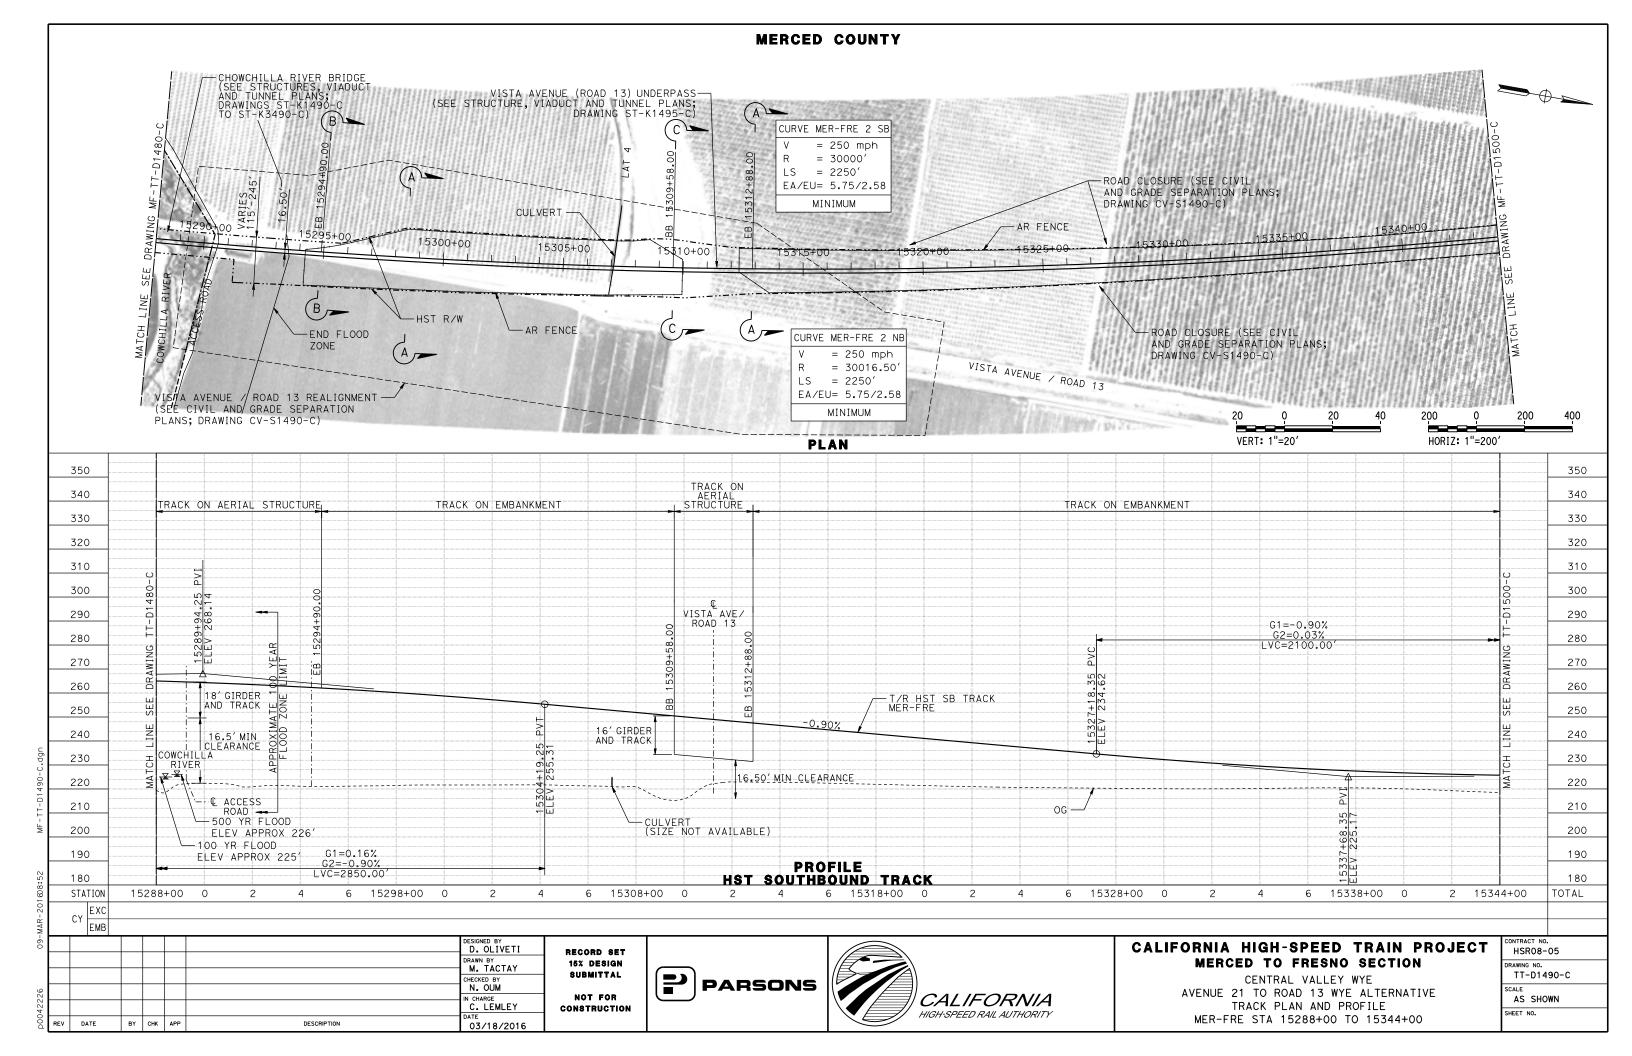


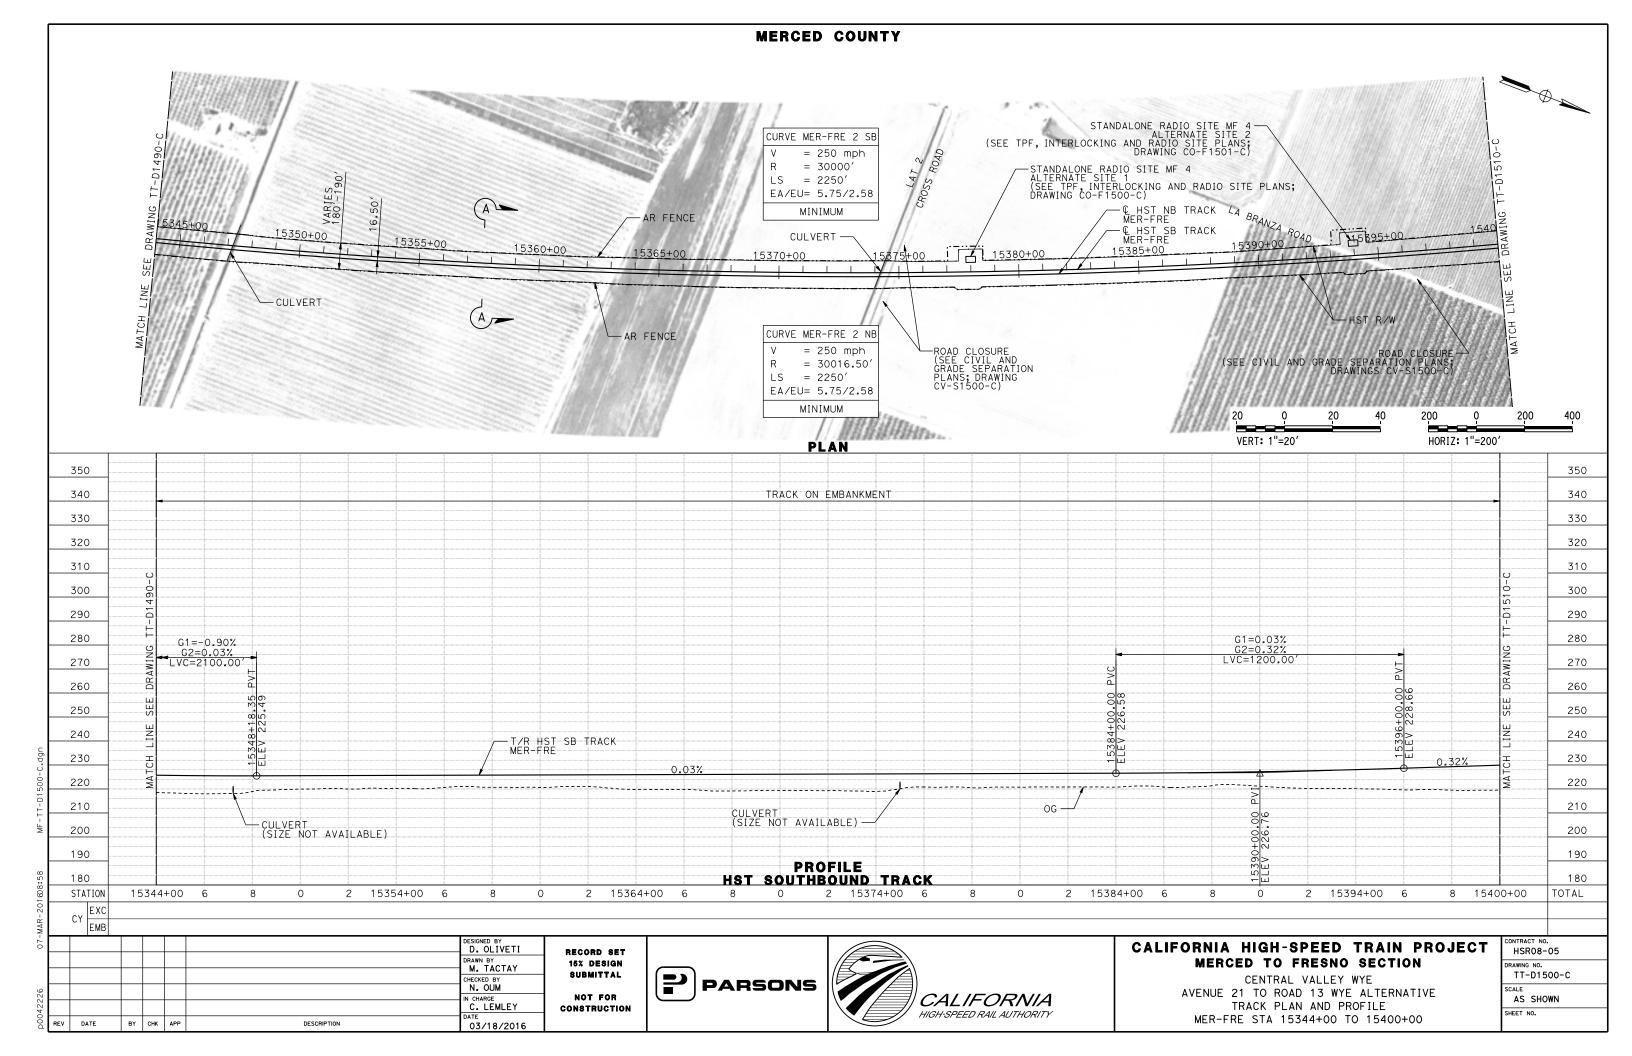


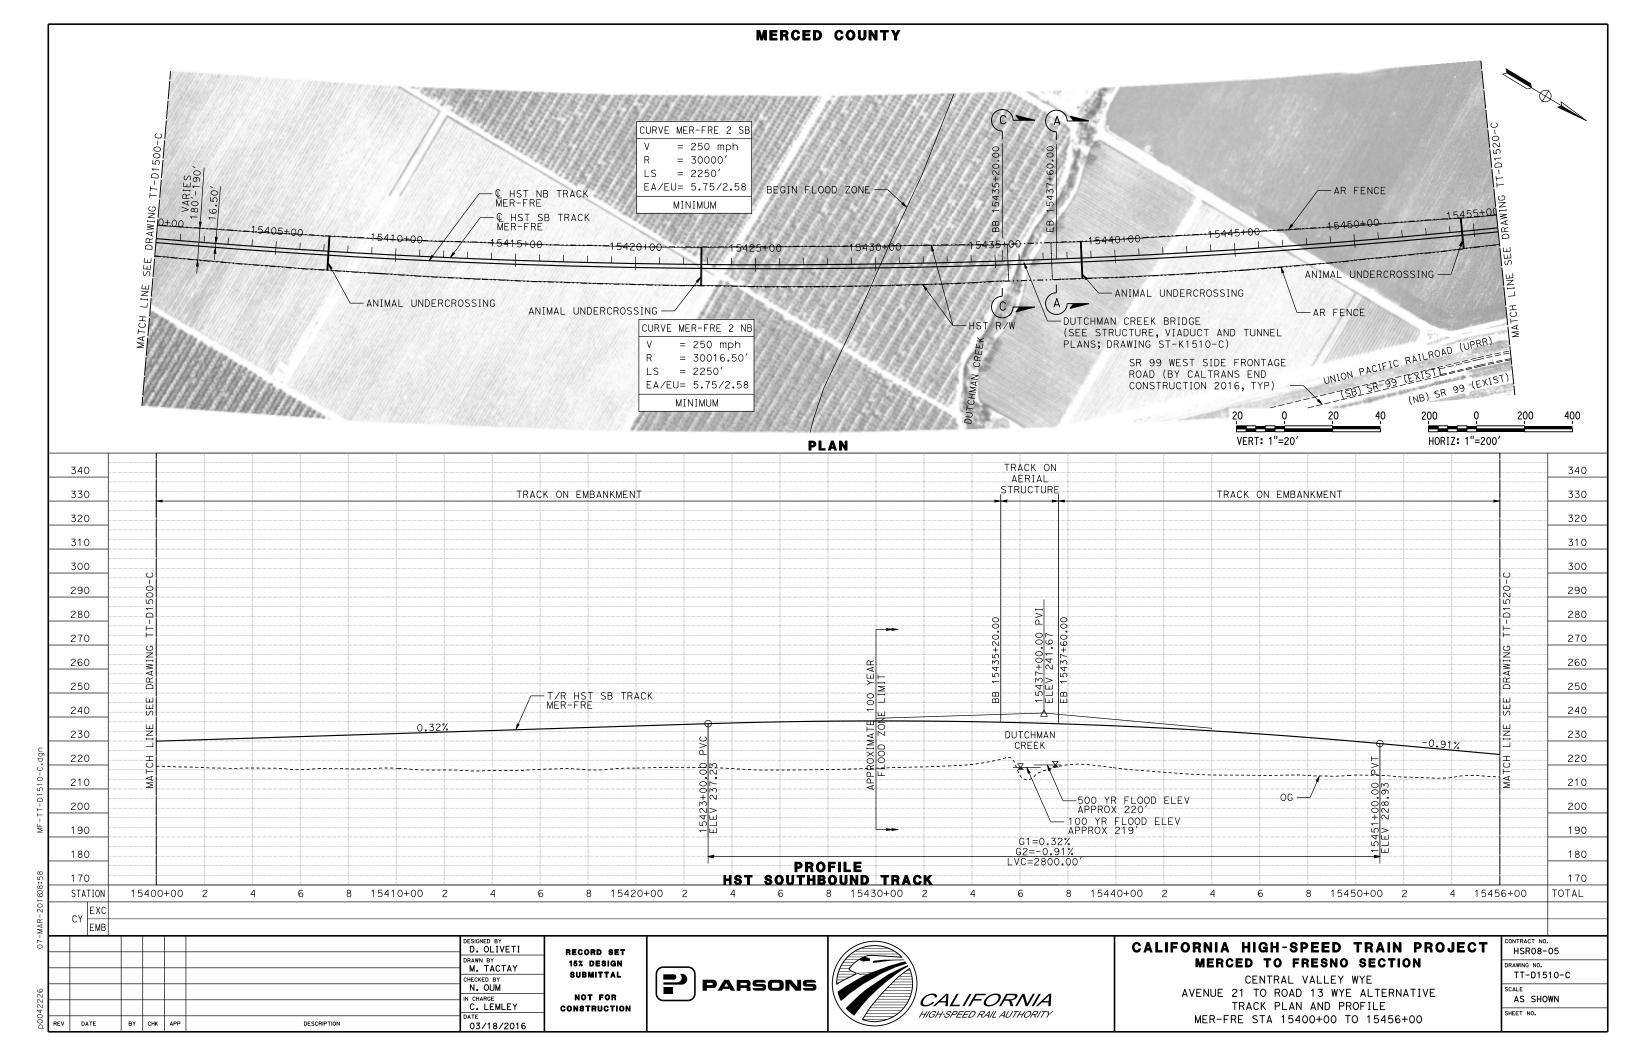


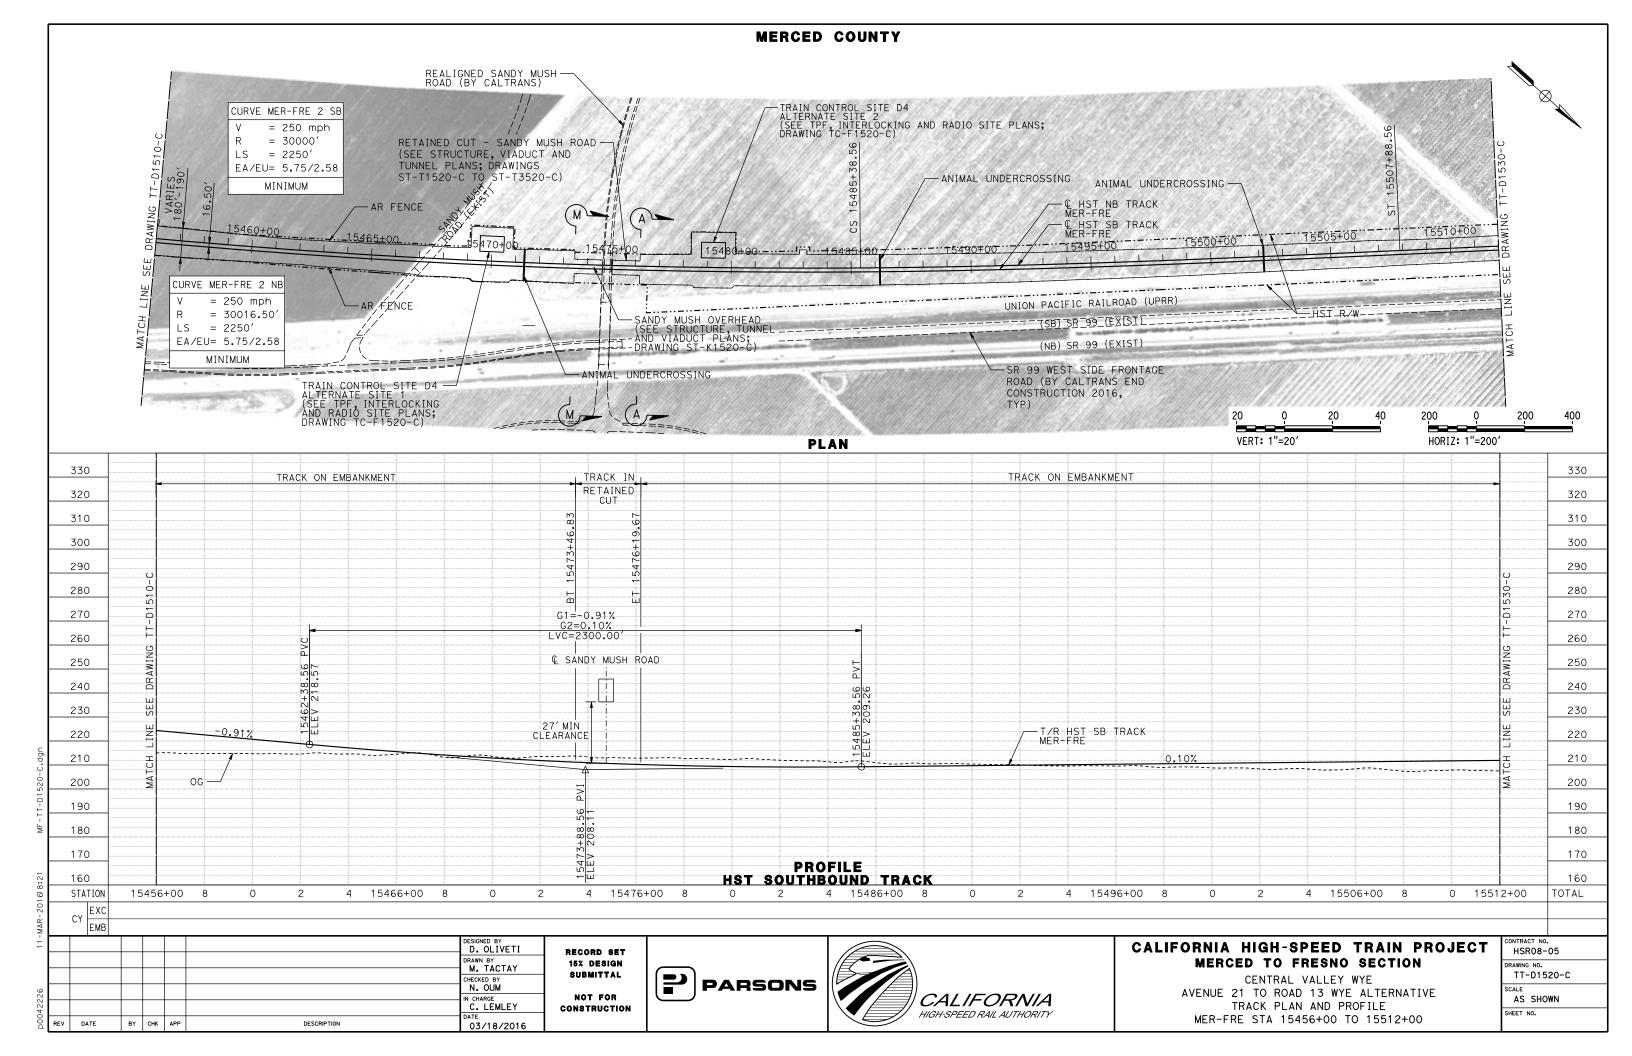


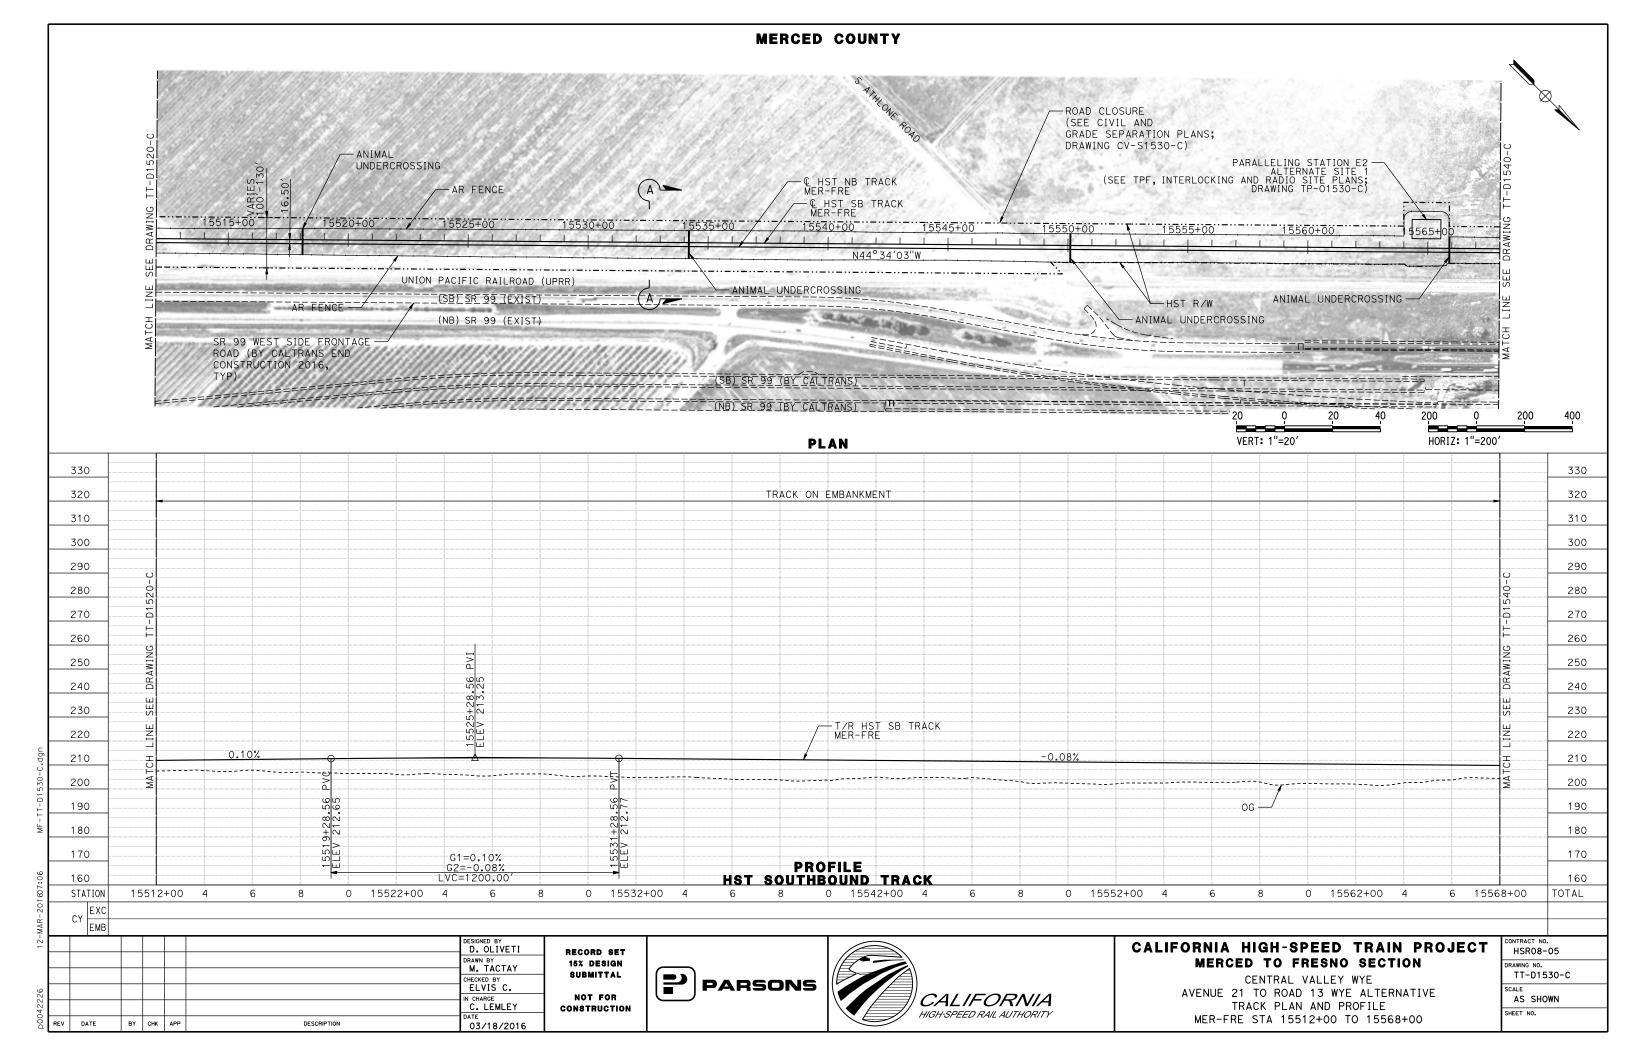


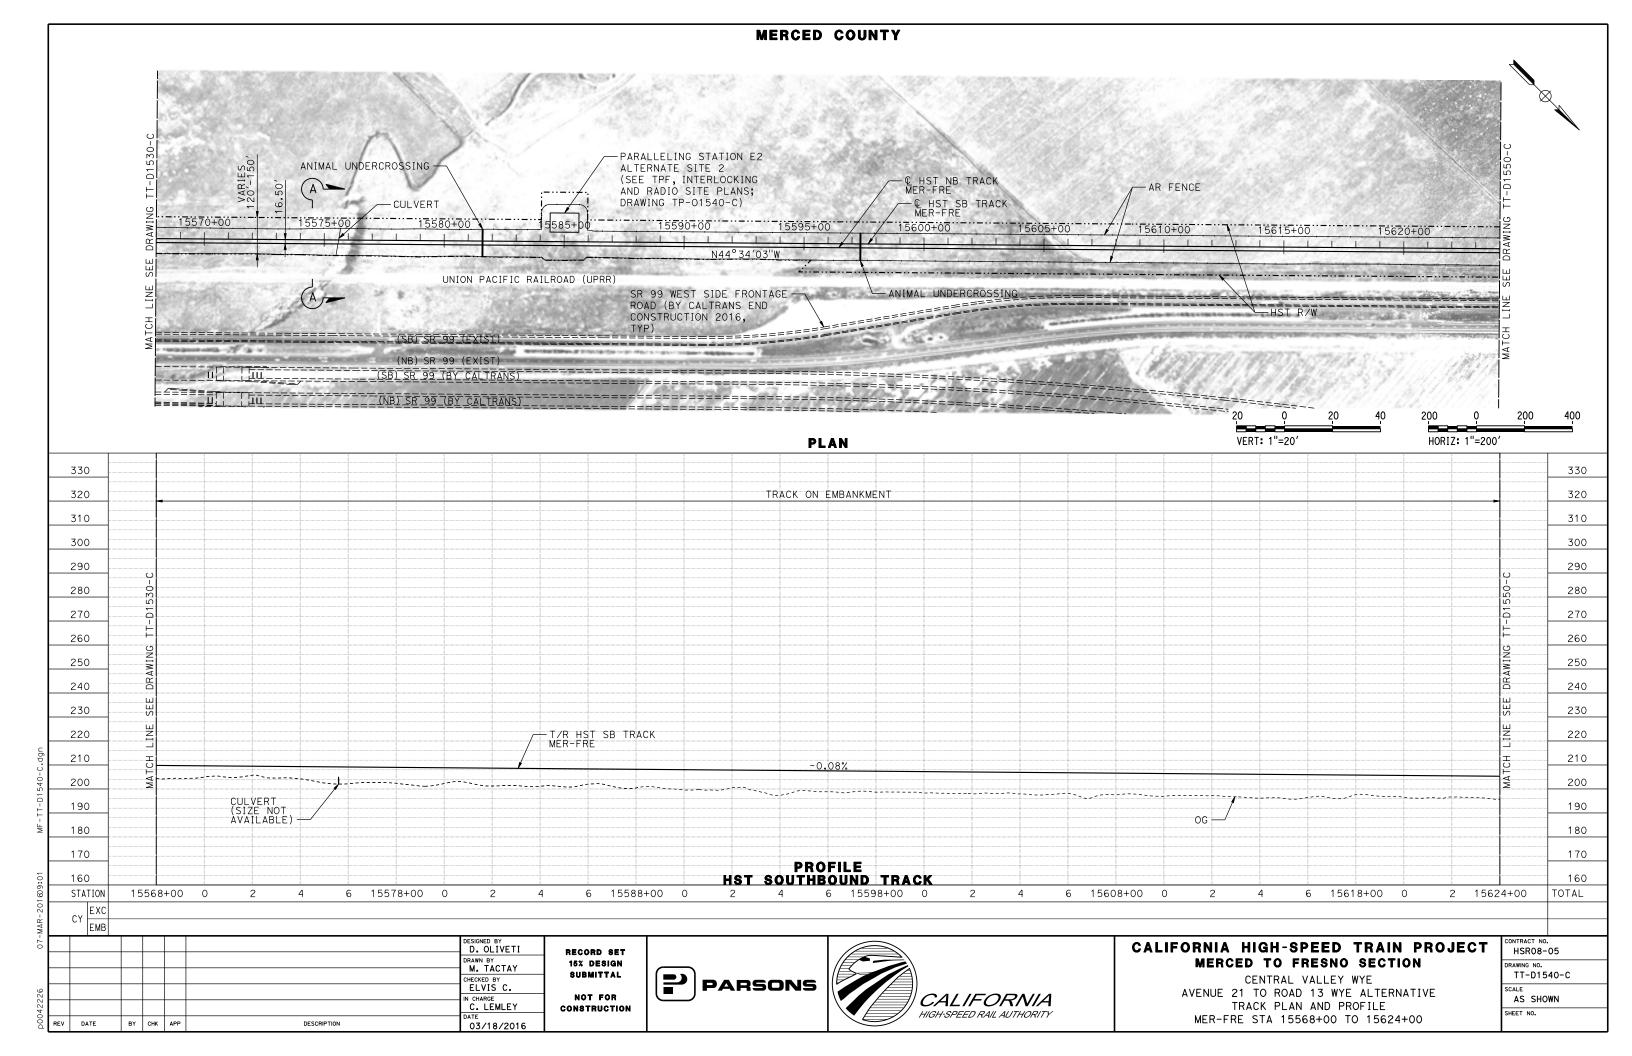


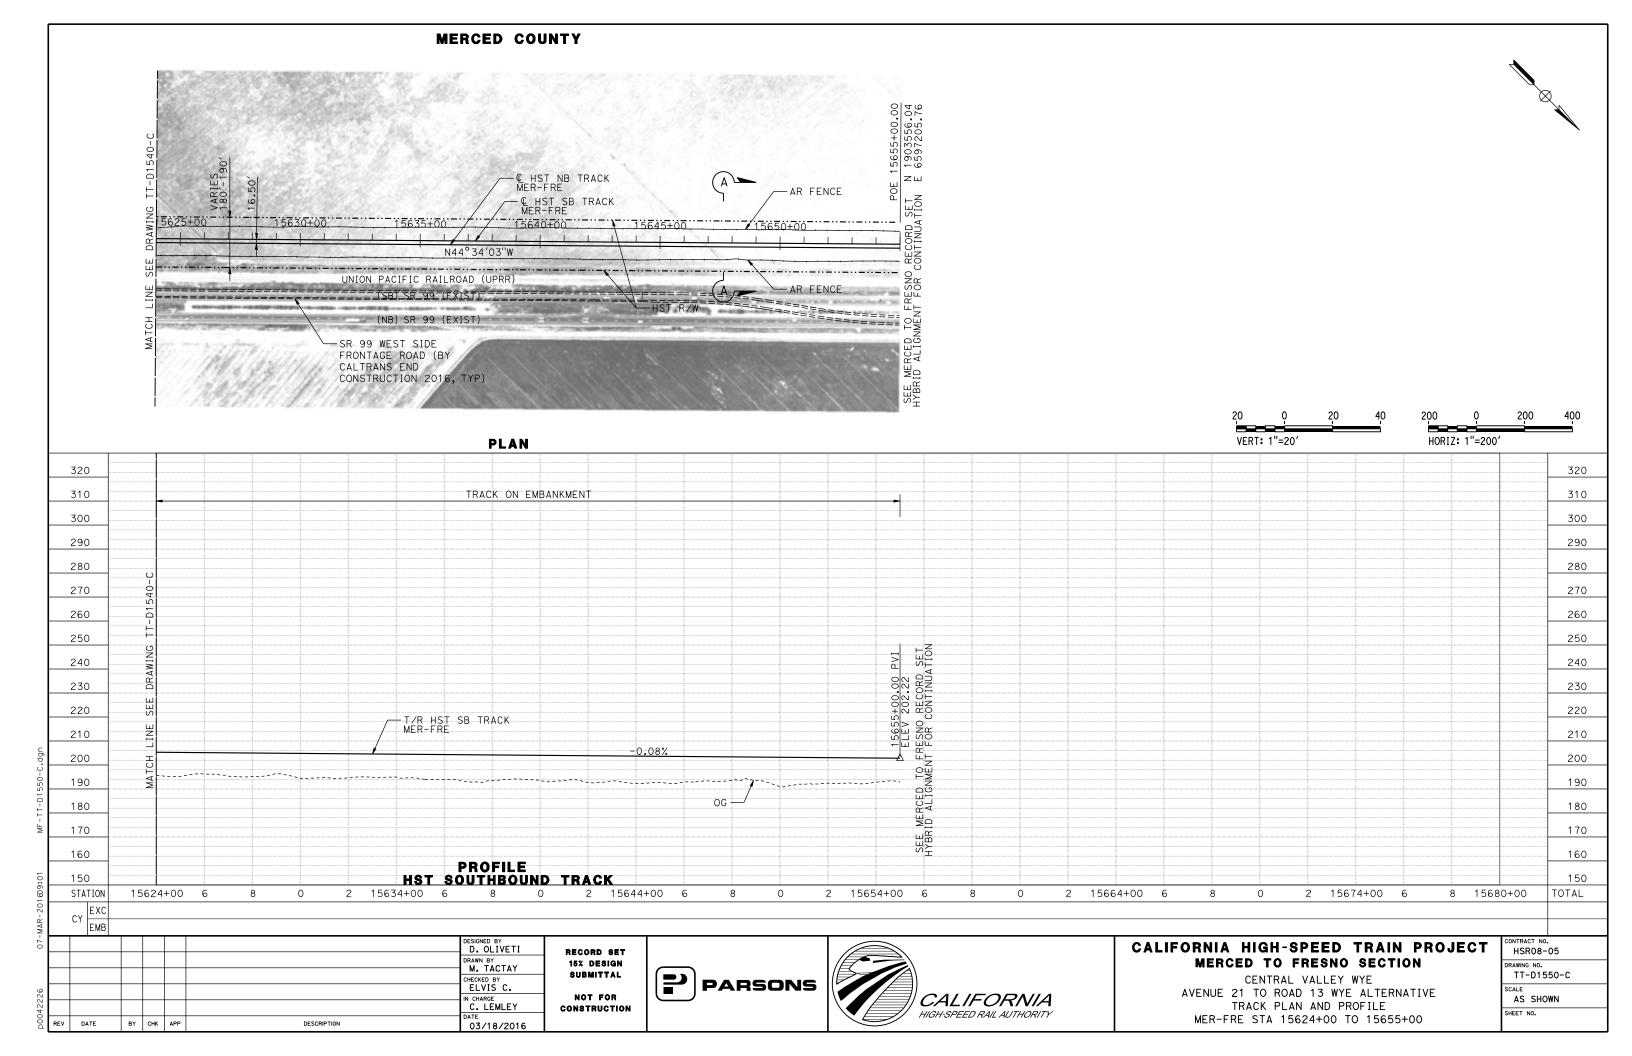


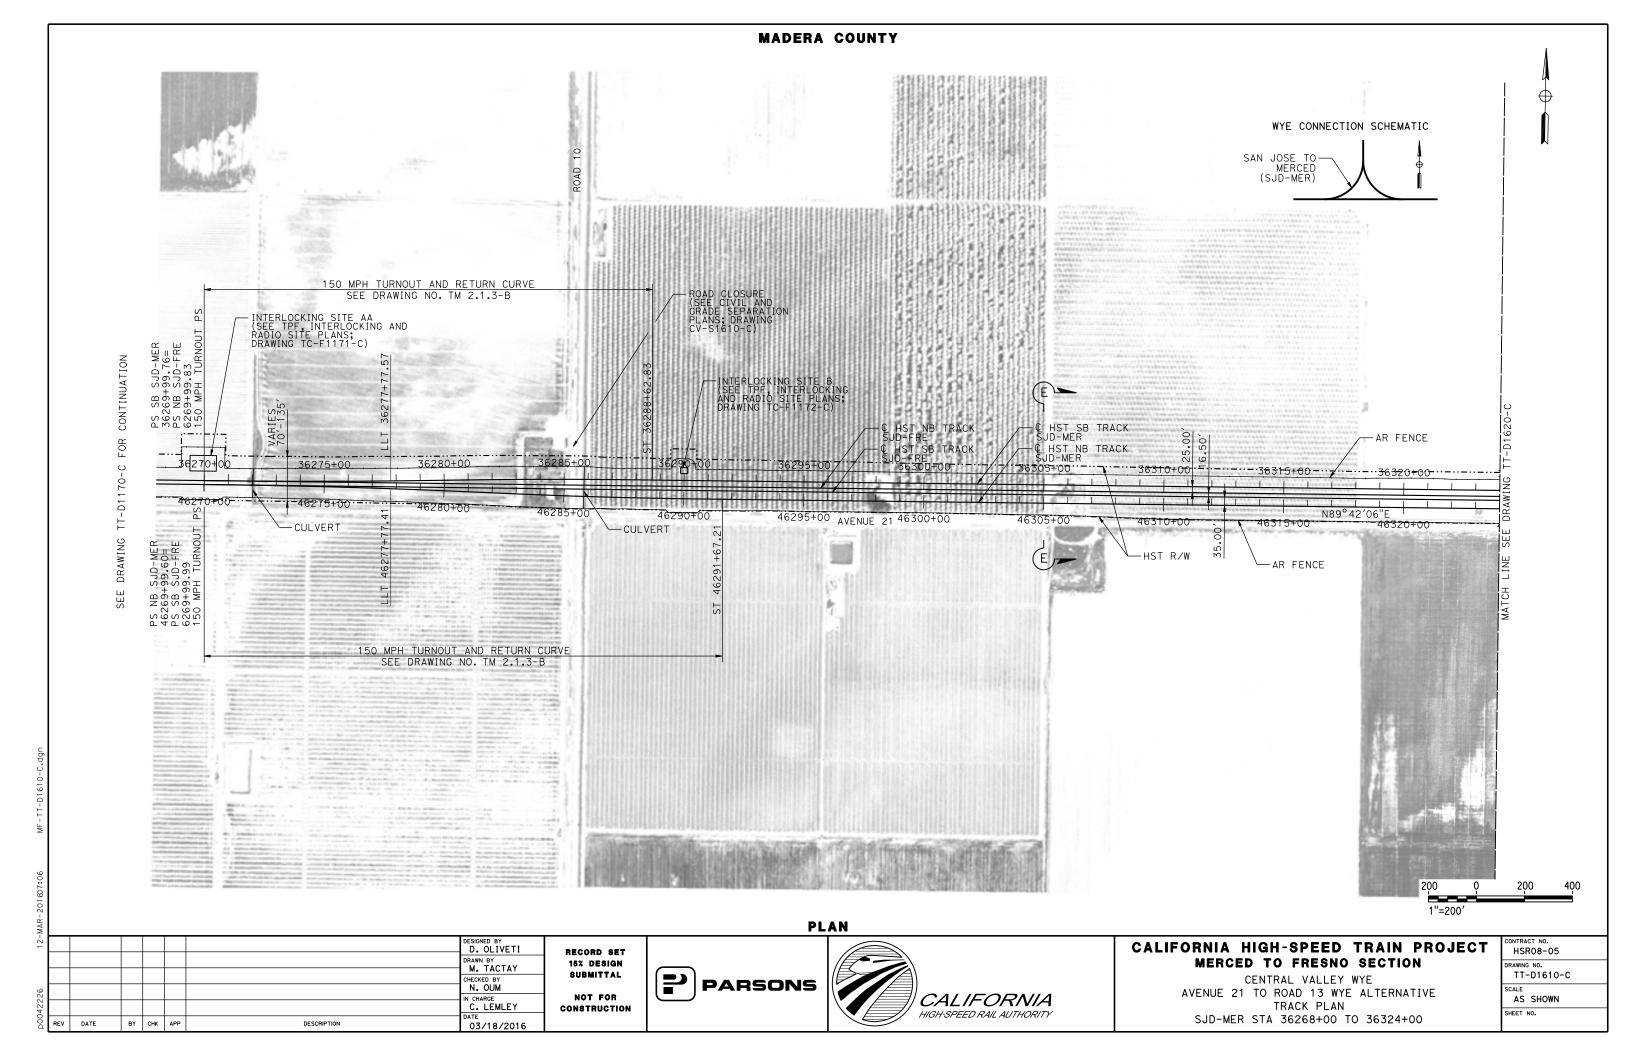


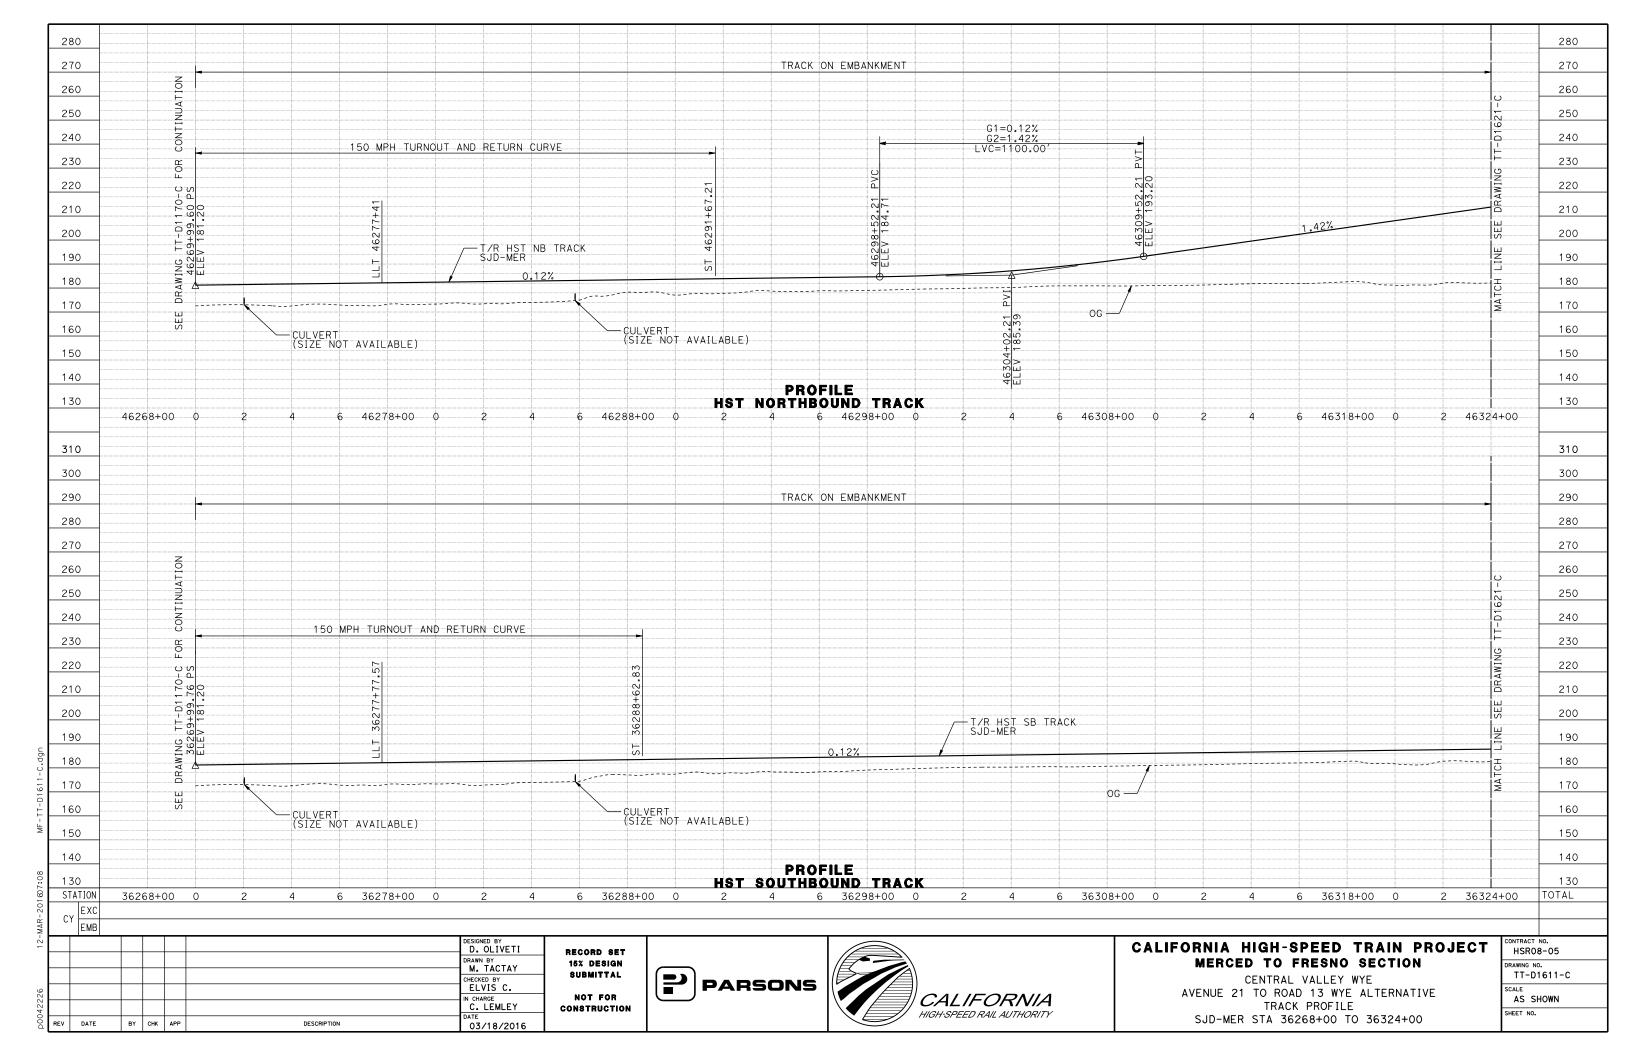


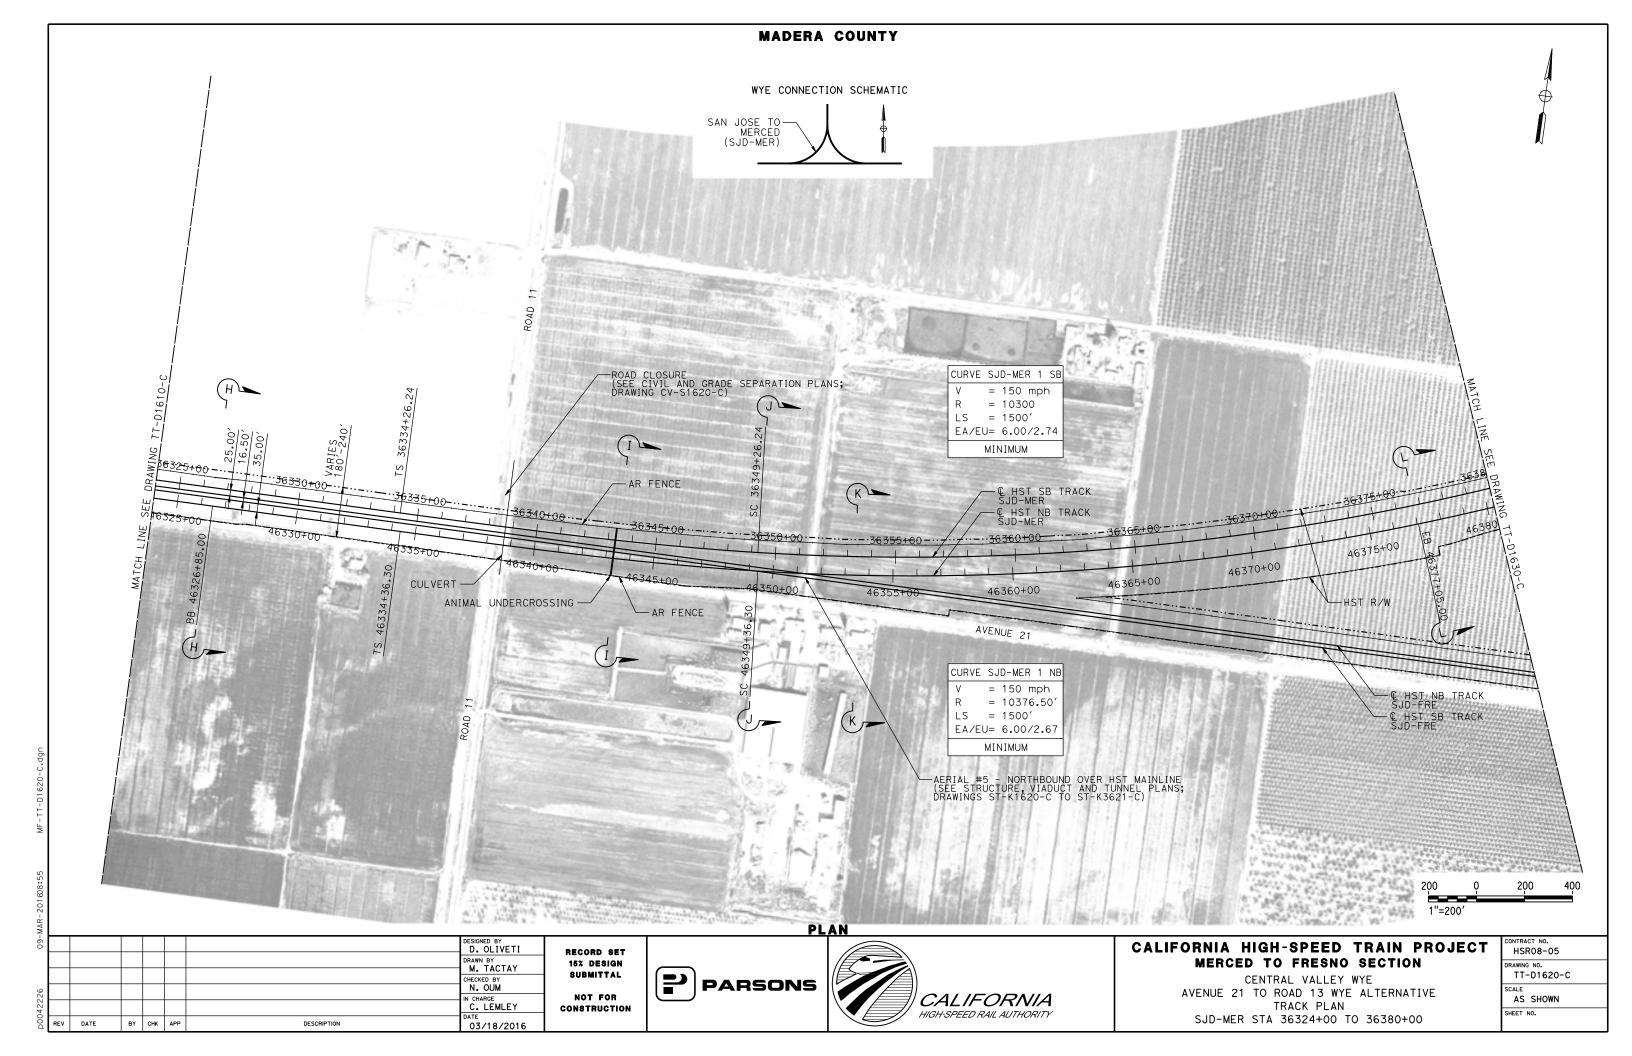


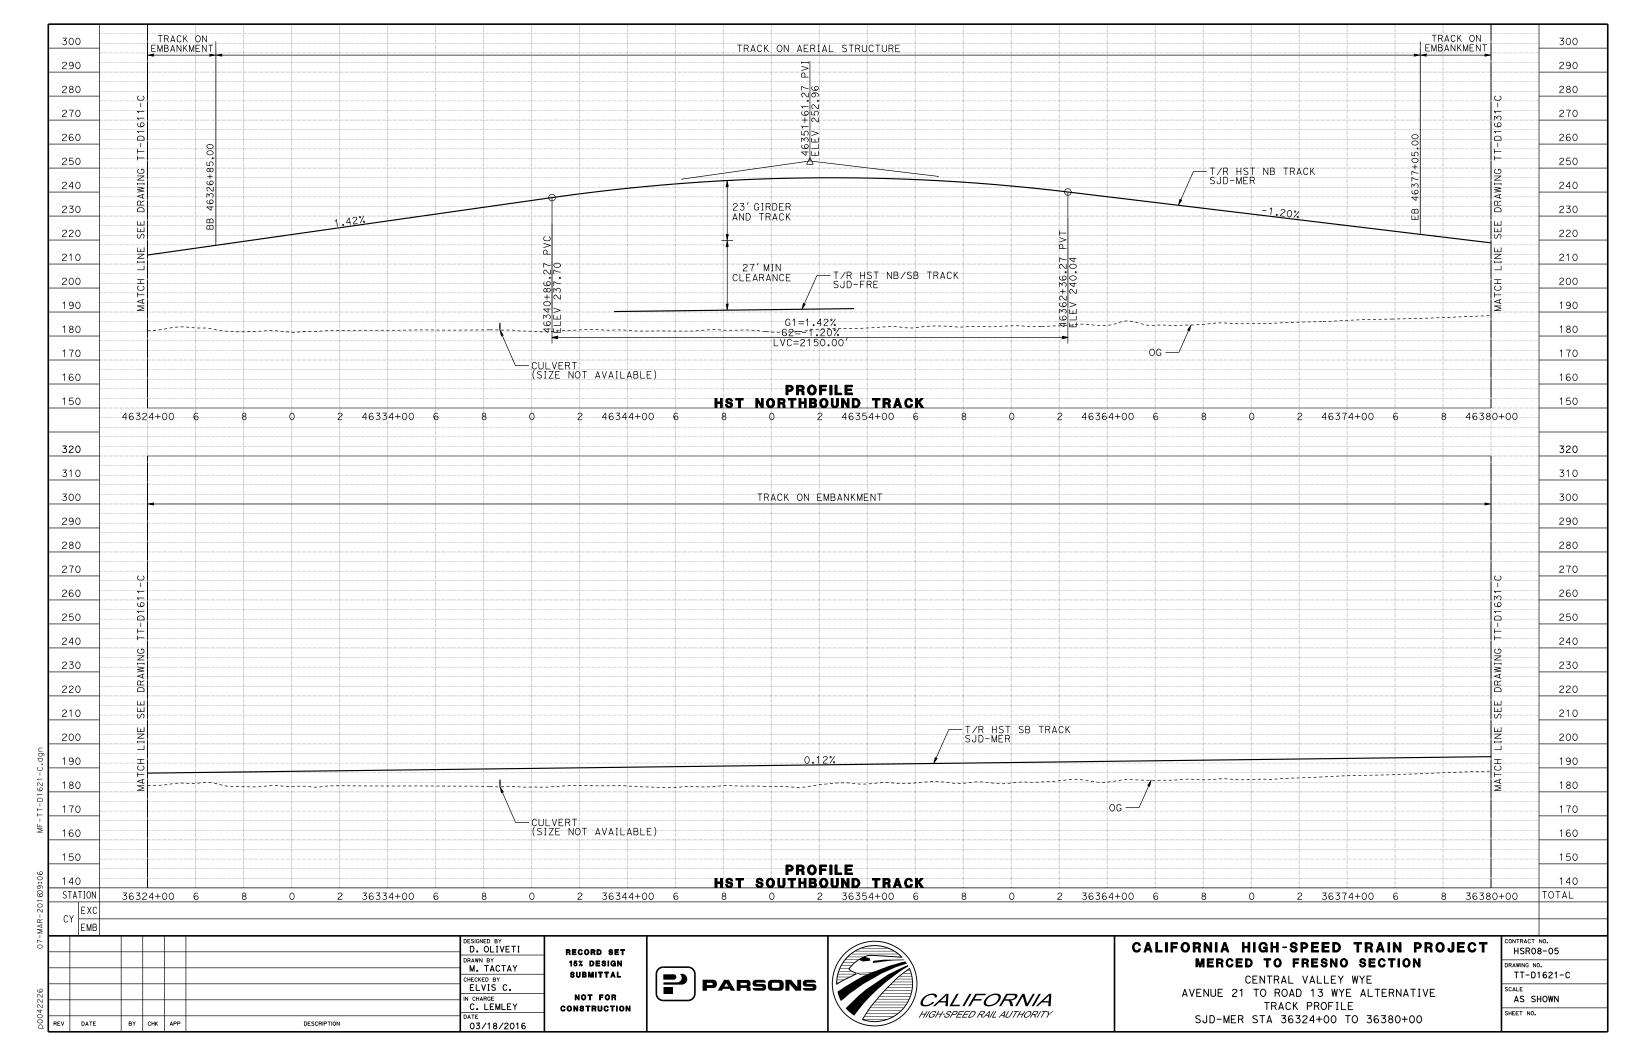


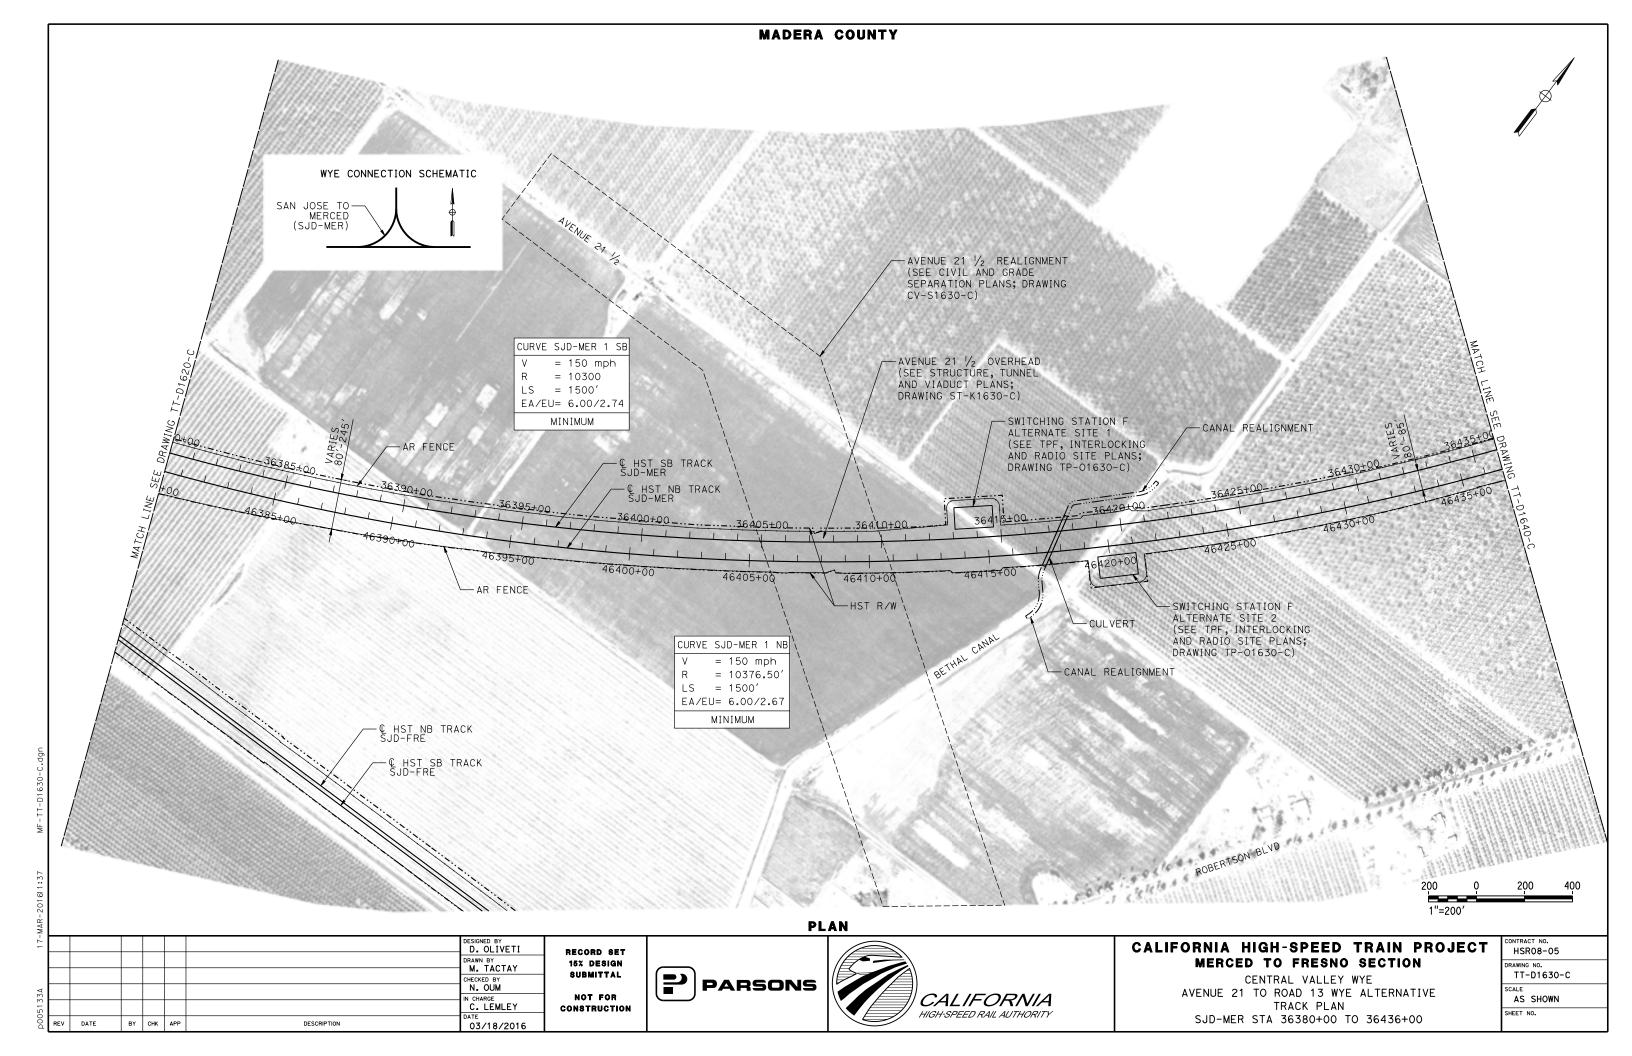


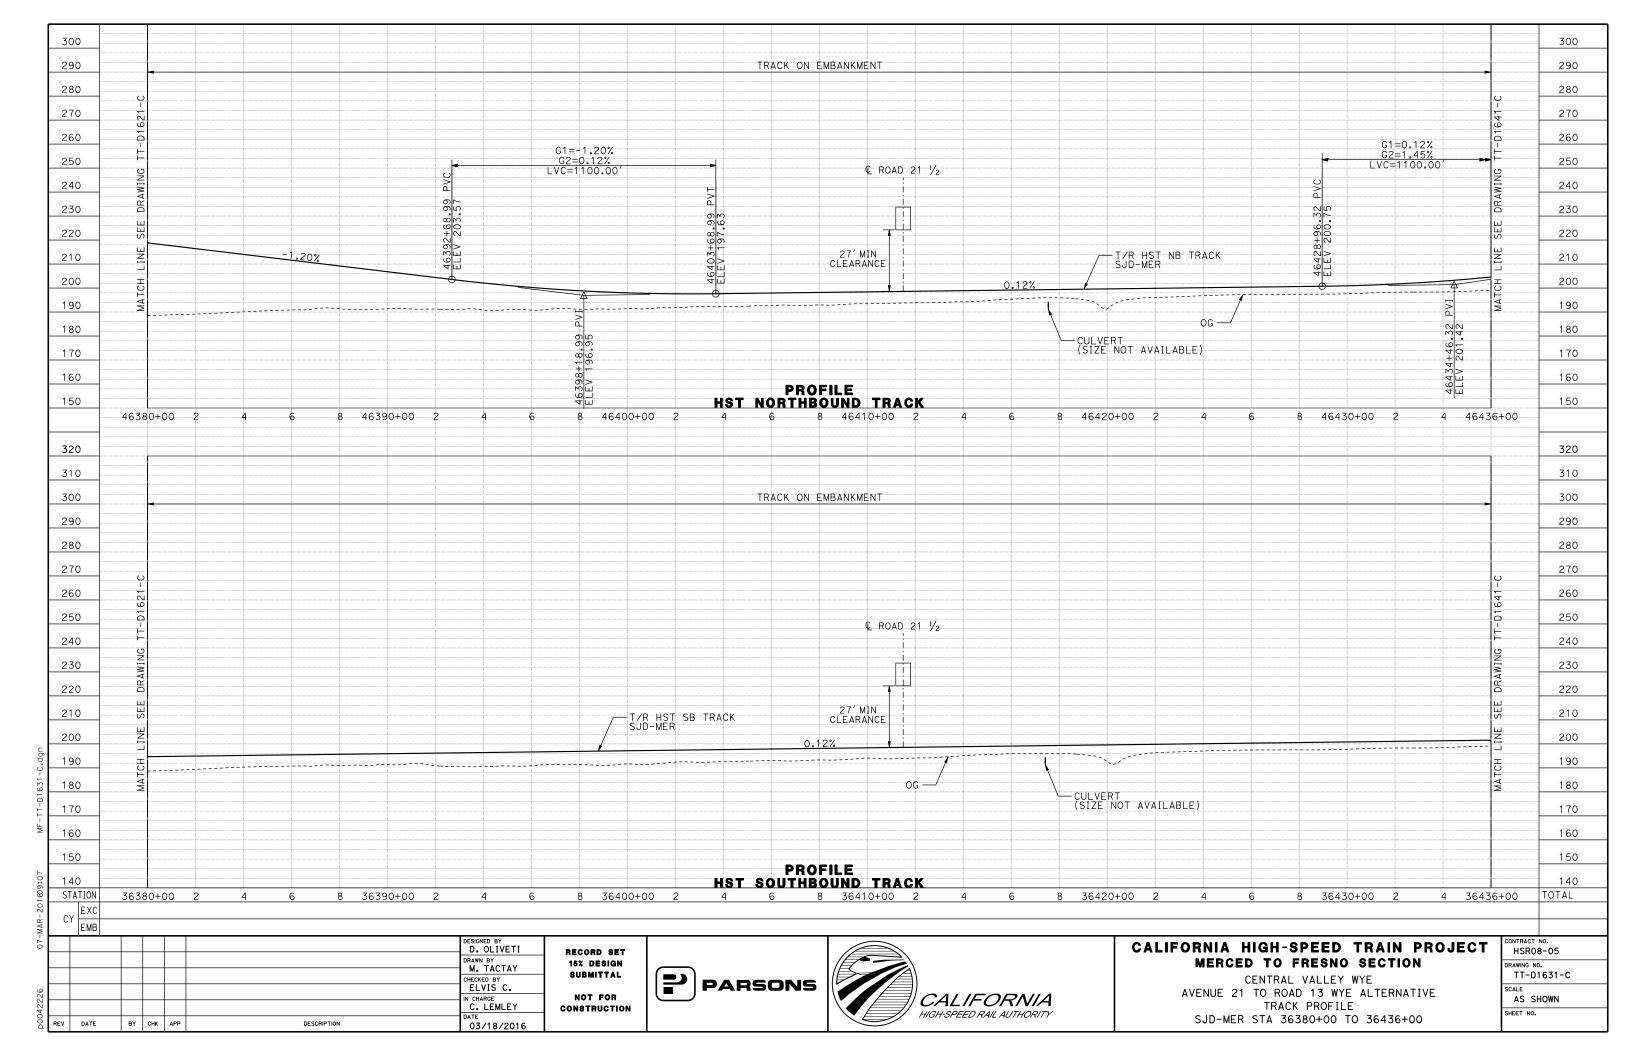


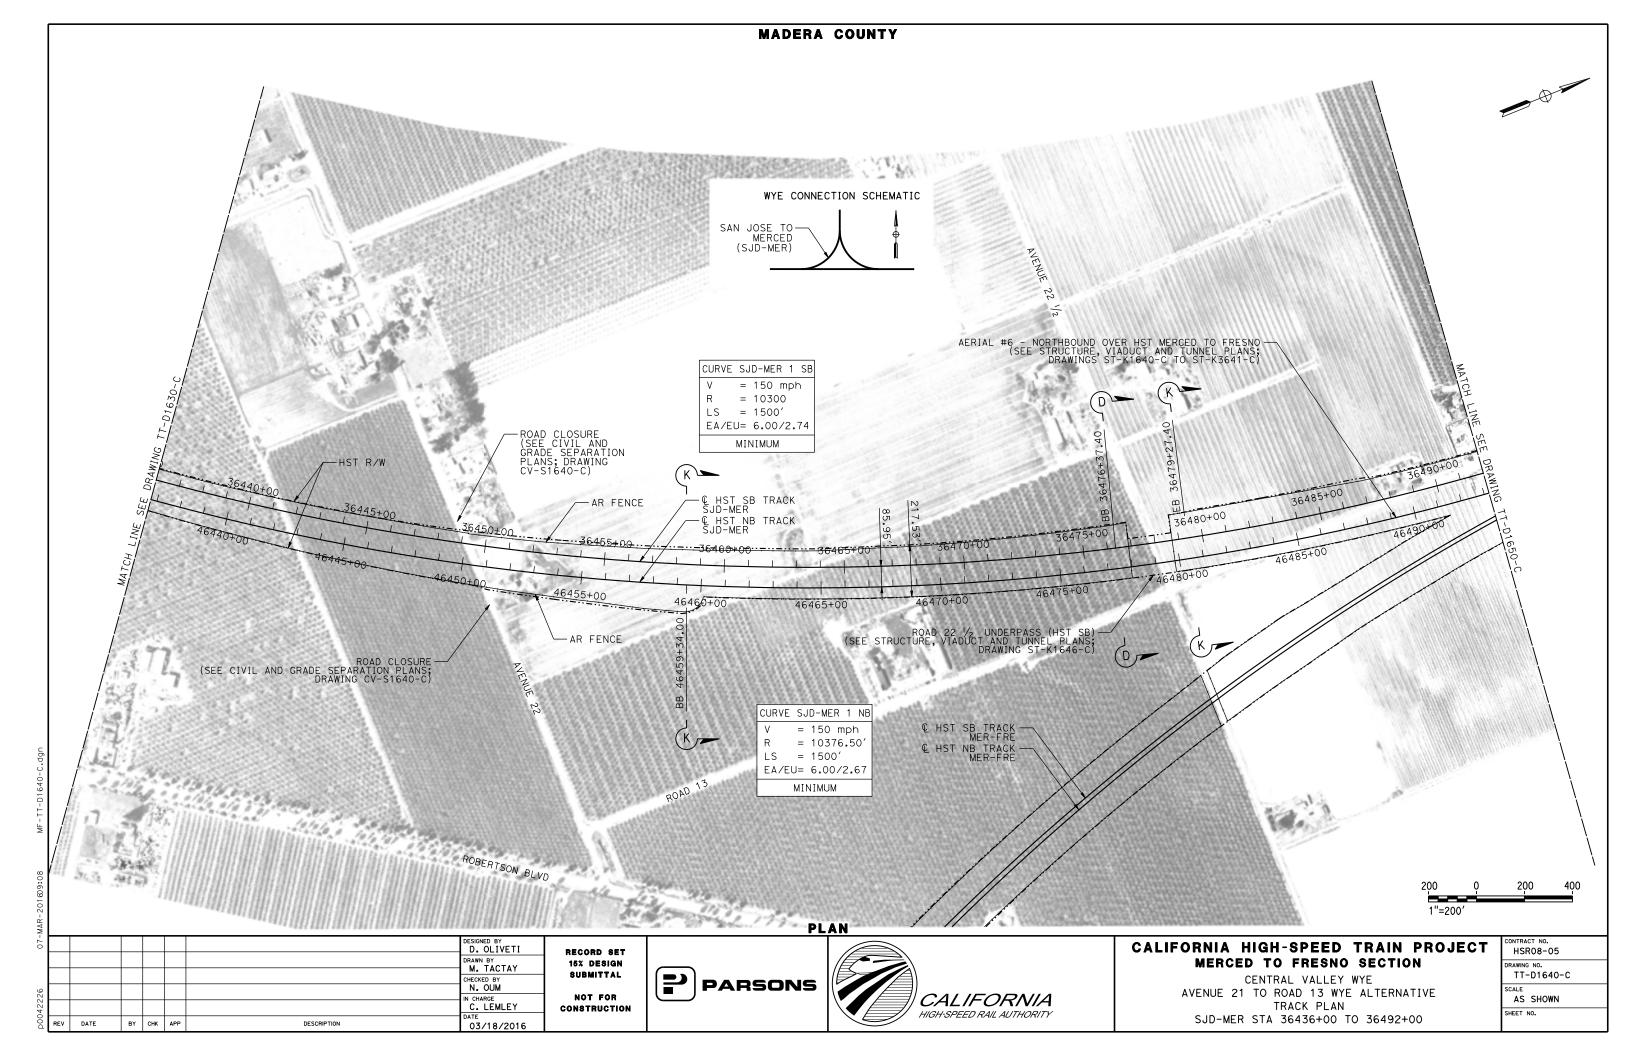

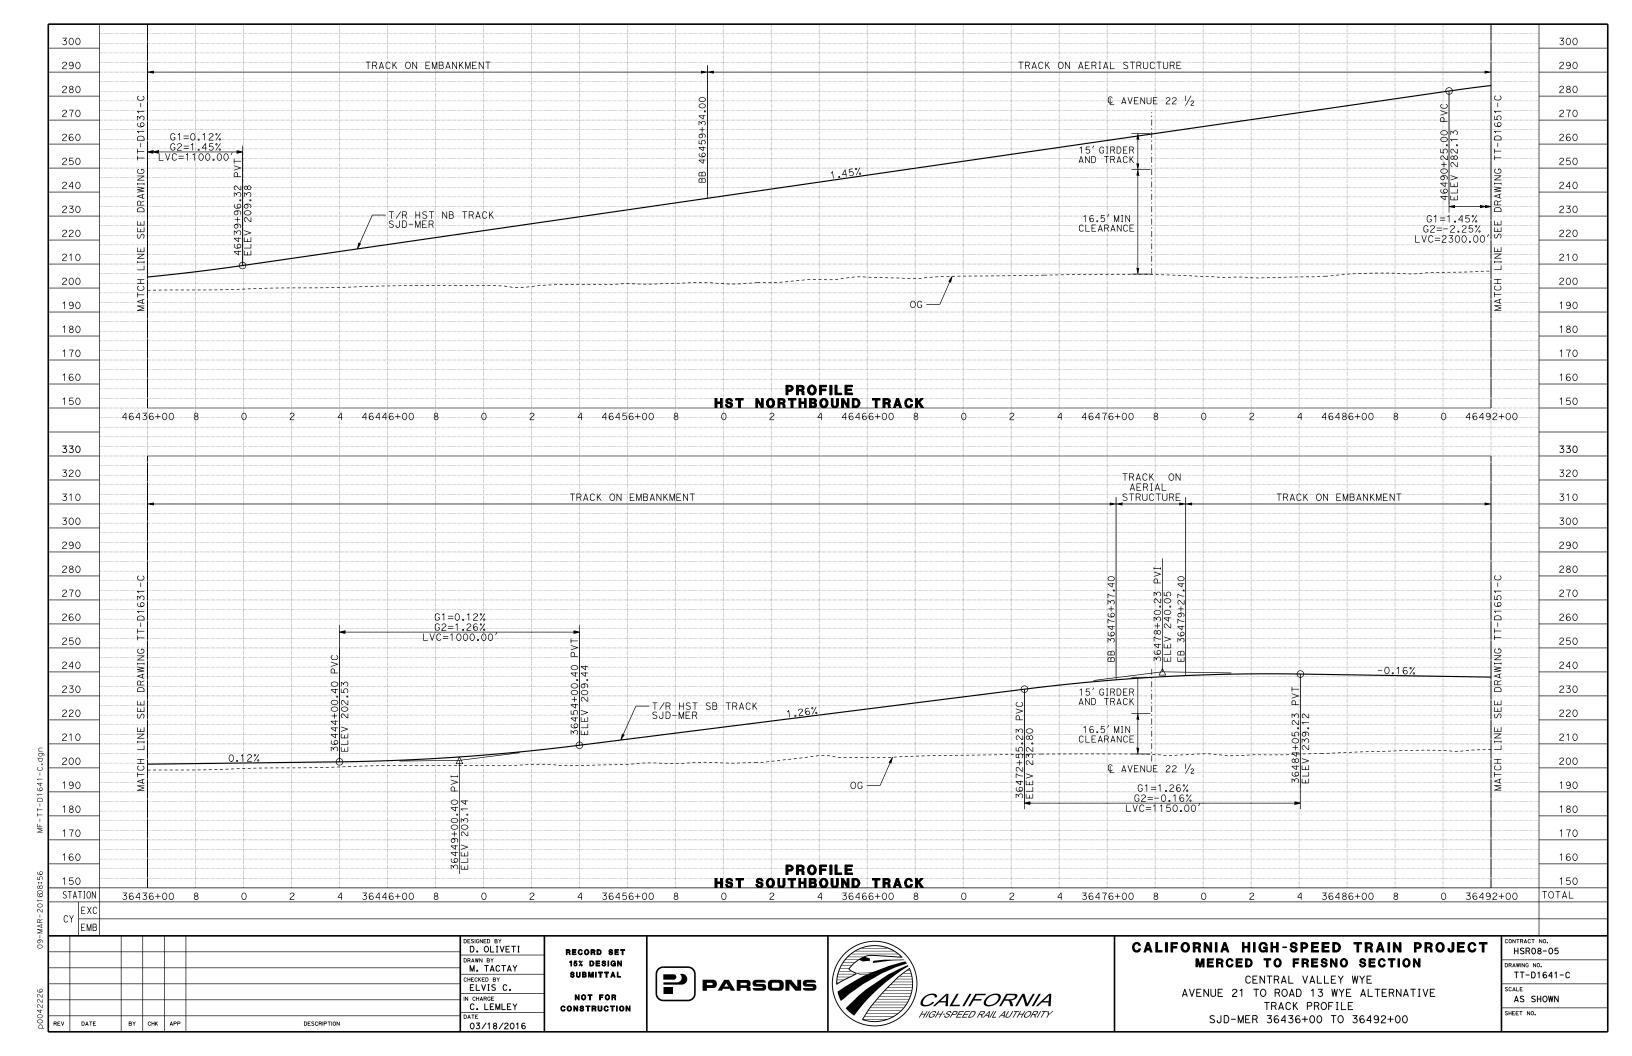

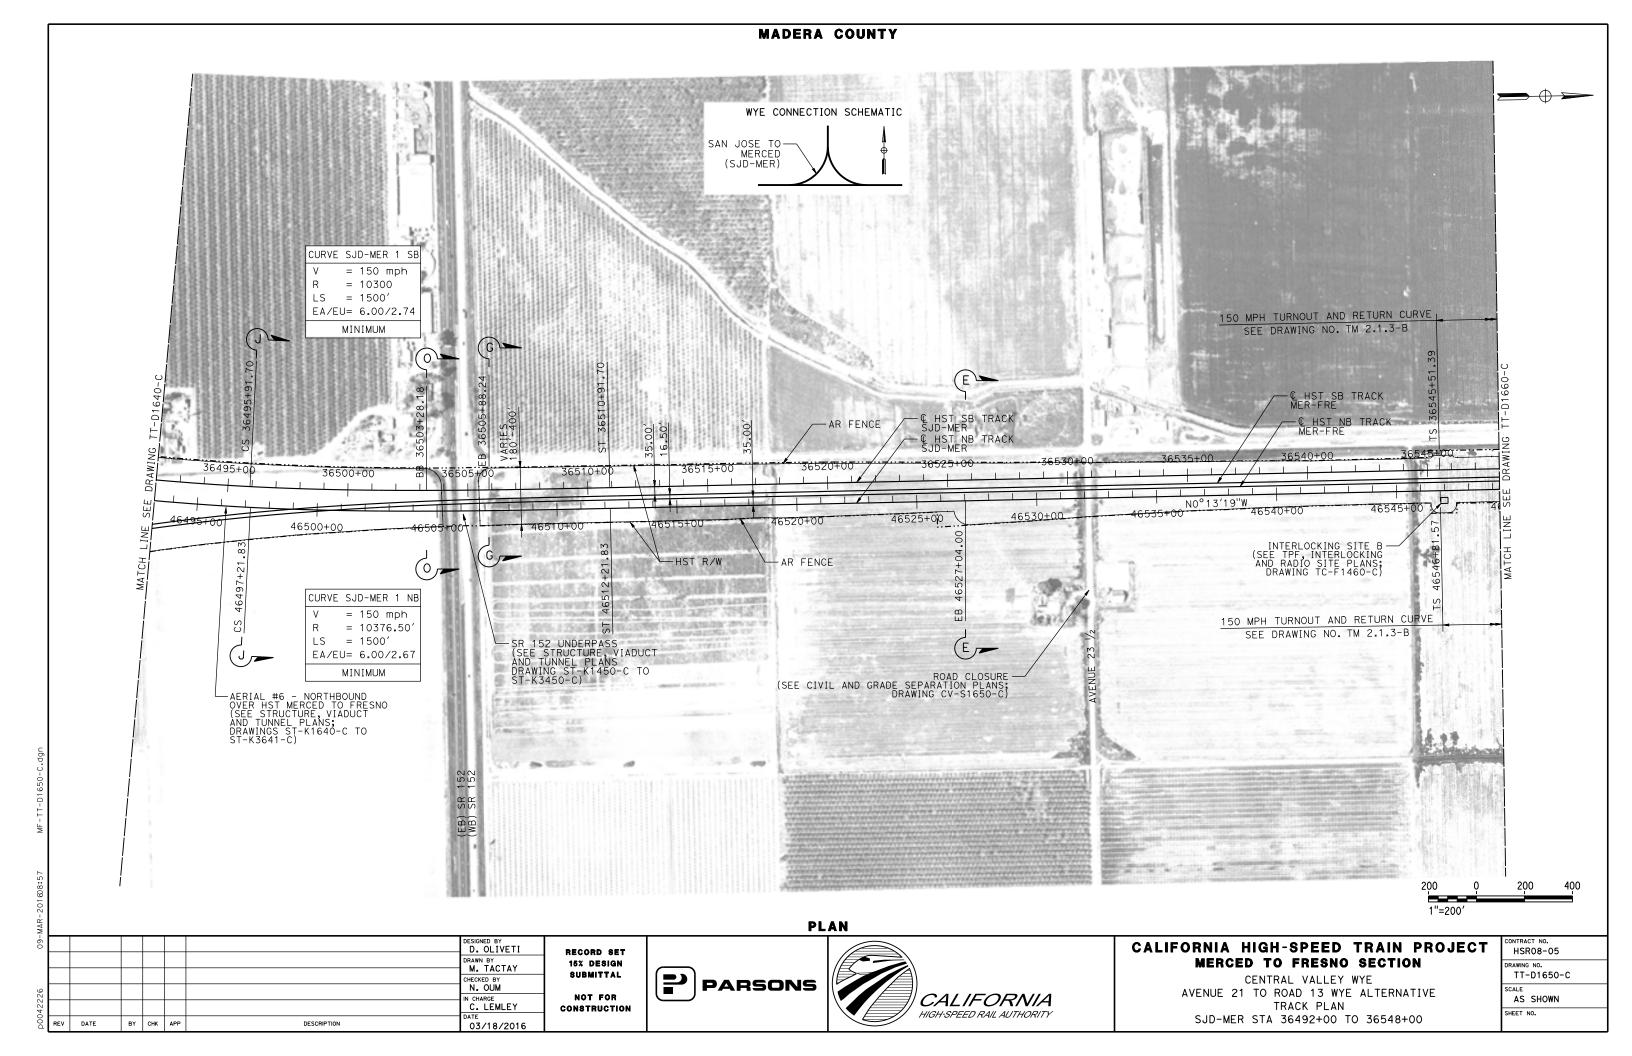

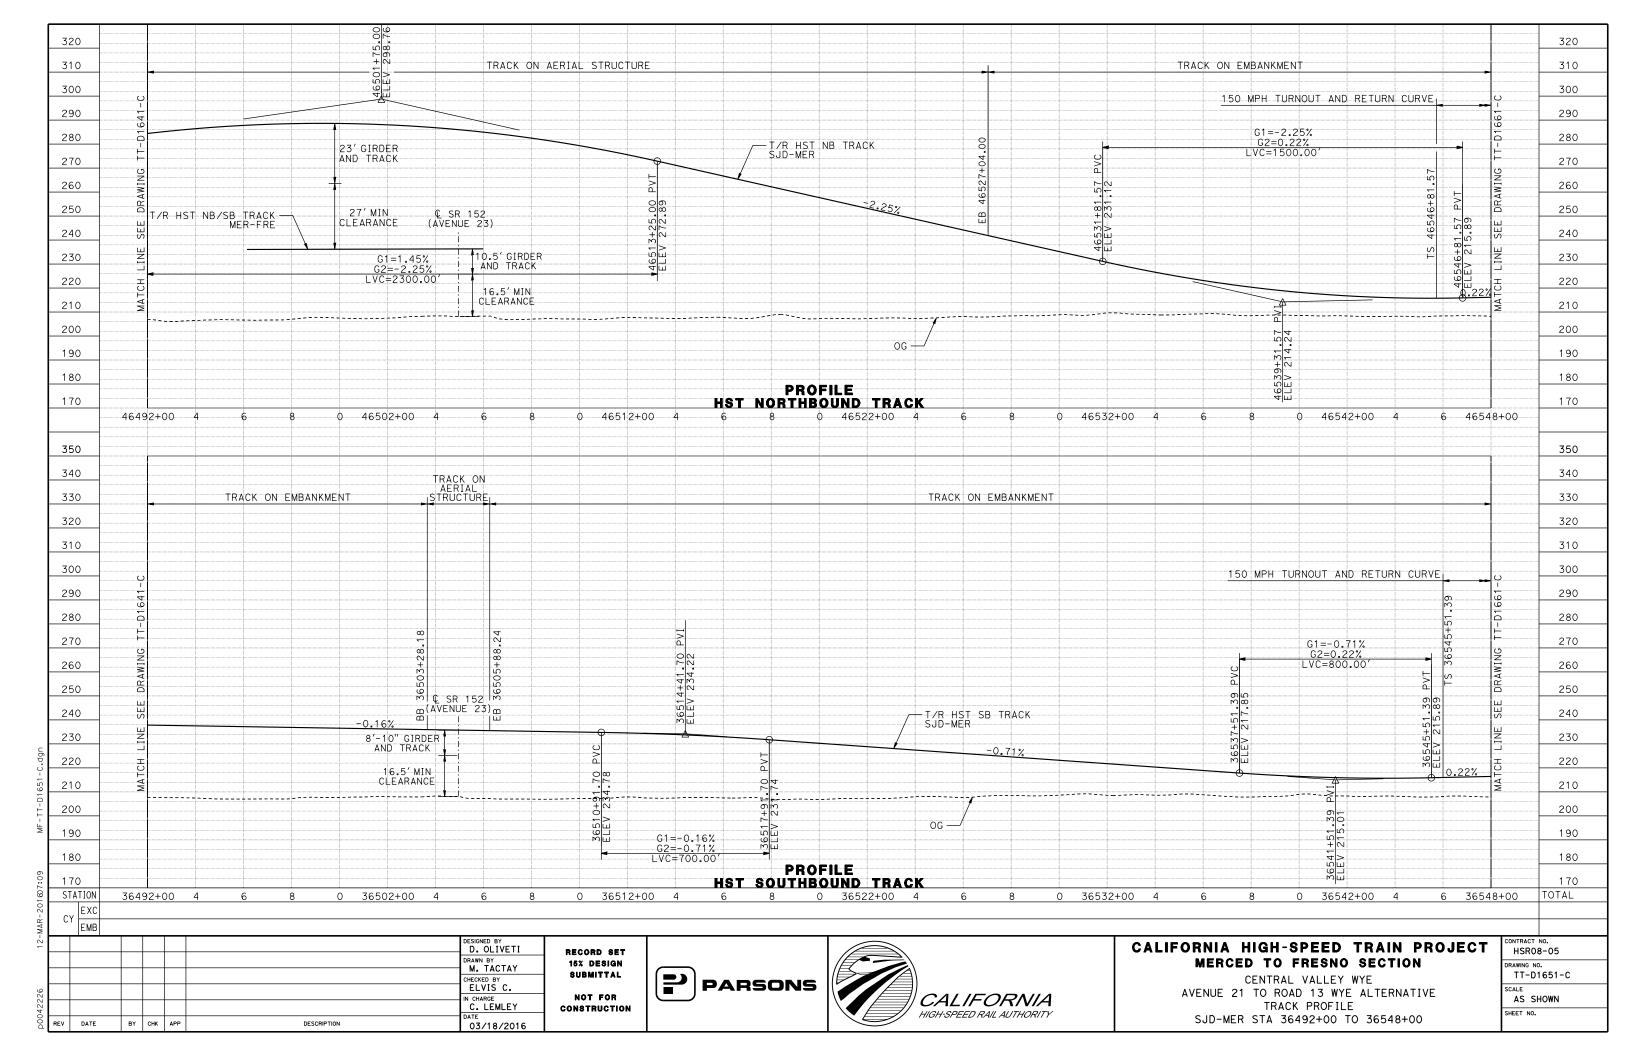

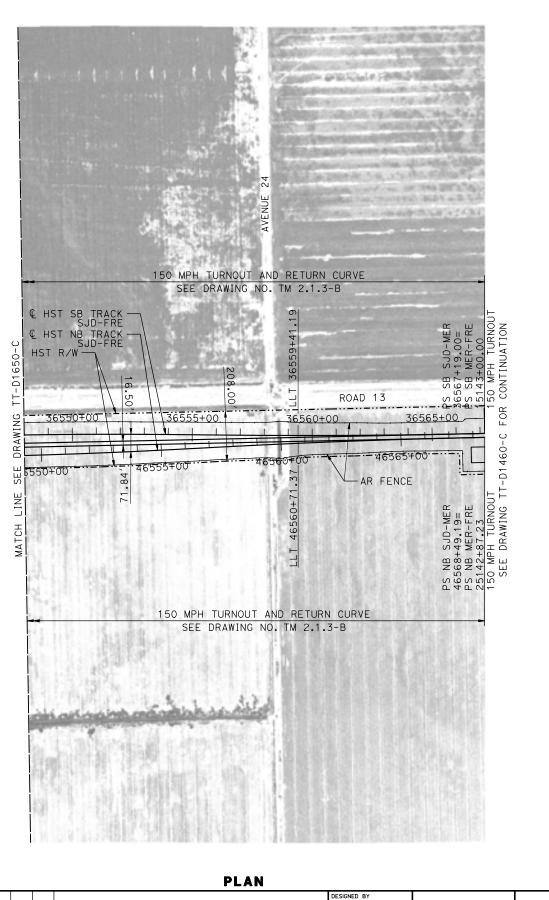

MADERA COUNTY

WYE CONNECTION SCHEMATIC

SAN JOSE TO MERCED (SJD-MER)



200 0 200 400

RECORD SET
15% DESIGN
SUBMITTAL
NOT FOR
CONSTRUCTION





## CALIFORNIA HIGH-SPEED TRAIN PROJECT MERCED TO FRESNO SECTION

CENTRAL VALLEY WYE
AVENUE 21 TO ROAD 13 WYE ALTERNATIVE
TRACK PLAN
SJD-MER STA 36548+00 TO 36604+00

ONTRACT NO. HSRO8-05
RAWING NO.
TT-D1660-C
CALE
AS SHOWN
HEET NO.

