


Merced to Fresno Section: Central Valley Wye

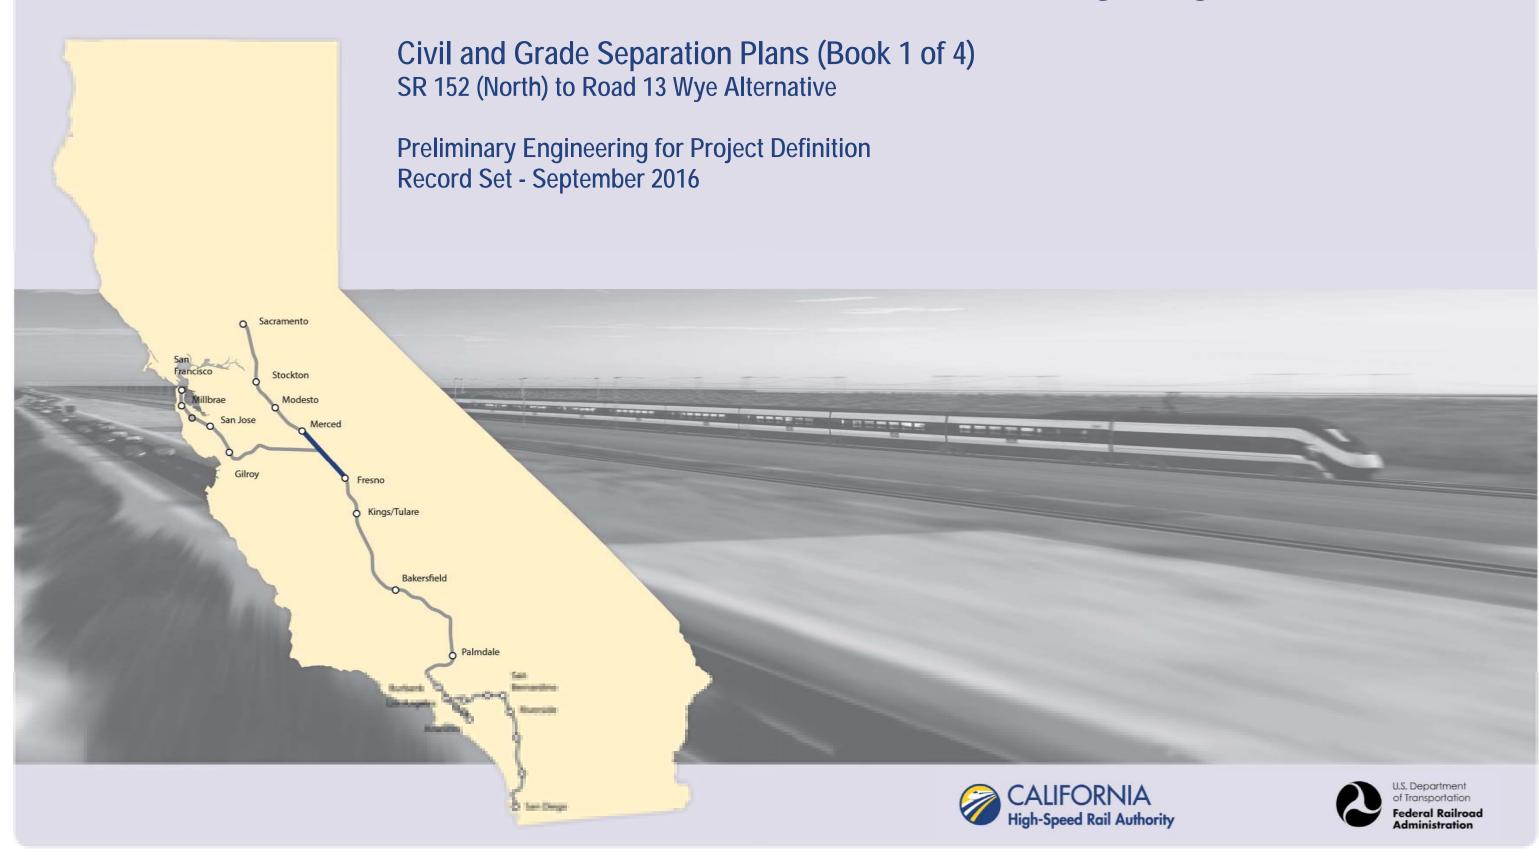

DRAWING NO.

SECTION

REV DATE

BY CHK APP

DESCRIPTION

	,			GENERAL	
CV-B0001	CENTRAL VALLEY WYE	CIVIL AND GRADE SEPARATION	ON PLANS	COVER	
CV-B0002	CENTRAL VALLEY WYE	CIVIL AND GRADE SEPARATION	ON PLANS	INDEX OF DRAWINGS	SHEET 1 OF 17
CV-B0003	CENTRAL VALLEY WYE	CIVIL AND GRADE SEPARATION	ON PLANS	INDEX OF DRAWINGS	SHEET 2 OF 17
CV-B0004	CENTRAL VALLEY WYE	CIVIL AND GRADE SEPARATION	ON PLANS	INDEX OF DRAWINGS	SHEET 3 OF 17
CV-B0005	CENTRAL VALLEY WYE	CIVIL AND GRADE SEPARATION	ON PLANS	INDEX OF DRAWINGS	SHEET 4 OF 17
CV-B0006	CENTRAL VALLEY WYE	CIVIL AND GRADE SEPARATION	ON PLANS	INDEX OF DRAWINGS	SHEET 5 OF 17
CV-B0007	CENTRAL VALLEY WYE	CIVIL AND GRADE SEPARATION	ON PLANS	INDEX OF DRAWINGS	SHEET 6 OF 17
CV-B0008	CENTRAL VALLEY WYE	CIVIL AND GRADE SEPARATION	ON PLANS	INDEX OF DRAWINGS	SHEET 7 OF 17
CV-B0009	CENTRAL VALLEY WYE	CIVIL AND GRADE SEPARATION	ON PLANS	INDEX OF DRAWINGS	SHEET 8 OF 17
CV-B0010	CENTRAL VALLEY WYE	CIVIL AND GRADE SEPARATION	ON PLANS	INDEX OF DRAWINGS	SHEET 9 OF 17
CV-B0011	CENTRAL VALLEY WYE	CIVIL AND GRADE SEPARATION	ON PLANS	INDEX OF DRAWINGS	SHEET 10 OF 17
CV-B0012	CENTRAL VALLEY WYE	CIVIL AND GRADE SEPARATION	ON PLANS	INDEX OF DRAWINGS	SHEET 11 OF 17
CV-B0013	CENTRAL VALLEY WYE	CIVIL AND GRADE SEPARATION	ON PLANS	INDEX OF DRAWINGS	SHEET 12 OF 17
CV-B0014	CENTRAL VALLEY WYE	CIVIL AND GRADE SEPARATION	ON PLANS	INDEX OF DRAWINGS	SHEET 13 OF 17
CV-B0015	CENTRAL VALLEY WYE	CIVIL AND GRADE SEPARATION	ON PLANS	INDEX OF DRAWINGS	SHEET 14 OF 17
CV-B0016	CENTRAL VALLEY WYE	CIVIL AND GRADE SEPARATION	ON PLANS	INDEX OF DRAWINGS	SHEET 15 OF 17
CV-B0017	CENTRAL VALLEY WYE	CIVIL AND GRADE SEPARATION	ON PLANS	INDEX OF DRAWINGS	SHEET 16 OF 17
CV-B0018	CENTRAL VALLEY WYE	CIVIL AND GRADE SEPARATION	ON PLANS	INDEX OF DRAWINGS	SHEET 17 OF 17
CV-B0020	CENTRAL VALLEY WYE	CIVIL AND GRADE SEPARATION	ON PLANS	ABBREVIATIONS	SHEET 1 OF 2
CV-B0021	CENTRAL VALLEY WYE	CIVIL AND GRADE SEPARATION	ON PLANS	ABBREVIATIONS	SHEET 2 OF 2
CV-B4000	CENTRAL VALLEY WYE	CIVIL AND GRADE SEPARATION	ON PLANS	LOCATION PLAN	
CV-B0030	CENTRAL VALLEY WYE	CIVIL AND GRADE SEPARATION	ON PLANS	GENERAL NOTES	
			SR 152 (NORTH)	TO ROAD 13 WYE ALTERNATIVE	
V-B4050-A	CENTRAL VALLEY WYE	SR 152 (NORTH) TO ROAD 13 WYE	E ALTERNATIVE	KEY MAP	SHEET 1 OF 4
V-B4051-A	CENTRAL VALLEY WYE	SR 152 (NORTH) TO ROAD 13 WYE	E ALTERNATIVE	KEY MAP	SHEET 2 OF 4
V-B4052-A	CENTRAL VALLEY WYE	SR 152 (NORTH) TO ROAD 13 WYE	E ALTERNATIVE	KEY MAP	SHEET 3 OF 4
V-B4053-A	CENTRAL VALLEY WYE	SR 152 (NORTH) TO ROAD 13 WYE	E ALTERNATIVE	KEY MAP	SHEET 4 OF 4
V-B0060-A	CENTRAL VALLEY WYE	SR 152 (NORTH) TO ROAD 13 WYE	E ALTERNATIVE	GEOMETRY DATA TABLE	SHEET 1 OF 6
V-B0061-A	CENTRAL VALLEY WYE	SR 152 (NORTH) TO ROAD 13 WYE	E ALTERNATIVE	GEOMETRY DATA TABLE	SHEET 2 OF 6
V-B0062-A	CENTRAL VALLEY WYE	SR 152 (NORTH) TO ROAD 13 WYE	E ALTERNATIVE	GEOMETRY DATA TABLE	SHEET 3 OF 6
V-B0063-A	CENTRAL VALLEY WYE	SR 152 (NORTH) TO ROAD 13 WYE	E ALTERNATIVE	GEOMETRY DATA TABLE	SHEET 4 OF 6
CV-B0064-A	CENTRAL VALLEY WYE	SR 152 (NORTH) TO ROAD 13 WYE	E ALTERNATIVE	GEOMETRY DATA TABLE	SHEET 5 OF 6
V-B0065-A	CENTRAL VALLEY WYE	SR 152 (NORTH) TO ROAD 13 WYE	E ALTERNATIVE	GEOMETRY DATA TABLE	SHEET 6 OF 6
V-B0070-A	CENTRAL VALLEY WYE	SR 152 (NORTH) TO ROAD 13 WYE	E ALTERNATIVE	UTILITY CONFLICT TABLE	SHEET 1 OF 4
V-B0071-A	CENTRAL VALLEY WYE	SR 152 (NORTH) TO ROAD 13 WYE	E ALTERNATIVE	UTILITY CONFLICT TABLE	SHEET 2 OF 4
V-B0072-A	CENTRAL VALLEY WYE	SR 152 (NORTH) TO ROAD 13 WYE	E ALTERNATIVE	UTILITY CONFLICT TABLE	SHEET 3 OF 4
V-B0073-A	CENTRAL VALLEY WYE	SR 152 (NORTH) TO ROAD 13 WYE	E ALTERNATIVE	UTILITY CONFLICT TABLE	SHEET 4 OF 4
V-B0080-A	CENTRAL VALLEY WYE	SR 152 (NORTH) TO ROAD 13 WYE	E ALTERNATIVE	TYPICAL SECTION	SHEET 1 OF 3
CV-B0081-A	CENTRAL VALLEY WYE	SR 152 (NORTH) TO ROAD 13 WYE	E ALTERNATIVE	TYPICAL SECTION	SHEET 2 OF 3

PARSONS

CALIFORNIA HIGH-SPEED RAIL AUTHORITY

INDEX OF DRAWINGS

TITLE

ALIGNMENT / PLAN SET

DRAWN BY
W. JOHNSEN

IN CHARGE
C. LEMLEY

DATE 09/09/2016

CHECKED BY

15% DESIGN

SUBMITTAL

NOT FOR

CONSTRUCTION

CALIFORNIA HIGH-SPEED TRAIN PROJECT MERCED TO FRESNO SECTION

DESCRIPTION

CENTRAL VALLEY WYE
CIVIL AND GRADE SEPARATION PLANS
INDEX OF DRAWINGS
SHEET 1 OF 17

CONTRACT NO.
HSR08-05
DRAWING NO.
CV-B0002
SCALE
NO SCALE
SHEET NO.

RECORD SET
15% DESIGN
SUBMITTAL
NOT FOR
CONSTRUCTION





CALIFORNIA HIGH-SPEED TRAIN PROJECT MERCED TO FRESNO SECTION

CENTRAL VALLEY WYE
CIVIL AND GRADE SEPARATION PLANS
INDEX OF DRAWINGS
SHEET 2 OF 17

CONTRACT NO. HSRO8-05	
DRAWING NO. CV-B0003	
NO SCALE	
SHEET NO.	

RECORD SET
15% DESIGN
SUBMITTAL
NOT FOR
CONSTRUCTION





CALIFORNIA HIGH-SPEED TRAIN PROJECT MERCED TO FRESNO SECTION

CENTRAL VALLEY WYE
CIVIL AND GRADE SEPARATION PLANS
INDEX OF DRAWINGS
SHEET 3 OF 17

HSR08-05
DRAWING NO. CV-BOOO4
NO SCALE
SHEET NO.

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| DESIGNED BY S. WELLS | DRAWN BY W. JOHNSEN | CHECKED BY J. RAY | IN CHARGE C. LEMLEY | DATE BY CHK APP | DESCRIPTION | DATE |

RECORD SET
15% DESIGN
SUBMITTAL
NOT FOR
CONSTRUCTION





CALIFORNIA HIGH-SPEED TRAIN PROJECT MERCED TO FRESNO SECTION

CENTRAL VALLEY WYE
CIVIL AND GRADE SEPARATION PLANS
INDEX OF DRAWINGS
SHEET 4 OF 17

HSR08-05
DRAWING NO. CV-B0005
NO SCALE
SHEET NO.

RECORD SET
15% DESIGN
SUBMITTAL
NOT FOR
CONSTRUCTION





CALIFORNIA HIGH-SPEED TRAIN PROJECT MERCED TO FRESNO SECTION

CENTRAL VALLEY WYE
CIVIL AND GRADE SEPARATION PLANS
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SHEET 5 OF 17

HSRO8-05	
DRAWING NO. CV-B0006	
NO SCALE	
SHEET NO.	

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RECORD SET
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NOT FOR
CONSTRUCTION





CALIFORNIA HIGH-SPEED TRAIN PROJECT MERCED TO FRESNO SECTION

CENTRAL VALLEY WYE
CIVIL AND GRADE SEPARATION PLANS
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CONTRACT NO. HSRO8-05
DRAWING NO. CV-B0007
NO SCALE
SHEET NO.

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TITLE CIVIL PLAN

CIVIL PLAN

W. JOHNSEN J. RAY C. LEMLEY DATE BY CHK APP DESCRIPTION 09/09/2016

DRAWING NO.

CV-S1191-B

CV-S1200-B

SECTION

CENTRAL VALLEY WYE

CENTRAL VALLEY WYE

CENTRAL VALLEY WYF

15% DESIGN SUBMITTAL NOT FOR CONSTRUCTION

ALIGNMENT / PLAN SET

SR 152 (NORTH) TO ROAD 19 WYE ALTERNATIVE

SR 152 (NORTH) TO ROAD 19 WYE ALTERNATIVE





CALIFORNIA HIGH-SPEED TRAIN PROJECT MERCED TO FRESNO SECTION

DESCRIPTION

SJD-FRE ACCESS ROAD

SJD-FRE STA 6402+00 TO 6458+00

CENTRAL VALLEY WYE CIVIL AND GRADE SEPARATION PLANS INDEX OF DRAWINGS SHEET 7 OF 17

CONTRACT NO.
HSR08-05
DRAWING NO.
CV-B0008
SCALE
NO SCALE
SHEET NO.

RECORD SET
15% DESIGN
SUBMITTAL
NOT FOR
CONSTRUCTION





CALIFORNIA HIGH-SPEED TRAIN PROJECT MERCED TO FRESNO SECTION

CENTRAL VALLEY WYE
CIVIL AND GRADE SEPARATION PLANS
INDEX OF DRAWINGS
SHEET 8 OF 17

HSR08-05
DRAWING NO. CV-B0009
NO SCALE
SHEET NO.

| DESIGNED BY | S. WELLS | DRAWN BY | W. JOHNSEN | CHECKED BY | J. RAY | IN CHARGE | C. LEMLEY | DATE | BY | CHK | APP | DESCRIPTION | DATE |

RECORD SET
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SUBMITTAL
NOT FOR
CONSTRUCTION





CALIFORNIA HIGH-SPEED TRAIN PROJECT MERCED TO FRESNO SECTION

CENTRAL VALLEY WYE
CIVIL AND GRADE SEPARATION PLANS
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HSR08-05
DRAWING NO.
CV-B0010
SCALE
NO SCALE
SHEET NO.

RECORD SET
15% DESIGN
SUBMITTAL
NOT FOR
CONSTRUCTION





CALIFORNIA HIGH-SPEED TRAIN PROJECT MERCED TO FRESNO SECTION

CENTRAL VALLEY WYE
CIVIL AND GRADE SEPARATION PLANS
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CONTRACT NO.
HSR08-05
DRAWING NO.
CV-B0011
SCALE
NO SCALE
SHEET NO.

RECORD SET
15% DESIGN
SUBMITTAL
NOT FOR
CONSTRUCTION





CALIFORNIA HIGH-SPEED TRAIN PROJECT MERCED TO FRESNO SECTION

CENTRAL VALLEY WYE
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HSR08-05
DRAWING NO.
CV-B0012
SCALE
NO SCALE
SHEET NO.

RECORD SET
15% DESIGN
SUBMITTAL
NOT FOR
CONSTRUCTION





CALIFORNIA HIGH-SPEED TRAIN PROJECT MERCED TO FRESNO SECTION

CENTRAL VALLEY WYE
CIVIL AND GRADE SEPARATION PLANS
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CONTRACT NO. HSRO8-05
DRAWING NO. CV-B0013
NO SCALE
SHEET NO.

DRAWING NO.

CV-R1300-C

CV-R1301-C

CV-R1310-C

CV-R1311-C

CV-R1430-C

CV-R1431-C

CV-R1432-C

SECTION

CENTRAL VALLEY WYE

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BY CHK APP

DESCRIPTION

CV-R1432-C   CENT	RAL VALLET WIE	AVENUE 21 TO ROAD 13 WIE ALTERNATIVE	PLAN AND PROFILE	AVENUE 21 1/2 GRADE SEPARATION
CV-R1433-C CENT	RAL VALLEY WYE	AVENUE 21 TO ROAD 13 WYE ALTERNATIVE	PLAN AND PROFILE	AVENUE 21 1/2 GRADE SEPARATION
CV-R1470-C CENT	RAL VALLEY WYE	AVENUE 21 TO ROAD 13 WYE ALTERNATIVE	PLAN AND PROFILE	AVENUE 25/WASHINGTON ROAD UNDERPASS
CV-R1471-C CENT	RAL VALLEY WYE	AVENUE 21 TO ROAD 13 WYE ALTERNATIVE	PLAN AND PROFILE	ROAD 13 REALIGNMENT
CV-R1490-C CENT	RAL VALLEY WYE	AVENUE 21 TO ROAD 13 WYE ALTERNATIVE	PLAN AND PROFILE	VISTA AVENUE/ROAD 13 REALIGNMENT
CV-R1491-C CENT	RAL VALLEY WYE	AVENUE 21 TO ROAD 13 WYE ALTERNATIVE	PLAN AND PROFILE	VISTA AVENUE/ROAD 13 REALIGNMENT
CV-R1500-C CENT	RAL VALLEY WYE	AVENUE 21 TO ROAD 13 WYE ALTERNATIVE	PLAN AND PROFILE	CROSS ROAD REALIGNMENT
CV-R1501-C CENT	RAL VALLEY WYE	AVENUE 21 TO ROAD 13 WYE ALTERNATIVE	PLAN AND PROFILE	CROSS ROAD REALIGNMENT
CV-R1502-C CENT	RAL VALLEY WYE	AVENUE 21 TO ROAD 13 WYE ALTERNATIVE	PLAN AND PROFILE	CROSS ROAD REALIGNMENT
CV-R1510-C CENT	RAL VALLEY WYE	AVENUE 21 TO ROAD 13 WYE ALTERNATIVE	PLAN AND PROFILE	ROAD 11 REALIGNMENT
CV-R1511-C CENT	RAL VALLEY WYE	AVENUE 21 TO ROAD 13 WYE ALTERNATIVE	PLAN AND PROFILE	ROAD 11 REALIGNMENT
CV-R1512-C CENT	RAL VALLEY WYE	AVENUE 21 TO ROAD 13 WYE ALTERNATIVE	PLAN AND PROFILE	ROAD 11 REALIGNMENT
CV-R1630-C CENT	RAL VALLEY WYE	AVENUE 21 TO ROAD 13 WYE ALTERNATIVE	PLAN AND PROFILE	AVENUE 21 1/2 SJD-MER GRADE SEPARATION
CV-R1631-C CENT	RAL VALLEY WYE	AVENUE 21 TO ROAD 13 WYE ALTERNATIVE	PLAN AND PROFILE	AVENUE 21 1/2 SJD-MER GRADE SEPARATION
CV-R1632-C CENT	RAL VALLEY WYE	AVENUE 21 TO ROAD 13 WYE ALTERNATIVE	PLAN AND PROFILE	ROAD 12 CONNECTOR ROAD
CV-I0001-C CENT	RAL VALLEY WYE	AVENUE 21 TO ROAD 13 WYE ALTERNATIVE	STAGE CONSTRUCTION PLAN	GENERAL NOTES
		SR 152 (NORT	TH) TO ROAD 11 WYE ALTERNATIVE	
CV-B4050-D CENT	RAL VALLEY WYE	SR 152 (NORTH) TO ROAD 11 WYE ALTERNATIVE	KEY MAP	SHEET 1 OF 4
CV-B4051-D CENT	RAL VALLEY WYE	SR 152 (NORTH) TO ROAD 11 WYE ALTERNATIVE	KEY MAP	SHEET 2 OF 4
CV-B4052-D CENT	RAL VALLEY WYE	SR 152 (NORTH) TO ROAD 11 WYE ALTERNATIVE	KEY MAP	SHEET 3 OF 4
CV-B4053-D CENT	RAL VALLEY WYE	SR 152 (NORTH) TO ROAD 11 WYE ALTERNATIVE	KEY MAP	SHEET 4 OF 4
CV-B0060-D CENT	RAL VALLEY WYE	SR 152 (NORTH) TO ROAD 11 WYE ALTERNATIVE	GEOMETRY DATA TABLE	SHEET 1 OF 6
CV-B0061-D CENT	RAL VALLEY WYE	SR 152 (NORTH) TO ROAD 11 WYE ALTERNATIVE	GEOMETRY DATA TABLE	SHEET 2 OF 6
CV-B0062-D CENT	RAL VALLEY WYE	SR 152 (NORTH) TO ROAD 11 WYE ALTERNATIVE	GEOMETRY DATA TABLE	SHEET 3 OF 6
CV-B0063-D CENT	RAL VALLEY WYE	SR 152 (NORTH) TO ROAD 11 WYE ALTERNATIVE	GEOMETRY DATA TABLE	SHEET 4 OF 6
CV-B0064-D CENT	RAL VALLEY WYE	SR 152 (NORTH) TO ROAD 11 WYE ALTERNATIVE	GEOMETRY DATA TABLE	SHEET 5 OF 6
CV-B0065-D CENT	RAL VALLEY WYE	SR 152 (NORTH) TO ROAD 11 WYE ALTERNATIVE	GEOMETRY DATA TABLE	SHEET 6 OF 6
CV-B0070-D CENT	RAL VALLEY WYE	SR 152 (NORTH) TO ROAD 11 WYE ALTERNATIVE	UTILITY CONFLICT TABLE	SHEET 1 OF 4
CV-B0071-D CENT	RAL VALLEY WYE	SR 152 (NORTH) TO ROAD 11 WYE ALTERNATIVE	UTILITY CONFLICT TABLE	SHEET 2 OF 4
CV-B0072-D CENT	RAL VALLEY WYE	SR 152 (NORTH) TO ROAD 11 WYE ALTERNATIVE	UTILITY CONFLICT TABLE	SHEET 3 OF 4
CV-B0073-D CENT	RAL VALLEY WYE	SR 152 (NORTH) TO ROAD 11 WYE ALTERNATIVE	UTILITY CONFLICT TABLE	SHEET 4 OF 4
CV-B0080-D CENT	RAL VALLEY WYE	SR 152 (NORTH) TO ROAD 11 WYE ALTERNATIVE	TYPICAL SECTION	SHEET 1 OF 3
CV-B0081-D CENT	RAL VALLEY WYE	SR 152 (NORTH) TO ROAD 11 WYE ALTERNATIVE	TYPICAL SECTION	SHEET 2 OF 3
CV-B0082-D CENT	RAL VALLEY WYE	SR 152 (NORTH) TO ROAD 11 WYE ALTERNATIVE	TYPICAL SECTION	SHEET 3 OF 3
		DESIGNED BY S. WELLS DRAWN BY W. JOHNSEN CHECKED BY J. RAY IN CHARGE C. LEMLEY  DESIGN SUBMITTAL NOT FOR CONSTRUCTION		CALIFORNIA HIGH-SPEED TRAIN PRO MERCED TO FRESNO SECTION  CENTRAL VALLEY WYE  CIVIL AND GRADE SEPARATION PLANS INDEX OF DRAWINGS

INDEX OF DRAWINGS

TITLE

PLAN AND PROFILE

DESCRIPTION

AVENUE 20 1/2 GRADE SEPARATION

AVENUE 20 1/2 GRADE SEPARATION

ROAD 24 REALIGNMENT

ROAD 24 REALIGNMENT

ROAD 14 GRADE SEPARATION

ROAD 14 GRADE SEPARATION

AVENUE 21 1/2 GRADE SEPARATION

HSR08-05 RAWING NO. CV-B0014 NO SCALE

SHEET NO.

SHEET 13 OF 17

ALIGNMENT / PLAN SET

AVENUE 21 TO ROAD 13 WYE ALTERNATIVE

09/09/2016

DRAWING NO.

CV-S1010-D

CV-S1020-D

CV-S1030-D

CV-S1040-D

CV-S1050-D

SECTION

CENTRAL VALLEY WYE

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DATE

BY CHK APP

DESCRIPTION

CV-S1060-D CENTRAL \	/ALLEY WYE SR 152 (NORTH) TO	O ROAD 11 WYE ALTERNATIVE	CIVIL PLAN	SJD-FRE STA 5618+00 TO 5674+00
CV-S1070-D CENTRAL V	/ALLEY WYE SR 152 (NORTH) TO	O ROAD 11 WYE ALTERNATIVE	CIVIL PLAN	SJD-FRE STA 5674+00 TO 5730+00
CV-S1080-D CENTRAL \	/ALLEY WYE SR 152 (NORTH) TO	O ROAD 11 WYE ALTERNATIVE	CIVIL PLAN	SJD-FRE STA 5730+00 TO 5786+00
CV-S1090-D CENTRAL \	/ALLEY WYE SR 152 (NORTH) TO	O ROAD 11 WYE ALTERNATIVE	CIVIL PLAN	SJD-FRE STA 5786+00 TO 5842+00
CV-S1100-D CENTRAL V	/ALLEY WYE SR 152 (NORTH) TO	O ROAD 11 WYE ALTERNATIVE	CIVIL PLAN	SJD-FRE STA 5842+00 TO 5898+00
CV-S1110-D CENTRAL V	/ALLEY WYE SR 152 (NORTH) TO	O ROAD 11 WYE ALTERNATIVE	CIVIL PLAN	SJD-FRE STA 5898+00 TO 5954+00
CV-S1120-D CENTRAL V	/ALLEY WYE SR 152 (NORTH) TO	O ROAD 11 WYE ALTERNATIVE	CIVIL PLAN	SJD-FRE STA 5954+00 TO 6010+00
CV-S1130-D CENTRAL V	/ALLEY WYE SR 152 (NORTH) TO	O ROAD 11 WYE ALTERNATIVE	CIVIL PLAN	SJD-FRE STA 6010+00 TO 6066+00
CV-S1140-D CENTRAL \	/ALLEY WYE SR 152 (NORTH) TO	O ROAD 11 WYE ALTERNATIVE	CIVIL PLAN	SJD-FRE STA 6066+00 TO 6122+00
CV-S1150-D CENTRAL \	/ALLEY WYE SR 152 (NORTH) TO	O ROAD 11 WYE ALTERNATIVE	CIVIL PLAN	SJD-FRE STA 6122+00 TO 6178+00
CV-S1160-D CENTRAL \	/ALLEY WYE SR 152 (NORTH) TO	O ROAD 11 WYE ALTERNATIVE	CIVIL PLAN	SJD-FRE STA 6178+00 TO 6234+00
CV-S1170-D CENTRAL \	/ALLEY WYE SR 152 (NORTH) TO	O ROAD 11 WYE ALTERNATIVE	CIVIL PLAN	SJD-FRE STA 6234+00 TO 6290+00
CV-S1180-D CENTRAL \	/ALLEY WYE SR 152 (NORTH) TO	O ROAD 11 WYE ALTERNATIVE	CIVIL PLAN	SJD-FRE STA 6290+00 TO 6346+00
CV-S1190-D CENTRAL \	/ALLEY WYE SR 152 (NORTH) TO	O ROAD 11 WYE ALTERNATIVE	CIVIL PLAN	SJD-FRE STA 6346+00 TO 6402+00
CV-S1200-D CENTRAL \	/ALLEY WYE SR 152 (NORTH) TO	O ROAD 11 WYE ALTERNATIVE	CIVIL PLAN	SJD-FRE STA 6402+00 TO 6458+00
CV-S1210-D CENTRAL \	/ALLEY WYE SR 152 (NORTH) TO	O ROAD 11 WYE ALTERNATIVE	CIVIL PLAN	SJD-FRE STA 6458+00 TO 6514+00
CV-S1220-D CENTRAL \	/ALLEY WYE SR 152 (NORTH) TO	O ROAD 11 WYE ALTERNATIVE	CIVIL PLAN	SJD-FRE STA 6514+00 TO 6570+00
CV-S1230-D CENTRAL \	/ALLEY WYE SR 152 (NORTH) TO	O ROAD 11 WYE ALTERNATIVE	CIVIL PLAN	SJD-FRE STA 6570+00 TO 6626+00
CV-S1240-D CENTRAL \	/ALLEY WYE SR 152 (NORTH) TO	O ROAD 11 WYE ALTERNATIVE	CIVIL PLAN	SJD-FRE STA 6626+00 TO 6682+00
CV-S1241-D CENTRAL \	/ALLEY WYE SR 152 (NORTH) TO	O ROAD 11 WYE ALTERNATIVE	CIVIL PLAN	SJD-FRE ACCESS ROAD
CV-S1250-D CENTRAL \	/ALLEY WYE SR 152 (NORTH) TO	O ROAD 11 WYE ALTERNATIVE	CIVIL PLAN	SJD-FRE STA 6682+00 TO 6738+00
CV-S1260-D CENTRAL \	/ALLEY WYE SR 152 (NORTH) TO	O ROAD 11 WYE ALTERNATIVE	CIVIL PLAN	SJD-FRE STA 6738+00 TO 6794+00
CV-S1270-D CENTRAL \	/ALLEY WYE SR 152 (NORTH) TO	O ROAD 11 WYE ALTERNATIVE	CIVIL PLAN	SJD-FRE STA 6794+00 TO 6850+00
CV-S1280-D CENTRAL \	/ALLEY WYE SR 152 (NORTH) TO	O ROAD 11 WYE ALTERNATIVE	CIVIL PLAN	SJD-FRE STA 6850+00 TO 6906+00
CV-S1290-D CENTRAL \	/ALLEY WYE SR 152 (NORTH) TO	O ROAD 11 WYE ALTERNATIVE	CIVIL PLAN	SJD-FRE STA 6906+00 TO 6962+00
CV-S1291-D CENTRAL \	/ALLEY WYE SR 152 (NORTH) TO	O ROAD 11 WYE ALTERNATIVE	CIVIL PLAN	SJD-FRE ACCESS ROAD
CV-S1300-D CENTRAL \	/ALLEY WYE SR 152 (NORTH) TO	O ROAD 11 WYE ALTERNATIVE	CIVIL PLAN	SJD-FRE STA 6962+00 TO 7018+00
CV-S1310-D CENTRAL V	/ALLEY WYE SR 152 (NORTH) TO	O ROAD 11 WYE ALTERNATIVE	CIVIL PLAN	SJD-FRE STA 7018+00 TO 7074+00
CV-S1320-D CENTRAL V	/ALLEY WYE SR 152 (NORTH) TO	O ROAD 11 WYE ALTERNATIVE	CIVIL PLAN	SJD-FRE STA 7074+00 TO 7130+00
CV-S1330-D CENTRAL \	/ALLEY WYE SR 152 (NORTH) TO	O ROAD 11 WYE ALTERNATIVE	CIVIL PLAN	SJD-FRE STA 7130+00 TO 7170+94.51
CV-S1410-D CENTRAL V	/ALLEY WYE SR 152 (NORTH) TO	O ROAD 11 WYE ALTERNATIVE	CIVIL PLAN	MER-FRE STA 15009+29.27 TO 15052+00
CV-S1420-D CENTRAL \	/ALLEY WYE SR 152 (NORTH) TO	O ROAD 11 WYE ALTERNATIVE	CIVIL PLAN	MER-FRE STA 15052+00 TO 15108+00
CV-S1430-D CENTRAL \	/ALLEY WYE SR 152 (NORTH) TO	O ROAD 11 WYE ALTERNATIVE	CIVIL PLAN	MER-FRE STA 15108+00 TO 15164+00
CV-S1440-D CENTRAL \	/ALLEY WYE SR 152 (NORTH) TO	O ROAD 11 WYE ALTERNATIVE	CIVIL PLAN	MER-FRE STA 15164+00 TO 15220+00
CV-S1441-D CENTRAL \	/ALLEY WYE SR 152 (NORTH) TO	O ROAD 11 WYE ALTERNATIVE	CIVIL PLAN	MER-FRE ACCESS ROAD
	DESIGNED BY S. WELLS DRAWN BY W. JOHNSEN CHECKED BY J. RAY IN CHARGE	RECORD SET 15% DESIGN SUBMITTAL NOT FOR	RSONS	CALIFORNIA HIGH-SPEED TRAIN F MERCED TO FRESNO SECTION CENTRAL VALLEY WYE CIVIL AND GRADE SEPARATION PLANS INDEX OF DRAWINGS

INDEX OF DRAWINGS

TITLE

CIVIL PLAN

CIVIL PLAN

CIVIL PLAN

CIVIL PLAN

CIVIL PLAN

DESCRIPTION

SJD-FRE STA 5338+00 TO 5394+00

SJD-FRE STA 5394+00 TO 5450+00

SJD-FRE STA 5450+00 TO 5506+00

SJD-FRE STA 5506+00 TO 5562+00

SJD-FRE STA 5562+00 TO 5618+00

HSR08-05 RAWING NO. CV-B0015 NO SCALE

SHEET NO.

SHEET 14 OF 17

ALIGNMENT / PLAN SET

SR 152 (NORTH) TO ROAD 11 WYE ALTERNATIVE

DATE 09/09/2016

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SEP-2016					CV-R1164-D	CENTRAL VALLEY WYE	SR	152 (NORTH) T	ГО
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<u>.</u>								IN CHARGE C. LEMLEY	1
1200d REV	DATE	BY	СНК	APP		DESCRIPTION		DATE 09/09/2016	1
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### CALIFORNIA HIGH-SPEED TRAIN PROJECT MERCED TO FRESNO SECTION

CENTRAL VALLEY WYE
CIVIL AND GRADE SEPARATION PLANS
INDEX OF DRAWINGS
SHEET 15 OF 17

CONTRACT NO.
HSR08-05
DRAWING NO.
CV-B0016
SCALE
NO SCALE
SHEET NO.

		11101	EX OF DRAWINGS	
DRAWING NO.	SECTION	ALIGNMENT / PLAN SET	TITLE	DESCRIPTION
CV-S1450-D	CENTRAL VALLEY WYE	SR 152 (NORTH) TO ROAD 11 WYE ALTERNATIVE	CIVIL PLAN	MER-FRE STA 15220+00 TO 15276+00
CV-S1460-D	CENTRAL VALLEY WYE	SR 152 (NORTH) TO ROAD 11 WYE ALTERNATIVE	CIVIL PLAN	MER-FRE STA 15276+00 TO 15332+00
CV-S1470-D	CENTRAL VALLEY WYE	SR 152 (NORTH) TO ROAD 11 WYE ALTERNATIVE	CIVIL PLAN	MER-FRE STA 15332+00 TO 15388+00
CV-S1480-D	CENTRAL VALLEY WYE	SR 152 (NORTH) TO ROAD 11 WYE ALTERNATIVE	CIVIL PLAN	MER-FRE STA 15388+00 TO 15444+00
CV-S1490-D	CENTRAL VALLEY WYE	SR 152 (NORTH) TO ROAD 11 WYE ALTERNATIVE	CIVIL PLAN	MER-FRE STA 15444+00 TO 15500+00
CV-S1500-D	CENTRAL VALLEY WYE	SR 152 (NORTH) TO ROAD 11 WYE ALTERNATIVE	CIVIL PLAN	MER-FRE STA 15500+00 TO 15556+00
CV-S1510-D	CENTRAL VALLEY WYE	SR 152 (NORTH) TO ROAD 11 WYE ALTERNATIVE	CIVIL PLAN	MER-FRE STA 15556+00 TO 15612+00
CV-S1520-D	CENTRAL VALLEY WYE	SR 152 (NORTH) TO ROAD 11 WYE ALTERNATIVE	CIVIL PLAN	MER-FRE STA 15612+00 TO 15655+00
CV-S1610-D	CENTRAL VALLEY WYE	SR 152 (NORTH) TO ROAD 11 WYE ALTERNATIVE	CIVIL PLAN	SJD-MER STA 36134+00.59 TO 36184+00
CV-S1620-D	CENTRAL VALLEY WYE	SR 152 (NORTH) TO ROAD 11 WYE ALTERNATIVE	CIVIL PLAN	SJD-MER STA 36184+00 TO 36240+00
CV-S1630-D	CENTRAL VALLEY WYE	SR 152 (NORTH) TO ROAD 11 WYE ALTERNATIVE	CIVIL PLAN	SJD-MER STA 36240+00 TO 36296+00
CV-S1640-D	CENTRAL VALLEY WYE	SR 152 (NORTH) TO ROAD 11 WYE ALTERNATIVE	CIVIL PLAN	SJD-MER STA 36296+00 TO 36352+00
CV-S1650-D	CENTRAL VALLEY WYE	SR 152 (NORTH) TO ROAD 11 WYE ALTERNATIVE	CIVIL PLAN	SJD-MER STA 36352+00 TO 36408+00
CV-S1660-D	CENTRAL VALLEY WYE	SR 152 (NORTH) TO ROAD 11 WYE ALTERNATIVE	CIVIL PLAN	SJD-MER STA 36408+00 TO 36457+64.63
CV-R1030-D	CENTRAL VALLEY WYE	SR 152 (NORTH) TO ROAD 11 WYE ALTERNATIVE	PLAN AND PROFILE	HENRY MILLER ROAD REALIGNMENT
CV-R1031-D	CENTRAL VALLEY WYE	SR 152 (NORTH) TO ROAD 11 WYE ALTERNATIVE	PLAN AND PROFILE	HENRY MILLER ROAD REALIGNMENT
CV-R1032-D	CENTRAL VALLEY WYE	SR 152 (NORTH) TO ROAD 11 WYE ALTERNATIVE	PLAN AND PROFILE	HENRY MILLER ROAD REALIGNMENT
CV-R1033-D	CENTRAL VALLEY WYE	SR 152 (NORTH) TO ROAD 11 WYE ALTERNATIVE	PLAN AND PROFILE	HENRY MILLER ROAD REALIGNMENT
CV-R1050-D	CENTRAL VALLEY WYE	SR 152 (NORTH) TO ROAD 11 WYE ALTERNATIVE	PLAN AND PROFILE	INDIANA ROAD GRADE SEPARATION
CV-R1051-D	CENTRAL VALLEY WYE	SR 152 (NORTH) TO ROAD 11 WYE ALTERNATIVE	PLAN AND PROFILE	INDIANA ROAD GRADE SEPARATION
CV-R1090-D	CENTRAL VALLEY WYE	SR 152 (NORTH) TO ROAD 11 WYE ALTERNATIVE	PLAN AND PROFILE	COYOTE ROAD REALIGNMENT
CV-R1091-D	CENTRAL VALLEY WYE	SR 152 (NORTH) TO ROAD 11 WYE ALTERNATIVE	PLAN AND PROFILE	COYOTE ROAD REALIGNMENT
CV-R1100-D	CENTRAL VALLEY WYE	SR 152 (NORTH) TO ROAD 11 WYE ALTERNATIVE	PLAN AND PROFILE	SR 152 REALIGNMENT AT SR 59
CV-R1101-D	CENTRAL VALLEY WYE	SR 152 (NORTH) TO ROAD 11 WYE ALTERNATIVE	PLAN AND PROFILE	SR 152 REALIGNMENT AT SR 59
CV-R1102-D	CENTRAL VALLEY WYE	SR 152 (NORTH) TO ROAD 11 WYE ALTERNATIVE	PLAN AND PROFILE	SR 152 REALIGNMENT AT SR 59
CV-R1103-D	CENTRAL VALLEY WYE	SR 152 (NORTH) TO ROAD 11 WYE ALTERNATIVE	PLAN AND PROFILE	SR 152 REALIGNMENT AT SR 59
CV-R1104-D	CENTRAL VALLEY WYE	SR 152 (NORTH) TO ROAD 11 WYE ALTERNATIVE	PLAN AND PROFILE	SR 59/SR 152 EB OFF RAMP GRADE SEPARATION
CV-R1105-D	CENTRAL VALLEY WYE	SR 152 (NORTH) TO ROAD 11 WYE ALTERNATIVE	PLAN AND PROFILE	SR 59/SR 152 EB OFF RAMP GRADE SEPARATION
CV-R1106-D	CENTRAL VALLEY WYE	SR 152 (NORTH) TO ROAD 11 WYE ALTERNATIVE	PLAN AND PROFILE	SR 59/SR 152 WB ON RAMP GRADE SEPARATION
CV-R1107-D	CENTRAL VALLEY WYE	SR 152 (NORTH) TO ROAD 11 WYE ALTERNATIVE	PLAN AND PROFILE	SR 59/SR 152 WB ON RAMP GRADE SEPARATION
CV-R1108-D	CENTRAL VALLEY WYE	SR 152 (NORTH) TO ROAD 11 WYE ALTERNATIVE	PLAN AND PROFILE	SR 59/SR 152 WB OFF RAMP GRADE SEPARATION
CV-R1109-D	CENTRAL VALLEY WYE	SR 152 (NORTH) TO ROAD 11 WYE ALTERNATIVE	PLAN AND PROFILE	SR 59/SR 152 WB OFF RAMP GRADE SEPARATION
CV-R1110-D	CENTRAL VALLEY WYE	SR 152 (NORTH) TO ROAD 11 WYE ALTERNATIVE	PLAN AND PROFILE	SR 59/SR 152 EB LOOP ON RAMP
CV-R1111-D	CENTRAL VALLEY WYE	SR 152 (NORTH) TO ROAD 11 WYE ALTERNATIVE	PLAN AND PROFILE	ROAD 4/LINCOLN ROAD GRADE SEPARATION
CV-R1112-D	CENTRAL VALLEY WYE	SR 152 (NORTH) TO ROAD 11 WYE ALTERNATIVE	PLAN AND PROFILE	ROAD 4/LINCOLN ROAD GRADE SEPARATION
CV-R1160-D	CENTRAL VALLEY WYE	SR 152 (NORTH) TO ROAD 11 WYE ALTERNATIVE	PLAN AND PROFILE	ROAD 9/HEMLOCK ROAD GRADE SEPARATION
CV-R1161-D	CENTRAL VALLEY WYE	SR 152 (NORTH) TO ROAD 11 WYE ALTERNATIVE	PLAN AND PROFILE	ROAD 9/HEMLOCK ROAD GRADE SEPARATION
CV-R1162-D	CENTRAL VALLEY WYE	SR 152 (NORTH) TO ROAD 11 WYE ALTERNATIVE	PLAN AND PROFILE	SR 152 REALIGNMENT AT ROAD 9
CV-R1163-D	CENTRAL VALLEY WYE	SR 152 (NORTH) TO ROAD 11 WYE ALTERNATIVE	PLAN AND PROFILE	SR 152 REALIGNMENT AT ROAD 9
CV-R1164-D	CENTRAL VALLEY WYE	SR 152 (NORTH) TO ROAD 11 WYE ALTERNATIVE	PLAN AND PROFILE	SR 152 REALIGNMENT AT ROAD 9

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### CALIFORNIA HIGH-SPEED TRAIN PROJECT MERCED TO FRESNO SECTION

CENTRAL VALLEY WYE
CIVIL AND GRADE SEPARATION PLANS
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CONTRACT NO. HSR08-05
DRAWING NO. CV-BOO17
NO SCALE
SHEET NO.

		INE	DEX OF DRAWINGS	
DRAWING NO.	SECTION	ALIGNMENT / PLAN SET	TITLE	DESCRIPTION
CV-R1165-D	CENTRAL VALLEY WYE	SR 152 (NORTH) TO ROAD 11 WYE ALTERNATIVE	PLAN AND PROFILE	ROAD 9/SR 152 EB OFF RAMP
CV-R1166-D	CENTRAL VALLEY WYE	SR 152 (NORTH) TO ROAD 11 WYE ALTERNATIVE	PLAN AND PROFILE	ROAD 9/SR 152 EB ON RAMP
CV-R1167-D	CENTRAL VALLEY WYE	SR 152 (NORTH) TO ROAD 11 WYE ALTERNATIVE	PLAN AND PROFILE	ROAD 9/SR 152 LOOP RAMP
CV-R1168-D	CENTRAL VALLEY WYE	SR 152 (NORTH) TO ROAD 11 WYE ALTERNATIVE	PLAN AND PROFILE	ROAD 9/SR 152 WB ON RAMP
CV-R1169-D	CENTRAL VALLEY WYE	SR 152 (NORTH) TO ROAD 11 WYE ALTERNATIVE	PLAN AND PROFILE	ROAD 9/SR 152 WB OFF RAMP
CV-R1190-D	CENTRAL VALLEY WYE	SR 152 (NORTH) TO ROAD 11 WYE ALTERNATIVE	PLAN AND PROFILE	ROAD 12 GRADE SEPARATION
CV-R1191-D	CENTRAL VALLEY WYE	SR 152 (NORTH) TO ROAD 11 WYE ALTERNATIVE	PLAN AND PROFILE	ROAD 12 GRADE SEPARATION
CV-R1192-D	CENTRAL VALLEY WYE	SR 152 (NORTH) TO ROAD 11 WYE ALTERNATIVE	PLAN AND PROFILE	SR 152 REALIGNMENT AT ROAD 12
CV-R1193-D	CENTRAL VALLEY WYE	SR 152 (NORTH) TO ROAD 11 WYE ALTERNATIVE	PLAN AND PROFILE	SR 152 REALIGNMENT AT ROAD 12
CV-R1194-D	CENTRAL VALLEY WYE	SR 152 (NORTH) TO ROAD 11 WYE ALTERNATIVE	PLAN AND PROFILE	SR 152 REALIGNMENT AT ROAD 12
CV-R1200-D	CENTRAL VALLEY WYE	SR 152 (NORTH) TO ROAD 11 WYE ALTERNATIVE	PLAN AND PROFILE	SR 152 REALIGNMENT AT SR 233
CV-R1201-D	CENTRAL VALLEY WYE	SR 152 (NORTH) TO ROAD 11 WYE ALTERNATIVE	PLAN AND PROFILE	SR 152 REALIGNMENT AT SR 233
CV-R1202-D	CENTRAL VALLEY WYE	SR 152 (NORTH) TO ROAD 11 WYE ALTERNATIVE	PLAN AND PROFILE	SR 152 REALIGNMENT AT SR 233
CV-R1203-D	CENTRAL VALLEY WYE	SR 152 (NORTH) TO ROAD 11 WYE ALTERNATIVE	PLAN AND PROFILE	SR 233/SR 152 EB OFF RAMP
CV-R1204-D	CENTRAL VALLEY WYE	SR 152 (NORTH) TO ROAD 11 WYE ALTERNATIVE	PLAN AND PROFILE	SR 233/SR 152 EB LOOP RAMP
CV-R1205-D	CENTRAL VALLEY WYE	SR 152 (NORTH) TO ROAD 11 WYE ALTERNATIVE	PLAN AND PROFILE	SR 233/SR 152 WB ON RAMP
CV-R1210-D	CENTRAL VALLEY WYE	SR 152 (NORTH) TO ROAD 11 WYE ALTERNATIVE	PLAN AND PROFILE	SR 233/ROBERTSON BLVD GRADE SEPARATION
CV-R1211-D	CENTRAL VALLEY WYE	SR 152 (NORTH) TO ROAD 11 WYE ALTERNATIVE	PLAN AND PROFILE	SR 233/ROBERTSON BLVD GRADE SEPARATION
CV-R1212-D	CENTRAL VALLEY WYE	SR 152 (NORTH) TO ROAD 11 WYE ALTERNATIVE	PLAN AND PROFILE	SR 233/SR 152 EB ON RAMP
CV-R1213-D	CENTRAL VALLEY WYE	SR 152 (NORTH) TO ROAD 11 WYE ALTERNATIVE	PLAN AND PROFILE	SR 233/SR 152 EB ON RAMP
CV-R1214-D	CENTRAL VALLEY WYE	SR 152 (NORTH) TO ROAD 11 WYE ALTERNATIVE	PLAN AND PROFILE	SR 233/SR 152 WB OFF RAMP
CV-R1224-D	CENTRAL VALLEY WYE	SR 152 (NORTH) TO ROAD 11 WYE ALTERNATIVE	PLAN AND PROFILE	SR 152 REALIGNMENT AT ROAD 16
CV-R1225-D	CENTRAL VALLEY WYE	SR 152 (NORTH) TO ROAD 11 WYE ALTERNATIVE	PLAN AND PROFILE	SR 152 REALIGNMENT AT ROAD 16
CV-R1226-D	CENTRAL VALLEY WYE	SR 152 (NORTH) TO ROAD 11 WYE ALTERNATIVE	PLAN AND PROFILE	SR 152 REALIGNMENT AT ROAD 16
CV-R1227-D	CENTRAL VALLEY WYE	SR 152 (NORTH) TO ROAD 11 WYE ALTERNATIVE	PLAN AND PROFILE	ROAD 16/SR 152 EB OFF RAMP
CV-R1228-D	CENTRAL VALLEY WYE	SR 152 (NORTH) TO ROAD 11 WYE ALTERNATIVE	PLAN AND PROFILE	ROAD 16/SR 152 EB OFF RAMP
CV-R1229-D	CENTRAL VALLEY WYE	SR 152 (NORTH) TO ROAD 11 WYE ALTERNATIVE	PLAN AND PROFILE	ROAD 16/SR 152 WB ON RAMP
CV-R1230-D	CENTRAL VALLEY WYE	SR 152 (NORTH) TO ROAD 11 WYE ALTERNATIVE	PLAN AND PROFILE	ROAD 16 GRADE SEPARATION
CV-R1231-D	CENTRAL VALLEY WYE	SR 152 (NORTH) TO ROAD 11 WYE ALTERNATIVE	PLAN AND PROFILE	ROAD 16 GRADE SEPARATION
CV-R1232-D	CENTRAL VALLEY WYE	SR 152 (NORTH) TO ROAD 11 WYE ALTERNATIVE	PLAN AND PROFILE	ROAD 16/SR 152 EB ON RAMP
CV-R1233-D	CENTRAL VALLEY WYE	SR 152 (NORTH) TO ROAD 11 WYE ALTERNATIVE	PLAN AND PROFILE	ROAD 16/SR 152 EB LOOP RAMP
CV-R1234-D	CENTRAL VALLEY WYE	SR 152 (NORTH) TO ROAD 11 WYE ALTERNATIVE	PLAN AND PROFILE	ROAD 16/SR 152 WB OFF RAMP
CV-R1235-D	CENTRAL VALLEY WYE	SR 152 (NORTH) TO ROAD 11 WYE ALTERNATIVE	PLAN AND PROFILE	ROAD 16 CONNECTOR REALIGNMENT
CV-R1240-D	CENTRAL VALLEY WYE	SR 152 (NORTH) TO ROAD 11 WYE ALTERNATIVE	PLAN AND PROFILE	ROAD 17 1/2 GRADE SEPARATION
CV-R1241-D	CENTRAL VALLEY WYE	SR 152 (NORTH) TO ROAD 11 WYE ALTERNATIVE	PLAN AND PROFILE	ROAD 17 1/2 GRADE SEPARATION
CV-R1242-D	CENTRAL VALLEY WYE	SR 152 (NORTH) TO ROAD 11 WYE ALTERNATIVE	PLAN AND PROFILE	ROAD 17 1/2 GRADE SEPARATION
CV-R1250-D	CENTRAL VALLEY WYE	SR 152 (NORTH) TO ROAD 11 WYE ALTERNATIVE	PLAN AND PROFILE	FAIRMEAD BOULEVARD REALIGNMENT
CV-R1260-D	CENTRAL VALLEY WYE	SR 152 (NORTH) TO ROAD 11 WYE ALTERNATIVE	PLAN AND PROFILE	ROAD 20 GRADE SEPARATION
CV-R1261-D	CENTRAL VALLEY WYE	SR 152 (NORTH) TO ROAD 11 WYE ALTERNATIVE	PLAN AND PROFILE	ROAD 20 GRADE SEPARATION
CV-R1280-D	CENTRAL VALLEY WYE	SR 152 (NORTH) TO ROAD 11 WYE ALTERNATIVE	PLAN AND PROFILE	ROAD 22 GRADE SEPARATION

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### CALIFORNIA HIGH-SPEED TRAIN PROJECT MERCED TO FRESNO SECTION

CENTRAL VALLEY WYE
CIVIL AND GRADE SEPARATION PLANS
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CONTRACT NO.
HSR08-05
DRAWING NO.
CV-B0018
SCALE
NO SCALE
SHEET NO.

DRAWING NO.	SECTION	ALIGNMENT / PLAN SET	TITLE	DESCRIPTION
V-R1281-D	CENTRAL VALLEY WYE	SR 152 (NORTH) TO ROAD 11 WYE ALTERNATIVE	PLAN AND PROFILE	ROAD 22 GRADE SEPARATION
V-R1290-D	CENTRAL VALLEY WYE	SR 152 (NORTH) TO ROAD 11 WYE ALTERNATIVE	PLAN AND PROFILE	AVENUE 22 REALIGNMENT
V-R1310-D	CENTRAL VALLEY WYE	SR 152 (NORTH) TO ROAD 11 WYE ALTERNATIVE	PLAN AND PROFILE	ROAD 24 REALIGNMENT
CV-R1311-D	CENTRAL VALLEY WYE	SR 152 (NORTH) TO ROAD 11 WYE ALTERNATIVE	PLAN AND PROFILE	ROAD 24 REALIGNMENT
CV-R1312-D	CENTRAL VALLEY WYE	SR 152 (NORTH) TO ROAD 11 WYE ALTERNATIVE	PLAN AND PROFILE	ROAD 24 REALIGNMENT
CV-R1313-D	CENTRAL VALLEY WYE	SR 152 (NORTH) TO ROAD 11 WYE ALTERNATIVE	PLAN AND PROFILE	AVENUE 20 1/2 GRADE SEPARATION
CV-R1314-D	CENTRAL VALLEY WYE	SR 152 (NORTH) TO ROAD 11 WYE ALTERNATIVE	PLAN AND PROFILE	AVENUE 20 1/2 GRADE SEPARATION
V-R1320-D	CENTRAL VALLEY WYE	SR 152 (NORTH) TO ROAD 11 WYE ALTERNATIVE	PLAN AND PROFILE	AVENUE 20 REALIGNMENT
CV-R1321-D	CENTRAL VALLEY WYE	SR 152 (NORTH) TO ROAD 11 WYE ALTERNATIVE	PLAN AND PROFILE	AVENUE 20 REALIGNMENT
CV-R1450-D	CENTRAL VALLEY WYE	SR 152 (NORTH) TO ROAD 11 WYE ALTERNATIVE	PLAN AND PROFILE	AVENUE 25 GRADE SEPARATION
V-R1451-D	CENTRAL VALLEY WYE	SR 152 (NORTH) TO ROAD 11 WYE ALTERNATIVE	PLAN AND PROFILE	AVENUE 25 GRADE SEPARATION
V-R1490-D	CENTRAL VALLEY WYE	SR 152 (NORTH) TO ROAD 11 WYE ALTERNATIVE	PLAN AND PROFILE	ATHLONE ROAD REALIGNMENT
V-R1491-D	CENTRAL VALLEY WYE	SR 152 (NORTH) TO ROAD 11 WYE ALTERNATIVE	PLAN AND PROFILE	ATHLONE ROAD REALIGNMENT
V-R1630-D	CENTRAL VALLEY WYE	SR 152 (NORTH) TO ROAD 11 WYE ALTERNATIVE	PLAN AND PROFILE	ROAD 10 REALIGNMENT
CV-R1631-D	CENTRAL VALLEY WYE	SR 152 (NORTH) TO ROAD 11 WYE ALTERNATIVE	PLAN AND PROFILE	ROAD 10 REALIGNMENT
CV-R1632-D	CENTRAL VALLEY WYE	SR 152 (NORTH) TO ROAD 11 WYE ALTERNATIVE	PLAN AND PROFILE	AVENUE 23 1/2 GRADE SEPARATION
CV-R1633-D	CENTRAL VALLEY WYE	SR 152 (NORTH) TO ROAD 11 WYE ALTERNATIVE	PLAN AND PROFILE	AVENUE 23 1/2 GRADE SEPARATION
CV-R1650-D	CENTRAL VALLEY WYE	SR 152 (NORTH) TO ROAD 11 WYE ALTERNATIVE	PLAN AND PROFILE	ROAD 11 REALIGNMENT
CV-R1651-D	CENTRAL VALLEY WYE	SR 152 (NORTH) TO ROAD 11 WYE ALTERNATIVE	PLAN AND PROFILE	ROAD 11 REALIGNMENT
CV-I0001-D	CENTRAL VALLEY WYE	SR 152 (NORTH) TO ROAD 11 WYE ALTERNATIVE	STAGE CONSTRUCTION PLAN	GENERAL NOTES
CV-I4100-D	CENTRAL VALLEY WYE	SR 152 (NORTH) TO ROAD 11 WYE ALTERNATIVE	STAGE CONSTRUCTION PLAN	SR 59/SR 152 STAGE 1 OF 4
CV-I4101-D	CENTRAL VALLEY WYE	SR 152 (NORTH) TO ROAD 11 WYE ALTERNATIVE	STAGE CONSTRUCTION PLAN	SR 59/SR 152 STAGE 2 OF 4
CV-I4102-D	CENTRAL VALLEY WYE	SR 152 (NORTH) TO ROAD 11 WYE ALTERNATIVE	STAGE CONSTRUCTION PLAN	SR 59/SR 152 STAGE 3 OF 4
CV-I4103-D	CENTRAL VALLEY WYE	SR 152 (NORTH) TO ROAD 11 WYE ALTERNATIVE	STAGE CONSTRUCTION PLAN	SR 59/SR 152 STAGE 4 OF 4
CV-I4160-D	CENTRAL VALLEY WYE	SR 152 (NORTH) TO ROAD 11 WYE ALTERNATIVE	STAGE CONSTRUCTION PLAN	ROAD 9/SR 152 STAGE 1 OF 4
CV-I4161-D	CENTRAL VALLEY WYE	SR 152 (NORTH) TO ROAD 11 WYE ALTERNATIVE	STAGE CONSTRUCTION PLAN	ROAD 9/SR 152 STAGE 2 OF 4
CV-I4162-D	CENTRAL VALLEY WYE	SR 152 (NORTH) TO ROAD 11 WYE ALTERNATIVE	STAGE CONSTRUCTION PLAN	ROAD 9/SR 152 STAGE 3 OF 4
CV-I4163-D	CENTRAL VALLEY WYE	SR 152 (NORTH) TO ROAD 11 WYE ALTERNATIVE	STAGE CONSTRUCTION PLAN	ROAD 9/SR 152 STAGE 4 OF 4
CV-I4210-D	CENTRAL VALLEY WYE	SR 152 (NORTH) TO ROAD 11 WYE ALTERNATIVE	STAGE CONSTRUCTION PLAN	SR 233/SR 152 STAGE 1 OF 5
CV-I4211-D	CENTRAL VALLEY WYE	SR 152 (NORTH) TO ROAD 11 WYE ALTERNATIVE	STAGE CONSTRUCTION PLAN	SR 233/SR 152 STAGE 2 OF 5
CV-I4212-D	CENTRAL VALLEY WYE	SR 152 (NORTH) TO ROAD 11 WYE ALTERNATIVE	STAGE CONSTRUCTION PLAN	SR 233/SR 152 STAGE 3 OF 5
V-I4213-D	CENTRAL VALLEY WYE	SR 152 (NORTH) TO ROAD 11 WYE ALTERNATIVE	STAGE CONSTRUCTION PLAN	SR 233/SR 152 STAGE 4 OF 5
CV-I4214-D	CENTRAL VALLEY WYE	SR 152 (NORTH) TO ROAD 11 WYE ALTERNATIVE	STAGE CONSTRUCTION PLAN	SR 233/SR 152 STAGE 5 OF 5
CV-I4230-D	CENTRAL VALLEY WYE	SR 152 (NORTH) TO ROAD 11 WYE ALTERNATIVE	STAGE CONSTRUCTION PLAN	ROAD 16/SR 152 STAGE 1 OF 4
CV-I4231-D	CENTRAL VALLEY WYE	SR 152 (NORTH) TO ROAD 11 WYE ALTERNATIVE	STAGE CONSTRUCTION PLAN	ROAD 16/SR 152 STAGE 2 OF 4
CV-I4232-D	CENTRAL VALLEY WYE	SR 152 (NORTH) TO ROAD 11 WYE ALTERNATIVE	STAGE CONSTRUCTION PLAN	ROAD 16/SR 152 STAGE 3 OF 4
CV-I4233-D	CENTRAL VALLEY WYE	SR 152 (NORTH) TO ROAD 11 WYE ALTERNATIVE	STAGE CONSTRUCTION PLAN	ROAD 16/SR 152 STAGE 4 OF 4

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		0.4.4	OARLE MISUER ASSEMBLY	DET		ENTO		16	
AB	AGGREGATE BASE	CAA	CABLE ANCHOR ASSEMBLY	DET	DETAIL, DETOUR	FNTB	FACING NORTHBOUND TRAFFIC	JS	JUNCTION STRUCTURE
ABBC	ASBESTOS BONDED BITUMINOUS COATED	CAP	CORRUGATED ALUMINUM PIPE	DF	DOUGLAS FIR, DIRECT FIXATION	FOB	FREE ON BOARD	JT	JOINT
ABM	AIR-BLOWN MORTAR	CAPA	CONSTRUCTION AREA SION	DIA	DRAINAGE INLET, DROP INLET	FOC FR RD	FACE OF CONCRETE		
ABN ABUT	ABANDON ABUTMENT	CAS CB	CONSTRUCTION AREA SIGN CONCRETE BARRIER	DIA DIAPH	DIAMETER DIAPHRAGM	FRE RD	FRONTAGE ROAD FRESNO		LENGTH
	ASPHALT CONCRETE	CBW	CONCRETE BARRIER  CONCRETE BLOCK WALL			FS		LAT	LATITUDE
AC ACD				DIST DMBB	DISTANCE, DISTRICT DOUBLE METAL BEAM BARRIER		FAR SIDE, FINISHED SURFACE		
ACB	ASPHALT CONCRETE BASE ASBESTOS CEMENT PIPE	C-C CHSRA	CENTER TO CENTER CALIFORNIA HIGH-SPEED RAIL	DR	DRIVE	FSBT FTG	FACING SOUTHBOUND TRAFFIC FOOTING	LCB LLT	LEAN CONCRETE BASE LAST LONG TIE
ACP ADL	ADDED DEAD LOAD	CHSKA	AUTHORITY (SEE AUTHORITY)	DTBB	DOUBLE THRIE BEAM BARRIER	FWBT	FACING WESTBOUND TRAFFIC	LN	LANE
ADJ	ADJUST	CHSR	CALIFORNIA HIGH-SPEED RAIL	DWY	DRIVEWAY	FWY	FREEWAY	LOC	LOCATION
AFES	ALTERNATIVE FLARED END SECTION	CHST	CALIFORNIA HIGH-SPEED TRAIN	DWI	DRIVEWAI	L AA I		LOL	LAYOUT LINE
AHD	AHEAD	CG	CENTER OF GRAVITY		(E)		G	LONG	LONGITUDE
ALT	ALTERNATE	CHNL	CHANNEL	F	EAST	G	GRADE, ACCELERATION DUE TO	LONGIT	LONGITUDINAL
AM	TIME FROM MIDNIGHT TO NOON	CI	CAST IRON	EA	ACTUAL SUPERELEVATION	G	GRAVITY	LS	LUMP SUM, LENGTH OF SPIRAL
AP AP	ALTERNATIVE PIPE	CIDH	CAST-IN-DRILLED-HOLE	EASE	EASEMENT	GA	GAGE	LT	LEFT
APC	ALTERNATIVE PIPE CULVERT	CIP	CAST IN DRIELED HOLL  CAST-IN-PLACE, CAST IRON PIPE	EB	END OF BRIDGE, EASTBOUND	GALV	GALVANIZED	LVC	LENGTH OF VERTICAL CURVE
APPROX	APPROXIMATE	CIPCP	CAST-IN-PLACE CONCRETE PIPE	EC	END HORIZONTAL CURVE	GP GP	GRADING PLANE	LVC	
APU	ALTERNATIVE PIPE UNDERDRAIN	CISS	CAST-IN-FEACE CONCRETE FITE  CAST-IN-STEEL SHELL	ECR	END CURB RETURN	GR	GUARD RAILING		M
AR	ACCESS RESTRICTION	CJP	COMPLETE JOINT PENETRATION	ED	EDGE DRAIN	GRDR	GIRDER	MAINT	MAINTENANCE
ARS	ACCELERATION RESPONSE SPECTRUM	CL	CHAIN LINK, CLASS	EDC	EDGE DRAIN CLEANOUT	GSP	GALVANIZED STEEL PIPE	MAX	MAXIMUM
AS	AGGREGATE SUBBASE	CL-6	CHAIN LINK, CEASS  CHAIN LINK FENCE (6 FT)	EDO	EDGE DRAIN OUTLET	GTR	GUTTER	MB	METAL BEAM
ASRP	ALUMINUM SPIRAL RIB PIPE	CLR	CLEAR, CLEARANCE	EDV	EDGE DRAIN VENT			MBB	METAL BEAM BARRIER
ASSY	ASSEMBLY	CM	CORRUGATED METAL	ELEC	ELECTROLIER		(H)	MBGR	METAL BEAM GUARD RAILING
ATC	AUTOMATIC TRAIN CONTROL	CMP	CORRUGATED METAL PIPE	ELECT	ELECTRIC	Н	HEIGHT	MED	MEDIAN
ATPB	ASPHALT TREATED PERMEABLE BASE	СО	COUNTY	ELEV	ELEVATION	H, HR	HOUR	MER	MERCED
АТРМ	ASPHALT TREATED PERMEABLE MATERIAL	COL	COLUMN	EMB	EMBANKMENT	HD	HORIZONTAL DRAIN	MF	MERCED TO FRESNO
AUTHORITY		CONC	CONCRETE	ENGR	ENGINEER	HDWL	HEADWALL	MH	MANHOLE
AVE	AVENUE	COND	CONDUIT	EOD	EDGE OF DECK	HEX HD	HEXAGONAL HEAD	MIN	MINIMUM
AVG	AVERAGE	CONN	CONNECTOR	EP	EDGE OF PAVEMENT	НМА	HOT MIXED ASPHALT	MISC	MISCELLANEOUS
@	АТ	CONST	CONSTRUCT, CONSTRUCTION	EQ	EQUATION	HORIZ	HORIZONTAL	MISC I & S	S MISCELLANEOUS IRON AND STEEL
	В	CONT	CONTINUOUS	ES	EDGE OF SHOULDER	HP	HINGE POINT, HORSEPOWER	MKR	MARKER
		COORD	COORDINATE	ET	END TUNNEL	HPS	HIGH PERFORMANCE STEEL	MOD	MODIFIED, MODIFY
BAGR	BRIDGE APPROACH GUARD RAILING	CP	CANDLEPOWER	ETW	EDGE OF TRAVELED WAY	HS	HIGH STRENGTH	MON	MONUMENT
ВВ	BEGINNING OF BRIDGE	CP1	CONSTRUCTION PACKAGE 1	EU	UNBALANCED SUPERELEVATION	HSR	HIGH-SPEED RAIL	MOW	MAINTENANCE-OF-WAY FACILITY
В-В	BACK-TO-BACK	CR	CREEK	EVC	END VERTICAL CURVE	HST	HIGH-SPEED TRAIN	MP	METAL PLATE
ВС	BEGIN HORIZONTAL CURVE	CRCP	CONTINUOUS REINFORCED CONCRETE PAVEMENT	EW	ENDWALL	HW	HEADWALL,	MPGR	METAL PLATE GUARD RAILING
BCR	BEGIN CURB RETURN	CRSP	CONCRETED ROCK SLOPE PROTECTION	EXC	EXCAVATION		100-YR HIGH WATER (UNLESS NOTED	MPH	MILES PER HOUR
BEG	BEGIN	CRZ	CLEAR RECOVERY ZONE	EXIST, (E)	EXISTING		OTHERWISE)	MR	MOVEMENT RATING
BIT CTD	BITUMINOUS COATED	CS	CURVE SPIRAL POINT	EXP	EXPANSION, EXPRESSWAY	HWM	HIGH WATER MARK	MSE	MECHANICALLY STABILIZED EARTH
ВК	BACK	CSP	CORRUGATED STEEL PIPE	EXP JT	EXPANSION JOINT	HWY	HIGHWAY	MTL	MATERIAL
BKF	BACKFILL	CSPA	CORRUGATED STEEL PIPE ARCH	EXT	EXTERIOR		Ţ		N
BLDG	BUILDING	СТВ	CEMENT TREATED BASE		F				IN
BLM	BRIDGE-LOG MILE	CTPB	CEMENT TREATED PERMEABLE BASE		Г	IB	IMPORTED BORROW	N	NORTH
F BLVD	BOULEVARD	CTPM	CEMENT TREATED PERMEABLE MATERIAL	F & C	FRAME AND COVER	ID	INSIDE DIAMETER	NB	NORTHBOUND
8M	BENCH MARK	CTRS	CENTERS	F & G	FRAME AND GRATE	IF	INSIDE FACE	NC	NORMAL CROWN
BOT	BOTTOM	CULV	CULVERT	FB	FLOOR BEAM	INT	INTERIOR	NIC	NOT IN CONTRACT
BNSF	BNSF RAILWAY	<u>C</u>	CENTERLINE	FDN	FOUNDATION	INV	INVERT	NO.	NUMBER (MUST HAVE PERIOD)
₽ BR	BRIDGE			FEBT	FACING EASTBOUND TRAFFIC	IRR	IRRIGATION	NOS.	NUMBERS (MUST HAVE PERIOD)
BRG	BEARING			FES	FLARED END SECTION	IS	INTERLOCKING SITE	NPS	NOMINAL PIPE SIZE
ВТ	BEGIN TUNNEL	D	DEPTH	FF	FILTER FABRIC			NS	NEAR SIDE
e BIN	BRITISH THERMAL UNIT	DD	DOWNDRAIN	FG	FINISHED GRADE		U )	NTS	NOT TO SCALE
BVC	BEGIN VERTICAL CURVE	DBL	DOUBLE	FH	FIRE HYDRANT	JCT	JUNCTION		0
BW BW	BARBED WIRE	DEG	DEGREE	FIG	FIGURE	JP	JOINT POLE		
AUG		DEL	DELINEATOR	FL	FLOW LINE	JPCP	JOINTED PLAIN CONCRETE PAVEMENT	OBLR	OBLITERATE
15-			DESIGNED BY S. WELLS RECORD SET				CALIFORNIA HIGH-SPI	EED TRA	IN PROJECT CONTRACT NO. HSR08-05
			DRAWN BY W. JOHNSEN 15% DESIGN				MERCED TO FRI	ESNO SEC	
			SUBMITTAL I ( -> )	RSONS			CENTRAL VA		CV-B0020
<u></u>			IN CHARGE NOT FOR		CALIFOR	NIA	CIVIL AND GRADE S		PLANS SCALE NO SCALE
000	DV 01W 10D		C. LEMLEY CONSTRUCTION		HIGH-SPEED RAIL AU		ABBREVI SHEET 1		SHEET NO.
REV DATE	BY CHK APP DESCRIPTION		08/12/2016				1	-· <del>-</del>	

			DESIGNED BY S. WELLS RECORD SET				CALIFORNIA HIGH-SPEED TRAIN PROJEC
-	POINT OF VERTICAL CURVE						
PVC	POLYVINYL CHLORIDE,	SJD	SAN JOSE DIRIDON STATION	TIVIN	MACK		
PT	POINT OF TANGENCY	SIM	SIMILAR	TRK	TRACK		
PSP	PARALLELING STATION PERFORATED STEEL PIPE	SHLD SHT	SHOULDER SHEET	T/R TRANS	TOP OF RAIL TRANSITION		
PS, P/S	POINT OF SWITCH, PRESTRESSED,	SG	SUBGRADE SUGUI DER	TPSS	TRACTION POWER SUBSTATION		
PS&E	PLANS, SPECIFICATIONS AND ESTIMATES	SEP	SEPARATION	TPM	TREATED PERMEABLE MATERIAL		
PRVC	POINT OF REVERSE VERTICAL CURVE	SEC	SECOND, SECTION	TPF	TRACTION POWER FACILITY		
PRF	PAVEMENT REINFORCING FABRIC	SD	STORM DRAIN	TPB	TREATED PERMEABLE BASE		
PRC	POINT OF REVERSE CURVE	SCSP	SLOTTED CORRUGATED STEEL PIPE	TP	TELEPHONE POLE		
PPP	PERFORATED PLASTIC PIPE	SC	SAND CUSHION, SPIRAL CURVE POINT	ТОТ	TOTAL		
PPL	PREFORMED PERMEABLE LINER	SB	SOUTHBOUND	ТО	TURNOUT	YRS	YEARS
	POWER POLE	SAPP	STRUCTURAL ALUMINUM PLATE PIPE	ТМ	TECHNICAL MEMORANDUM	YR	YEAR
PP	PIPE PILE, PLASTIC PIPE,	SALV	SALVAGE	TG	TOP OF GRADE		( <u>Y</u>
POVC	POINT OF VERTICAL CURVE	SAE	STRUCTURE APPROACH EMBANKMENT	TEMP	TEMPORARY		
POT	POINT OF TANGENT	S	SOUTH, SUPPLEMENT	TEL	TELEPHONE	XO	CROSSOVER
POE	POINT OF END		(S)	TCE	TEMPORARY CONSTRUCTION EASEMENT	XING	CROSSING
POC	POINT OF BEGINNING  POINT OF HORIZONTAL CURVE	17.11/1		TCB	TRAFFIC CONTROL BOX	X SEC	CROSS SECTION
PN POB	PAVING NOTCH POINT OF BEGINNING	R∕W RWY	RIGHT-OF-WAY RAILWAY	TBR TC	TIMBER TOP OF CURB, TRAIN CONTROL		X
DNI	TIME FROM NOON TO MIDNIGHT	D //W	RETAINING WALL	TBD	TO BE DETERMINED	WWLOL	WINGWALL LAYOUT LINE
РМ	POST MILE,	RW	REDWOOD,	TBB	THRIE BEAM BARRIER	WW	WINGWALL
P/L	PROPERTY LINE	RTE	ROUTE	TAN	TANGENT	WV	WATER VALVE
₽, PL	PLATE	RT	RIGHT	TAB	TABLET	WT	WEIGHT
PJP	PARTIAL JOINT PENETRATION	RSP	ROCK SLOPE PROTECTION	Т	SEMI-TANGENT	WSP	WELDED STEEL PIPE
PITO	POINT OF INTERSECTION TURNOUT	RR	RAILROAD			WS	WATER SURFACE
PΙ	POINT OF INTERSECTION		REFERENCE POINT		Т	WM	WIRE MESH
PG&E	PACIFIC GAS AND ELECTRIC	RP	RADIUS POINT,	S4S	SURFACE 4 SIDES	WH	WEEP HOLE
PG	PROFILE GRADE	RM	ROAD-MIXED	SYM	SYMMETRICAL	WCB	WORLD COORDINATE BEARING
PERM MTL	PERMEABLE MATERIAL	RDWY	ROADWAY	SWS	SWITCHING STATION	wB	WESTBOUND
PED UC	PEDESTRIAN UNDERCROSSING	REV	REVISED	SWR	SEWER	W	WEST, WIDTH
PED OC	PEDESTRIAN OVERCROSSING	RET	RETAINING	SW	SIDEWALK, SOUND WALL		W
PED	PEDESTRIAN	REPL	REPLACEMENT	SURF	SURFACING	VOL	
PCVC	POINT OF COMPOUND VERTICAL CURVE	REL	RELOCATE	STR	STRUCTURE	VIA	VIADUCI
PCP	PRESTRESSED CONCRETE PIPE,	REINF	REINFORCED, REINFORCEMENT, REINFORCING	STBB STD	SINGLE THRIE BEAM BARRIER STANDARD	VERT	VERTICAL VIADUCT
DCD	PORTLAND CEMENT CONCRETE PERFORATED CONCRETE PIPE.	RD DE INE	ROAD	STA	STATION	VCP VERT	VITRIFIED CLAY PIPE
PCC	POINT OF COMPOUND CURVE,	RCPA	REINFORCED CONCRETE PIPE ARCH	ST	STREET, SPIRAL TANGENT POINT	VC	VERTICAL CURVE
PC	POINT OF CURVATURE, PRECAST	RCP	REINFORCED CONCRETE PIPE	SSRP	STEEL SPIRAL RIB PIPE	VAR	VARIABLE
PB	PULL BOX, PHASE BREAK	RCB	REINFORCED CONCRETE BOX	SSPPA	STRUCTURAL STEEL PLATE PIPE ARCH	٧	DESIGN SPEED, VALVE
PAP	PERFORATED ALUMINUM PIPE	RCA	REINFORCED CONCRETE ARCH	SSPP	STRUCTURAL STEEL PLATE PIPE		
Р	PAGE	R/C	RATE OF CHANGE	SSPA	STRUCTURAL STEEL PLATE ARCH		V
	P	R & S	REMOVE AND SALVAGE	SSD	STRUCTURAL SECTION DRAIN	UXO	UNIVERSAL CROSSOVER
	P	R & D	REMOVE AND DISPOSE	SSBM	STRAP AND SADDLE BRACKET METHOD	UPRR	UNION PACIFIC RAILROAD
OPP	OPPOSITE	R	RADIUS	SS	SLOPE STAKE, SUBSTATION	UP	UNDERPASS
0-0	OUT TO OUT			SRS	STANDALONE RADIO SITE	UON	UNLESS OTHERWISE NOTED
OH	OVERHEAD	Q I I		SR	STATE ROUTE	UD	UNDERDRAIN
OGAC	OPEN GRADED ASPHALT CONCRETE	QTY	QUANTITY	SPP	SLOTTED PLASTIC PIPE	UC	UNDERCROSSING
OG	OUTSIDE FACE ORIGINAL GROUND		Q	SPEC	SPECIAL, SPECIFICATIONS		U
OD OF	OUTSIDE DIAMETER	PVT	POINT OF VERTICAL TANGENT	S SM	STATION LINE SELECTED MATERIAL	TYP	TYPICAL
ocs	OVERHEAD CONTACT SYSTEM	PVMT	PAVEMENT	SJV	SAN JOAQUIN VALLEY	T.V.D	TUBULAR STEEL, TANGENT SPIRAL POINT
OC	OVERCROSSING	PVI	POINT OF VERTICAL INTERSECTION	SJM	SAN JOSE TO MERCED	TS	TRANSVERSE, TRAFFIC SIGNAL,
			( P CONTINUED )		(S CONTINUED)		(T CONTINUED)

NOT FOR CONSTRUCTION

IN CHARGE
C. LEMLEY

DATE 08/12/2016

DESCRIPTION


REV DATE

BY CHK APP

CENTRAL VALLEY WYE
CIVIL AND GRADE SEPARATION PLANS
ABBREVIATIONS SHEET 2 OF 2

CONTRACT NO. HSRO8-05 DRAWING NO. CV-B0021 SCALE NO SCALE

SHEET NO.

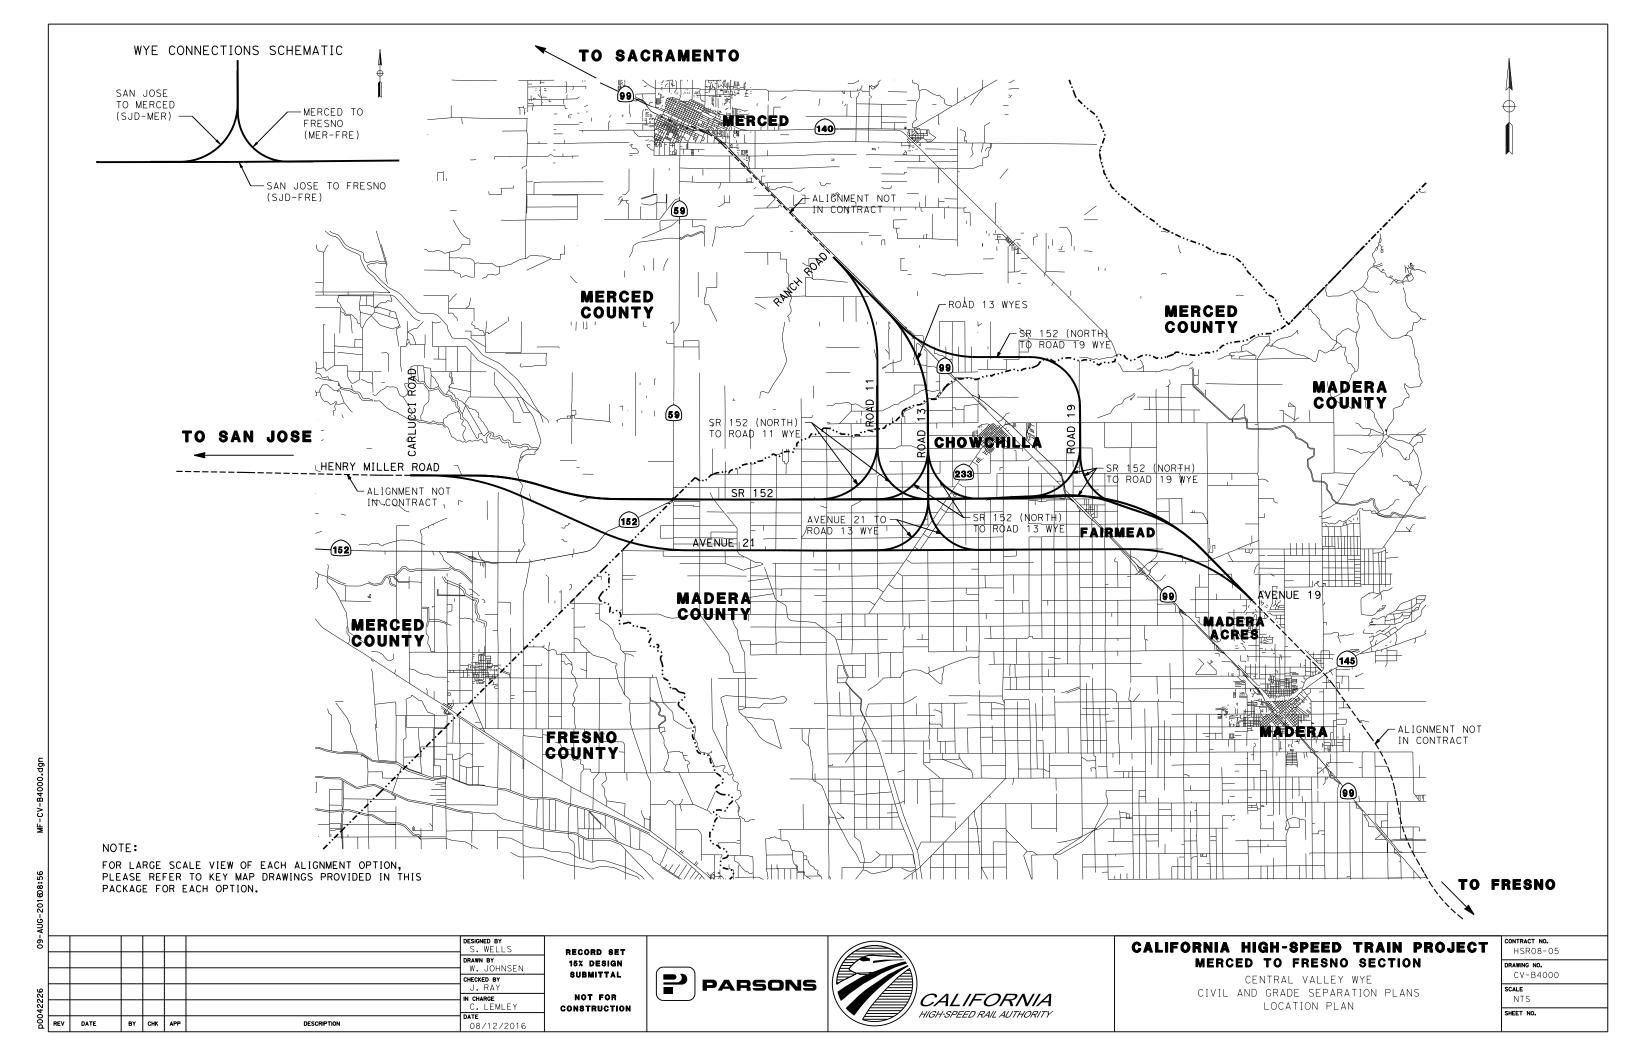

- 1. DESIGN IS BASED ON THE FOLLOWING STANDARDS:
  - CALIFORNIA HIGH-SPEED RAIL AUTHORITY DIRECTIVE DRAWINGS FOR HIGH-SPEED RAIL PROJECT FACILITIES
  - CALTRANS HIGHWAY DESIGN MANUAL FOR STATE HIGHWAY FACILITIES
     LOCAL AGENCY STANDARDS FOR ALL OTHER FACILITIES
- 2. THE HORIZONTAL CONTROL DATUM IS NAD 83. ALL ELEVATIONS ARE BASED ON NAVD 88.
- 3. ALL MAJOR UTILITIES ARE SHOWN ON THE PLANS. PLEASE REFERENCE THE SECTION UTILITY REPORT FOR A DISCUSSION OF HIGH VS. LOW RISK AND MINOR UTILITIES.
- 4. RETAINING WALL TYPES ARE NOT SHOWN DUE TO CURRENT LACK OF GEOTECHNICAL BORINGS. IT CAN BE ASSUMED FOR COST PURPOSES THAT ALL FILL RETAINING WALLS ARE MSE AND THAT ALL CUT RETAINING WALLS ARE SOIL NAIL. PRELIMINARY RETAINING WALL TYPES WILL BE FINALIZED BASED ON SUBSEQUENT GEOTECHNICAL EXPLORATION.
- 5. MAJOR WATERCOURSES, IRRIGATION CANALS, AND BODIES OF WATER ARE SHOWN ON THE PLANS. FOR FURTHER INFORMATION REGARDING DRAINAGE DESIGN, PLEASE REFER TO THE FOLLOWING:

  - HYDROLOGY AND HYDRAULICS REPORT FLOODPLAIN IMPACTS ASSESSMENT REPORT
  - STORM WATER MANAGEMENT REPORT
  - STRUCTURE, VIADUCT AND TUNNEL PLANS (FOR FLOW DIRECTION)
- 6. WHERE PROPOSED ROADWAY R/W AND ROADWAY TCE LINES CROSS PERPENDICULAR TO EXISTING ROADWAY R/W LINES, IT IS ASSUMED THESE LINES SHOW A DEMARCATION OF CONSTRUCTION LIMITS. THEY ARE NOT INTENDED TO BE CONSTRUED AS A JURISDICTIONAL
- 7. EMERGENCY VEHICLE ACCESS SHALL BE MAINTAINED AT ALL TIMES.
- 8. CUL-DE-SACS WERE DESIGNED BASED ON MERCED COUNTY STANDARD (ST-12).
- 9. METAL BEAM GUARD RAILING WAS DESIGNED PER CALTRANS STANDARD PLANS (A77) AND AASHTO ROADSIDE DESIGN GUIDE (TABLE 5-10).

ΑŬ								
-60							DESIGNED BY	
							DRAWN BY W. JOHNSEN	ĺ
9							CHECKED BY J. RAY	ĺ
p0042226							IN CHARGE C. LEMLEY	1
00d	REV	DATE	BY	снк	APP	DESCRIPTION	08/12/2016	

RECORD SET 15% DESIGN SUBMITTAL NOT FOR






#### CALIFORNIA HIGH-SPEED TRAIN PROJECT MERCED TO FRESNO SECTION


CIVIL AND GRADE SEPARATION PLANS GENERAL NOTES


HSR08-05
DRAWING NO. CV-B0030

NO SCALE SHEET NO.

CENTRAL VALLEY WYE

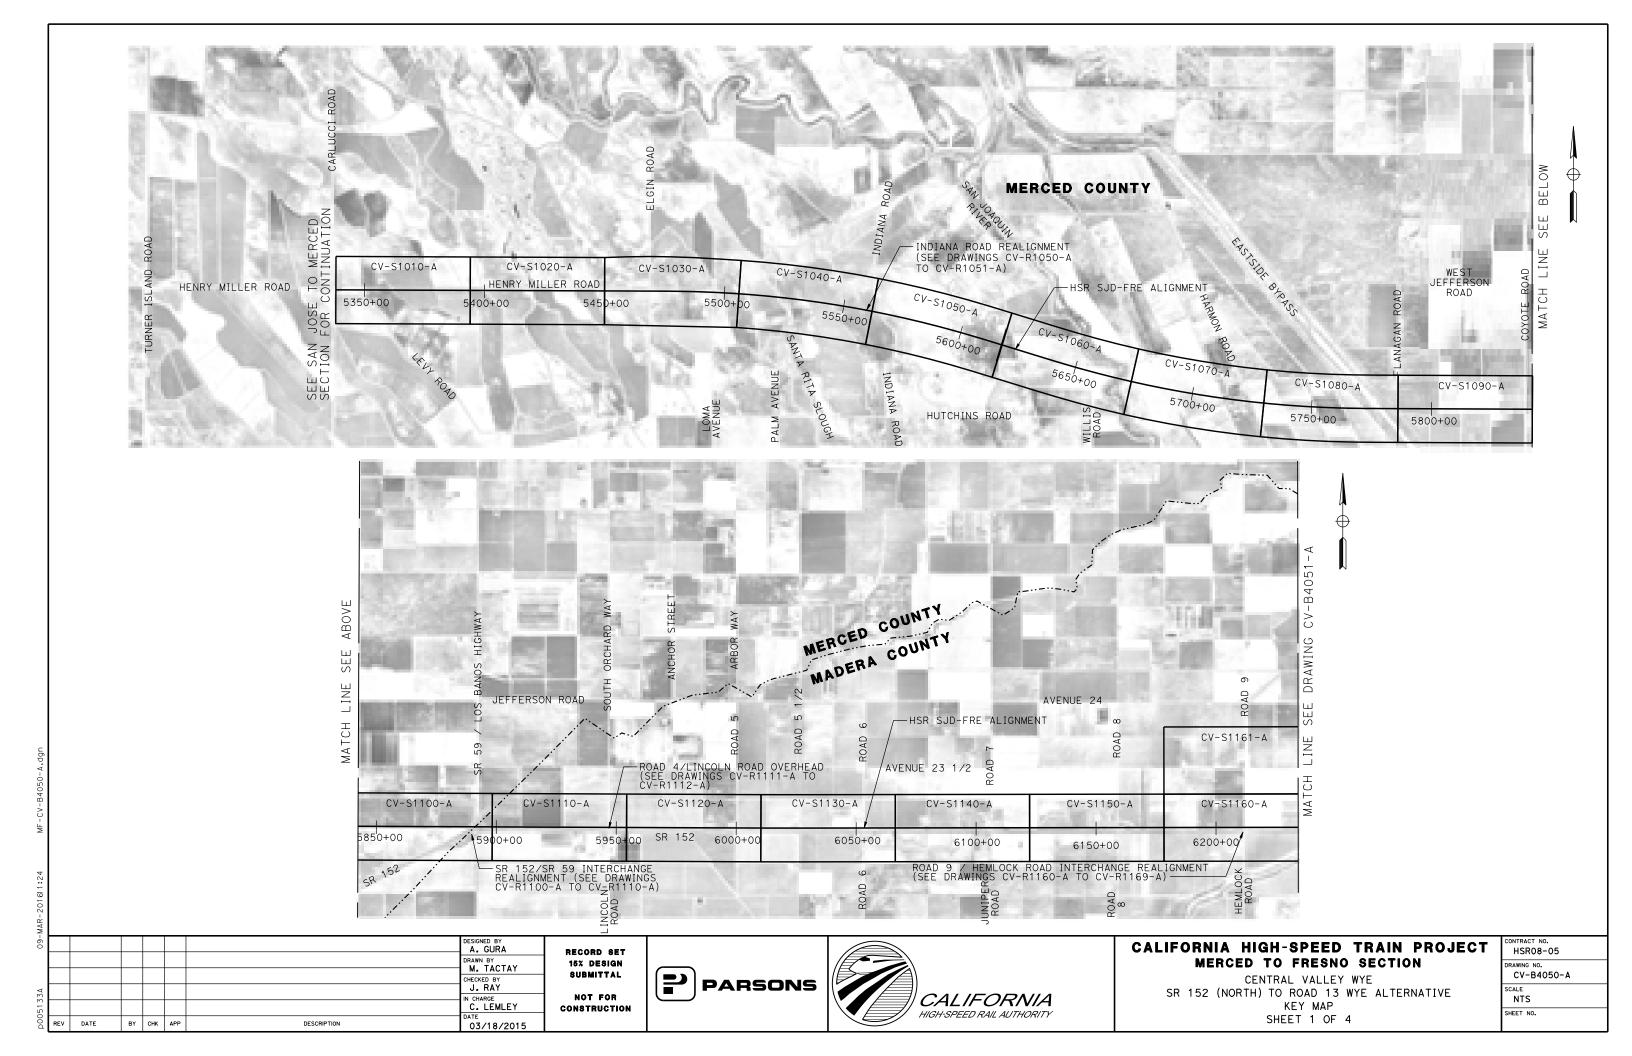

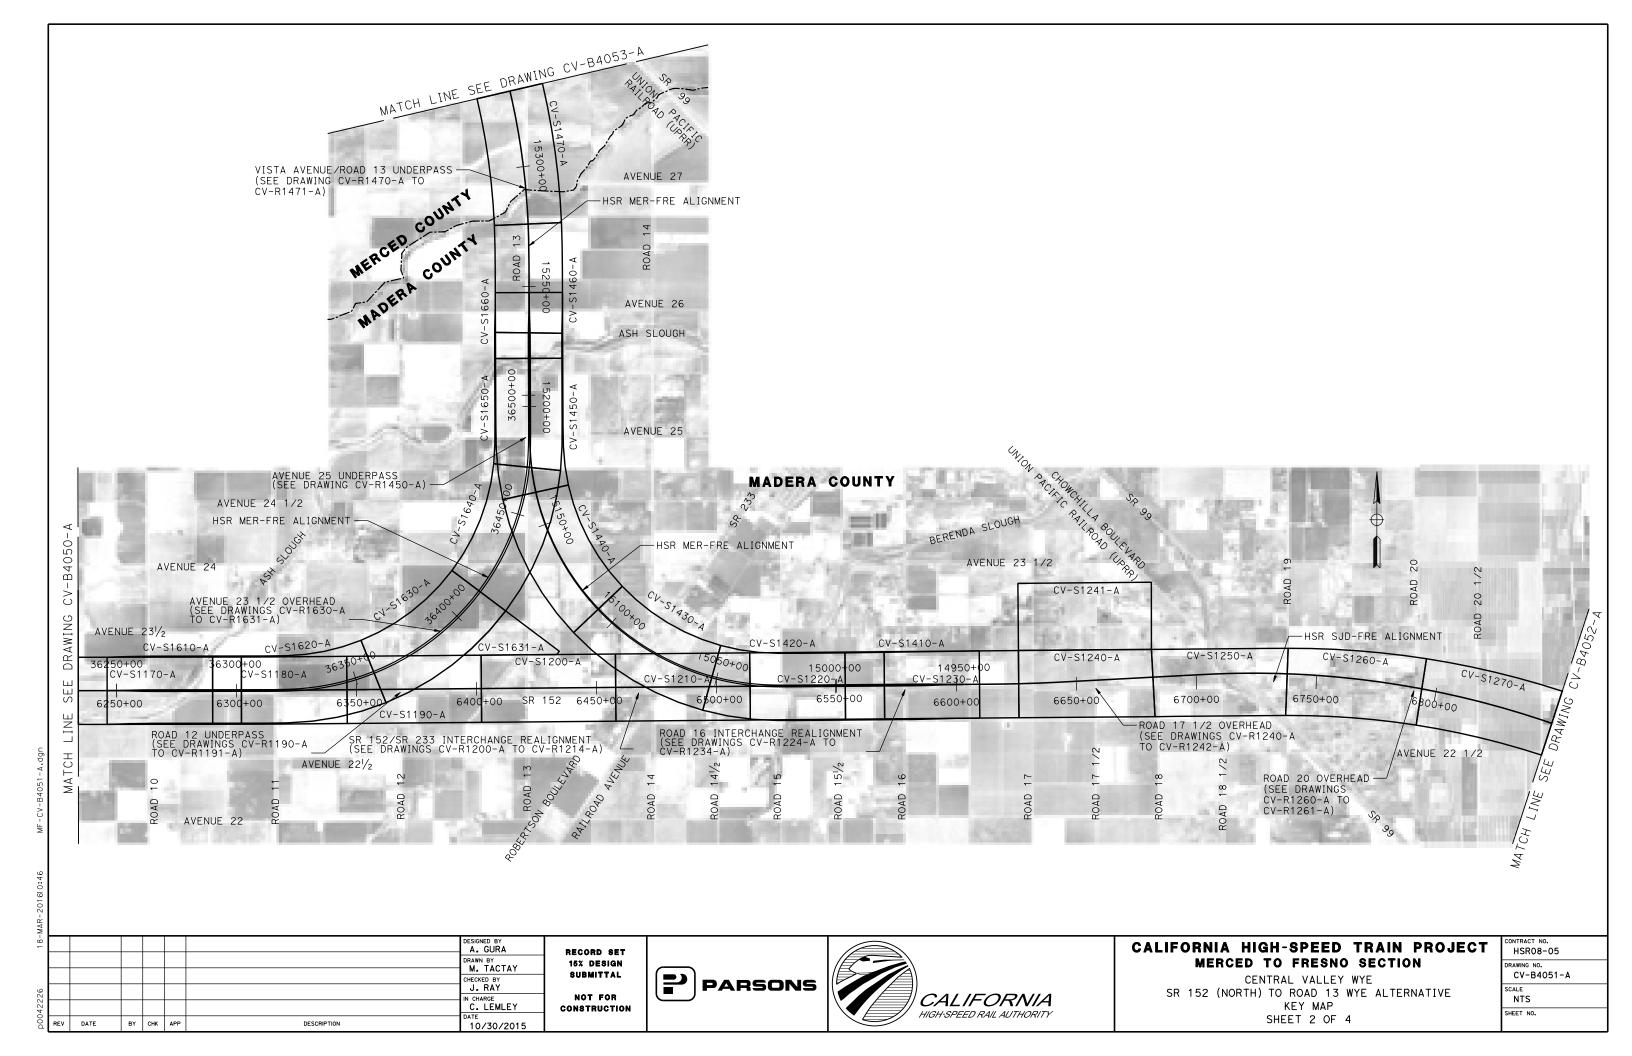

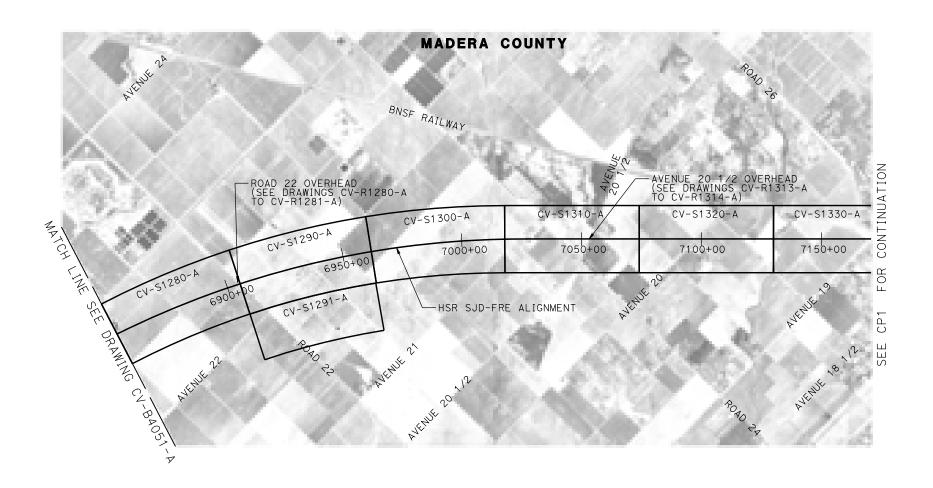



DESIGNED BY
A. GURA
DRAWN BY
M. TACTAY
CHECKED BY
J. RAY
IN CHARGE
C. LEMLEY
DATE
BY CHK APP
DESCRIPTION
DATE
03/18/2016

RECORD SET
15% DESIGN
SUBMITTAL
NOT FOR
CONSTRUCTION





### CALIFORNIA HIGH-SPEED TRAIN PROJECT MERCED TO FRESNO SECTION

CENTRAL VALLEY WYE
SR 152 (NORTH) TO ROAD 13 WYE ALTERNATIVE
KEY MAP
SHEET 3 OF 4

CONTRACT NO.
HSR08-05
DRAWING NO.
CV-B4052-A
SCALE
NTS
SHEET NO.

MA								
-60							DESIGNED BY A. GURA	_
							DRAWN BY M. TACTAY	
٨							CHECKED BY J. RAY	
5133A							IN CHARGE C. LEMLEY	C.
,500d	REV	DATE	BY	СНК	APP	DESCRIPTION	03/18/2016	





### CALIFORNIA HIGH-SPEED TRAIN PROJECT MERCED TO FRESNO SECTION

CENTRAL VALLEY WYE
SR 152 (NORTH) TO ROAD 13 WYE ALTERNATIVE
KEY MAP
SHEET 4 OF 4

CONTRACT NO.
HSR08-05
DRAWING NO.
CV-B4053-A
SCALE
NTS
SHEET NO.

CC

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-						T
						DESIGNED BY A. GURA
						DRAWN BY M. TACTAY
						CHECKED BY
						J. RAY
						C. LEMLEY
REV	DATE	BY	СНК	APP	DESCRIPTION	DATE 10/30/2015

ROAD

"ALIGNMENT NAME"

CURVE NO.

ВС

RECORD SET 15% DESIGN SUBMITTAL NOT FOR CONSTRUCTION





DELTA

 $\triangle$ 

RADIUS

(FT)

#### CALIFORNIA HIGH-SPEED TRAIN PROJECT MERCED TO FRESNO SECTION

CENTRAL VALLEY WYE SR 152 (NORTH) TO ROAD 13 WYE ALTERNATIVE GEOMETRY DATA TABLE SHEET 1 OF 6

CONTRACT NO. HSR08-05
DRAWING NO. CV-B0060-A
NO SCALE
SHEET NO.

TANGENT

(FT)

LENGTH

(FT)

DEGREE OF CURVATURE (ARC)

Š							
-60							DESIGNED BY A. GURA
							DRAWN BY M. TACTAY
							CHECKED BY
γ							J. RAY
513							C. LEMLEY
1500d	REV	DATE	BY	СНК	APP	DESCRIPTION	DATE 10/30/2015

RECORD SET 15% DESIGN Submittal Not for

CONSTRUCTION





### CALIFORNIA HIGH-SPEED TRAIN PROJECT MERCED TO FRESNO SECTION

CENTRAL VALLEY WYE SR 152 (NORTH) TO ROAD 13 WYE ALTERNATIVE GEOMETRY DATA TABLE SHEET 2 OF 6

CONTRACT NO.
HSR08-05
DRAWING NO.
CV-B0061-A
SCALE
NO SCALE
SHEET NO.

ROAD "ALIGNMENT NAME"	CURVE NO.		ВС	PI	СС	EC	RADIUS (FT)	DELTA	DEGREE OF CURVATURE (ARC)	LENGTH (FT)	TANGEN (FT)
		STATION	52+03.54	53+67.46		55+31.05	3,000.00	6°15′17.78"	1°54′35.49''	327.51	163.92
	103-01	NORTHING	1853976.13	1853812.6	1854183.46	1853651.29		LEFT			
		EASTING	6563936.73	6563948.06	6566929.56	6563977.13					
	103-02	STATION	55+31.05	63+97.93		69+59.47	1,000.00	81° 50′33.51"	5° 43′46.48"	1,428.42	866.88
		NORTHING	1853651.29	1852798.16	1853828.68	1852829.33		LEFT			
		EASTING	6563977.13	6564130.91	6564961.27	6564997.23					
		STATION	77+47.81	80+63.60		83+79.32	18,077.00	2°00′05.77"	0°19′01.03"	631.51	315.79
"ALIGNMENT NAME"  WB SR 152 TO NB SR 59 RAMP "WB OFF RAMP"	103-03	NORTHING	1852857.67	1852869.02	1834792.36	1852869.35		RIGHT			
		EASTING	6565785.06	6566100.64	6566435.00	6566416.43					
		STATION	45+66.64			50+57.29	150.00	187°24′58.88"	38°11′49.87"	490.65	0.00
	104-01	NORTHING	1851816.07		1851950.65	1852092.65		RIGHT			
		EASTING	6563300.54		6563234.29	6563185.97					
		STATION	53+88.24	54+71.80		55+55.31	2,570.00	3° 43′28.19"	2°13′45.87"	167.06	83.56
	104-02	NORTHING	1852199.27	1852226.18	1849766.26	1852247.91		RIGHT			
		EASTING	6563499.28	6563578.38	6564327.17	6563659.07					
		STATION	55+55.31	57+05.36		58+55.41	17,921.00	0° 57′34.14"	0°19′10.97"	300.11	150.06
WB SR 152 TO NB SR 59 RAMP "WB OFF RAMP"  SB SR 59 TO EB SR 152 LOOP ON RAMP "EB LOOP RAMP"  SR 152 REALIGNMENT AT ROAD 9 "SR 152/ROAD 9"  ROAD 9/SR 152 FB OFF RAMP	104-03	NORTHING	1852247.91	1852286.91	1834943.04	1852323.49		RIGHT			
		EASTING	6563659.07	6563803.97	6568317.82	6563949.50					163.92 866.88 315.79
		STATION	14+30.85	18+97.60		23+61.75	5,100.00	10°27′29.06"	1° 07′24.41"	930.89	466.74
	160-01	NORTHING	1852856.89	1852856.05	1847756.90	1852770.49		RIGHT			
		EASTING	6592662.51	6593129.26	6592653.25	6593588.09					
		STATION	31+86.42	36+65.87		41+42.52	5,100.00	10° 44′28.52"	1° 07′24.41"	956.10	479.45
	160-02	NORTHING	1852619.33	1852531.44	1857632.91	1852532.94		LEFT			
SR 152 REALIGNMENT AT ROAD 9		EASTING	6594398.79	6594870.12	6595333.63	6595349.57					
		STATION	52+03.02	56+66.40		61+27.24	5,100.00	10°22′59.34"	1° 07′24.41"	924.22	463.38
	160-03	NORTHING	1852536.25	1852537.7	1857636.23	1852622.64		LEFT			
		EASTING	6596410.07	6596873.45	6596394.13	6597328.98					
		STATION	69+37.21	74+00.59		78+61.43	5,100.00	10°22′59.34"	1° 07′24.41"	924.22	463,38
	160-04	NORTHING	1852771.11	1852856.05	1847757.52	1852857.5		RIGHT			(FT) 31 163.92 42 866.88 31 315.79 5 0.00 6 83.56 1 150.06 9 466.74 0 479.45 2 463.38 2 463.38 0 264.03 6 333.04
		EASTING	6598125.22	6598580.75	6599060.06	6599044.13					
		STATION	25+62.64	28+26.67		30+89.34	3,000.00	10°03′32.93"	1° 54′35.49"	526.70	264.03
"ALIGNMENT NAME"  WB SR 152 TO NB SR 59 RAMP "WB OFF RAMP"  SB SR 59 TO EB SR 152 LOOP ON RAMP "EB LOOP RAMP"  SR 152 REALIGNMENT AT ROAD 9 "SR 152/ROAD 9"  ROAD 9/SR 152 EB OFF RAMP "EB OFF RAMP"	161-01	NORTHING	1852632.87	1852562.61	1849741.01	1852448.99		RIGHT			
ROAD 9/SR 152 FB OFF RAMP	STATION   Sept.   STATION   Sept.   Sept.										
"SR 152/ROAD 9"  ROAD 9/SR 152 FB OFF RAMP		STATION	38+53.84	41+86.88		45+09.29	1,500.00	25°02′11.73"	3°49′10.99"	655.46	333.04
	161-02	NORTHING	1852119.98	1851976.65	1853473.97	1851974.01		LEFT			
		EASTING	6594950.11	6595250.74	6595595.65	6595583.77					
		STATION	46+58.21	49+60.83		52+55.44	1,500.00	22°48′44.95"	3°49′10.99''	597.23	302.62
	162-01	NORTHING	1851984.11	1851984.11	1853484.11	1852101.44		LEFT			
ROAD 9/SR 152 FB ON RAMP			6595983.41	6596286.03	6595983.41	6596564.98					
"EB ON RAMP"		STATION	62+99.90	65+91.52		68+81.32	3,000.00	11°06′15.69"	1° 54′35.49"	581.42	291.62
"EB LOOP RAMP"  SR 152 REALIGNMENT AT ROAD 9 "SR 152/ROAD 9"  ROAD 9/SR 152 EB OFF RAMP "EB OFF RAMP"	162-02	NORTHING	1852506.39		1849741.06	1852678.64					
											1

MAM						
- 60						DESIGNED BY A. GURA
						DRAWN BY M. TACTAY
						CHECKED BY J. RAY
5   5 S A						IN CHARGE C. LEMLEY
REV	DATE	ВҮ	СНК	APP	DESCRIPTION	DATE 03/18/2016





#### CALIFORNIA HIGH-SPEED TRAIN PROJECT MERCED TO FRESNO SECTION

CENTRAL VALLEY WYE SR 152 (NORTH) TO ROAD 13 WYE ALTERNATIVE GEOMETRY DATA TABLE SHEET 3 OF 6

CONTRACT NO. HSR08-05
DRAWING NO. CV-BOO62-A
NO SCALE

SHEET NO.

	202-01	NORTHING	1852116.15	1852044.25	1852188.37	1852088.05		RIGHT			Í
		EASTING	6620190.24	6620141.45	6620113.28	6620066.40					
		STATION	13+02.25	19+40.71		18+09.14	200.00	145°12′47.90"	28° 38′52.40"	506.89	638.4
SR 233/SR 152 EB LOOP RAMP	202-02	NORTHING	1852169.95	1852491.79	1852342.68	1852542.06		RIGHT			
EB EOOI TRAWII		EASTING	6619926.08	6619374.67	6620026.90	6620011.15					
		STATION	22+51.67	23+35.24		24+18.76	3,000.00	3°11′28.67"	1° 54′35.49''	167.10	83.5
	202-03	NORTHING	1852576.90	1852583.48	1849586.22	1852585.42		RIGHT			
"EB LOOP RAMP"  SR 233/SR 152 WB ON RAMP "WB ON RAMP"  SR 233/SR 152 EB ON RAMP "EB ON RAMP"  SR 233/SR 152 WB OFF RAMP "WB OFF RAMP"  CATES COURT "CATES CT"		EASTING	6620452.30	6620535.61	6620688.52	6620619.16					
		STATION	16+72.81	22+15.00		27+45.61	3,000.00	20° 29′20''	1° 54′35"	1,072.80	542.1
	203-01	NORTHING	1852867.39	1852793.36	1855839.30	1852912.03		LEFT			
SR 233/SR 152 WB ON RAMP		EASTING	6618965.65	6619502.76	6619375.23	6620031.81					
		STATION	31+35.85	32+43.86		33+45.37	350.00	34° 17′55"	16° 22′13"	209.52	108.0
	203-02	NORTHING	1852997.44	1853021.07	1852655.92	1852981.22		RIGHT			
"EB LOOP RAMP"  SR 233/SR 152 WB ON RAMP "WB ON RAMP"  SR 233/SR 152 EB ON RAMP "EB ON RAMP"  SR 233/SR 152 WB OFF RAMP "WB OFF RAMP"  CATES COURT "CATES CT"  SR 152 REALIGNMENT AT ROAD 16		EASTING	6620412.59	6620517.98	6620489.19	6620618.36					
		STATION	12+18.03	15+67.22		18+50.52	600.00	60°23′53.55"	9° 32′57.47"	632.49	349.2
	210-01	NORTHING	1851893.73	1851717.71	1852411.92	1851892.98		LEFT			
SP 233/SP 152 FR ON RAMP		EASTING	6620323.95	6620625.53	6620626.40	6620927.55					
		STATION	29+50.66	34+43.98		39+28.54	3,000.00	18°40′34.42"	1° 54′35.49"	977.88	493.
"EB LOOP RAMP"  SR 233/SR 152 WB ON RAMP "WB ON RAMP"  SR 233/SR 152 EB ON RAMP "EB ON RAMP"  SR 233/SR 152 WB OFF RAMP "WB OFF RAMP"  CATES COURT "CATES CT"  SR 152 REALIGNMENT AT ROAD 16	210-02	NORTHING	1852445.17	1852692.78	1849850.44	1852790.72	,	RIGHT			
		EASTING	6621879.08	6622305.75	6623384.86	6622789.25					
		STATION	37+30.21	38+77.53		40+19.14	600.00	27° 35′29''	9° 32′57''	288.94	147.
"EB LOOP RAMP"  SR 233/SR 152 WB ON RAMP "WB ON RAMP"  SR 233/SR 152 EB ON RAMP "EB ON RAMP"  SR 233/SR 152 WB OFF RAMP "WB OFF RAMP"  CATES COURT "CATES CT"  SR 152 REALIGNMENT AT ROAD 16	211-01	NORTHING	1852847.48	1852793.11	1853405.13	1852808.35		LEFT			
		EASTING	6620987.67	6621124.60	6621209.10	6621271.14					
		STATION	52+23.14	54+44.03		56+64.66	5,177.00	4° 53′11"	1° 06′24''	441.52	220.9
	211-02	NORTHING	1852932.83	1852955.67	1847783.58	1852959.71		RIGHT	. 00 2 .		
		EASTING	6622468.68	6622688.39	6623003.95	6622909.25					
	212-01	STATION	13+44.20	14+13.01		14+78.49	250.00	30°46′36.50"	22°55′05 <b>.</b> 92"	134.29	68.8
		NORTHING	1854386.24	1854347.54	1854179.52	1854285.18		RIGHT			
CATES COLIDI		EASTING	6622168.17	6622225.07	6622027.58	6622254.15					
"CATES COURT		STATION	15+34.15	16+02.94		16+68.41	250.00	30° 46′14.25"	22° 55′05 <b>.</b> 92"	134.26	68.7
"EB LOOP RAMP"  SR 233/SR 152 WB ON RAMP "WB ON RAMP"  SR 233/SR 152 EB ON RAMP "EB ON RAMP"  SR 233/SR 152 WB OFF RAMP "WB OFF RAMP"  CATES COURT "CATES CT"  SR 152 REALIGNMENT AT ROAD 16	212-01	NORTHING	1854234.74	1854172.40	1854340.41	1854133.70		LEFT			
		EASTING	6622277.68	6622306.75	6622504.25	6622363.63					
"EB LOOP RAMP"  SR 233/SR 152 WB ON RAMP "WB ON RAMP"  SR 233/SR 152 EB ON RAMP "EB ON RAMP"  SR 233/SR 152 WB OFF RAMP "WB OFF RAMP"  CATES COURT "CATES CT"  SR 152 REALIGNMENT AT ROAD 16		STATION	14+25.89	19+02.52	0022001120	23+76.40	5,100.00	10°40′42.20"	1°07′24.41''	950.50	476.0
	220-01	NORTHING	1853031.56	1853042.05	1847932.80	1852964.06	3,100100	RIGHT	1 01 2111	330.30	
		EASTING	6629753.42	6630229.94	6629865.63	6630700.14					
		STATION	28+57.10	33+02.66	0023003103	37+45.96	5,100.00	9°59′09.18"	1°07′24.41''	888.86	445.5
	220-02	NORTHING	1852885.4	1852812.49	1857916.66	1852816.91	3,100100	LEFT	1 01 2111	000100	1131
		EASTING	6631174.37	6631613.92	6632008.89	6632059.46					
"SR 152/ROAD 16"		STATION	48+64.72	53+03.74	0032000:03	57+40.60	5,100.00	9°50′24.30"	1°07′24.41''	875.88	439.0
	220-03	NORTHING	1852828.00	1852832.36	1857927.75	1852911.67	3,100100	LEFT	1 01 2111	013100	1001
	220 00	EASTING	6633178.16	6633617.16	6633127.59	6634048.96					
		STATION	63+83.13	68+31.57	333721133	72+77.70	5,100.00	10°03′00.07"	1° 07′24.41''	894.57	448.4
	220-04	NORTHING	1853027.75	1853108.76	1848011.67	1853111.57	3,100100	RIGHT		331831	110.
	220 07	EASTING	6634680.92	6635121.98	6635602.29	6635570.4		1/10/11			
	1	LASTINO	0007000.02	0000121.00	0000002.20	0000010.7					

Σ								
-60						ī	DESIGNED BY	
							RAWN BY	1
							CHECKED BY	ł
3A							J. RAY	ł
513							C. LEMLEY	(
p0051	REV	DATE	BY	СНК	APP		03/18/2016	

ROAD "ALIGNMENT NAME"

CURVE NO.

202-01

STATION

NORTHING

ВС

10+00.00

1852116.15

PΙ

10+86.90

1852044.25

CC

1852168.37

RECORD SET
15% DESIGN
SUBMITTAL
NOT FOR
CONSTRUCTION





RADIUS (FT)

93.00

ЕC

11+39.78

1852088.05

DELTA

86°06′5<u>Ø</u>38"

RIGHT

DEGREE OF CURVATURE (ARC)

61° 36′30.11"

### CALIFORNIA HIGH-SPEED TRAIN PROJECT MERCED TO FRESNO SECTION

CENTRAL VALLEY WYE
SR 152 (NORTH) TO ROAD 13 WYE ALTERNATIVE
GEOMETRY DATA TABLE
SHEET 4 OF 6

LENGTH (FT)

139.78

TANGENT (FT)

86.90

CONTRACT NO.
HSR05-05
DRAWING NO.
CV-B0063-A
SCALE
NO SCALE
SHEET NO.

ROAD "ALIGNMENT NAME"	CURVE NO.		ВС	PI	CC	EC	RADIUS (FT)	DELTA	DEGREE OF CURVATURE (ARC)	LENGTH (FT)	TANGEN ⁻ (FT)
		STATION	16+67.72	23+35.36		29+95.16	5,000.00	15°12′40.64"	1°08′45.30"	1,327.44	667.64
	221-01	NORTHING	1852981.15	1852877.22	1848042.10	1852603.89		RIGHT			
ROAD 16/SR 152 FB OFF RAMP		EASTING	6629993.95	6630653.46	6629215.62	6631262.59					
"EB OFF RAMP"		STATION	34+96.52	38+17.64		41+29.21	1,500.00	24°10′00.28"	3°49′10.99"	632.68	321.12
"ALIGNMENT NAME"  ROAD 16/SR 152 EB OFF RAMP	221-02	NORTHING	1852398.63	1852267.17	1853767.17	1852267.17		LEFT			
		EASTING	6631720.02	6632012.99	6632334.11	6632334.11					
		STATION	19+63.41	21+13.74		22+63.98	5.024.00	3° 25′40"	1° 08′26''	300.57	150.33
	222-01	NORTHING	1853068.53	1853065.87	1848045.32	1853054.22	,,,,,,,,,,,,,,,,,,,,,,,,,,,,,,,,,,,,,,,	RIGHT			
DOAD 16 (SD 152 WD ON DAMD		EASTING	6630294.90	6630445.21	6630205.95	6630595.08					
		STATION	25+90.18	29+78.04		33+65.52	10.000.00	4° 26′32"	0° 34′23"	775.33	387.86
	222-02	NORTHING	1853028.96	1852998.91	1862998.91	1852998.91	10,000.00		0 0 1 2 0	113833	331133
	222 02	EASTING	6630920.31	6631307.00	6631694.86	6631694.86					
		STATION	43+83.24	46+71.67	0031094.00		1 200 00	27°01'47 16"	4° 46'20 73"	566 11	288.42
	230-01	NORTHING	1852279.17	1852279.17	1853479.17		1,200.00		4 40 20.73	366.11	200.42
	230-01							LEFI			
		EASTING	6632824.23	6633112.66	6632824.23		7 000 00	4.59.00/70.70!!	49 5 4 / 7 5 4 0 11	040.74	407.6
EB ON MAINI		STATION	55+18.08	59+25.72		63+28.39	3,000.00		1 54 35.49	810.31	407.64
"EB ON RAMP"  ROAD 16/SR 152 EB LOOP RAMP	230-02	NORTHING	1852668.7	1852853.95	1849996.39	1852935.60		RIGHT			
		EASTING	6633876.18	6634239.29	6635239.54	6634638.67			-		
		STATION	31+70.24	32+40.24		32+80.20	70.00		81° 51 ′04.01"	109.96	70.00
	231-01	NORTHING	1852367.17	1852297.17	1852367.17	1852297.17		RIGHT			
		EASTING	6632596.67	6632596.67	6632526.67	6632526.67					
		STATION	34+31.05			40+38.88	200.00	174°07′43.56"	28° 38′52.40"	607.82	3,900.0
	231-02	NORTHING	1852297.17		1852497.17	1852696.12		RIGHT			
		EASTING	6632375.81		6632375.81	6632355.35					
		STATION	43+46.98	44+55.87		45+64.66	3,000.00	4°09′26.29"	1° 54′35.49''	217.68	108.89
	231-03	NORTHING	1852727.64	1852738.77	1849743.37	1852742.03		RIGHT			
		EASTING	6632661.85	6632770.16	6632968.73	6632879.00					
		STATION	49+57.47	53+00.61		56+43.20	7,000.00	5° 36′46.15"	0° 49′06.64''	685.74	343.14
	232-01	NORTHING	1853010.91	1853010.91	1860010.91	1853044.48	,	LEFT			
DOAD 16/SD 152 WD OFF DAMD		EASTING	6633247.64	6633590.78	6633247.64	6633932.28					
		STATION	61+34.77	63+33.48	333211131	65+32.00	5 177 00	4°23′46.86"	1° 06′24 25"	397 24	198.72
"ALIGNMENT NAME"  ROAD 16/SR 152 EB OFF RAMP "EB OFF RAMP"  ROAD 16/SR 152 EB ON RAMP "WB ON RAMP"  ROAD 16/SR 152 EB LOOP RAMP "EB LOOP RAMP"  ROAD 16/SR 152 EB LOOP RAMP "EB LOOP RAMP"  ROAD 16/SR 152 WB OFF RAMP "WB OFF RAMP"  ROAD 16 CONNECTOR "RD 16 CONNECTOR"	232-02	NORTHING	1853092.55	1853111.99	1847940.37	1853116.21	3,111.00		7 00 2 1720	001121	130111
	232 02	EASTING	6634421.48	6634619.25	6634927.82	6634817.92		1(10111			
		STATION	13+45.79	14+93.90	0034321:02		Section   Sect	148.1			
	233-01	NORTHING	1853652.19	1853652.19	1853152.19		300.00		11 27 33	201.90	140.1
	233-01	EASTING	6632960.46	6633108.57	6632960.46			KIGHI			
"WB OFF RAMP"  ROAD 16 CONNECTOR			+		0032900.40		500.00	700 50/50!!	44907/77	007.00	1.40.4
	077.04	STATION	17+26.67	18+74.78	1057010 00		500.00		11 27 33	287.98	148.1
	233-01	NORTHING	1853520.92	1853440.26	1853940.26	1853440.26		LEFT			
		EASTING	6633310.69	6633434.91	6633583.01	6633583.01	706	4 7 50 4 5 4 4 4 1 1	00.4.4.5 - 11		
		STATION	38+19.65	55+23.03		54+72.90	700.00		8°11′06''	1,653.24	1,703.3
	240-01	NORTHING	1852923.08	1851219.73	1852919.17	1852424.20		LEFT			
		EASTING	6640581.25	6640571.74	6641281.24	6641776.21					
"RD 17 1/2"		STATION	60+75.88	63+63.26		66+21.28	700.00	44° 38′30''	8°11′06''	545.40	287.39
	240-02	NORTHING	1852850.57	1853053.78	1852355.59	1853055.58		RIGHT			
		EASTING	6642202.58	6642405.80	6642697.56	6642693.18					

'n								
-90							DESIGNED BY A. GURA	
							DRAWN BY M. TACTAY	1
							CHECKED BY	l
_							J. RAY IN CHARGE	l
218							C. LEMLEY	
DOOG!	REV	DATE	BY	СНК	APP	DESCRIPTION	09/09/2016	





### CALIFORNIA HIGH-SPEED TRAIN PROJECT MERCED TO FRESNO SECTION

CENTRAL VALLEY WYE
SR 152 (NORTH) TO ROAD 13 WYE ALTERNATIVE
GEOMETRY DATA TABLE
SHEET 5 OF 6

CONTRACT NO.								
HSR05-05								
DRAWING NO.								
CV-B0064-A								
SCALE								
NO SCALE								
SHEET NO.								

						DESIGNED BY A. GURA
						DRAWN BY M. TACTAY
						CHECKED BY J. RAY
						IN CHARGE C. LEMLEY
REV	DATE	BY	СНК	APP	DESCRIPTION	DATE 09/09/2016

RECORD SET 15% DESIGN SUBMITTAL NOT FOR

CONSTRUCTION





# CALIFORNIA HIGH-SPEED TRAIN PROJECT MERCED TO FRESNO SECTION

	CENTRAL VALLEY WYE
SR 152	(NORTH) TO ROAD 13 WYE ALTERNATIVE
	GEOMETRY DATA TABLE
	SHEET 6 OF 6

CONTRACT NO.
HSR05-05
DRAWING NO. CV-B0065-A
SCALE NO SCALE
CUEET NO

ROAD "ALIGNMENT NAME"	CURVE NO.		ВС	PI	CC	EC	RADIUS (FT)	DELTA	DEGREE OF CURVATURE (ARC)	LENGTH (FT)	TANGEN' (FT)
		STATION	12+50.00	13+72.86		14+95.59	3,000.00	4° 41 ′26"	1° 54′35"	245.59	122.86
	250-01	NORTHING	1854217.48	1854130.08	1856325.85	1854050.03		LEFT			
		EASTING	6646152.11	6646238.46	6648286.31	6646331.67					
		STATION	16+98.79	19+44.19		21+88.49	3,000.00	9° 21′10"	1° 54′35"	489.71	245.40
FAIRMEAD BLVD REALIGNMENT "FAIR BLVD" LINE	250-02	NORTHING	1853917.63	1853757.74	1851641.81	1853569.73		RIGHT			
		EASTING	6646485.81	6646671.97	6644531.17	6646829.67					
		STATION	23+95.89	25+18.01		26+40.00	3,000.00	4° 39′44''	1° 54′35"	244.11	122.12
	250-03	NORTHING	1853410.83	1853317.26	1855338.75	1853230.38		LEFT			
		EASTING	6646962.95	6647041.43	6649261.46	6647127.26					
		STATION	27+78.31	35+81.73		43+06.23	2,000.00	43° 46′18''	2° 51 ′53"	1,527.92	803.42
	310-01	NORTHING	1839905.08	1839902.68	1841905.07	1840456.73		LEFT			
AVENUE 20 1/2		EASTING	6675844.57	6676647.98	6675850.55	6677229.80					
"AVE 20 1/2"		STATION	49+74.10	53+43.44		57+04.54	2,000.00	20° 55′32''	2° 51 ′53"	730.44	369.33
	310-02	NORTHING	1840917.31	1841172.01	1839468.97	1841314.39		RIGHT			
		EASTING	6677713.45	6677980.91	6679092.70	6678321.70					
		STATION	13+01.85	24+70.25		31+54.79	1,200.00	88° 28′17''	4° 46′29''	1,852.94	1,168.4
	311-01	NORTHING	1842114.13	1840945.76	1842122.67	1840922.90		LEFT			
ROAD 24 REALIGNMENT		EASTING	6675261.67	6675269.98	6676461.64	6676438.16					
"RD 24"		STATION	35+52.49	37+81.87		39+87.13	550.00	45° 16′44''	10° 25′03''	434.65	229.39
	311-02	NORTHING	1840915.12	1840910.63	1840365.22	1840744.52		RIGHT			
		EASTING	6676835.79	6677065.13	6676825.03	6677223.32					
		STATION	11+69.34	14+64.90		17+28.66	700.00	45° 46′52''	8° 11′06"	559.32	295.56
	320-01	NORTHING	1837282.83	1837284.39	1836582.84	1837073.66		RIGHT			
AVENUE 20		EASTING	6678557.18	6678852.73	6678560.87	6679059.97					
"AVE 20"		STATION	36+78.85	39+59.61		42+12.86	700.00	43° 42′35''	8° 11 ′06"	534.01	280.76
	320-02	NORTHING	1835683.20	1835483.02	1835192.38	1835202.30		RIGHT			
		EASTING	6680427.38	6680624.24	6679928.29	6680628.22					
		STATION	112+46.35	115+35.02		118+16.72	1,500.00	21° 47′11''	3° 49′11''	570.36	288.67
	470-01	NORTHING	1873944.61	1874233.28	1873937.52	1874500.82		LEFT			
		EASTING	6616773.38	6616772.01	6615273.40	6616663.61					
		STATION	122+74.47	127+94.78		132+56.36	1,200.00	46° 52′55''	4° 46′29''	981.89	520.31
/ISTA AVENUE/ROAD 13 REALIGNMENT "VISTA AV" LINE	470-02	NORTHING	1874925.07	1875407.29	1875375.71	1875879.52		RIGHT			
VISIA AV LINE		EASTING	6616491.71	6616296.32	6617603.88	6616514.76					
		STATION	135+77.46	138+44.54		141+03.06	1,200.00	25° 05′44''	4° 46′29''	525.60	267.08
	470-03	NORTHING	1876170.95	1876413.35	1876674.76	1876680.43		LEFT			
		EASTING	6616649.57	6616761.70	6615560.45	6616760.44					
		STATION	79+26.46	83+28.04		87+24.88	3,000.00	15°14′56''	1° 54′35"	798.43	401.59
ROAD 13 REALIGNMENT "RD 13"	640-01	NORTHING	1862557.57	1862945.47	1863334.02	1863347.05		LEFT			
10 13		EASTING	6616721.01	6616824.95	6613823.23	6616823.21					

12-							DESIGNED BY D.SCHWANIK
							DRAWN BY M. TACTAY
9							CHECKED BY A. GURA
4222							IN CHARGE C. LEMLEY
00d	REV	DATE	BY	снк	APP	DESCRIPTION	DATE 02/13/2015

Utility Type

Electrical Utility >60KV

Natural Gas Line

Petroleum Products

Water Infrastructure

Conflict ID #

JVC-2

JVC-3

WYH-1

WYH-2

WYH-15

WYH-7 WYH-16

G30

G52

G51

WYH-8

WYH-8

G4

JVC-8

Ρ2

JVC-65

JVC-66

JVC-137

JVC-38

JVC-39

JVC-40

JVC-85

Utility

Electric Overhead

Natural Gas

Natural Gas

Natural Gas

Natural Gas

Natural Gas

Natural Gas

Challenger Pipeline

Petroleum

Irrigation Ditch #40

West San Juan Drain No. 1

Irrigation Ditch #41

Irrigation Ditch #42

San Juan Canal

San Juan Drain

Irrigation Ditch #43

RECORD SET 15% DESIGN SUBMITTAL NOT FOR CONSTRUCTION





Potential

Project

Impact

High Risk

Sheet #

CV-S1080-A to CV-S1090-A

CV-S1110-A

CV-S1180-A

CV-S1620-A

CV-S1200-A

CV-S1640-A to CV-1650-A

CV-S1460-A

CV-S1660-A

CV-S1280-A to CV-S1290-A

CV-S1500-A

CALIFORNIA HIGH-SPEED TRAIN PROJECT	CONTRACT NO. HSRO8-05
MERCED TO FRESNO SECTION  CENTRAL VALLEY WYE	DRAWING NO. CV-B0070-A
SR 152 (NORTH) TO ROAD 13 WYE ALTERNATIVE UTILITY CONFLICT TABLE	NO SCALE
SHEET 1 OF 4	SHEET NO.

#### 15476+75 to 15655+00 CV-S1500-A to CV-S1530-A 12", west side of UPRR 8" line on west side of Fairmead Blvd 6718+10 CV-S1250-A 12" line on west side of Fairmead Blvd 6718+25 CV-S1250-A 4" feeder main on west side of Road 22 6905+20 High Risk CV-S1280-A to CV-S1291-A 4" feeder main on north side of Avenue 22 6938+90 CV-S1290-A 4" feeder line at unknown location on west side of Road 4 (Lincoln Rd) Approximately 5946+35 CV-S1110-A 8-inch, high pressure natural gas gathering steel line on east side of Harmon Road. 5724+30 CV-S1070-A 12.75" OD 0.219" WT X-60 high pressure, east side of UPRR ROW 6717+85 High Risk CV-S1250-A Unknown flow, irrigation infrastructure 5348+00 CV-S1010-A Max flow - 20 cfs, irrigation infrastructure 5361+10 CV-S1010-A 5378+70 CV-S1010-A Unknown flow, irrigation infrastructure 5391+70 Low Risk CV-S1010-A Max flow - 80 cfs, irrigation infrastructure 5399+50 CV-S1020-A Unknown flow, irrigation infrastructure 5419+00 CV-S1020-A Max flow - 80 cfs, irrigation infrastructure 5427+90 CV-S1020-A

Approximate Location of Conflict

5786+10

5945+70

6315+85

36315+85

6420+35

36452+10 to 36503+80

15233+50 to 15239+50

36528+75 to 36535+10

6883+50 to 6930+85

15467+80

#### NOTES:

Description

115 KV, crossing at Eastside Bypass

70 KV, west side of Road 4 / Lincoln Road

115 KV, east side of Road 11

115 KV, west side of Road 13

115 KV, south side of Avenue 26

230 KV

115 KV, north side of Sandy Mush Road

- 1. ALL CONFLICTS ARE TRANSVERSE UNLESS OTHERWISE NOTED. ALL PIPE SIZES ARE SHOWN IN INCHES IN DIAMETER.
- 2. REFER TO THE 15% UTILITY REPORT FOR ADDITIONAL UTILITY INFORMATION.
- 3. REFER TO THE 15% HYDROLOGY AND HYDRAULICS REPORT FOR ADDITIONAL WATER CROSSING INFORMATION.

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Utility Type	Conflict ID #	U+ili+y	Description	Approximate Location of Conflict	Potential Project Impact	Sheet #
	JVC-41	Temple Santa Rita Canal		5436+95		CV-S1020-A
	JVC-42	West Santa Rita Drain		5446+30		CV-S1020-A
	JVC-67	Drain No. 2		5494+60		CV-S1030-A
	JVC-68	Escano Branch Ditch		5496+90		CV-S1030-A
	JVC-85	Drain No. 3		5509+15		CV-S1040-A
	JVC-45	Orchard Ditch		5521+70		CV-S1040-A
	JVC-70	Santa Rita Slough		5522+75		CV-S1040-A
	JVC-71	Santa Rita Drain No. 1		5527+90		CV-S1040-A
	JVC-72	Drain No. 4	Unknown flow, irrigation infrastructure	5535+55		CV-S1040-A
	JVC-73	Santa Rita Drain No. 1A		5544+75		CV-S1040-A
	JVC-86	Drain No. 5		5564+20		CV-S1050-A
Weller Te Come have have	JVC-88	Santa Rita Ditch		5564+75		CV-S1050-A
Water Infrastructure	JVC-87	Island Field		5573+20	Low Risk	CV-S1050-A
	JVC-12	Lucerne Ditch		5594+40		CV-S1050-A
	JVC-148	Historical Wood Slough		5596+00 +o 5596+75		CV-S1050-A
	JVC-13	Wood Slough		5623+55		CV-S1060-A
	JVC-147	Irrigation Ditch #57		5646+00		CV-S1060-A
	JVC-74	Riverside Canal	Max flow - 40 cfs, irrigation infrastructure	5666+55		CV-S1060-A
	JVC-98	San Joaquin River		5567+20 +o 5570+40		CV-S1060-A
	JVC-101	Mariposa Slough	N/A	5685+85		CV-S1070-A
	JVC-15	Eastside Bypass		5772+10 to 5783+85		CV-S1080-A
	JVC-46	Chowchilla Canal	Unknown flow, concrete lined irrigation infrastructure	5976+00		CV-S1120-A
				6276+40 +0 6282+40		CV-S1170-A
	JVC-77	Ash Slough	N/A	36276+50 to 36282+75		CV-S1610-A

#### NOTES:

- 1. ALL CONFLICTS ARE TRANSVERSE UNLESS OTHERWISE NOTED. ALL PIPE SIZES ARE SHOWN IN INCHES IN DIAMETER.
- 2. REFER TO THE 15% UTILITY REPORT FOR ADDITIONAL UTILITY INFORMATION.
- 3. REFER TO THE 15% HYDROLOGY AND HYDRAULICS REPORT FOR ADDITIONAL WATER CROSSING INFORMATION.

12-							DESIGNED BY D.SCHWANIK	,
							DRAWN BY M. TACTAY	1
							CHECKED BY	
56							A. GURA	ł
422							C. LEMLEY	Co
D00	REV	DATE	BY	снк	APP	DESCRIPTION	DATE 02/13/2015	

RECORD SET 15% DESIGN SUBMITTAL NOT FOR CONSTRUCTION





#### CALIFORNIA HIGH-SPEED TRAIN PROJECT MERCED TO FRESNO SECTION

CENTRAL VALLEY WYE SR 152 (NORTH) TO ROAD 13 WYE ALTERNATIVE UTILITY CONFLICT TABLE SHEET 2 OF 4

CONTRACT NO. HSR08-05
DRAWING NO. CV-B0071-A
NO SCALE
SHEET NO.

-M/						
12						
56						
p0042226						
D00	REV	DATE	BY	снк	APP	DESCRIPTION
,						

Utility Type

Water Infrastructure

Conflict ID #

JVC-80

JVC-82

JVC-133

JVC-120

JVC-111

JVC-113

WYH-17

JVC-130

JVC-129

JVC-143

JVC-134

JVC-131

JVC-133

JVC-115

JVC-106

JVC-77

JVC-106

Utility

Road 11 Canal

Bethel Canal

Berenda Canal

Berenda Pipeline

Berenda Slough

Califa Canal

Lat 32.2

Berenda Creek

24.2-8.9-1.0

24.2-8.9

Dry Creek

24.2

Berenda Canal

Malti P.L.

Ash Main Canal

Ash Slough

Ash Main Canal

D.SCHWANIK

M. TACTAY

IN CHARGE
C. LEMLEY

10/30/2015

CHECKED BY
A. GURA

RECORD SET 15% DESIGN SUBMITTAL NOT FOR CONSTRUCTION





### NOTES:

Description

Max flow - 24 cfs, irrigation infrastructure

Max flow - 40 cfs, irrigation infrastructure

Max flow - 875 cfs, irrigation infrastructure

42" M.C.P., Unknown flow, buried irrigation infrastructure, east side of Road 15

N/A

Unknown flow, irrigation infrastructure

Max flow - 600 cfs, irrigation infrastructure

N/A

Max flow - 320 cfs, irrigation infrastructure

Unknown flow, irrigation infrastructure

N/A

Max flow - 990 cfs, irrigation infrastructure

Max flow - 875 cfs, irrigation infrastructure

M.C.P.; Unknown flow, buried irrigation infrastructure

Unknown flow, irrigation infrastructure

N/A

Unknown flow, irrigation infrastructure

- 1. ALL CONFLICTS ARE TRANSVERSE UNLESS OTHERWISE NOTED. ALL PIPE SIZES ARE SHOWN IN INCHES IN DIAMETER.
- 2. REFER TO THE 15% UTILITY REPORT FOR ADDITIONAL UTILITY INFORMATION.
- 3. REFER TO THE 15% HYDROLOGY AND HYDRAULICS REPORT FOR ADDITIONAL WATER CROSSING INFORMATION.

### CALIFORNIA HIGH-SPEED TRAIN PROJECT CONTRACT NO. HSR08-05 MERCED TO FRESNO SECTION

Potential Project Impact

Low Risk

Sheet #

CV-S1180-A

CV-S1620-A

CV-S1200-A

CV-S1210-A

CV-S1220-A

CV-S1420-A

CV-S1220-A

CV-S1420-A

CV-S1250-A

CV-S1280-A

CV-S1300-A

CV-S1320-A

CV-S1320-A

CV-S1320-A to CV-S1330-A

CV-S1330-A

CV-S1430-A

CV-S1430-A

CV-S1450-A

CV-S1650-A

CV-S1450-A

CV-S1650-A

CV-S1450-A

CV-S1650-A

Approximate Location of Conflict

6316+30

36316+15

6406+55

6478+40

6526+85

15022+80

6544+00 to 6547+65

15002+35 to 15005+90

6737+80

6876+70

7011+10 to 7011+55

7098+35

7117+00

7129+75 to 7130+60

7168+00

15066+50

15094+55

15213+70

36509+05

15214+25 to 15217+80

36509+60 to 36513+05

15217+20

36512+90

CENTRAL VALLEY WYE SR 152 (NORTH) TO ROAD 13 WYE ALTERNATIVE UTILITY CONFLICT TABLE SHEET 3 OF 4

H2K06-05				
DRAWING NO.				
CV-B0072-A				
SCALE				
NO SCALE				
SHEET NO.				

PARSONS

-M-		
-71		
977		
422		
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U+ili+y Type	Conflict ID #	U+iIi+y	Description	Approximate Location of Conflict	Potential Project Impact	Sheet #	
	JVC-107	Chowchilla River	N/A	15288+00 +o 15290+15		CV-S1470-A	
	JVC-108	Lat 4	Max flow - 600 cfs, irrigation infrastructure	15307+00		CV-S1470-A	
	JVC-145	Lat 3	Max flow - 600 cfs, irrigation infrastructure	15347+25		CV-S1480-A	
Water Infrastructure	JVC-109	Lat 2	Max flow - 600 cfs, irrigation infrastructure, south side of Cross Road	15374+25	Low Risk	CV-S1480-A	
water intrastructure	JVC-110	Dutchman Creek	N/A	15436+10		CV-S1490-A	
	JVC-105	Deadman's Creek	N/A	15575+70		CV-S1520-A	
	JVC-82	Bethel Canal	Max flow - 40 cfs, irrigation infrastructure	36457+00 +o 36470+00		CV-S1640-A +o CV-1650-A	
	JVC-149	Un-named Delivery Irrigation Canal	Unknown flow, irrigation infrastructure	36455+30		CV-S1640-A	
Storm Water Infrastructure		None Found					
Wastewater Infrastructure		None Found					
	Т97	Fiber Optic	Underground Trenched Ducts with Fiber Optic, east side of Fairmead Blvd.	6718+65		CV-S1250-A	
	T00		During and a state of August Of	15186+80		CV-S1450-A	
	199	T99 Fiber Optic	Buried cable, south side of Avenue 25	36482+15		CV-S1650-A	
Communication Facilities	F9	Fiber Optic	Underground 2-2"HDPE, west side of UPRR	6717+45	Low Risk	CV-S1250-A	
	F11	Fiber Optic	Underground telephone, west side of UPRR 6717+7  Buried cable. Runs North-South on the West side of Elgin Road right-of-way. 12 Pair. 5468+2			CV-S1250-A	
	JVC-56	Copper Cable				CV-S1030-A to CV-S1032-A	
	JVC-57	Copper Cable	Buried cable, Runs North-South on the East side of Indiana Road right-of-way. 6 Pair.	5565+00		CV-S1050-A	

#### NOTES:

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- 3. REFER TO THE 15% HYDROLOGY AND HYDRAULICS REPORT FOR ADDITIONAL WATER CROSSING INFORMATION.

12-							DESIGNED BY D.SCHWANIK	R
							DRAWN BY M. TACTAY	]
							CHECKED BY	
56							A. GURA	
422							C. LEMLEY	co
D00	REV	DATE	BY	снк	APP	DESCRIPTION	10/30/2015	

RECORD SET 15% DESIGN SUBMITTAL NOT FOR ONSTRUCTION






#### CALIFORNIA HIGH-SPEED TRAIN PROJECT MERCED TO FRESNO SECTION

CENTRAL VALLEY WYE SR 152 (NORTH) TO ROAD 13 WYE ALTERNATIVE UTILITY CONFLICT TABLE SHEET 4 OF 4

CONTRACT NO. HSRO8-05
DRAWING NO. CV-B0073-A
SCALE NO SCALE
SHEET NO.

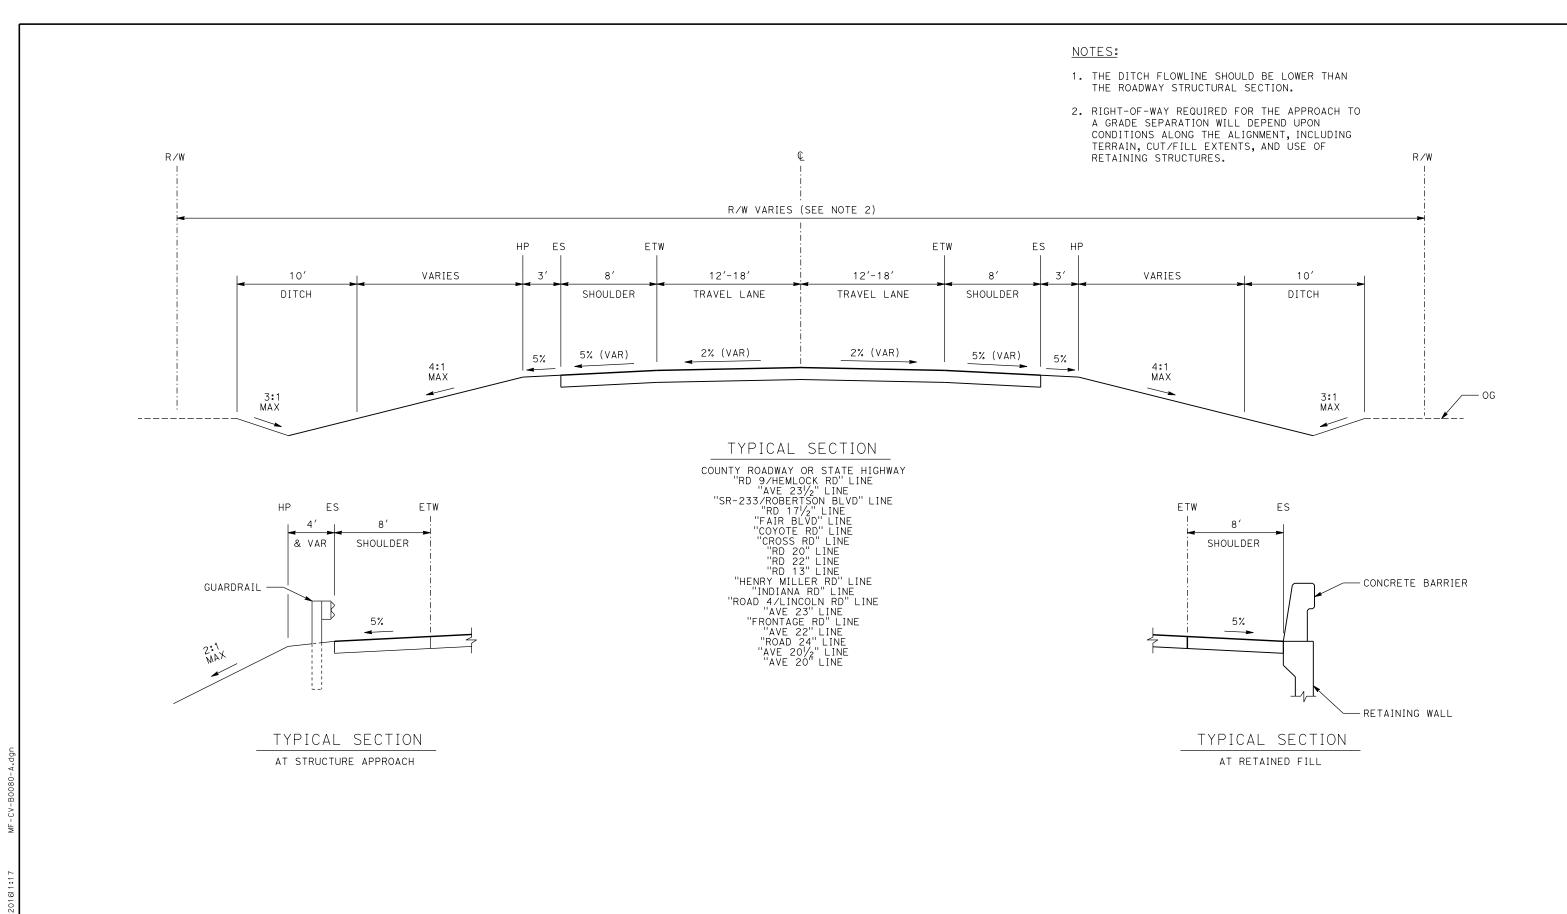

MAF								
-60							DESIGNED BY A. GURA	
							DRAWN BY M. TACTAY	
							CHECKED BY J. RAY	
33A							IN CHARGE	
051							C. LEMLEY	C
0d	REV	DATE	BY	CHK	APP	DESCRIPTION	03/18/2016	

RECORD SET
15% DESIGN
SUBMITTAL
NOT FOR
CONSTRUCTION








# CALIFORNIA HIGH-SPEED TRAIN PROJECT MERCED TO FRESNO SECTION


CENTRAL VALLEY WYE
SR 152 (NORTH) TO ROAD 13 WYE ALTERNATIVE
TYPICAL SECTION
SHEET 1 OF 3


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NO SCALE
SHEET NO.

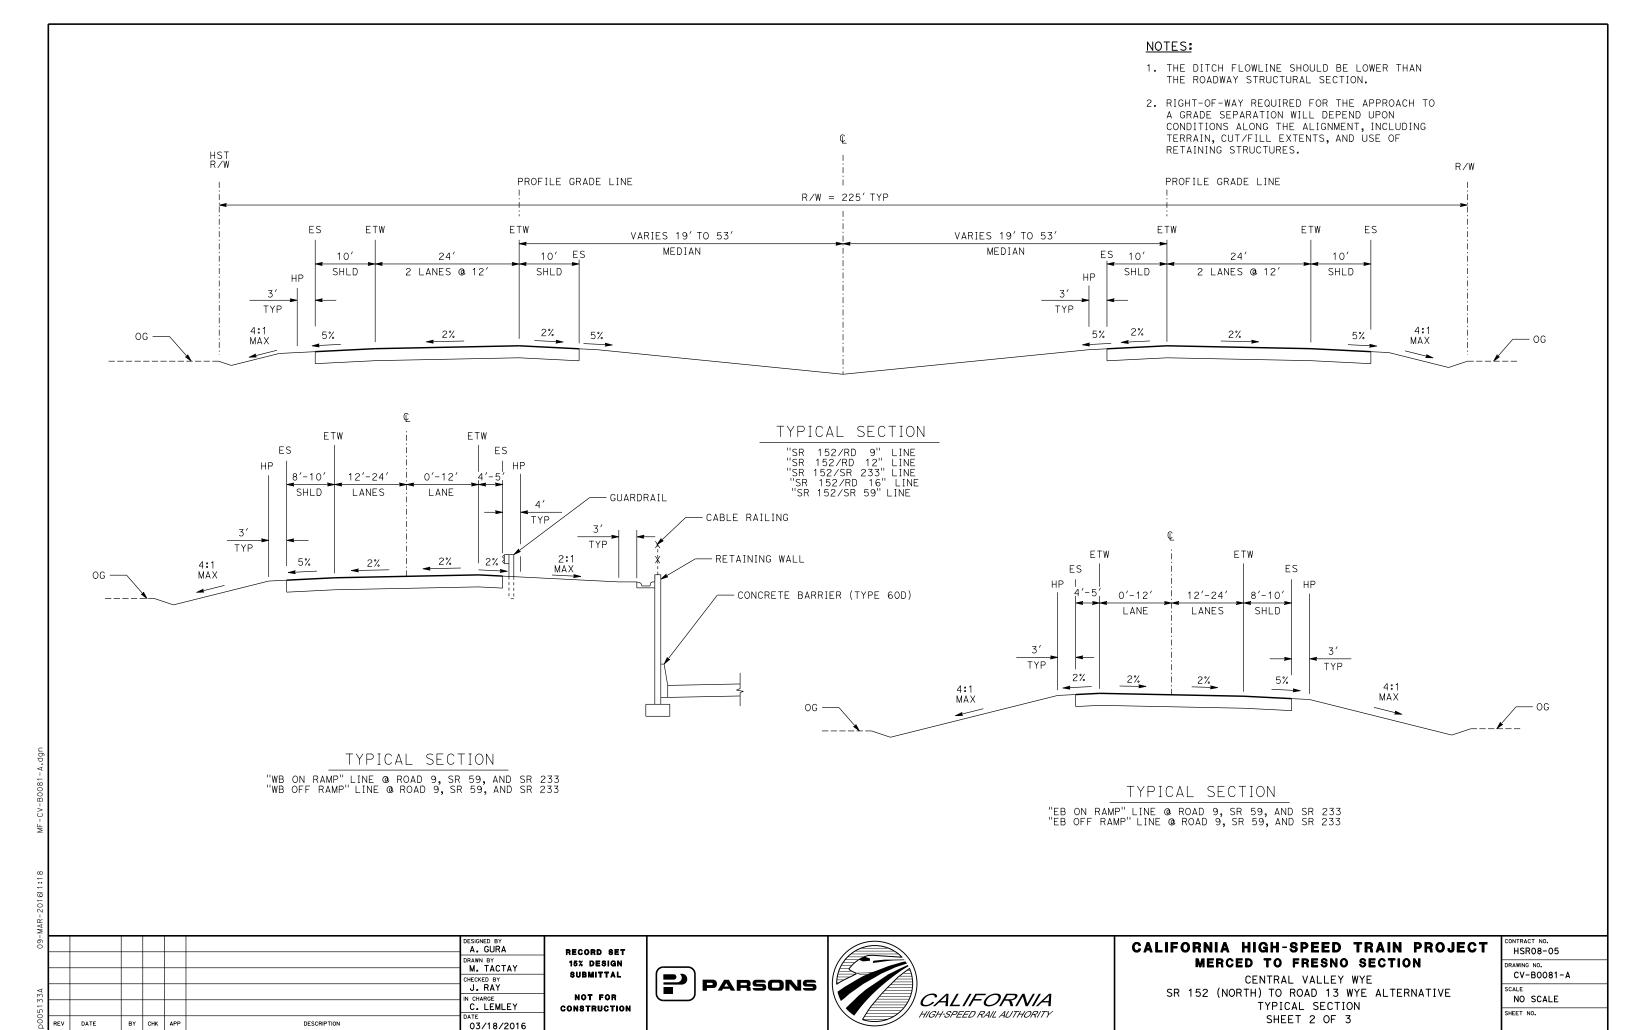


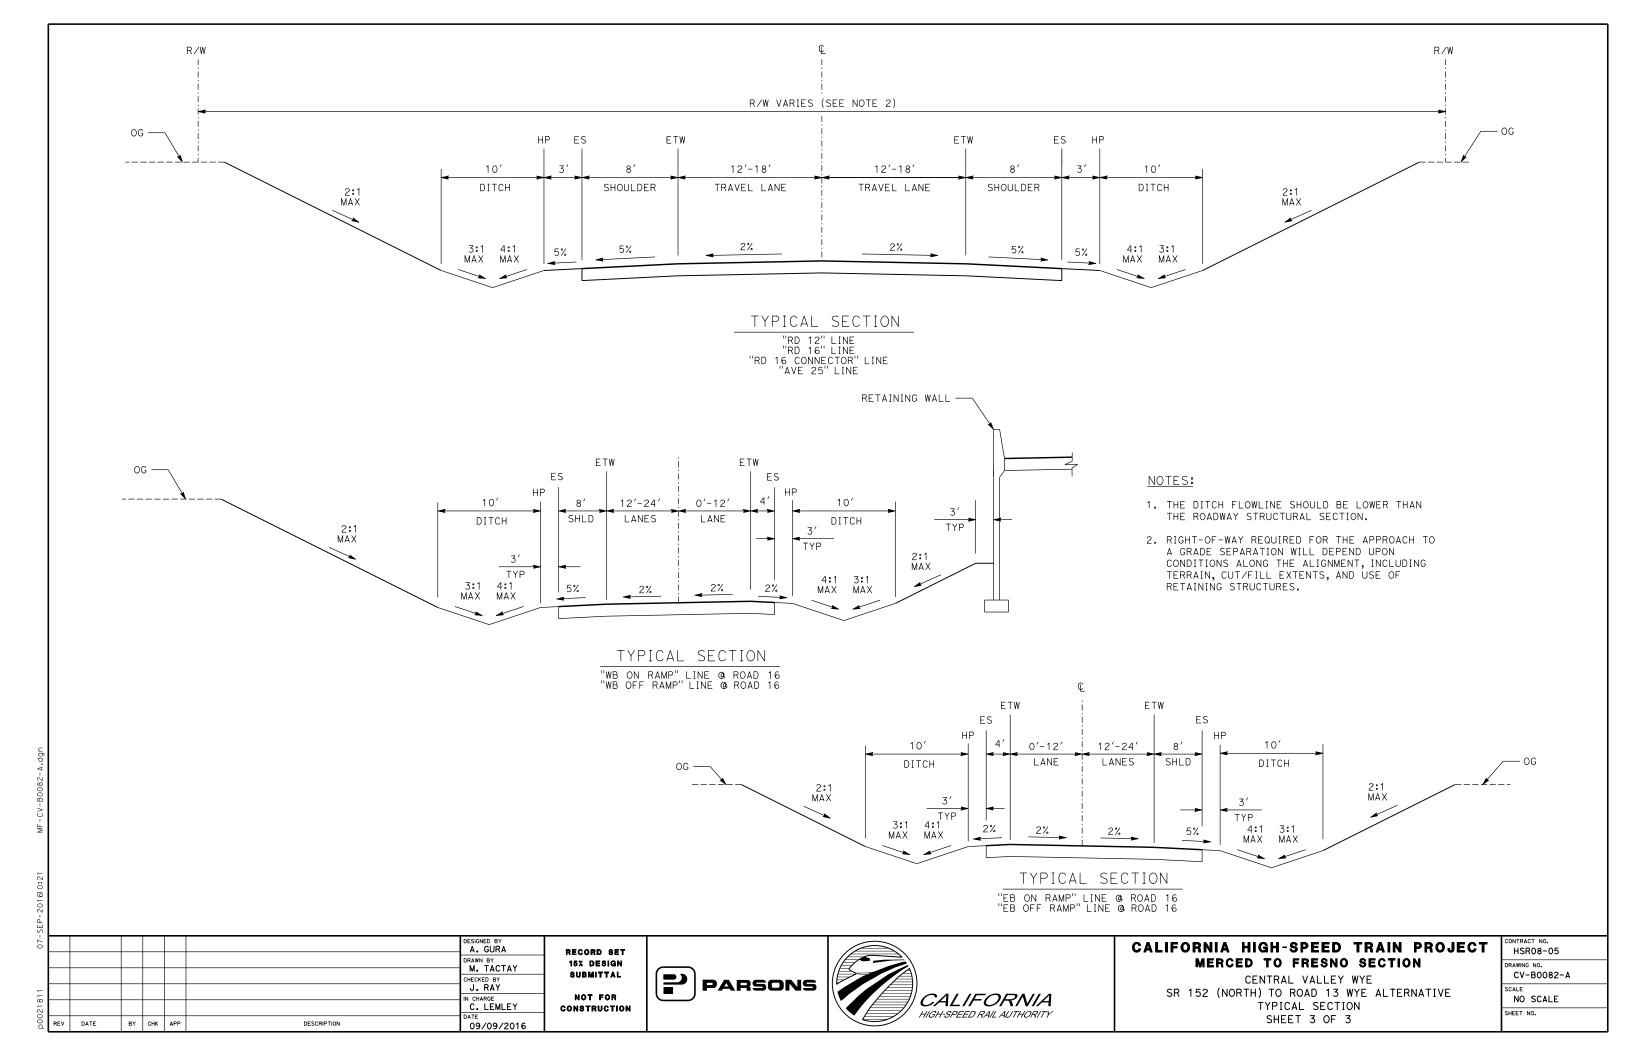

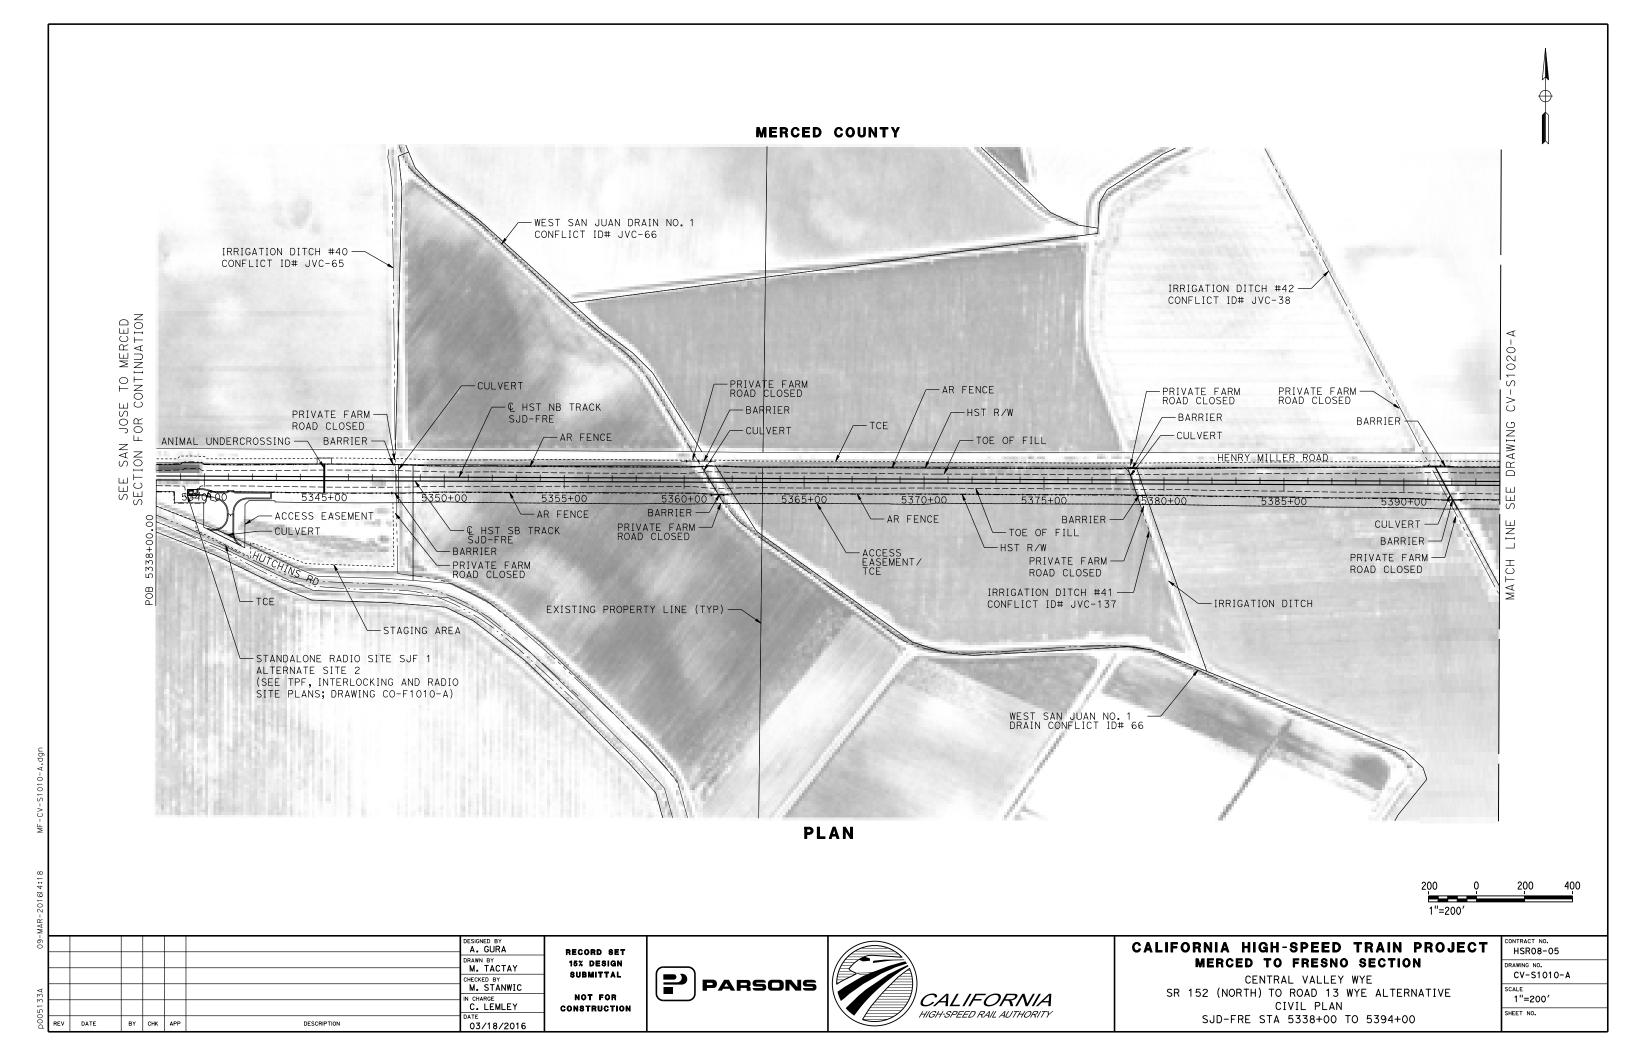

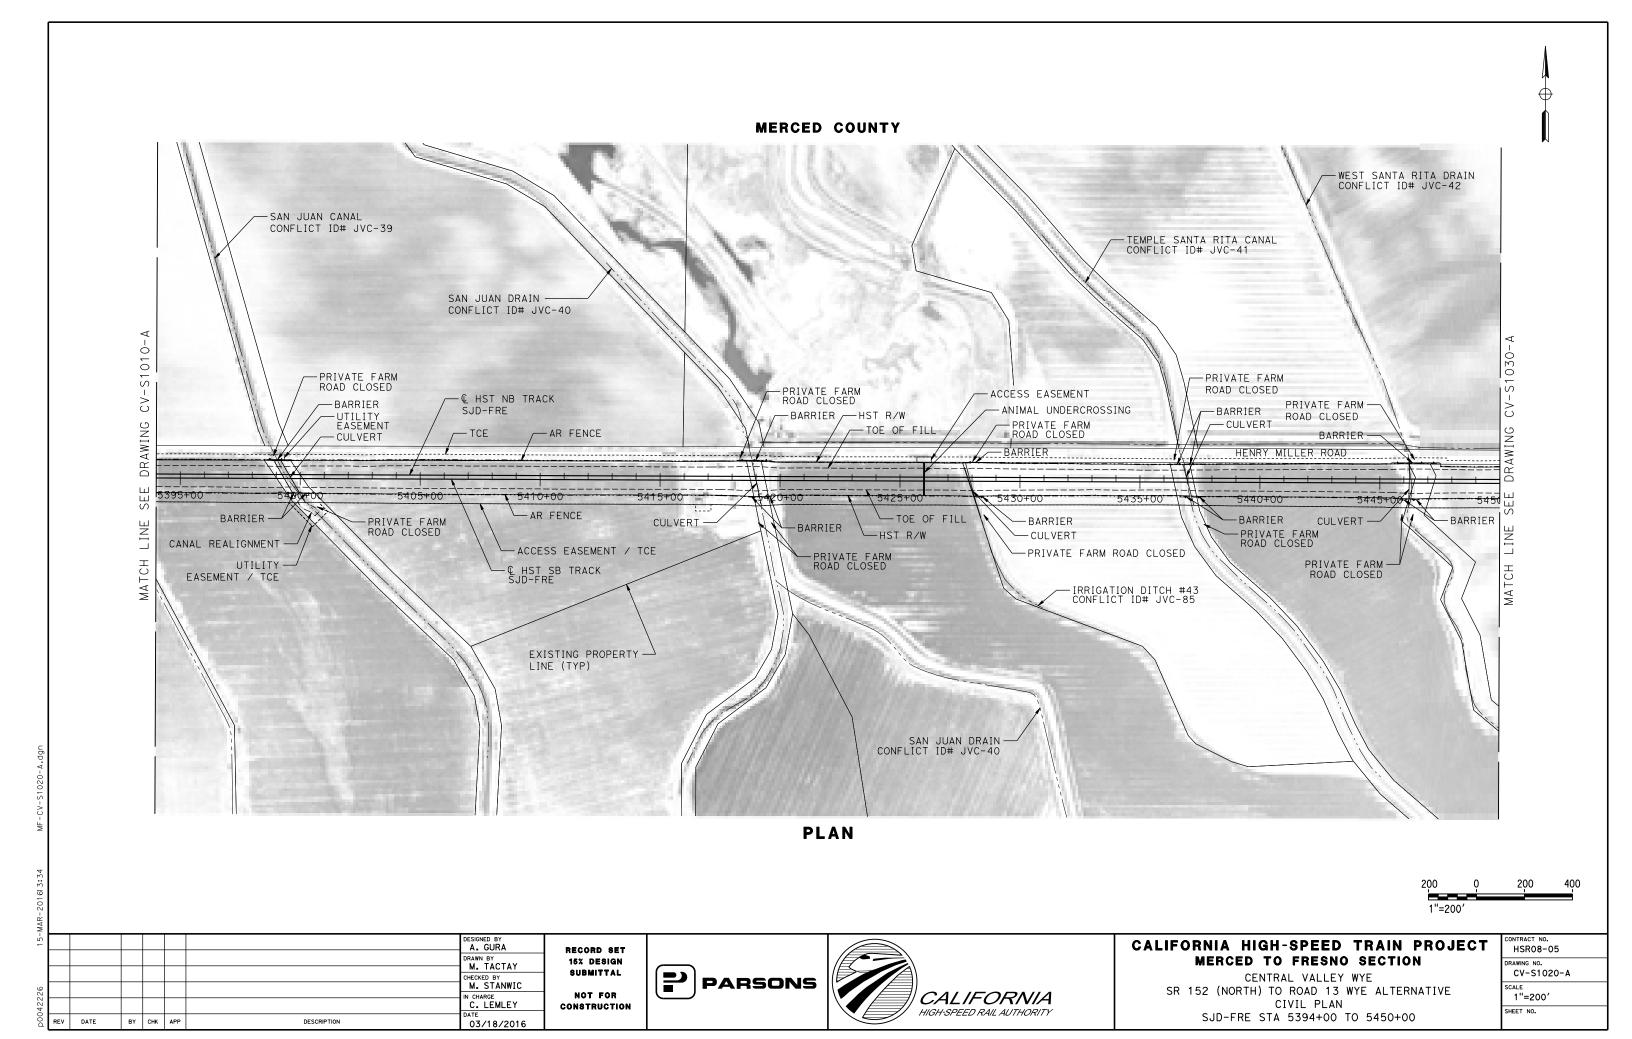

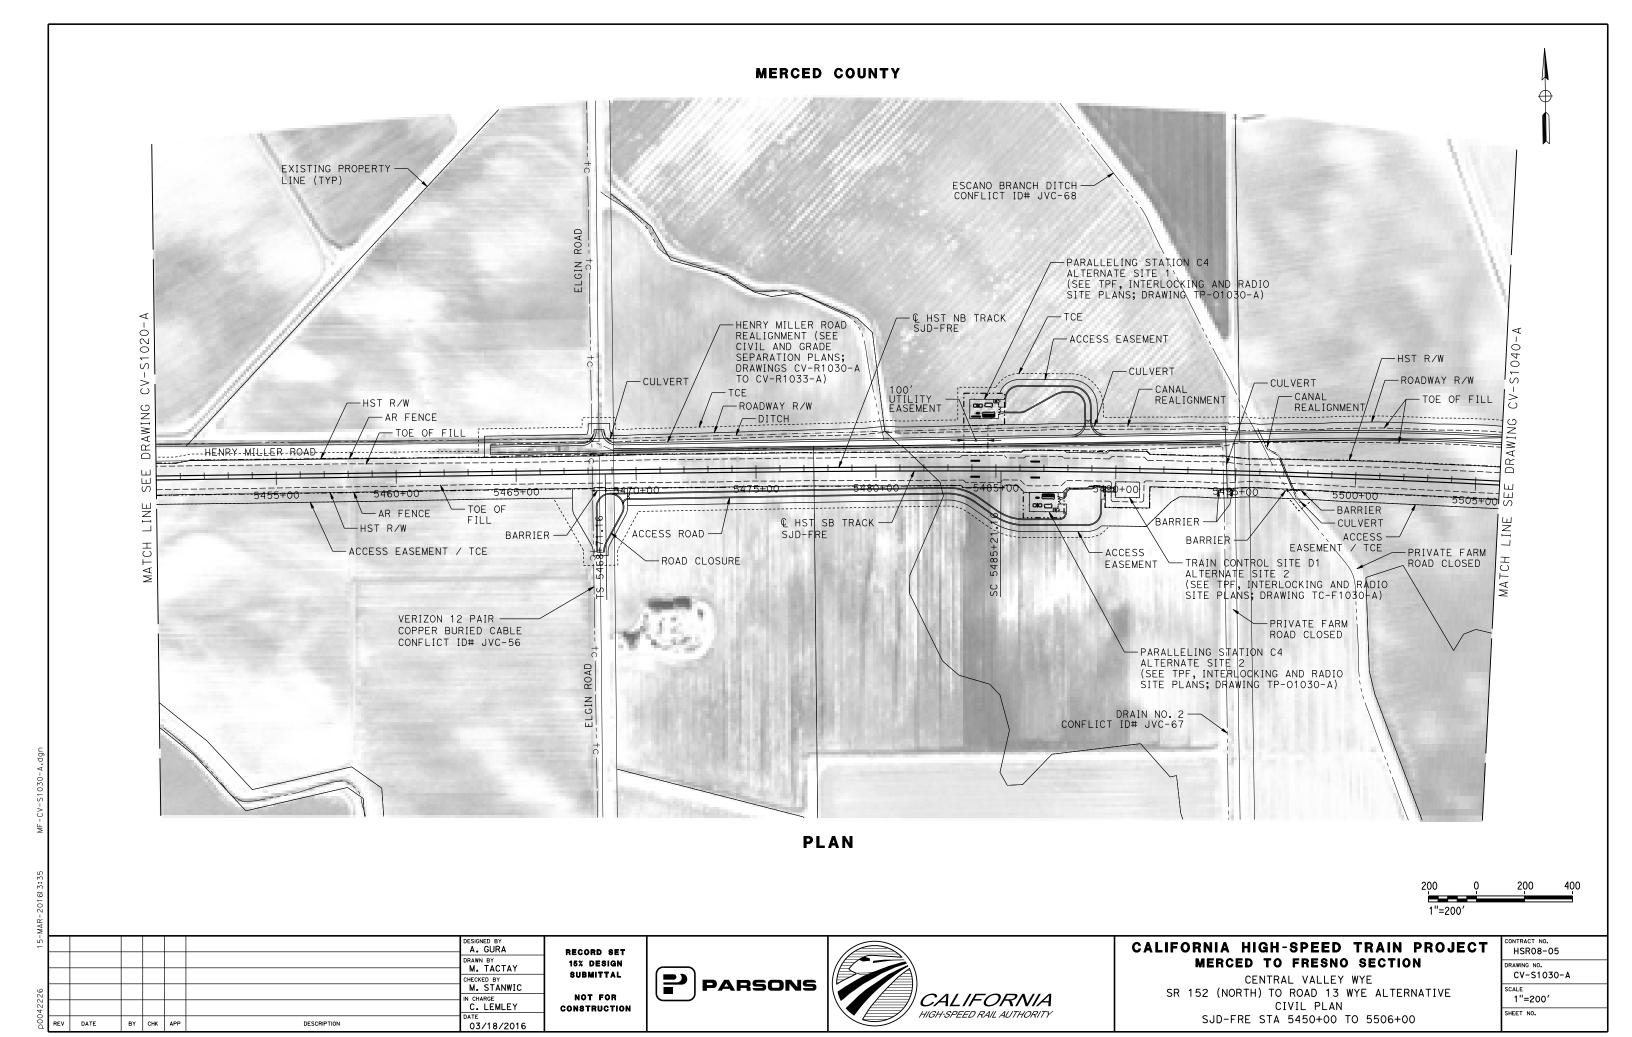

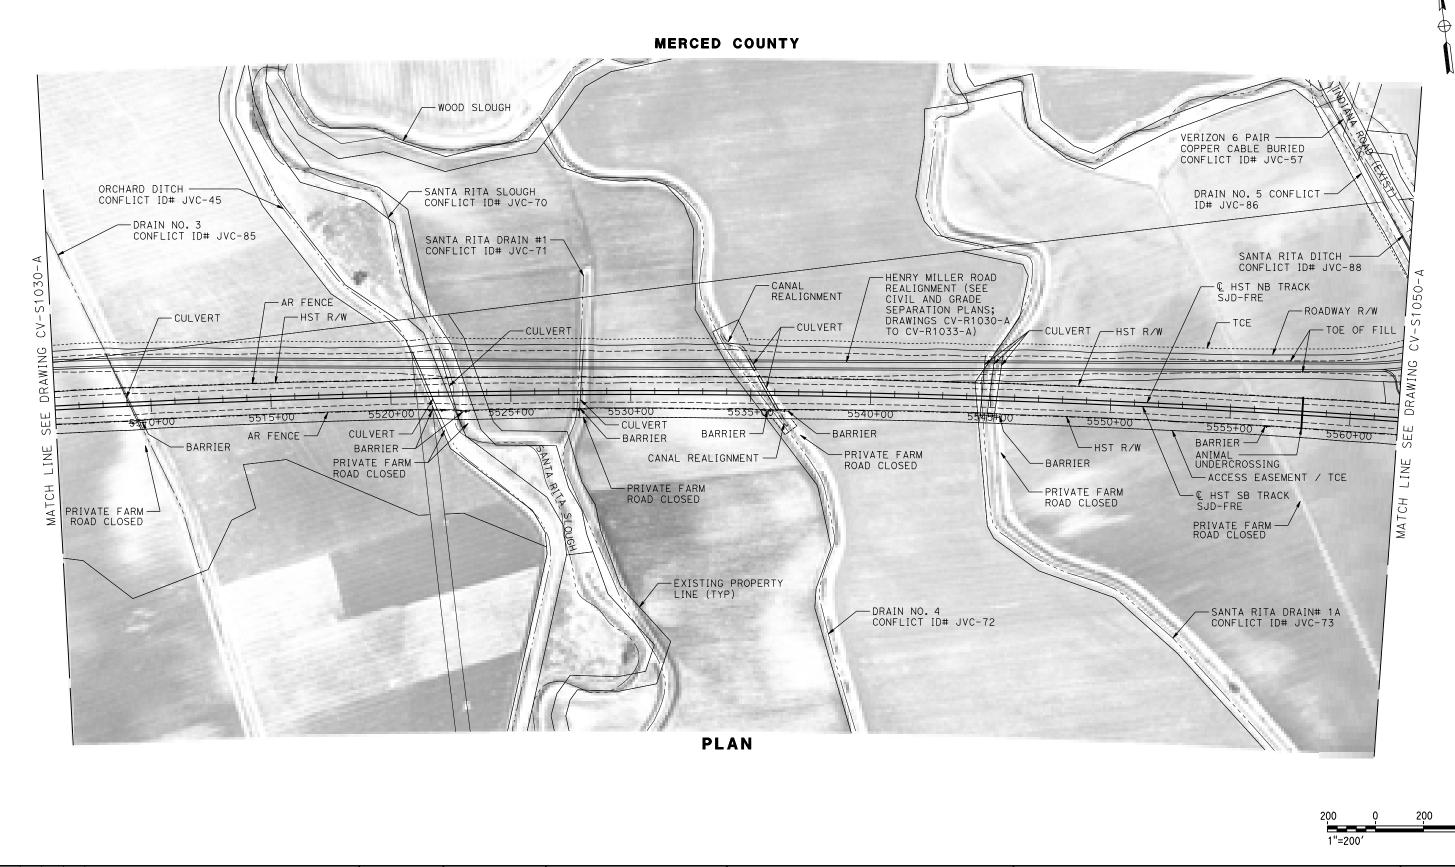

CALIFORNIA HIGH-SPEED TRAIN PROJECT MERCED TO FRESNO SECTION CENTRAL VALLEY WYE

CIVIL PLAN

SJD-FRE STA 5506+00 TO 5562+00

HSR08-05 RAWING NO. CV-S1040-A SR 152 (NORTH) TO ROAD 13 WYE ALTERNATIVE 1"=200' SHEET NO.


400

A. GURA DRAWN BY
M. TACTAY M. STANWIC IN CHARGE
C. LEMLEY DATE BY CHK APP DESCRIPTION 03/18/2016

RECORD SET 15% DESIGN SUBMITTAL NOT FOR CONSTRUCTION

**PARSONS** 



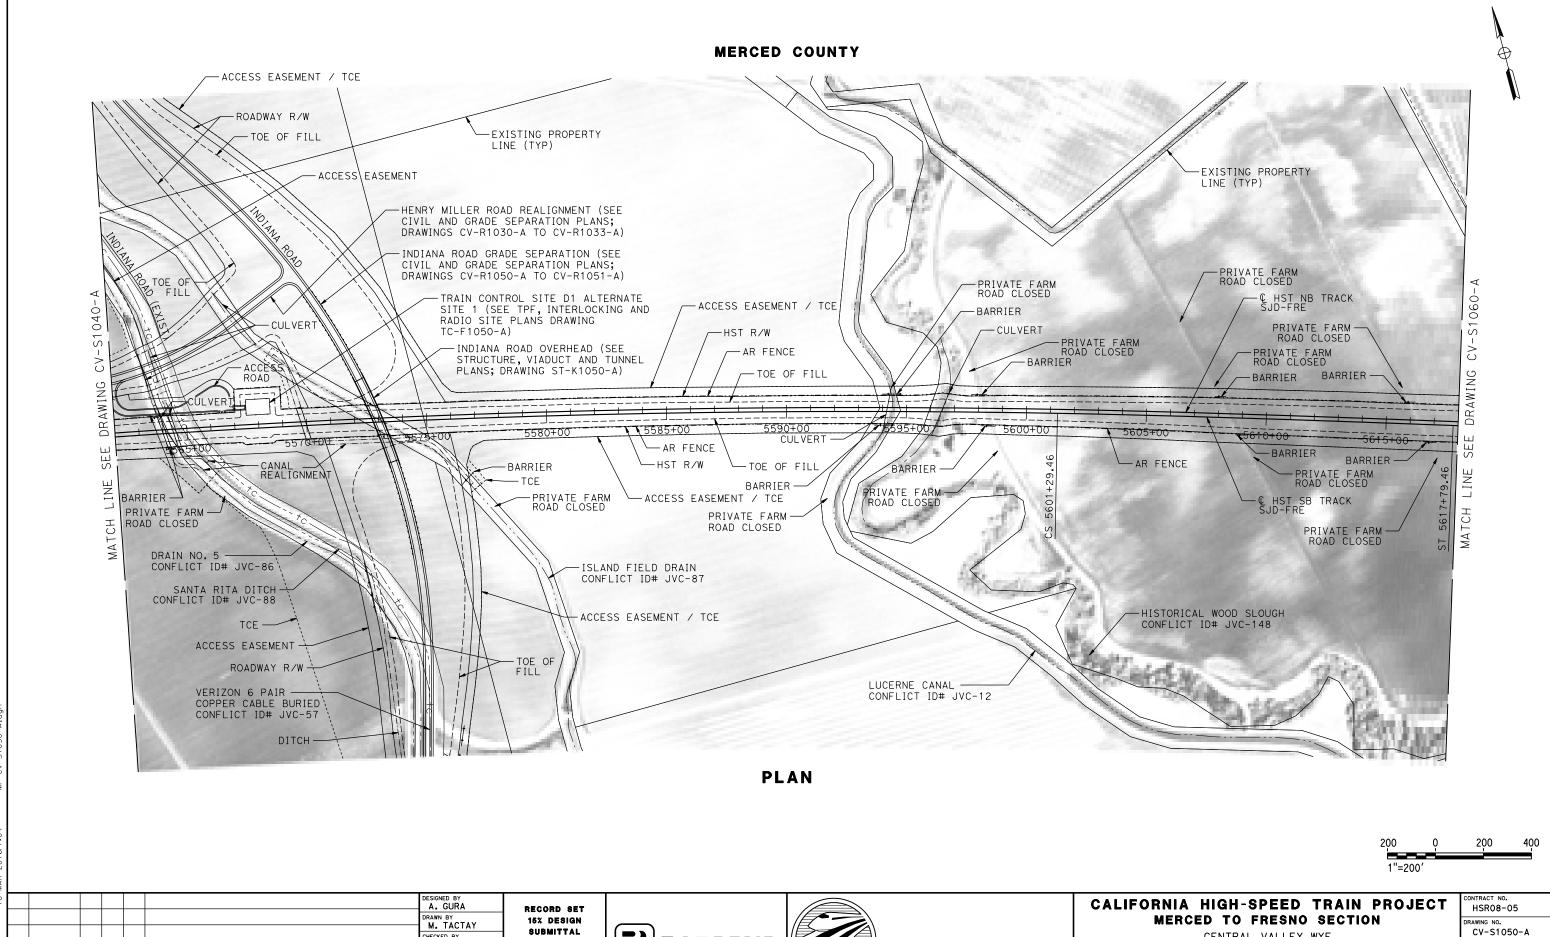

**PARSONS** 

**CALIFORNIA** 

HIGH-SPEED RAIL AUTHORITY

M. STANWIC

IN CHARGE
C. LEMLEY

03/18/2016

DATE

BY CHK APP

DESCRIPTION


NOT FOR

CONSTRUCTION

CENTRAL VALLEY WYE
SR 152 (NORTH) TO ROAD 13 WYE ALTERNATIVE
CIVIL PLAN
SJD-FRE STA 5562+00 TO 5618+00

1"=200'

SHEET NO.

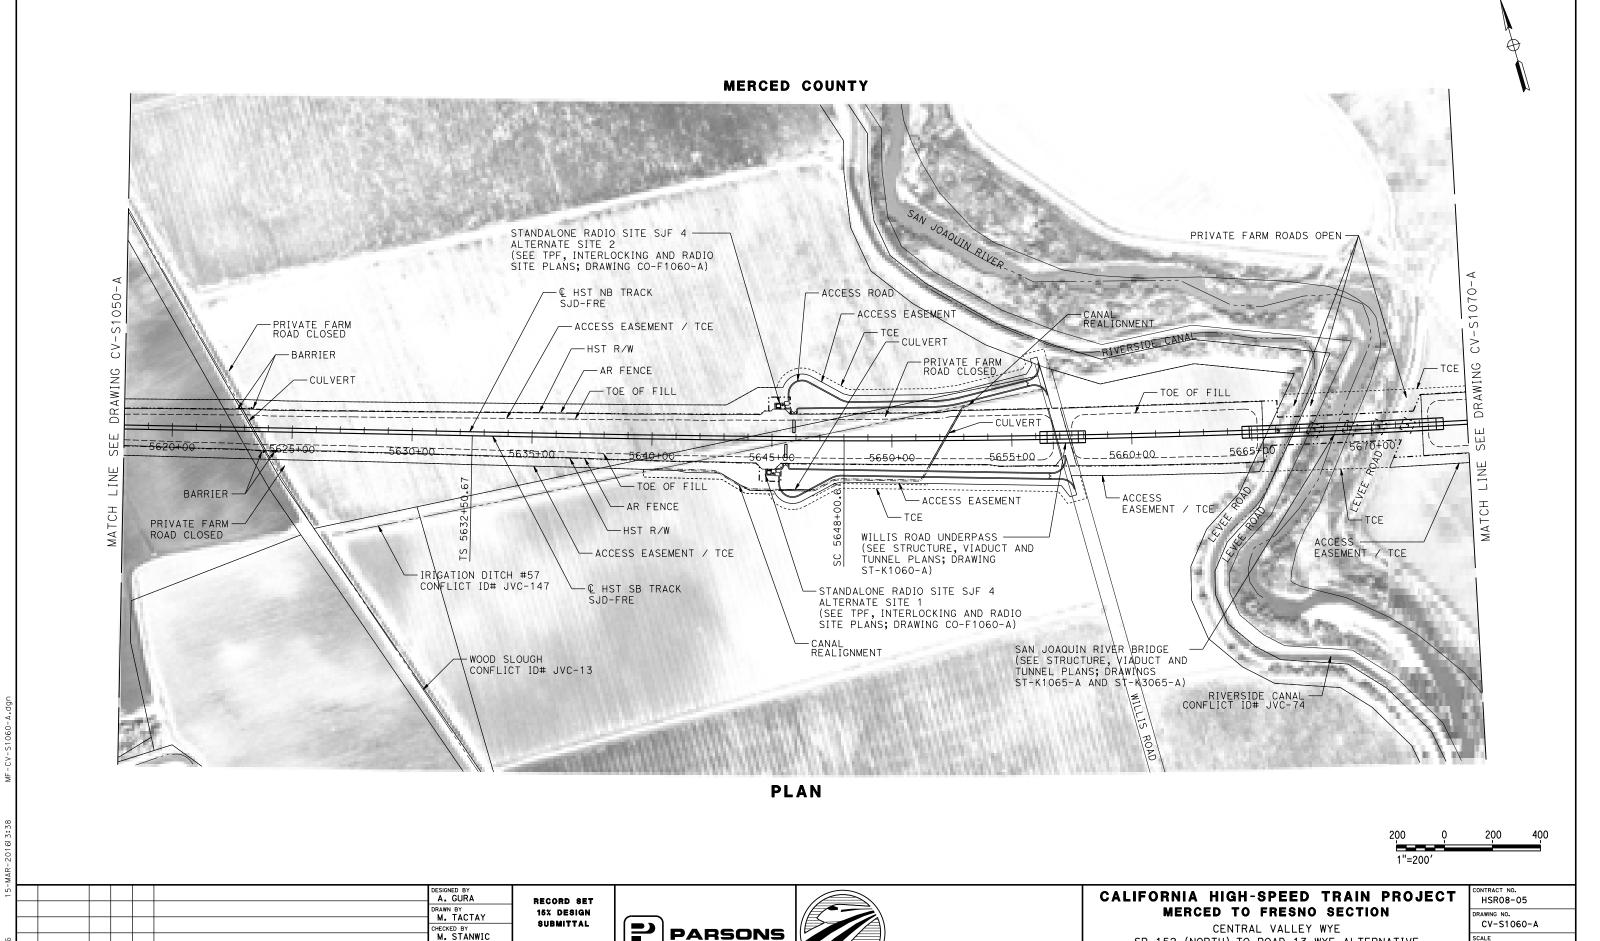

**CALIFORNIA** 

HIGH-SPEED RAIL AUTHORITY

NOT FOR

CONSTRUCTION

IN CHARGE
C. LEMLEY

03/18/2016

BY CHK APP

DESCRIPTION


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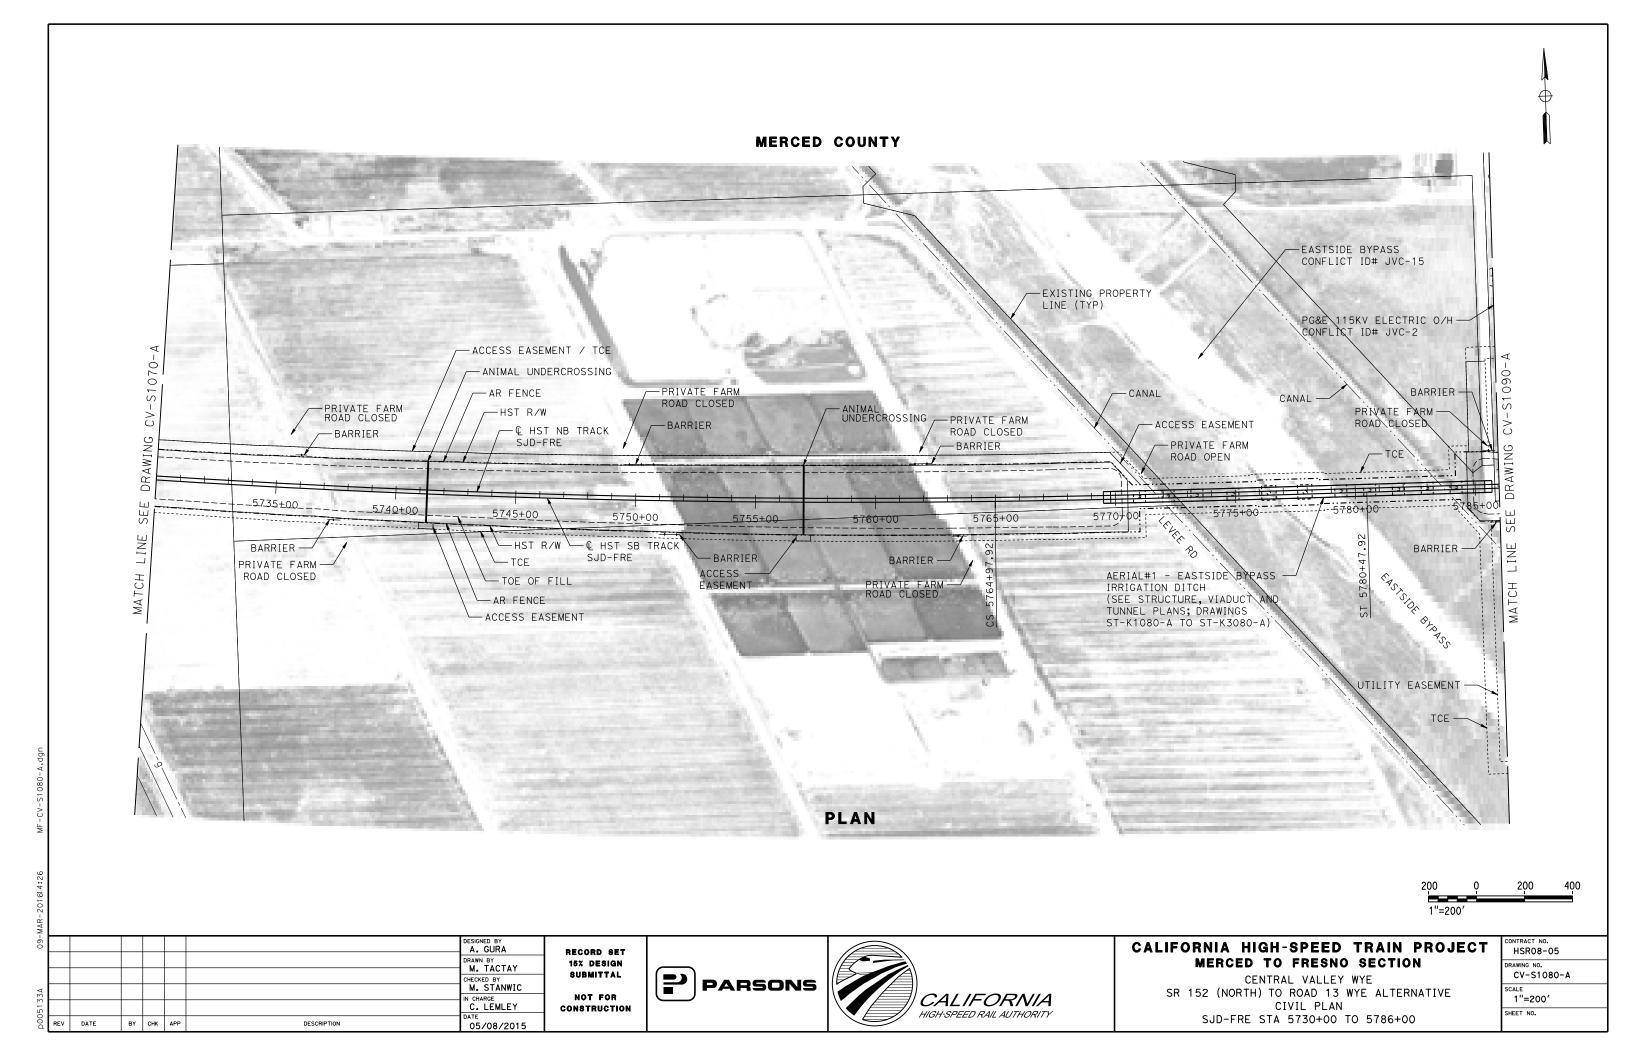
CIVIL PLAN


SJD-FRE STA 5618+00 TO 5674+00


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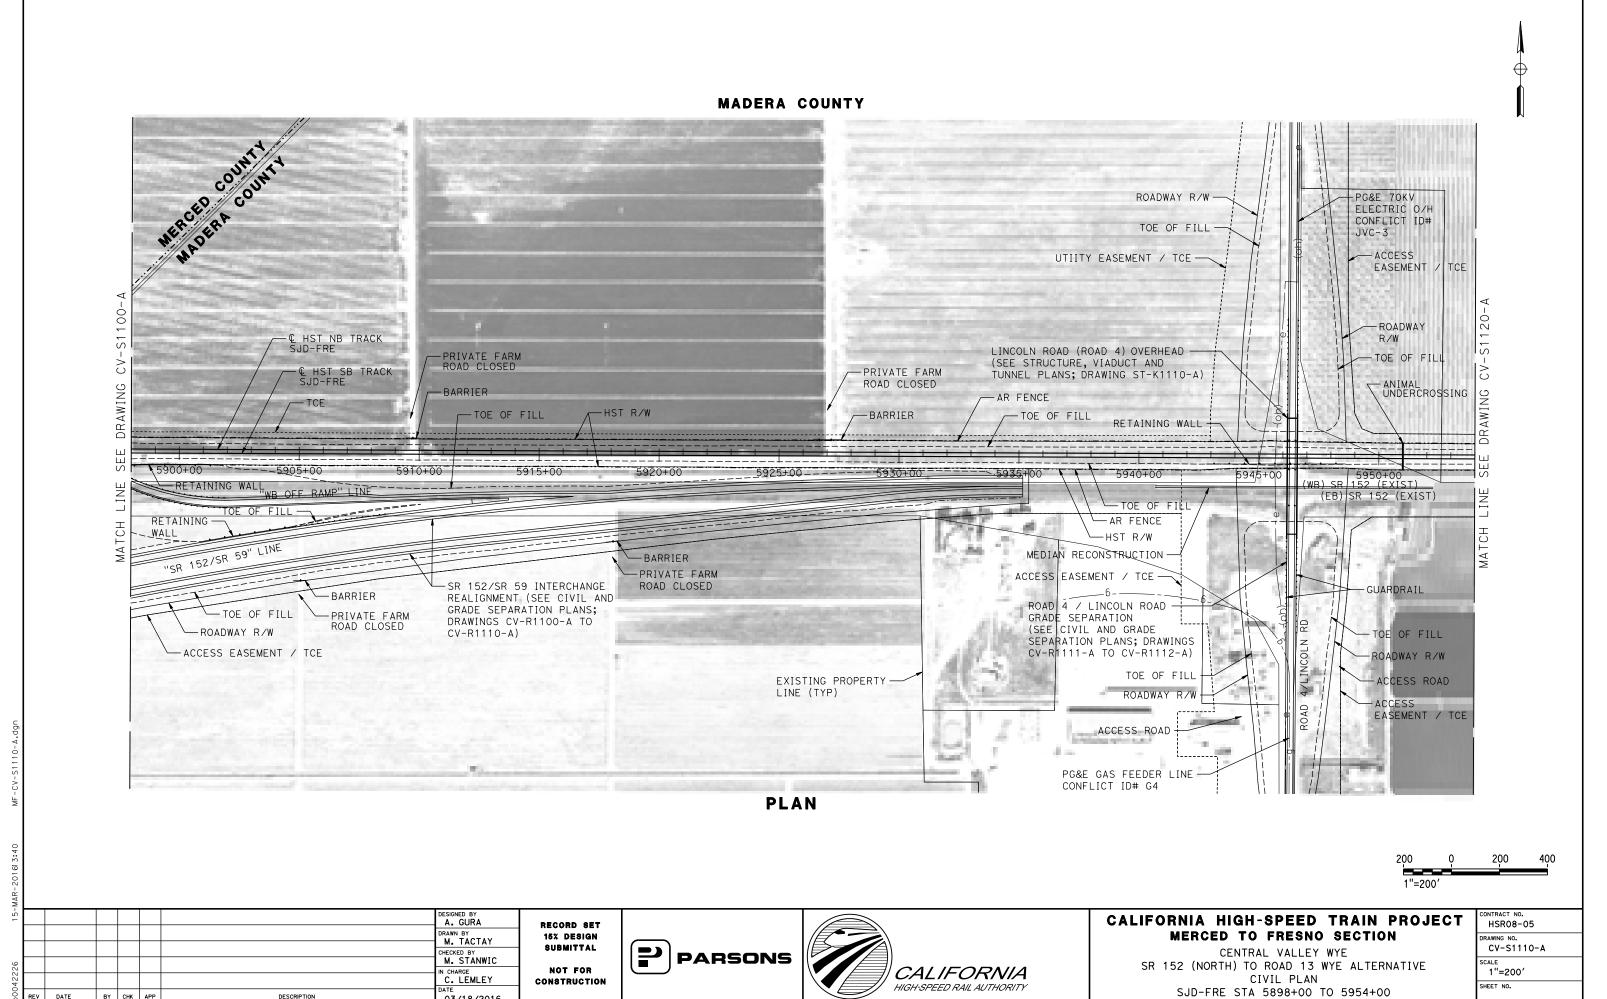
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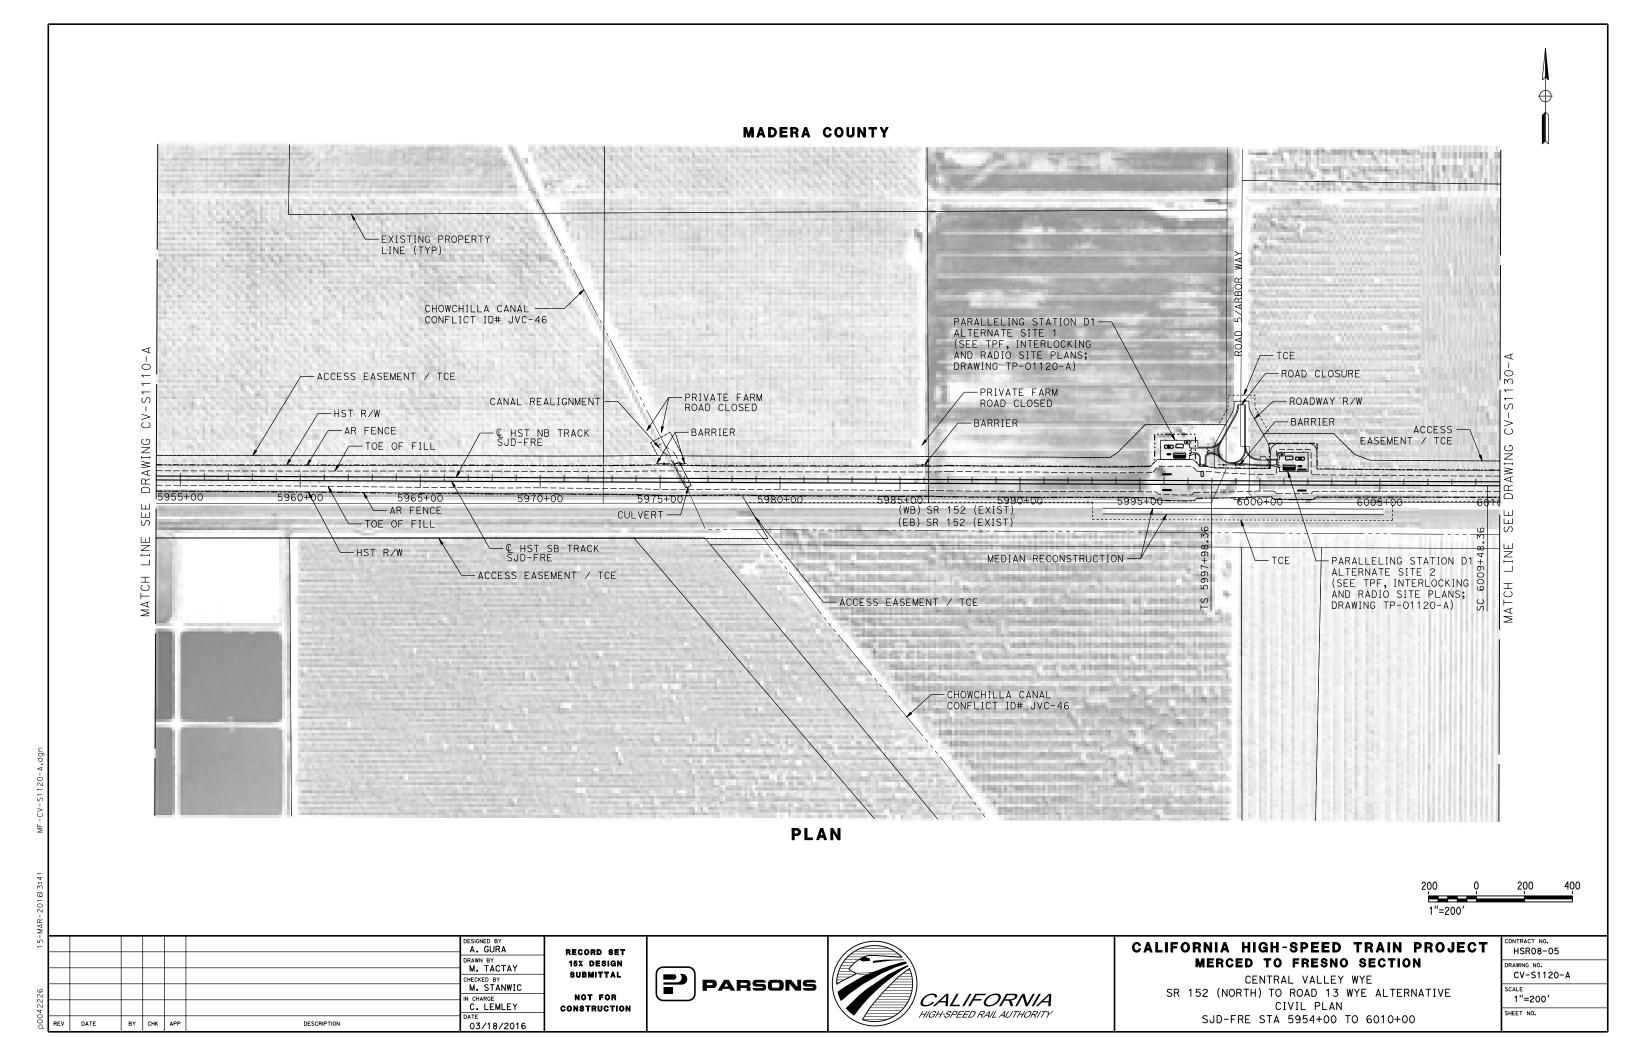






BY CHK APP

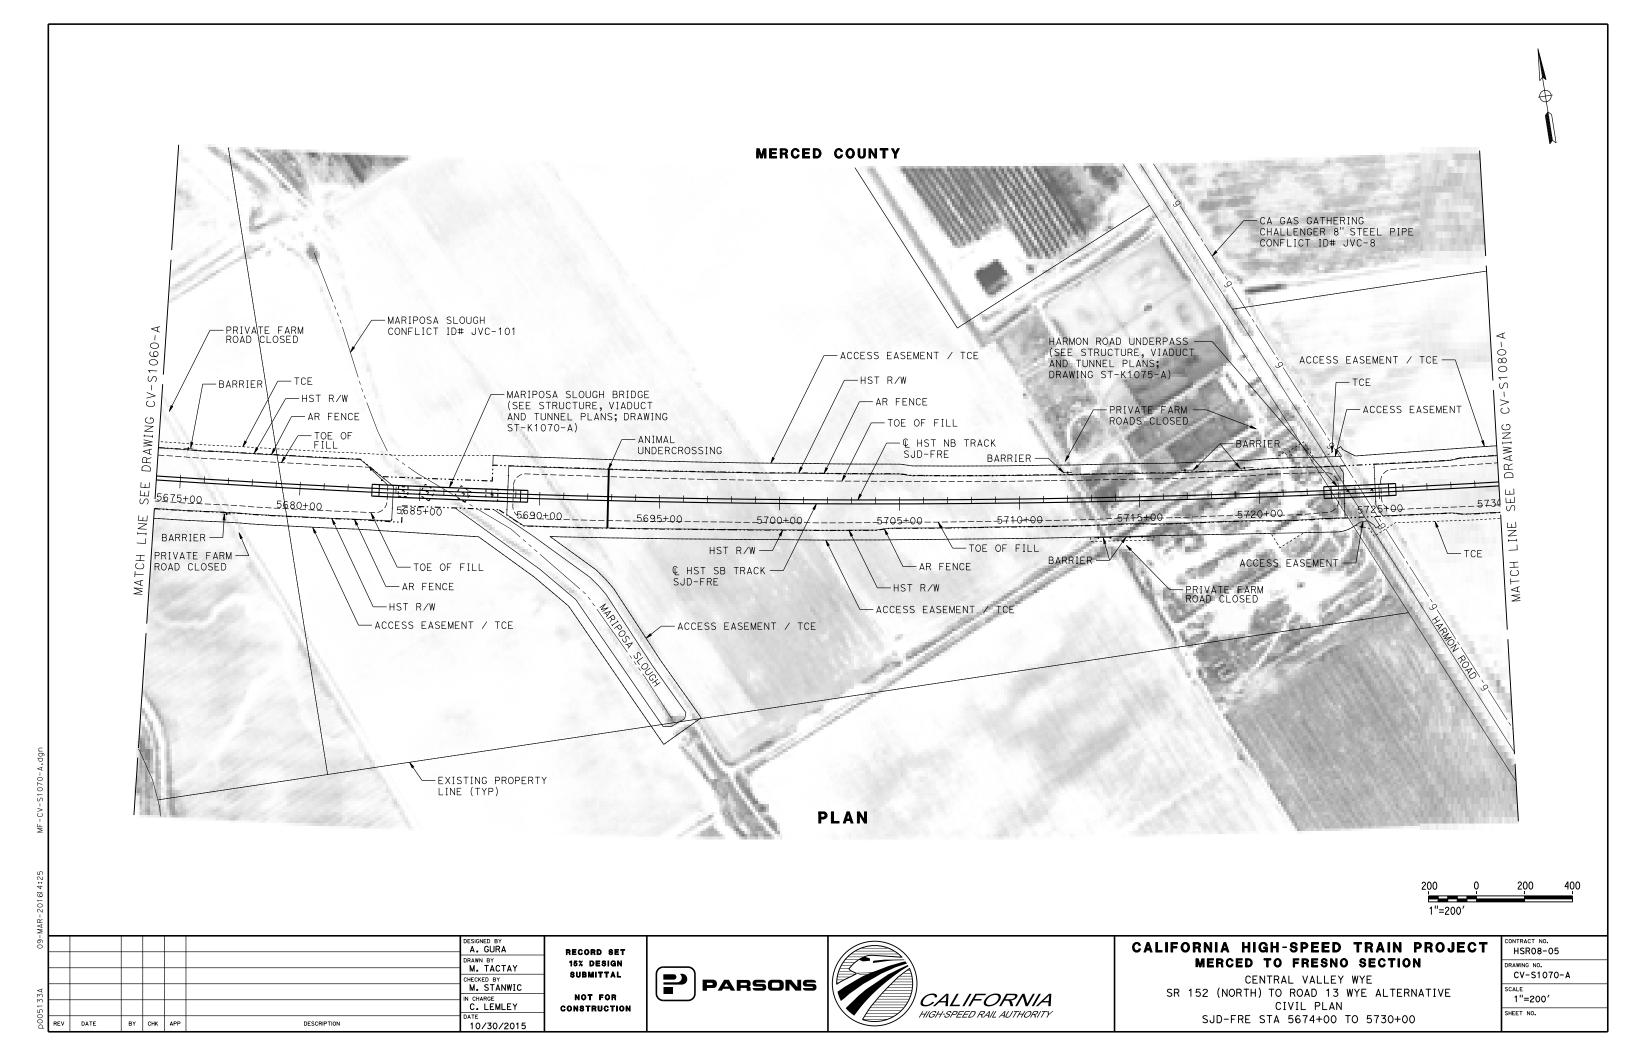DESCRIPTION

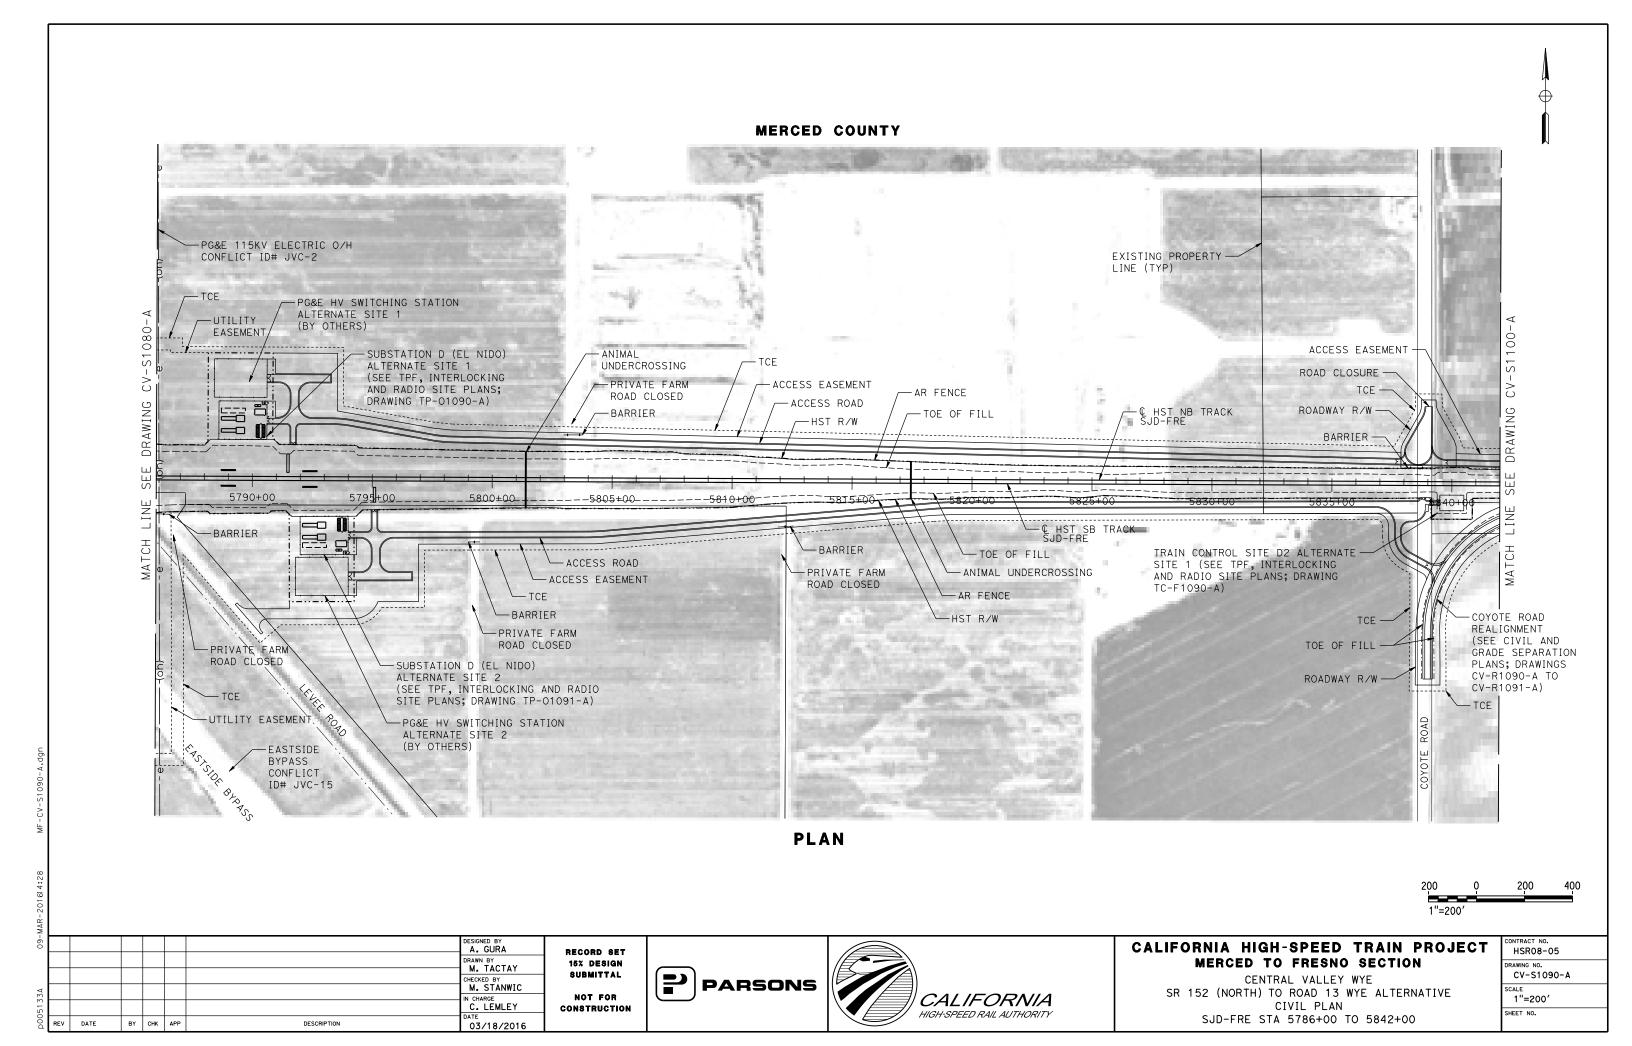03/18/2016

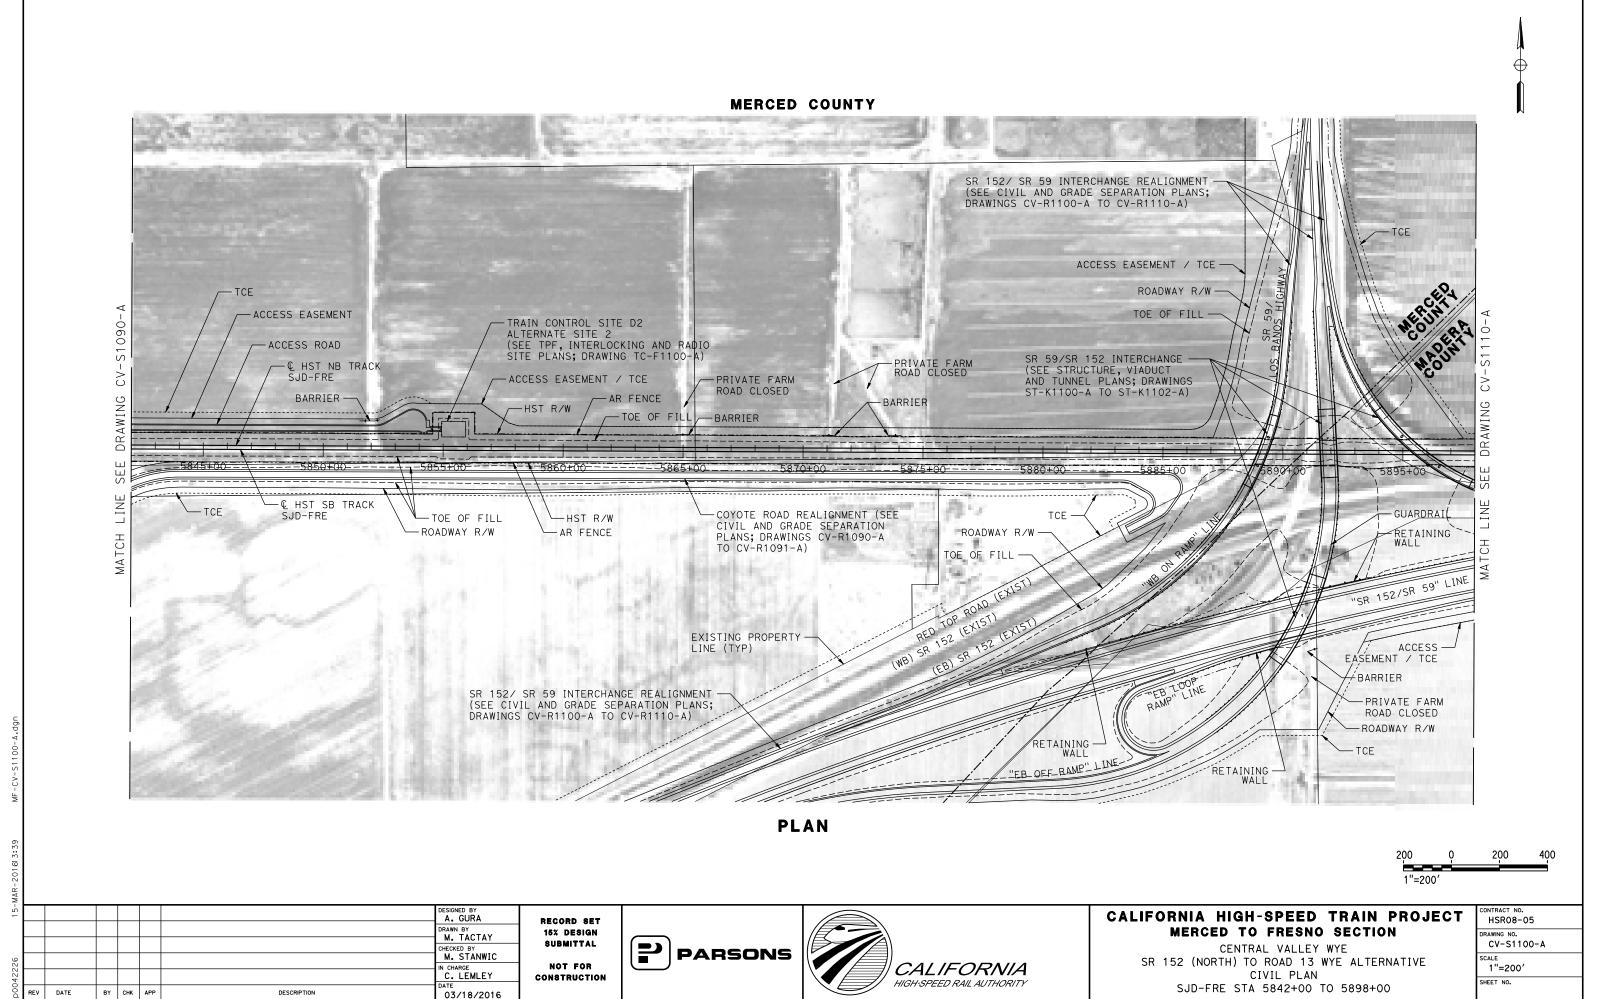

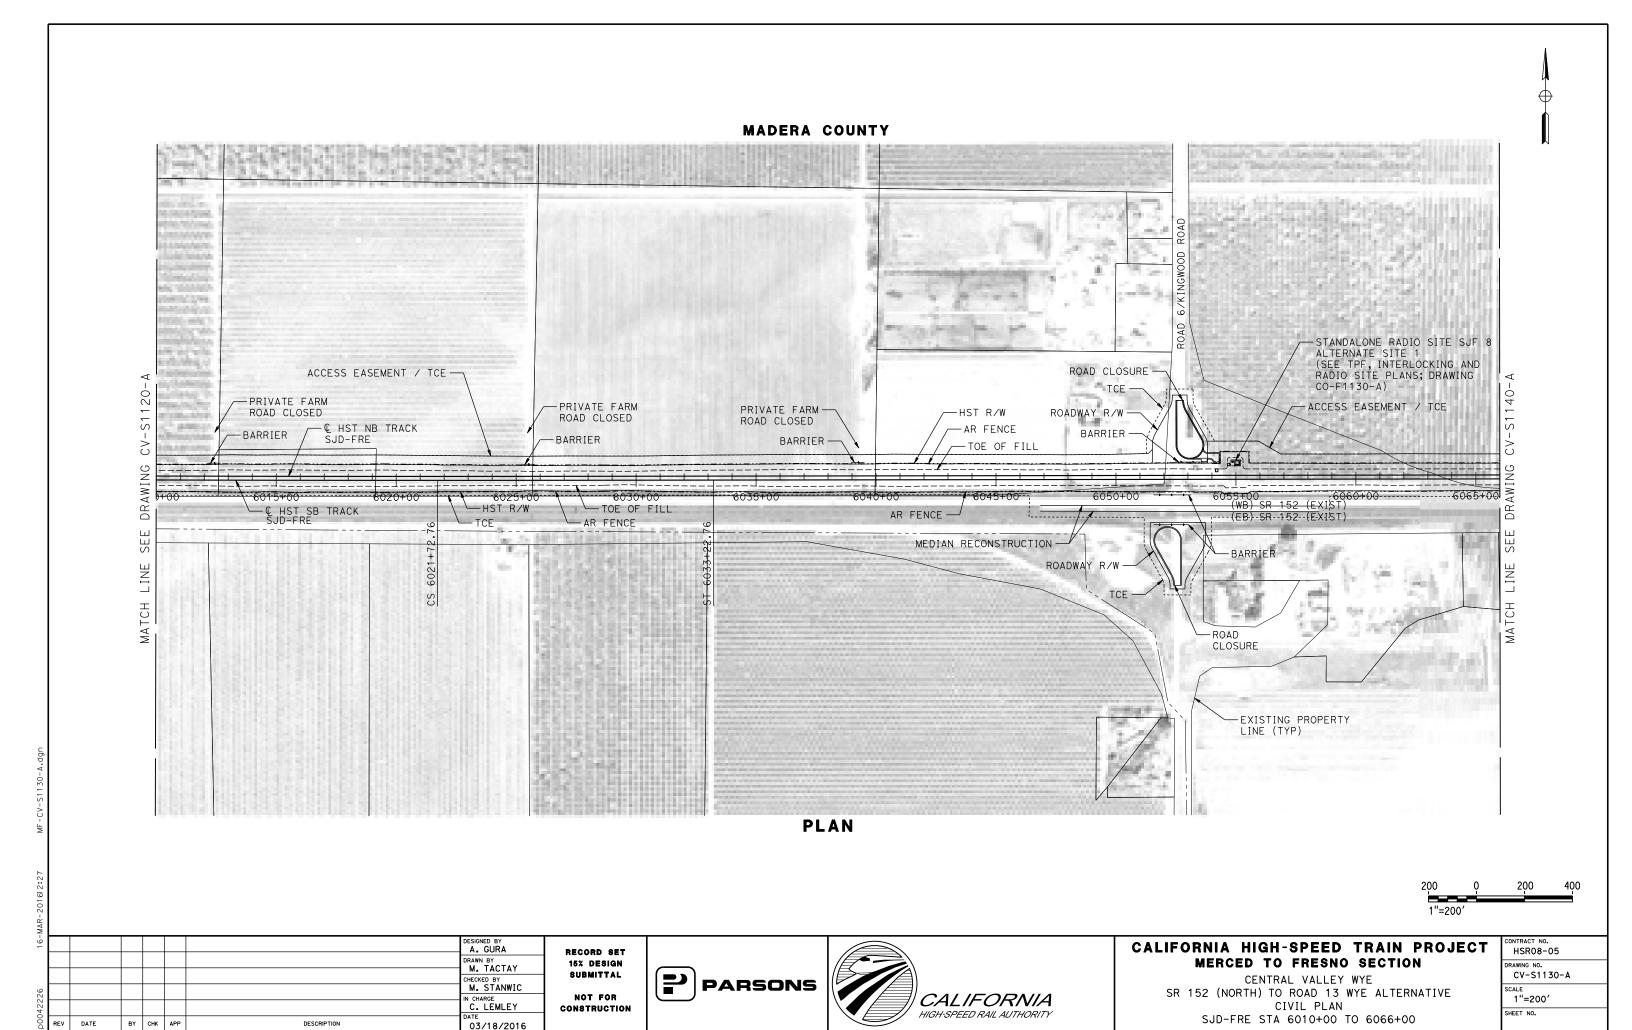


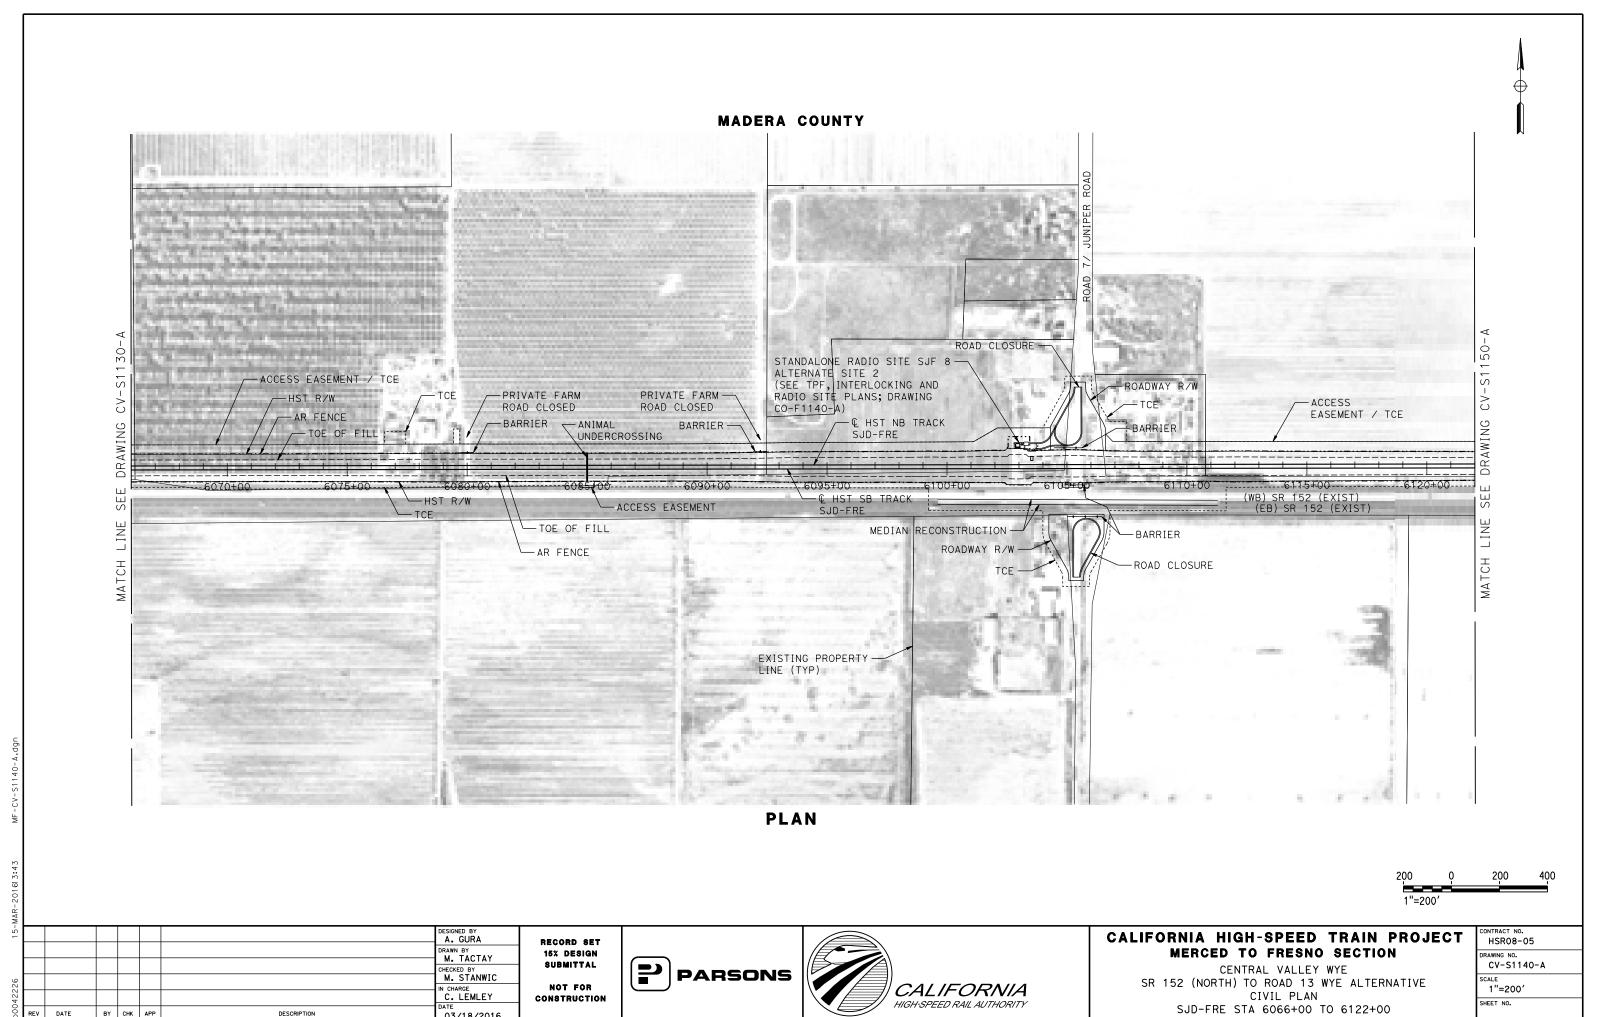


BY CHK APP

DESCRIPTION

03/18/2016

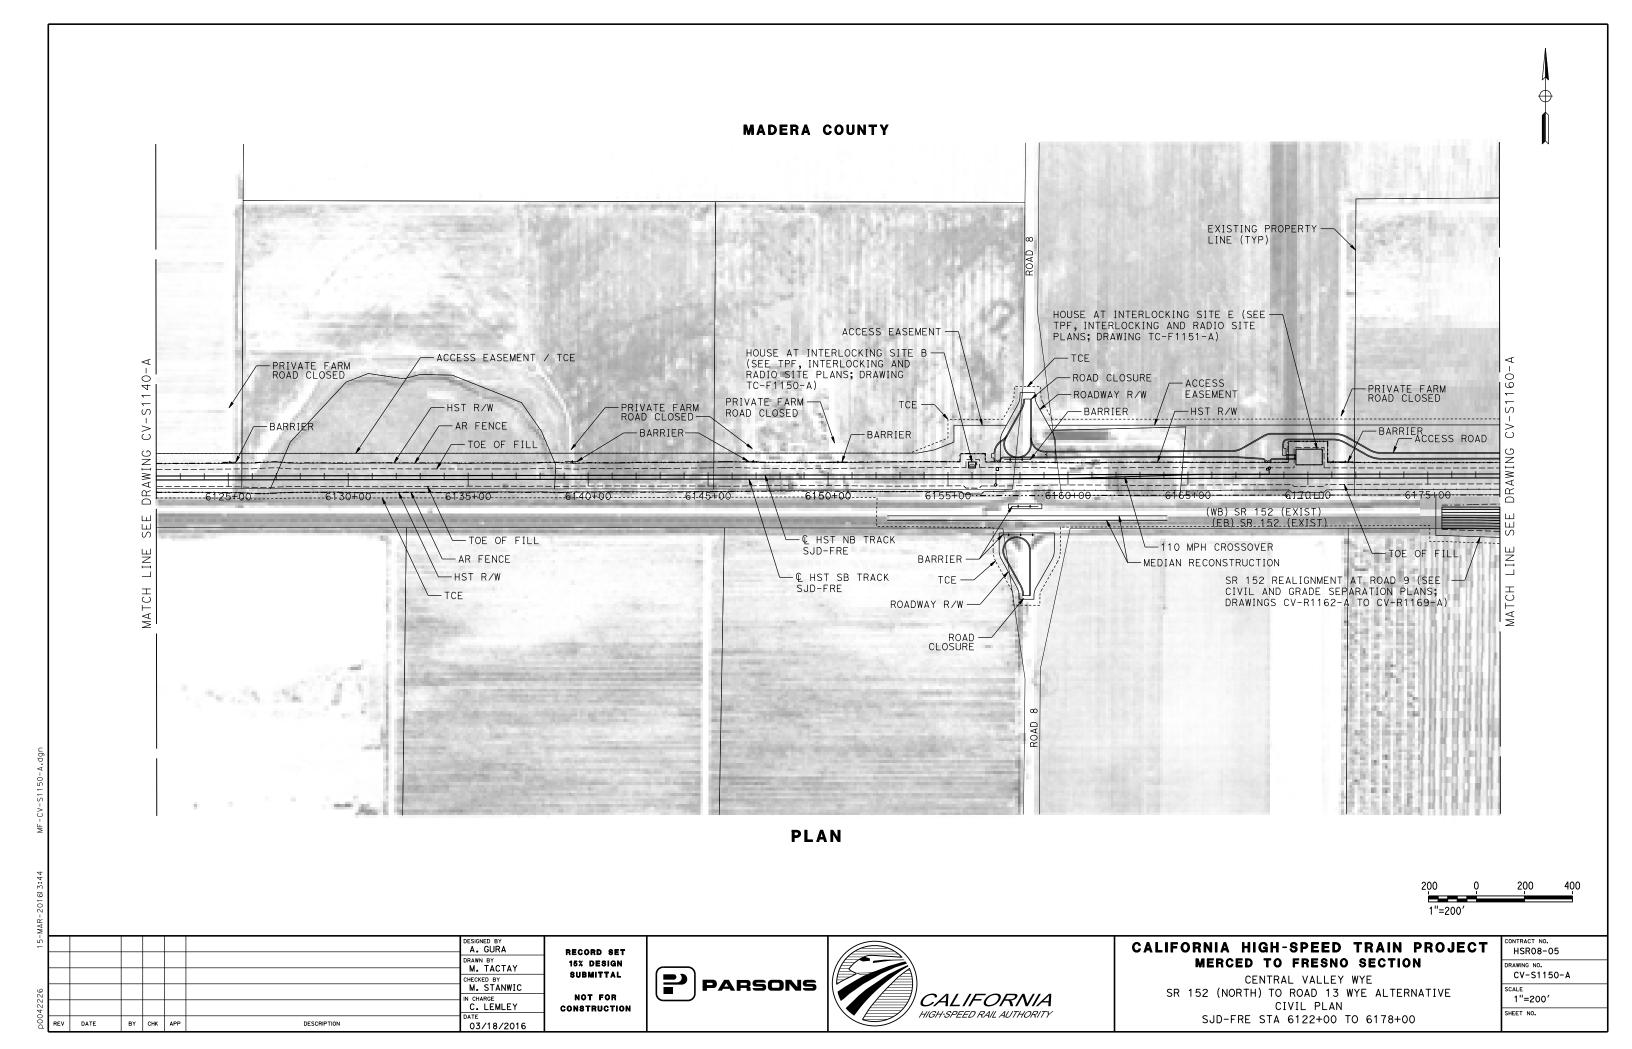

#### MADERA COUNTY

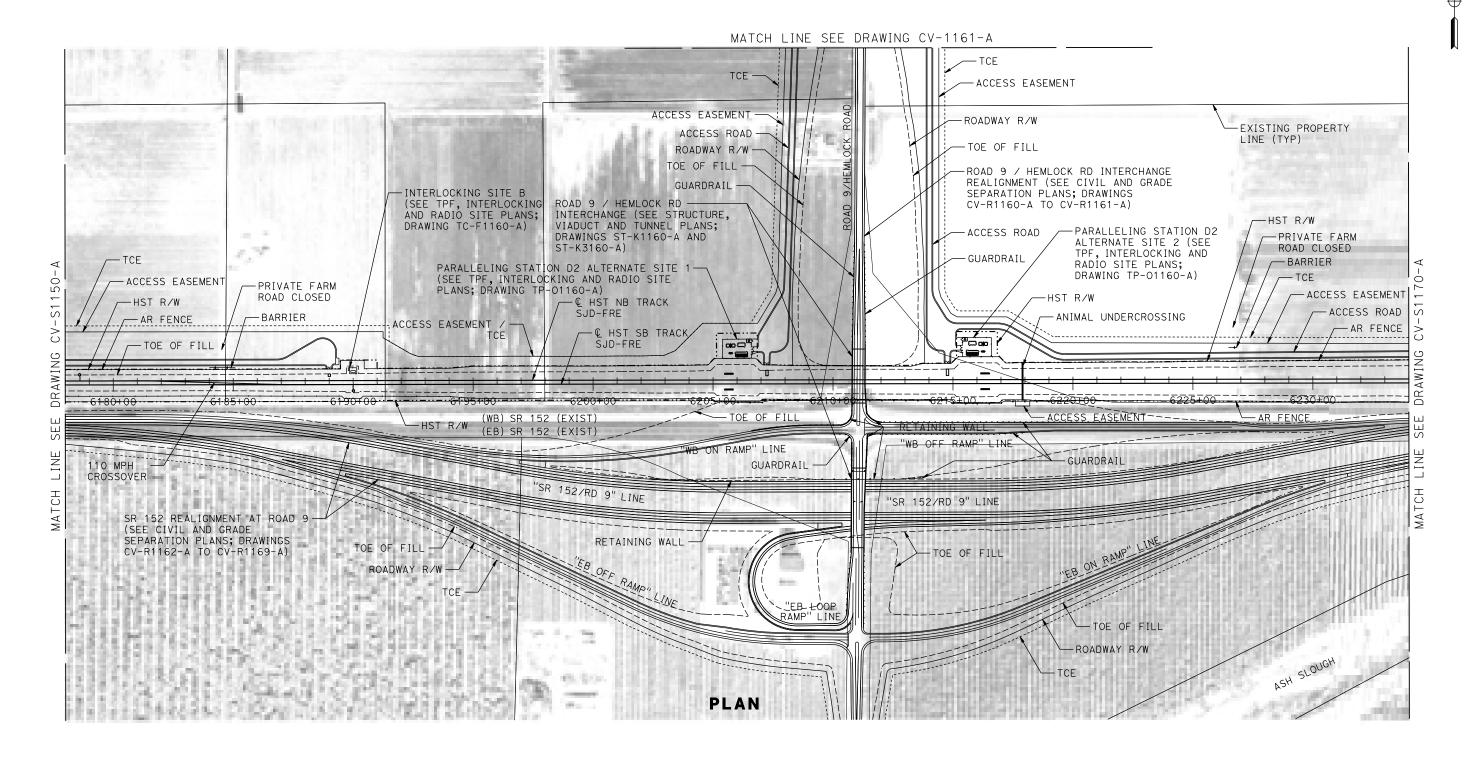

200	Q	200	400
1"=20	0'		

-								
16-							DESIGNED BY A. GURA	R
							DRAWN BY M. TACTAY	1
							CHECKED BY	۱ ۹
226							M. STANWIC IN CHARGE	l
)422;							C. LEMLEY	co
00d	REV	DATE	BY	снк	APP	DESCRIPTION	03/18/2016	

RECORD SET
15% DESIGN
SUBMITTAL
NOT FOR
CONSTRUCTION








## CALIFORNIA HIGH-SPEED TRAIN PROJECT MERCED TO FRESNO SECTION

CENTRAL VALLEY WYE
SR 152 (NORTH) TO ROAD 13 WYE ALTERNATIVE
CIVIL PLAN
SJD-FRE STA 6178+00 TO 6234+00

CONTRACT NO.
HSR08-05
DRAWING NO.
CV-S1160-A
SCALE
1"=200′
SHEET NO.

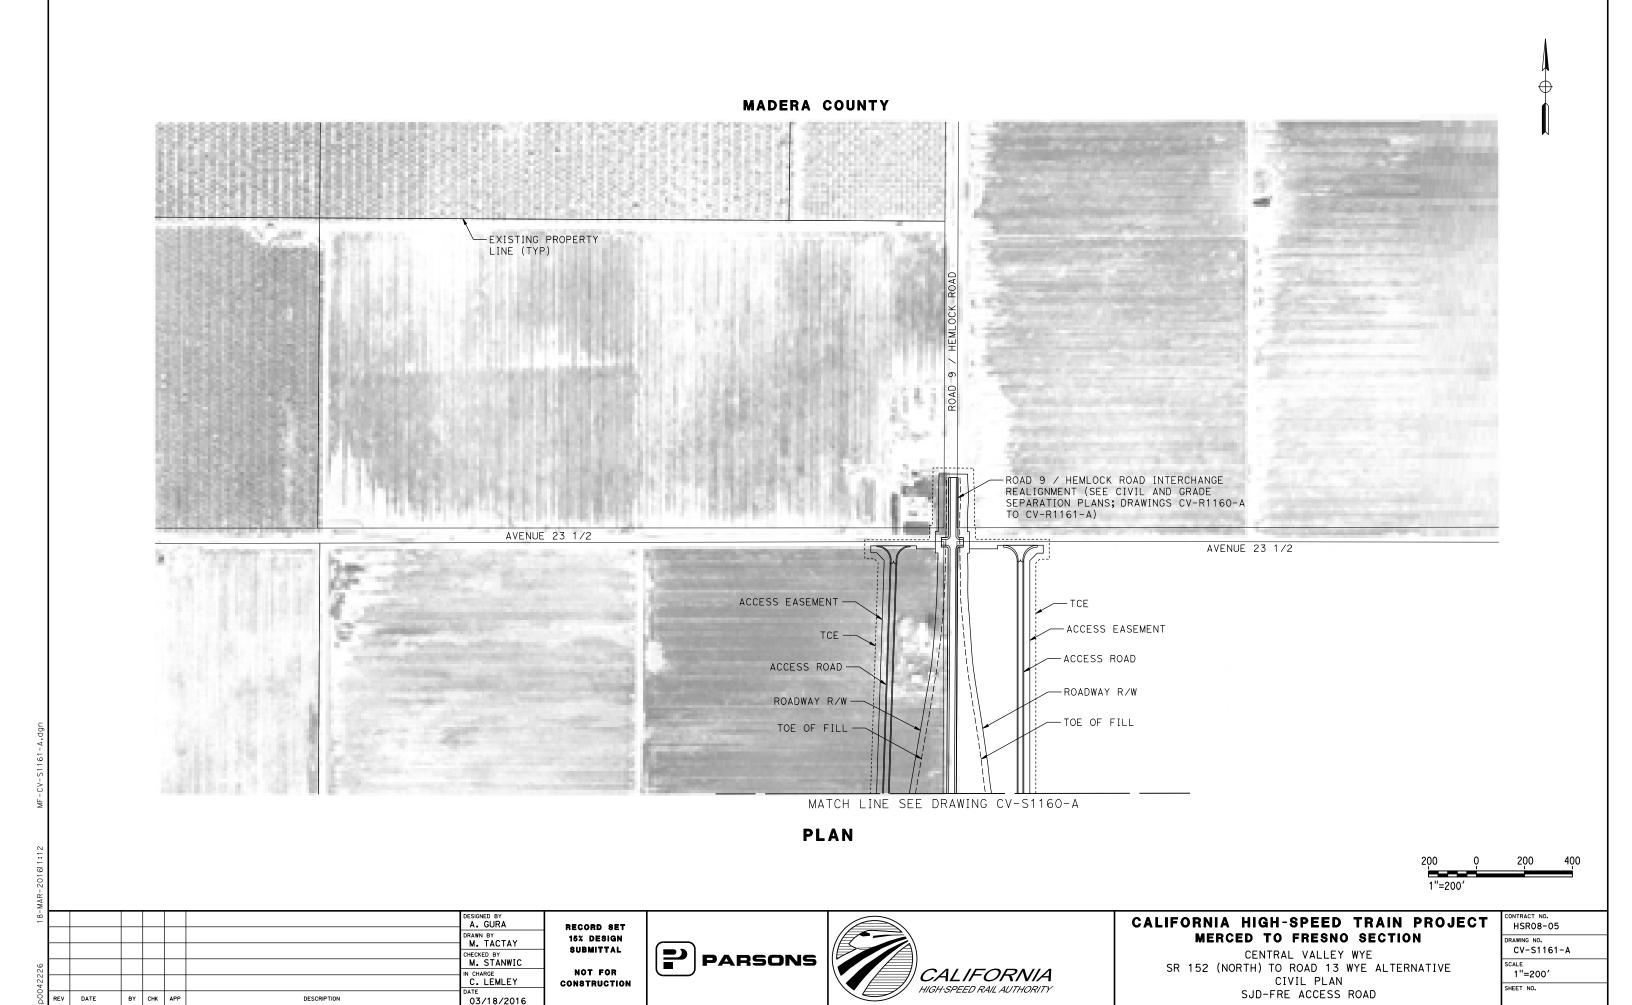

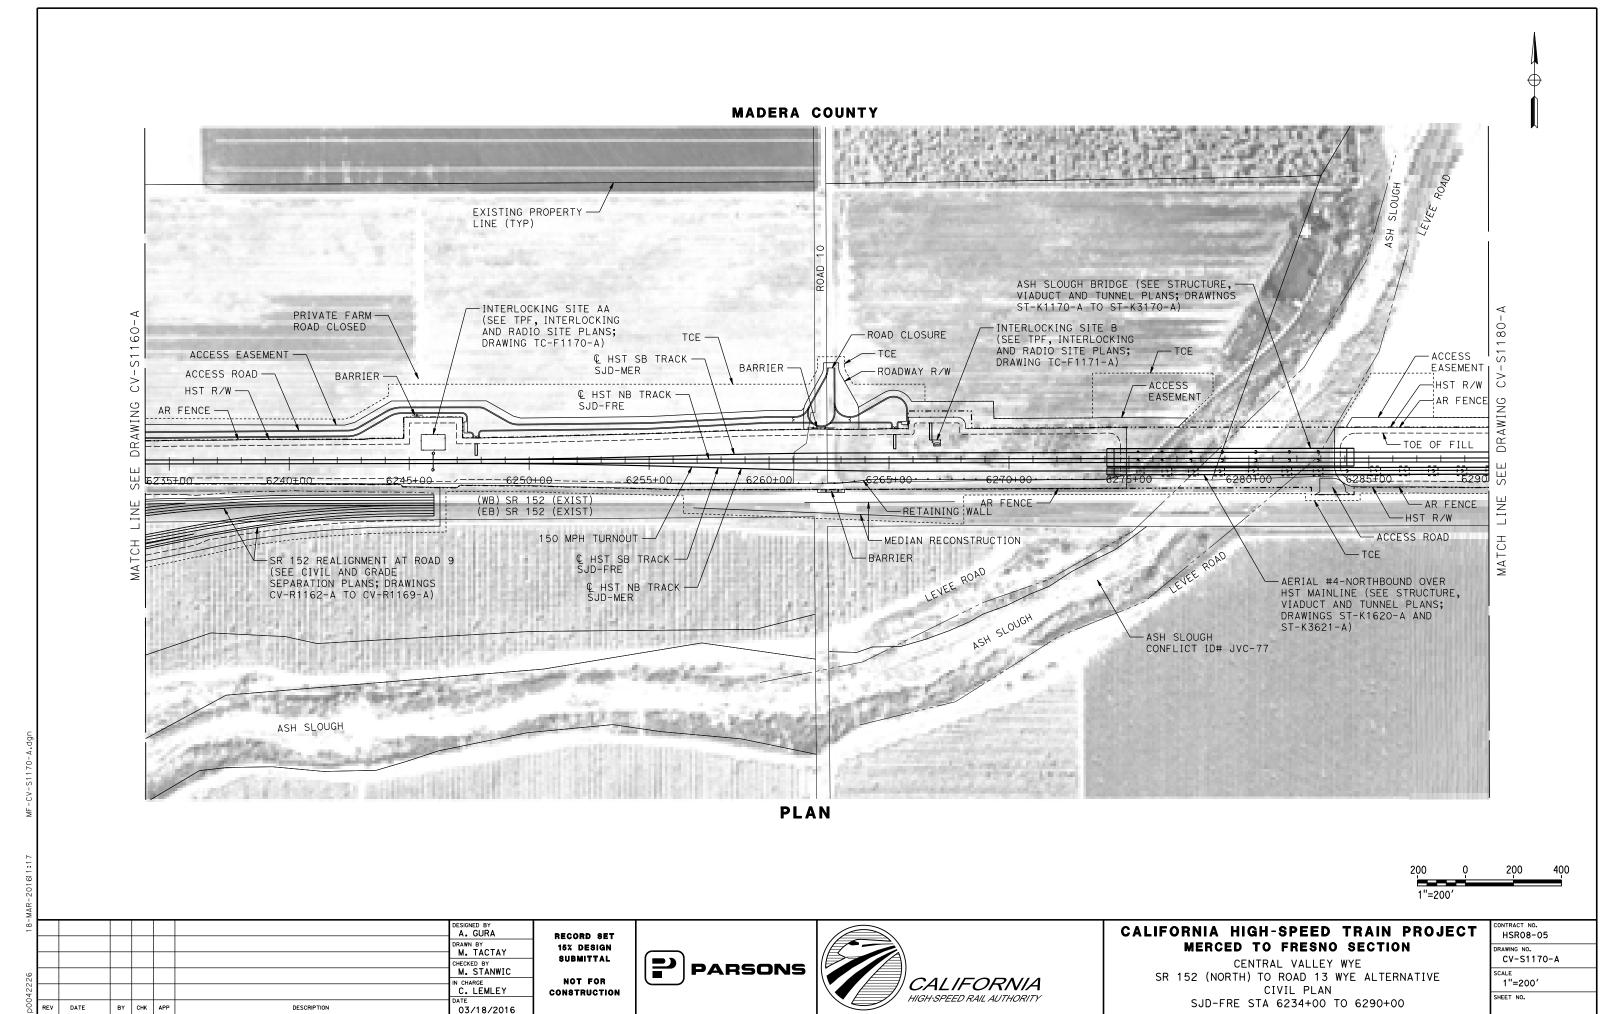

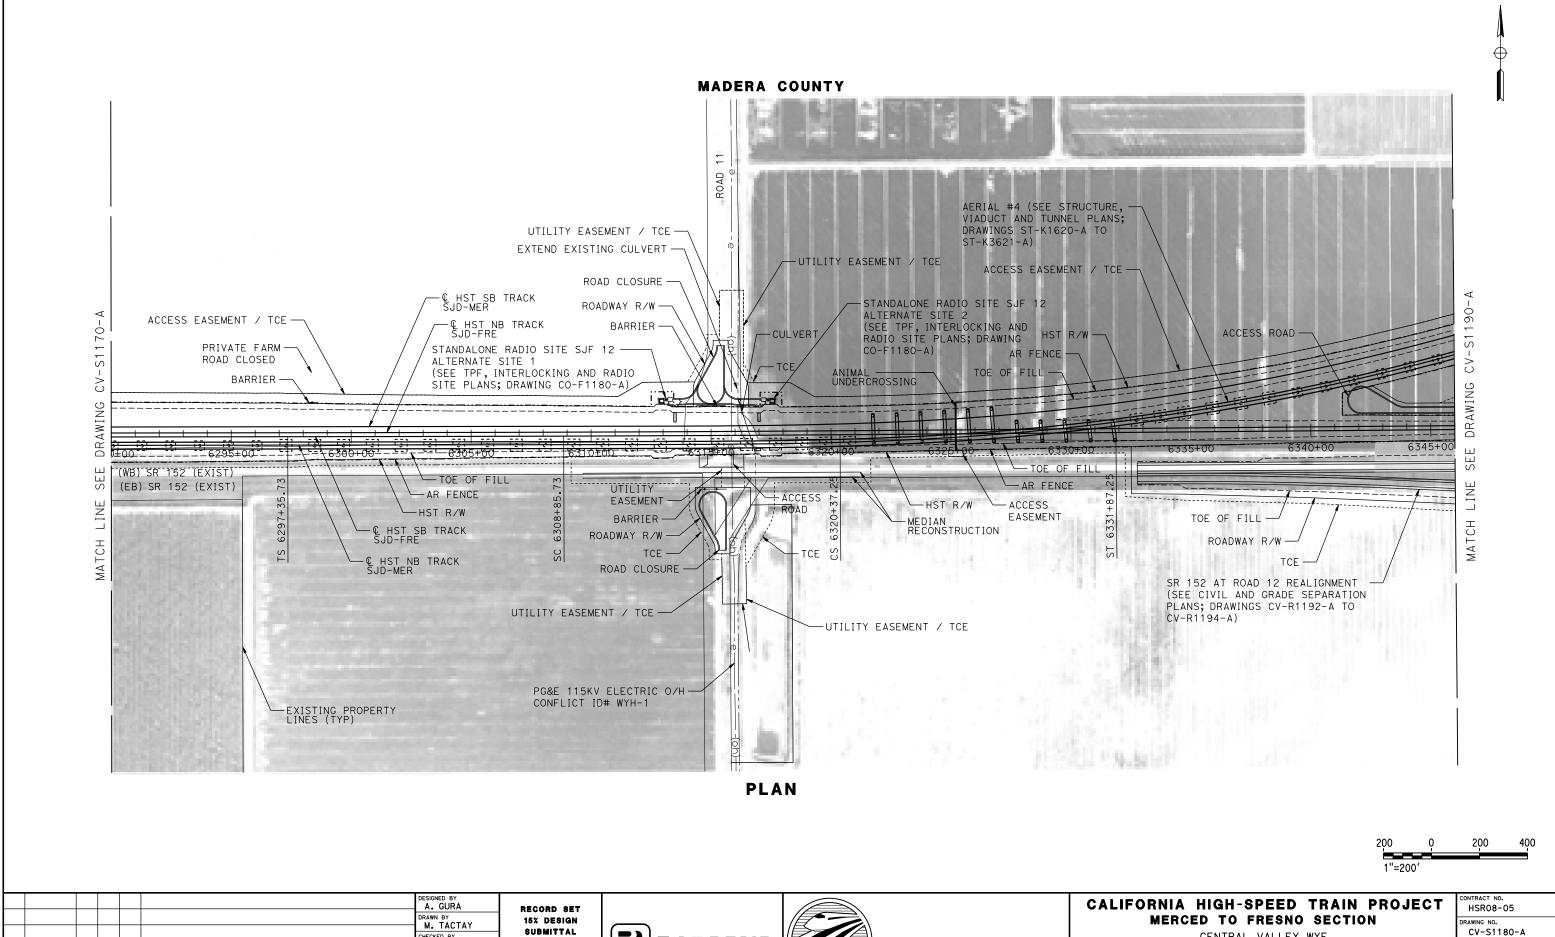

**PARSONS** 

**CALIFORNIA** 

HIGH-SPEED RAIL AUTHORITY

M. STANWIC

IN CHARGE
C. LEMLEY

03/18/2016

BY CHK APP

DESCRIPTION


NOT FOR

CONSTRUCTION

CENTRAL VALLEY WYE
SR 152 (NORTH) TO ROAD 13 WYE ALTERNATIVE
CIVIL PLAN
SJD-FRE STA 6290+00 TO 6346+00

1"=200'

SHEET NO.

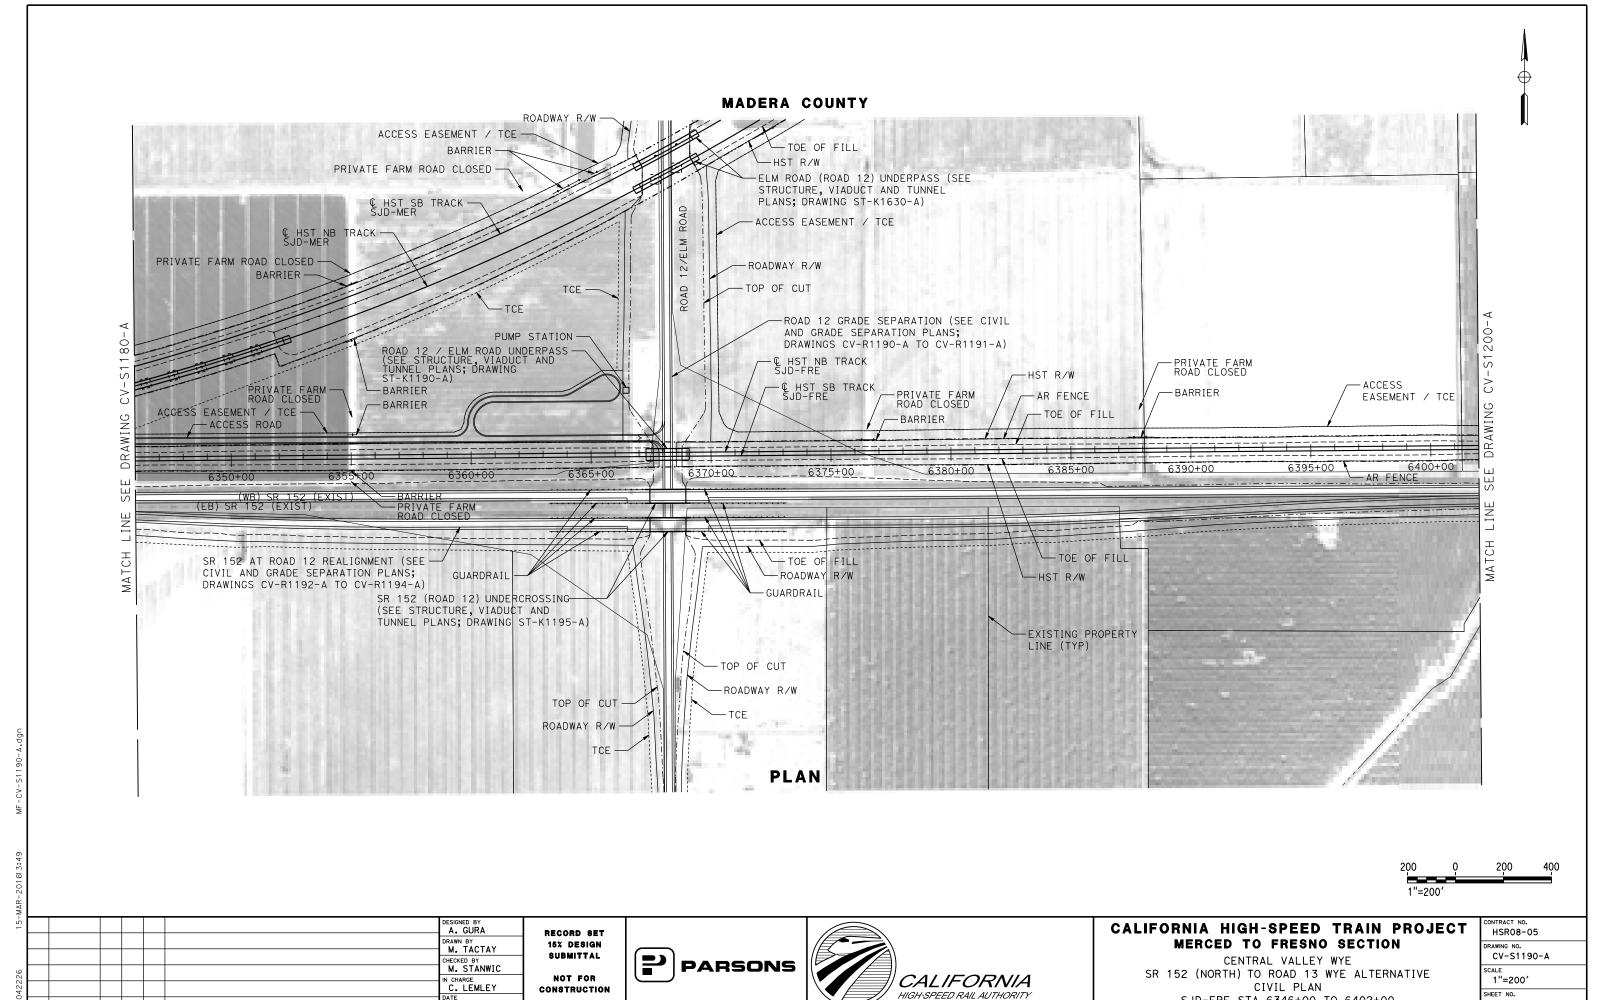



BY CHK APP


DESCRIPTION


03/18/2016


SJD-FRE STA 6346+00 TO 6402+00

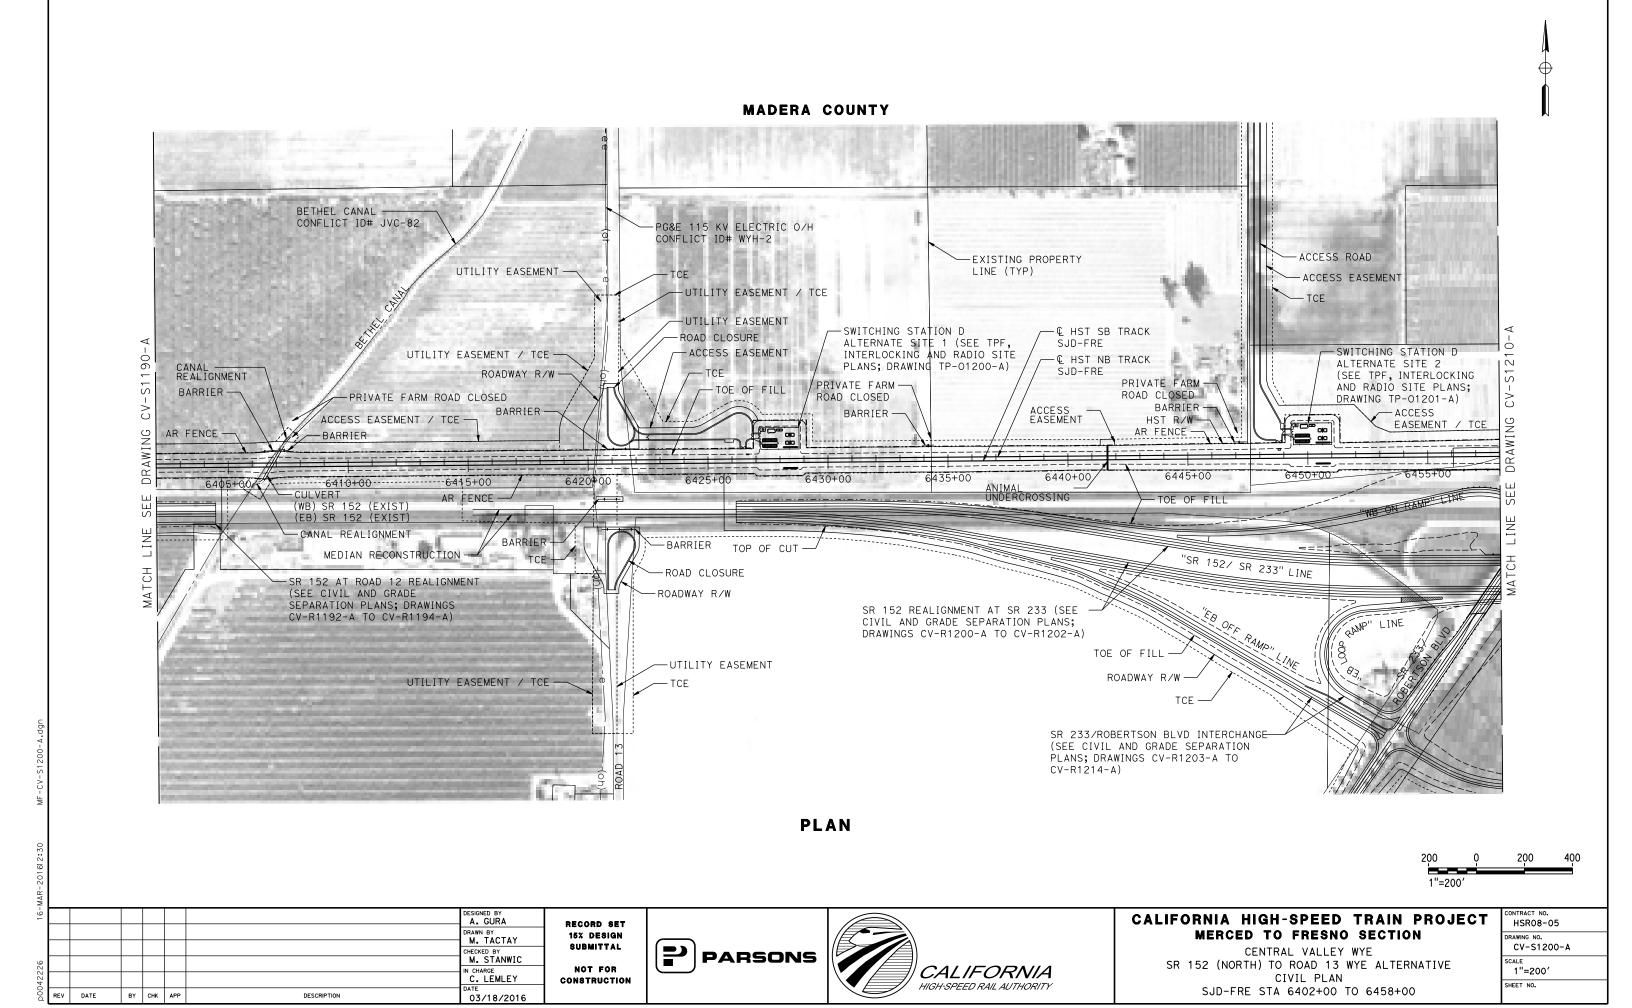


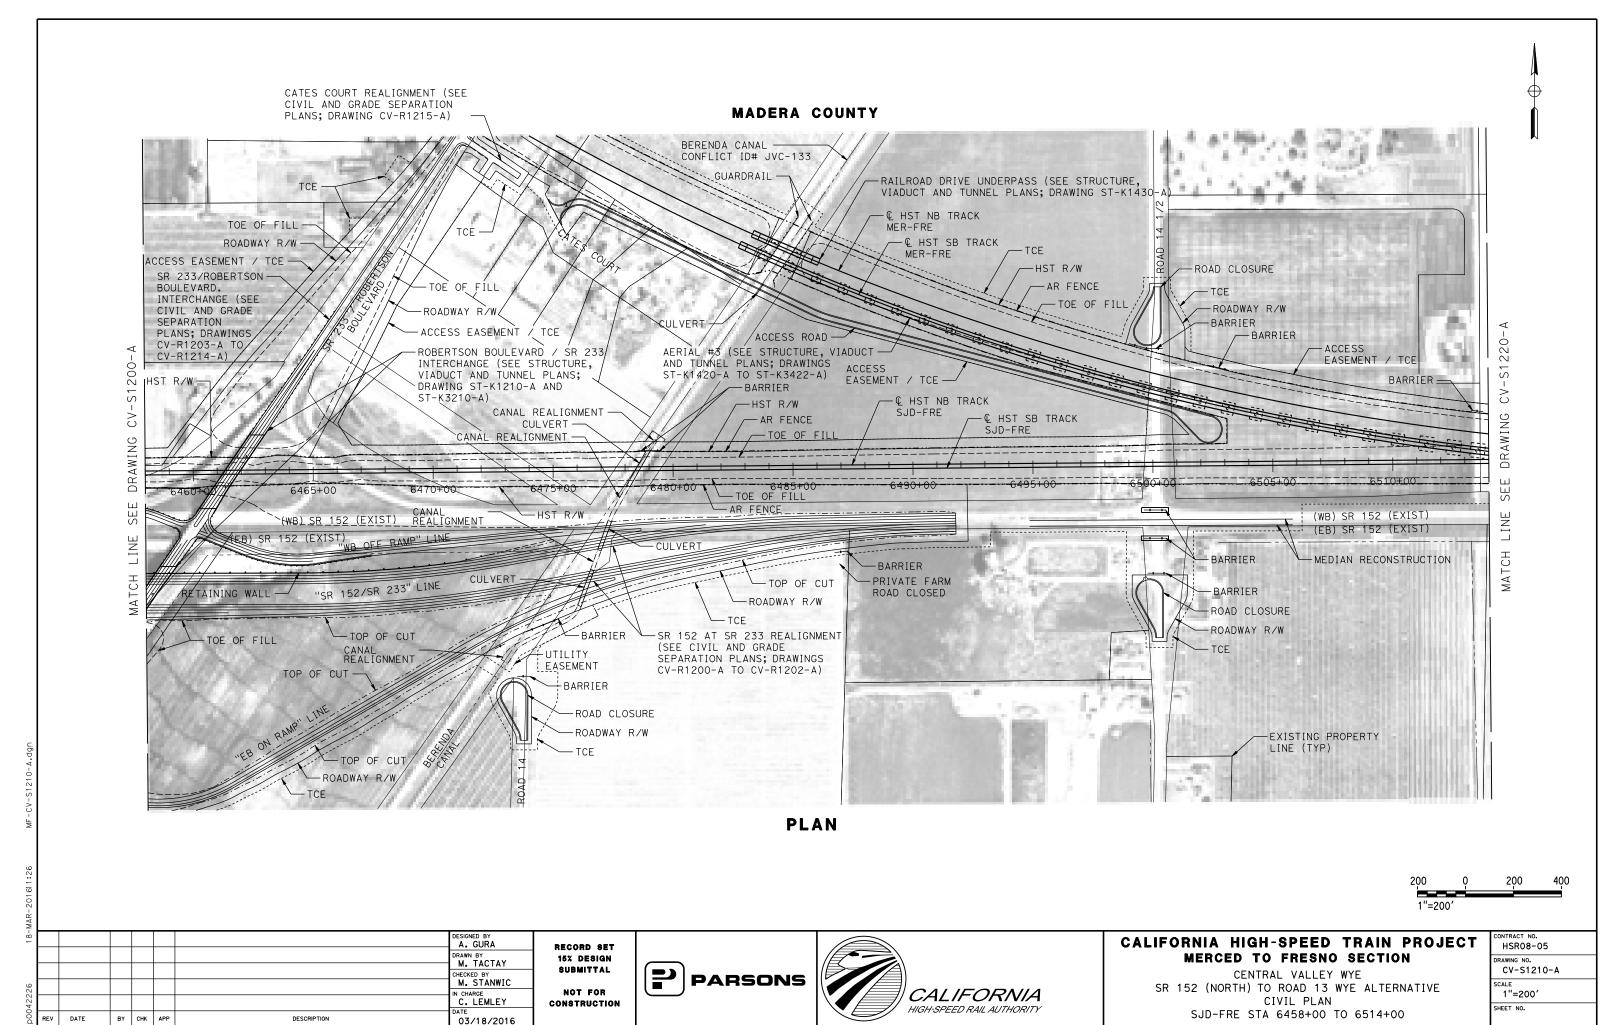


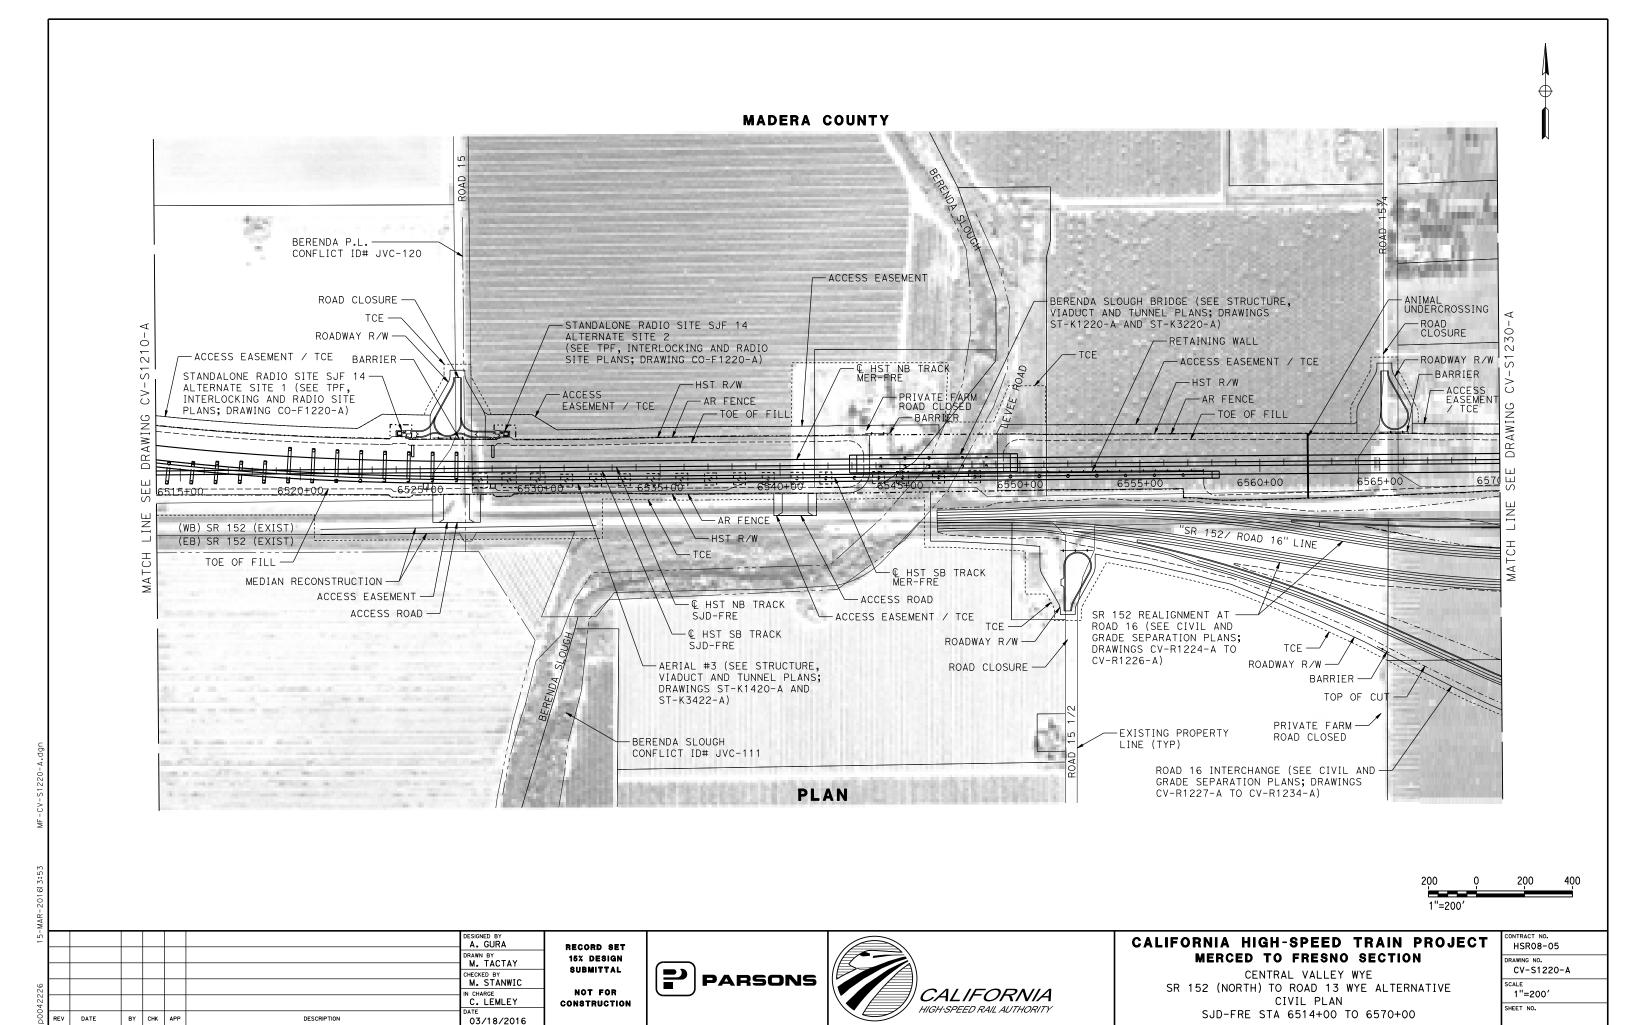

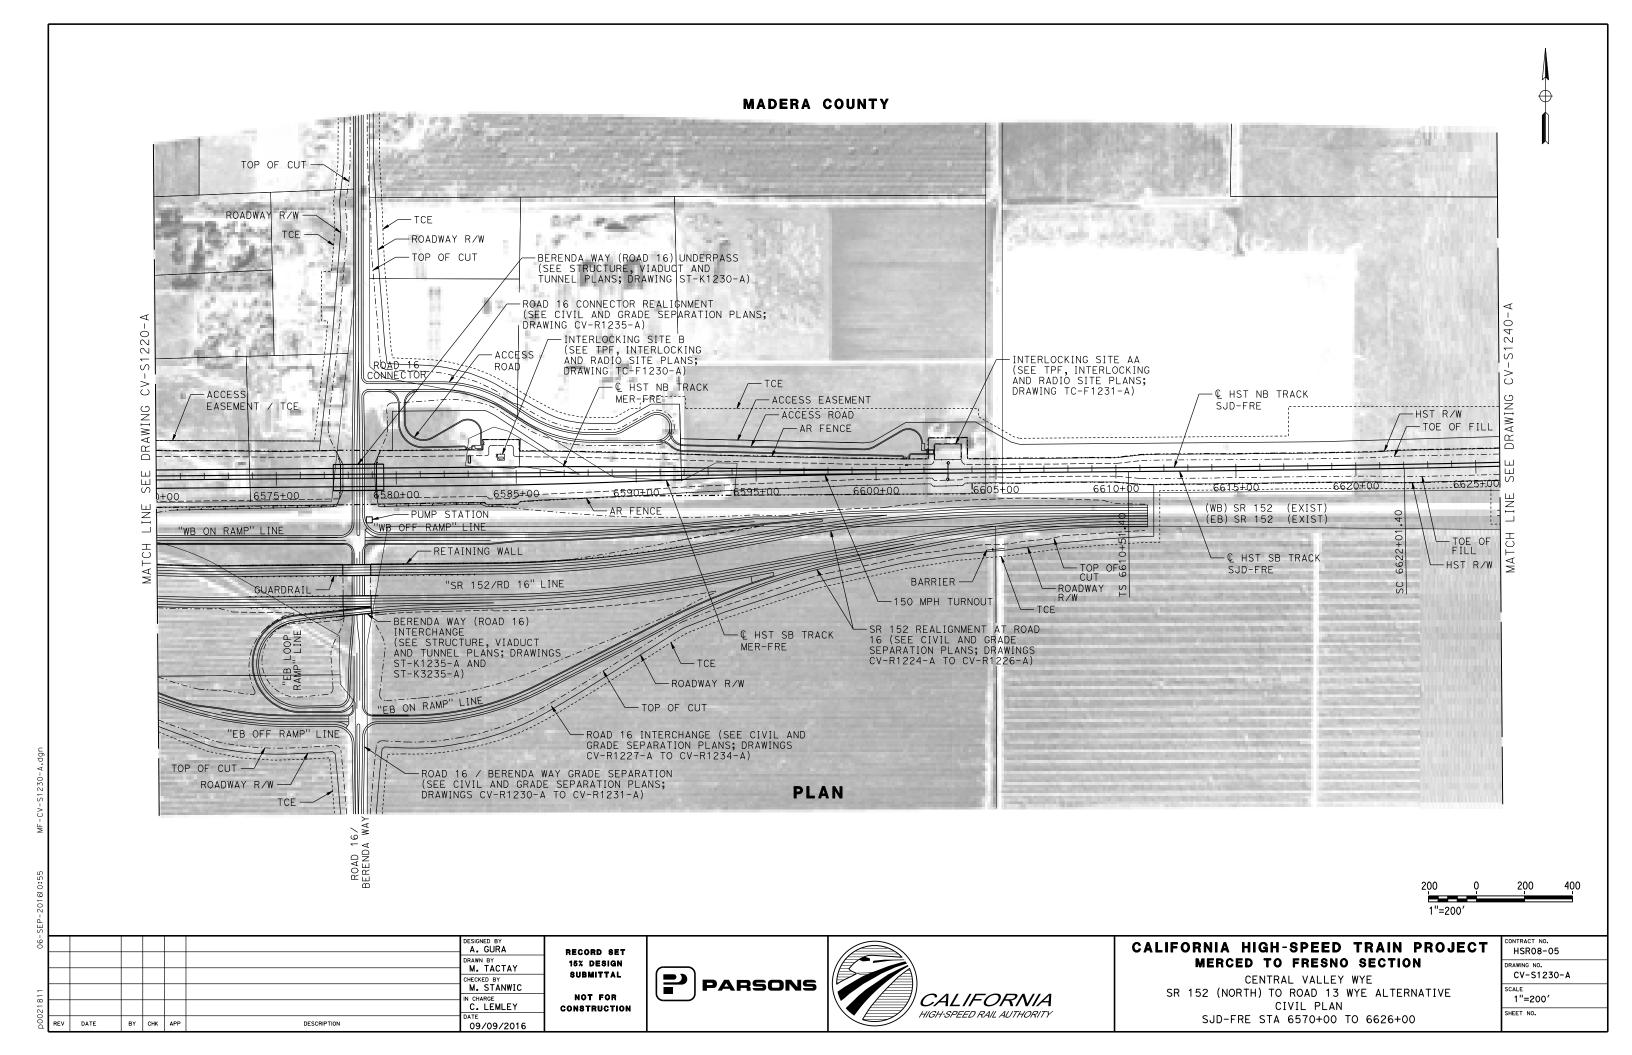

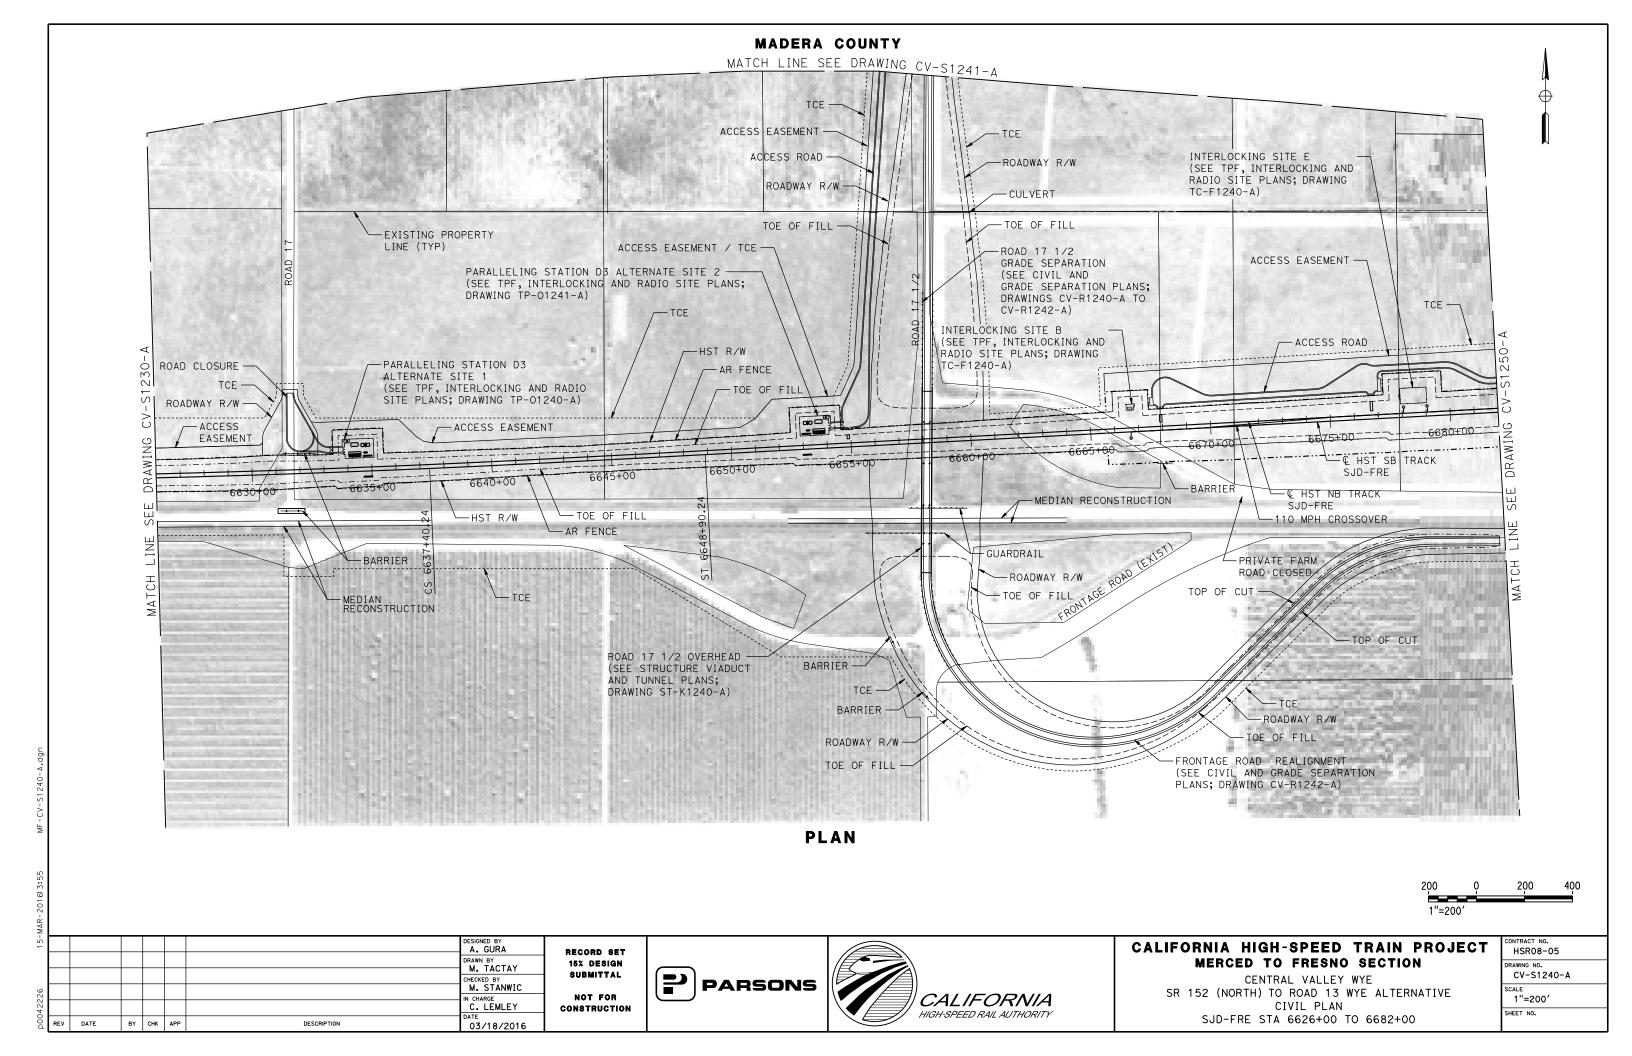

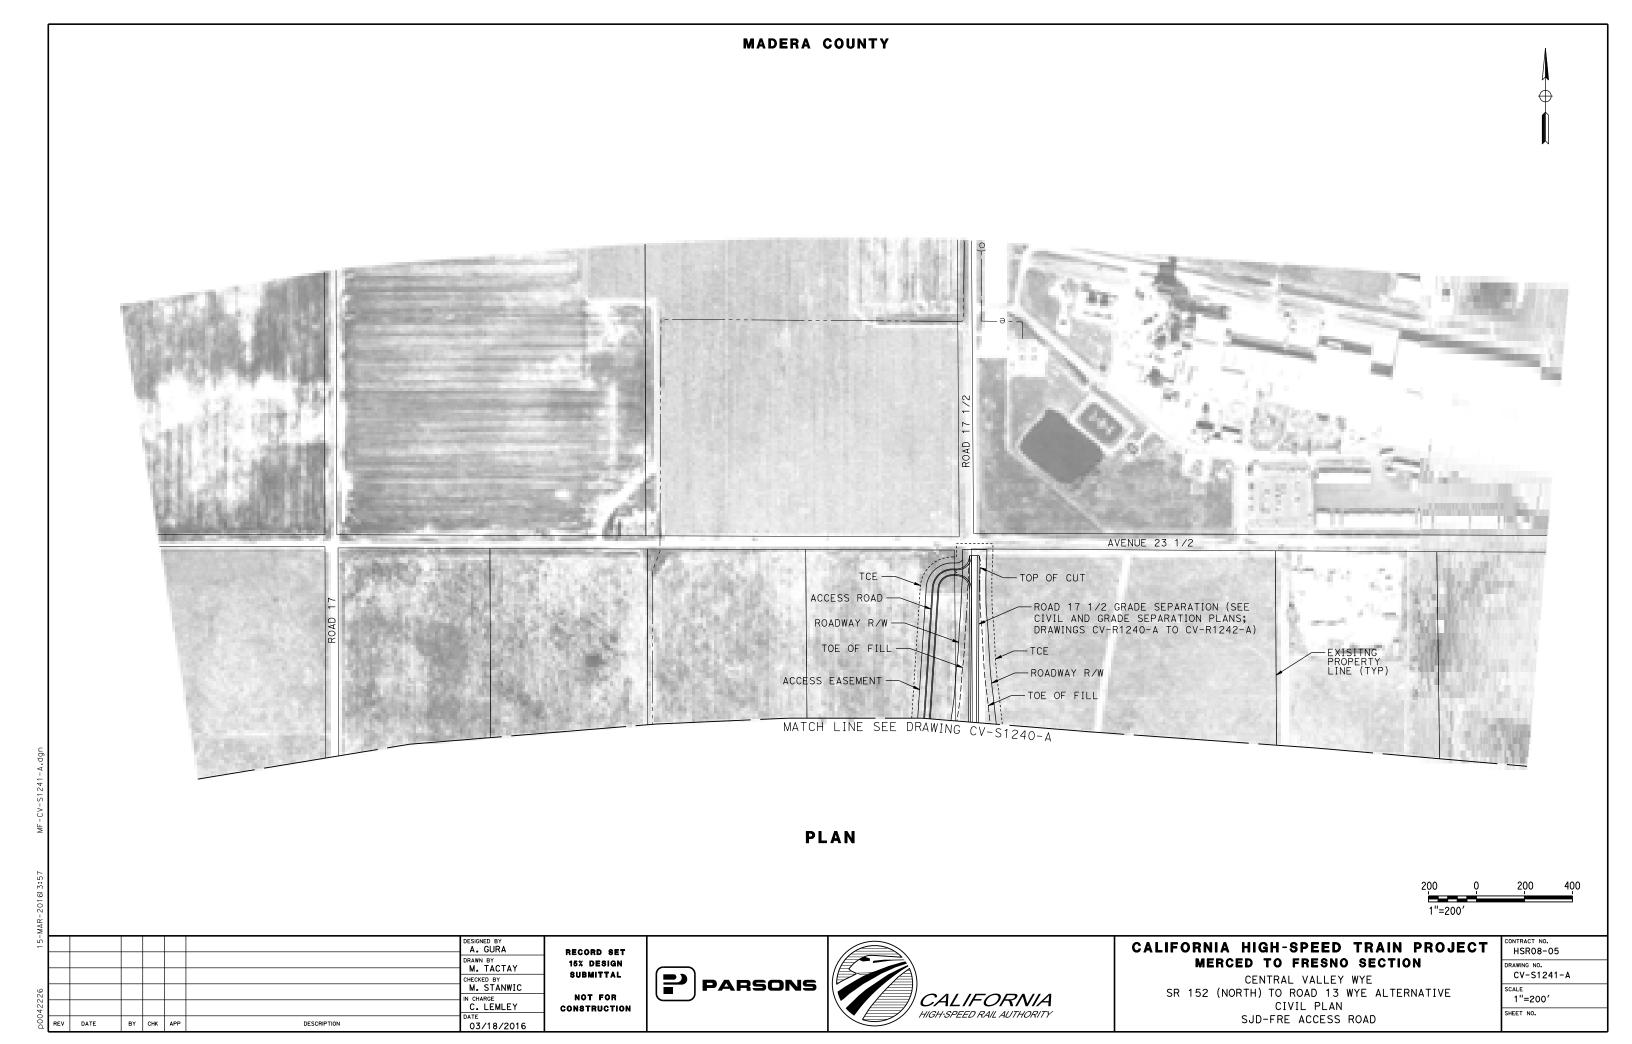

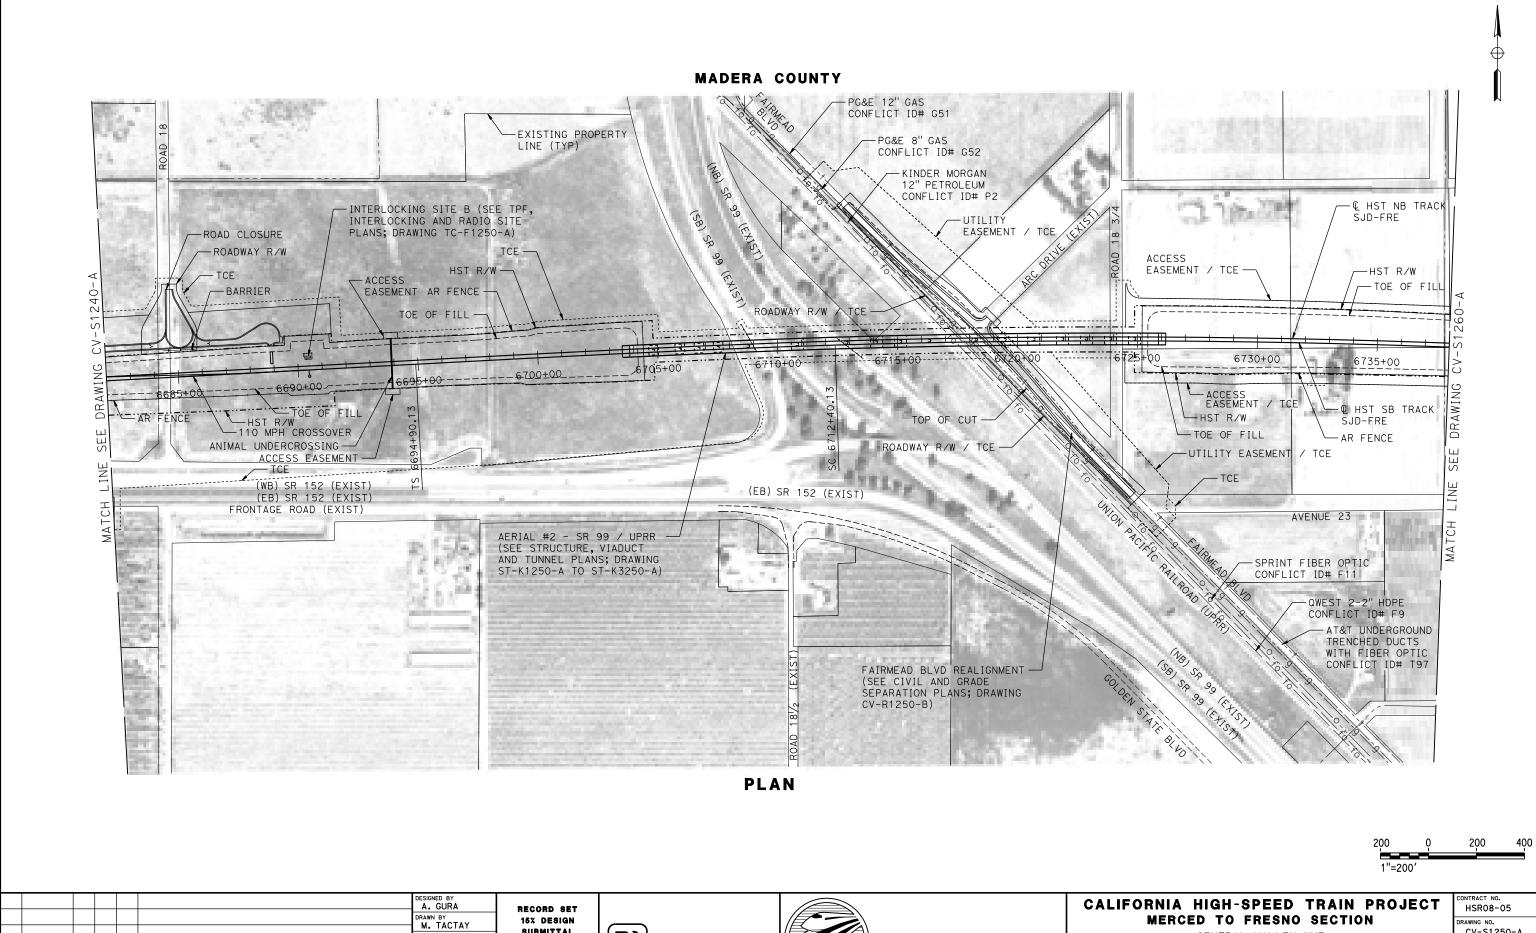


RECORD SET
15% DESIGN
SUBMITTAL
NOT FOR
CONSTRUCTION





CENTRAL VALLEY WYE
SR 152 (NORTH) TO ROAD 13 WYE ALTERNATIVE
CIVIL PLAN
SJD-FRE STA 6682+00 TO 6738+00

	CONTRACT NO. HSRO8-05
	DRAWING NO. CV-S1250-A
	1"=200'
	SHEET NO.

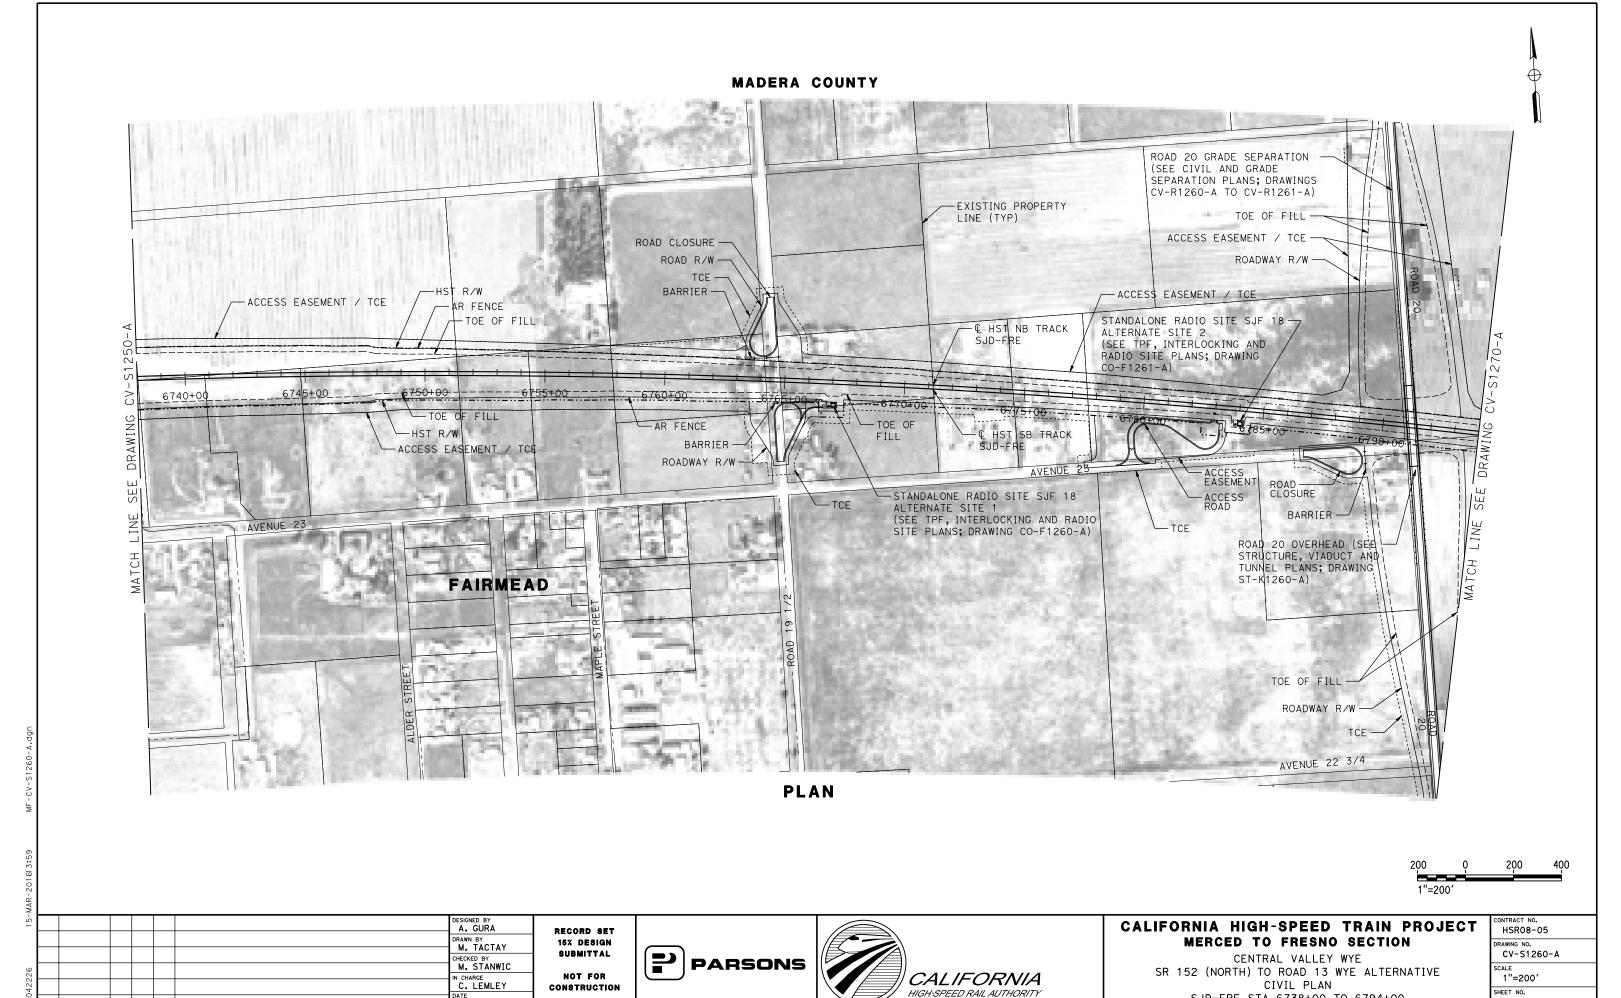


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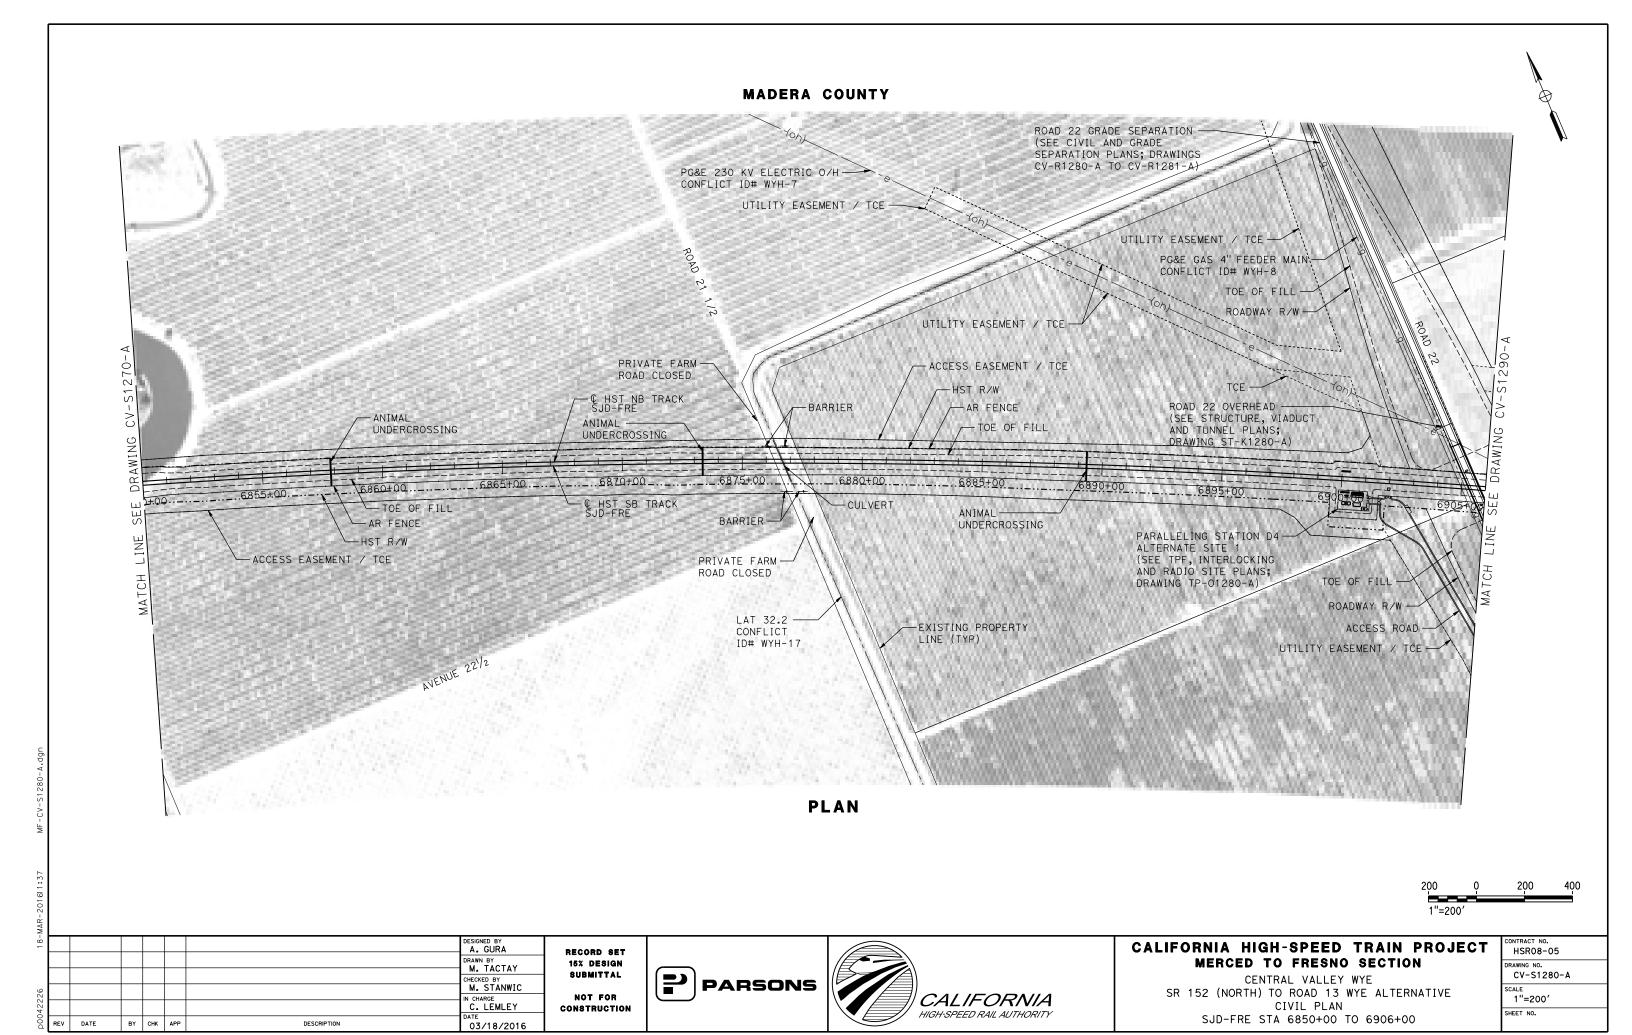
BY CHK APP


DESCRIPTION

03/18/2016

SJD-FRE STA 6738+00 TO 6794+00



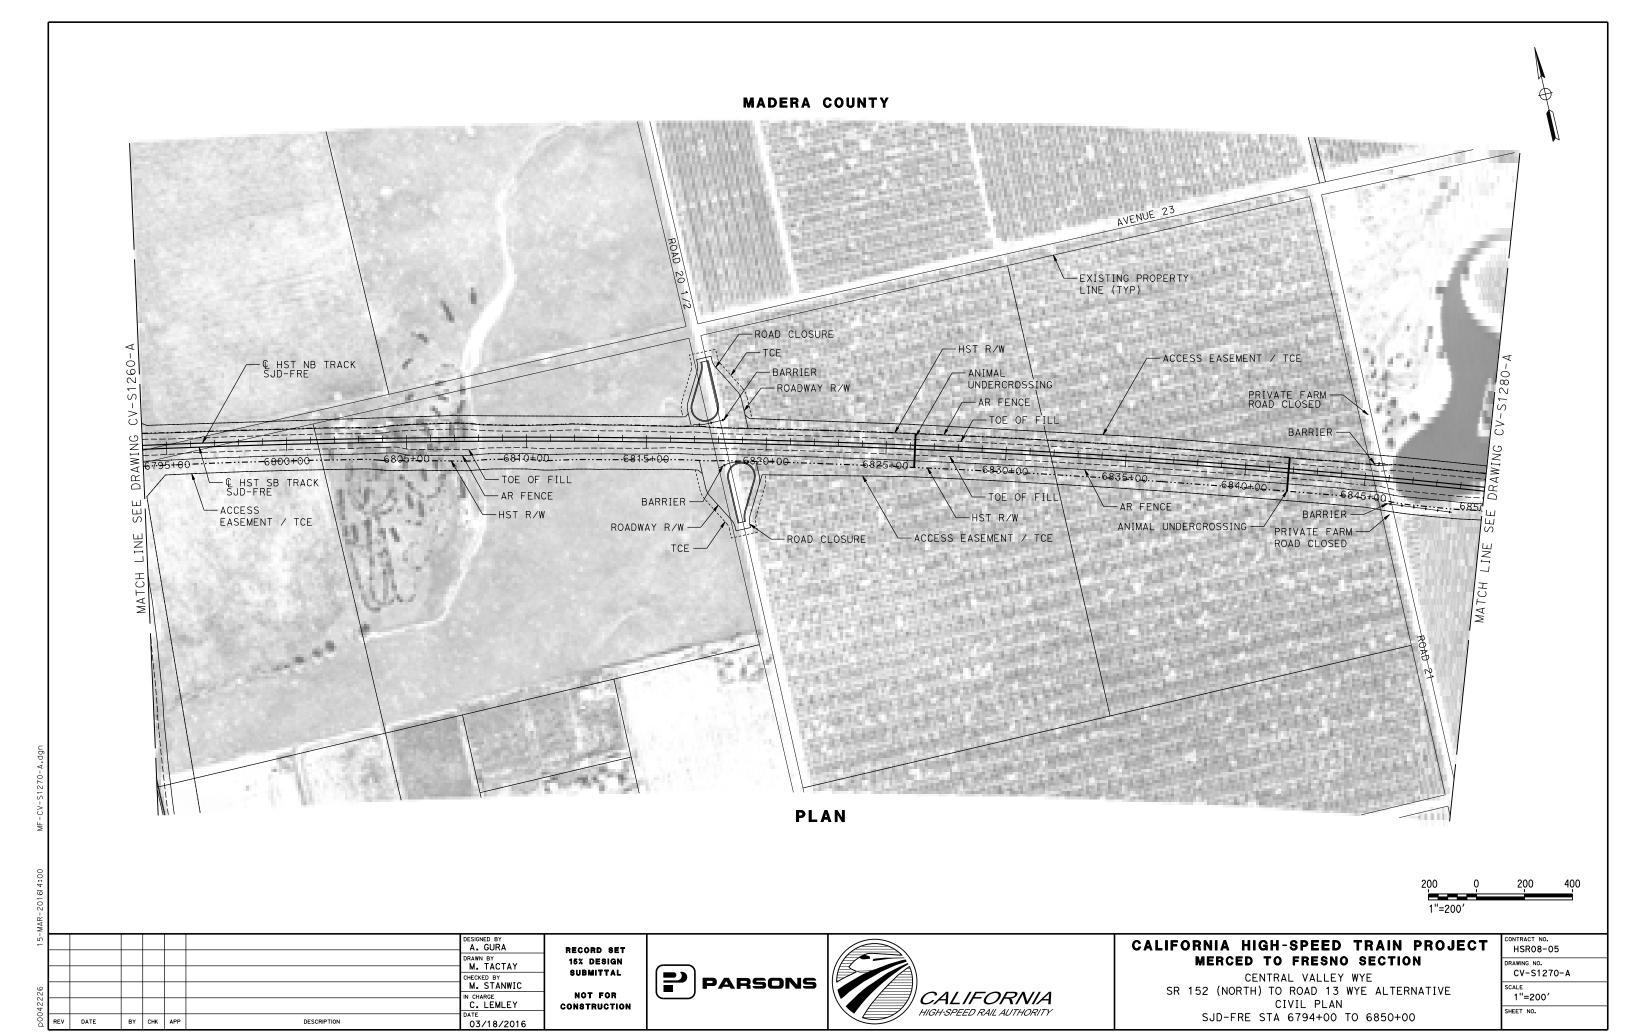

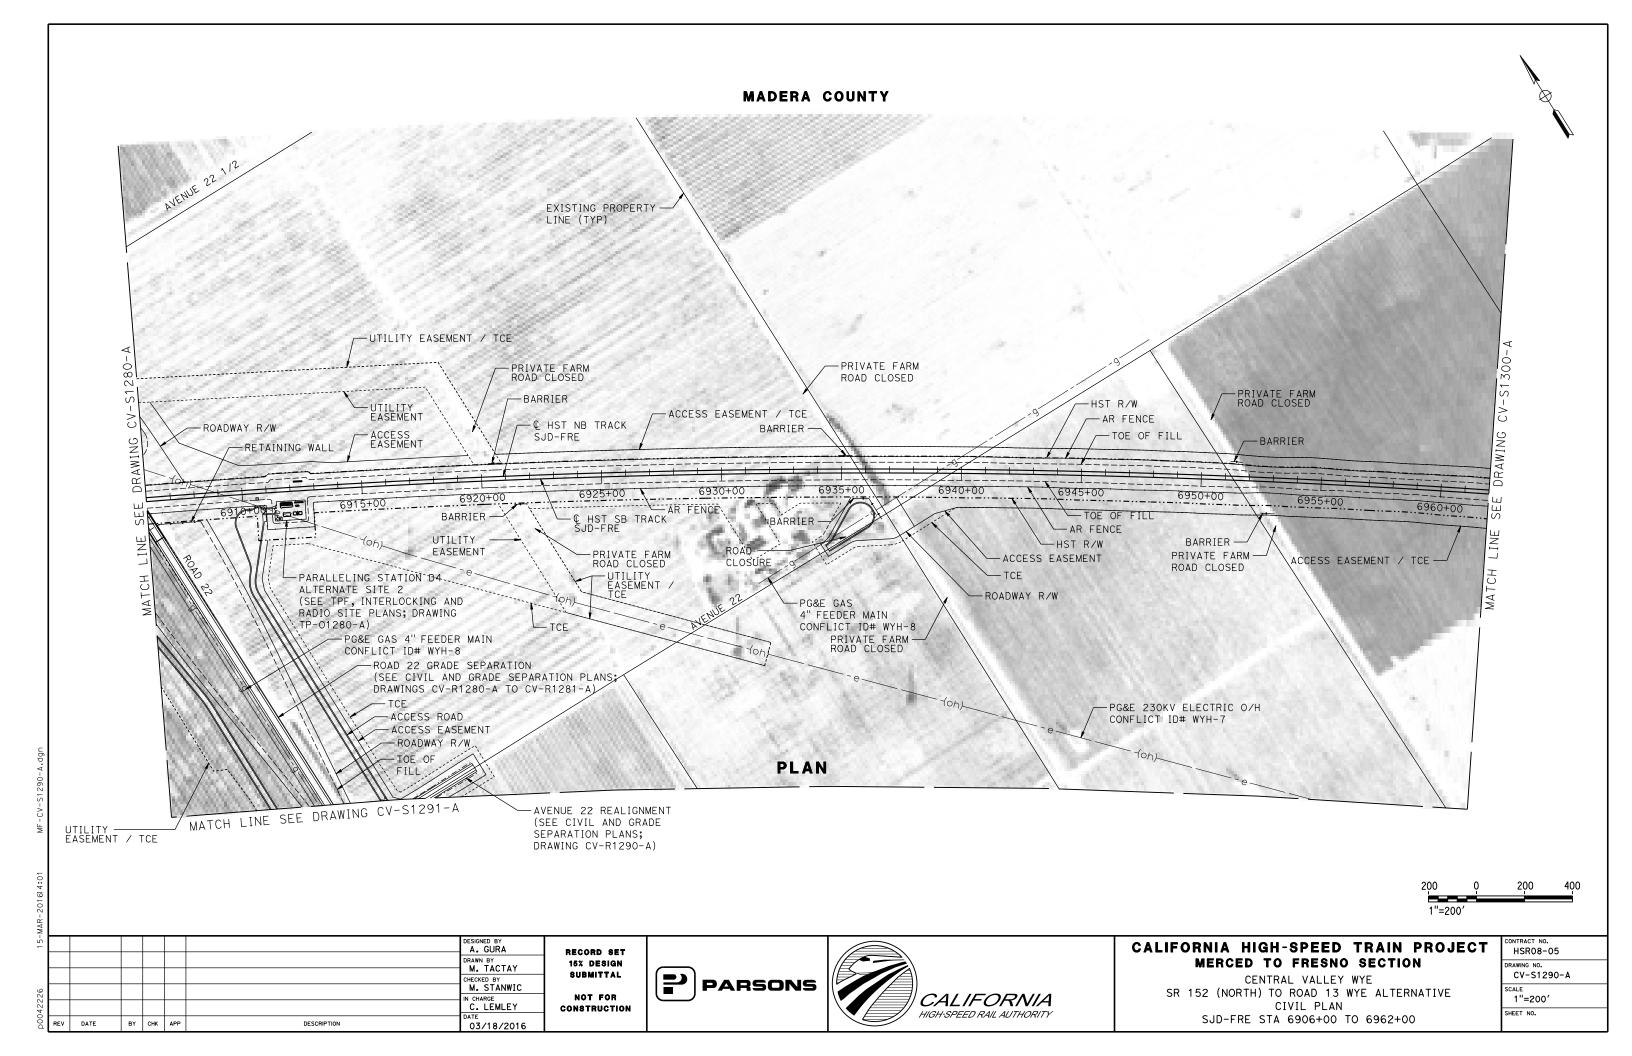

### MADERA COUNTY





200 0 200 400

1"=200'

						DESIGNED BY A. GURA	R
						DRAWN BY J. KIDWELL	1
						CHECKED BY M. STANWIC	
						IN CHARGE C. LEMLEY	co
REV	DATE	BY	СНК	APP	DESCRIPTION	DATE 03/18/2016	

RECORD SET
15% DESIGN
SUBMITTAL
NOT FOR
CONSTRUCTION







# CALIFORNIA HIGH-SPEED TRAIN PROJECT MERCED TO FRESNO SECTION

CENTRAL VALLEY WYE
SR 152 (NORTH) TO ROAD 13 WYE ALTERNATIVE
CIVIL PLAN
SJD-FRE ACCESS ROAD

CONTRACT NO.
HSR08-05
DRAWING NO.
CV-S1291-A
SCALE
1"=200'
SHEET NO.

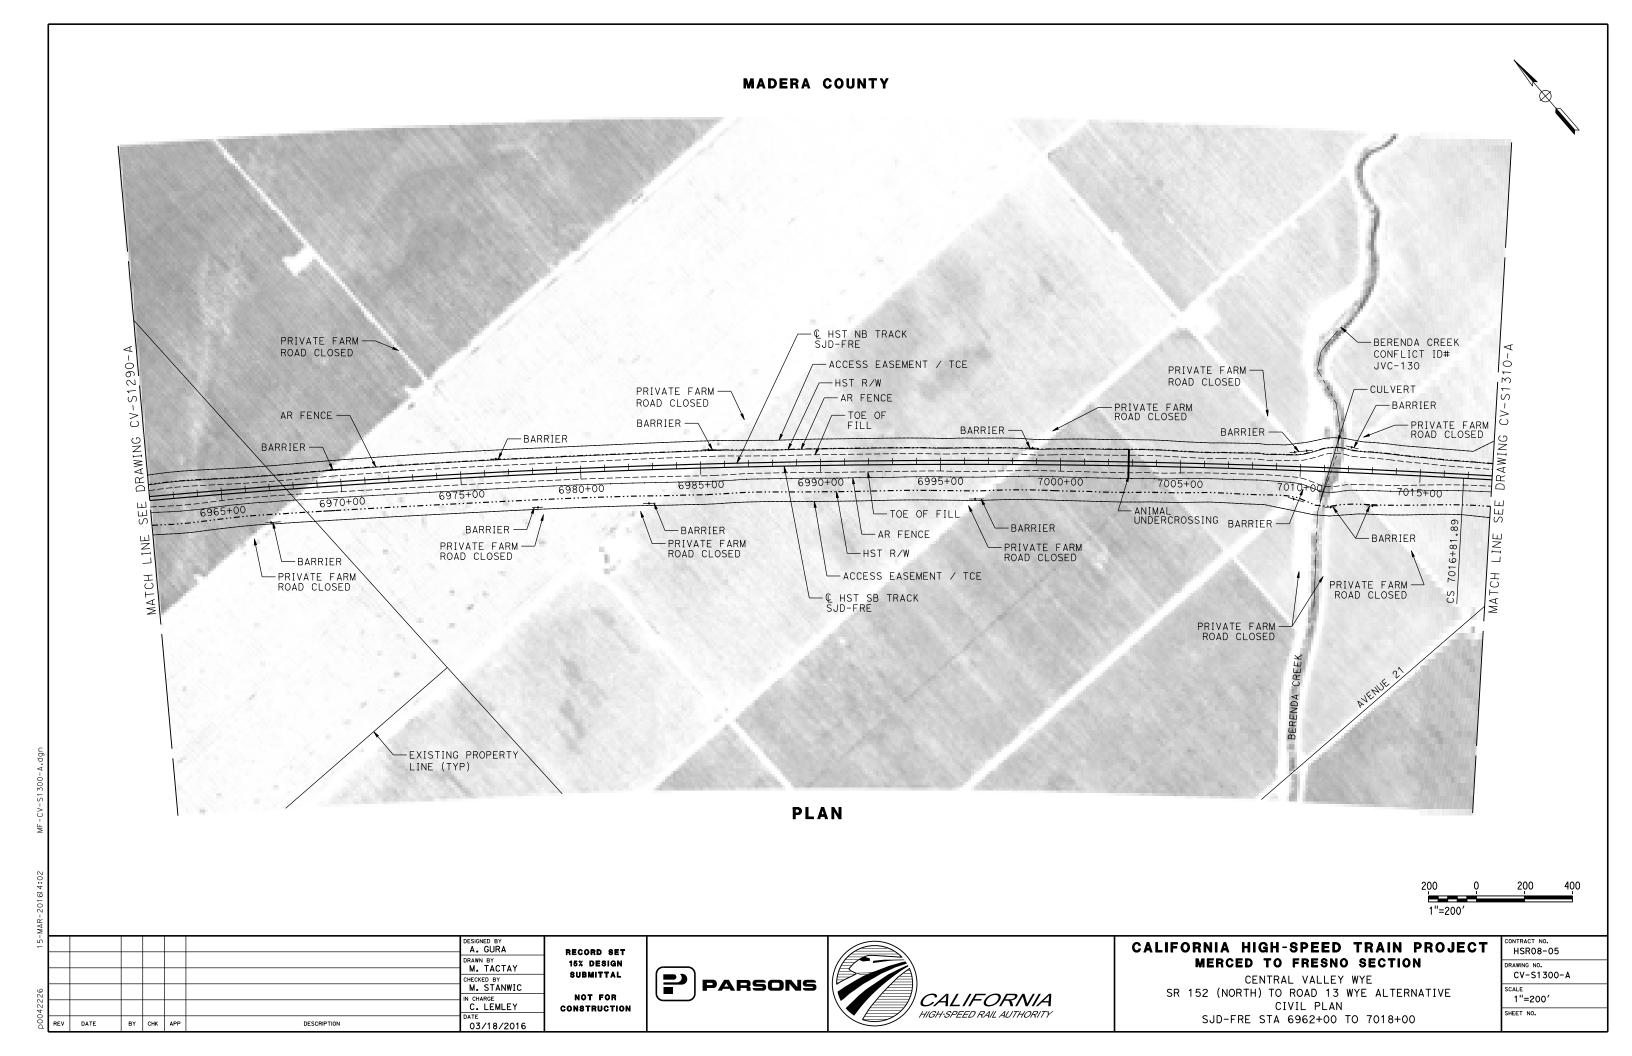

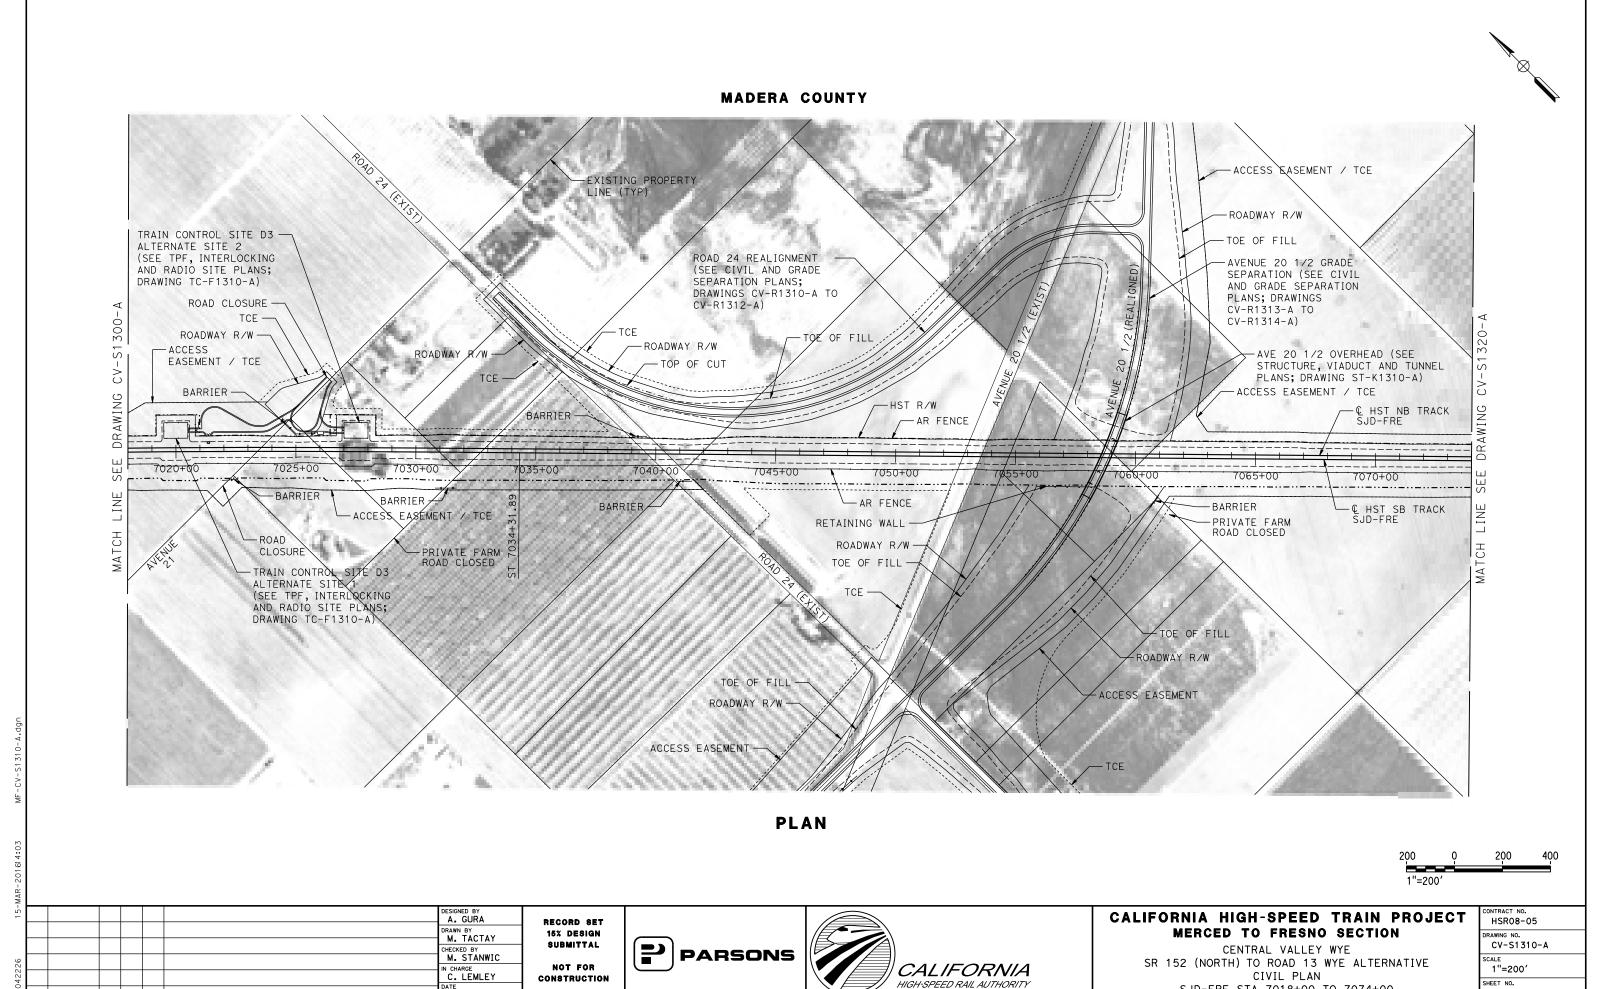


BY CHK APP

DESCRIPTION

03/18/2016


SJD-FRE STA 7018+00 TO 7074+00

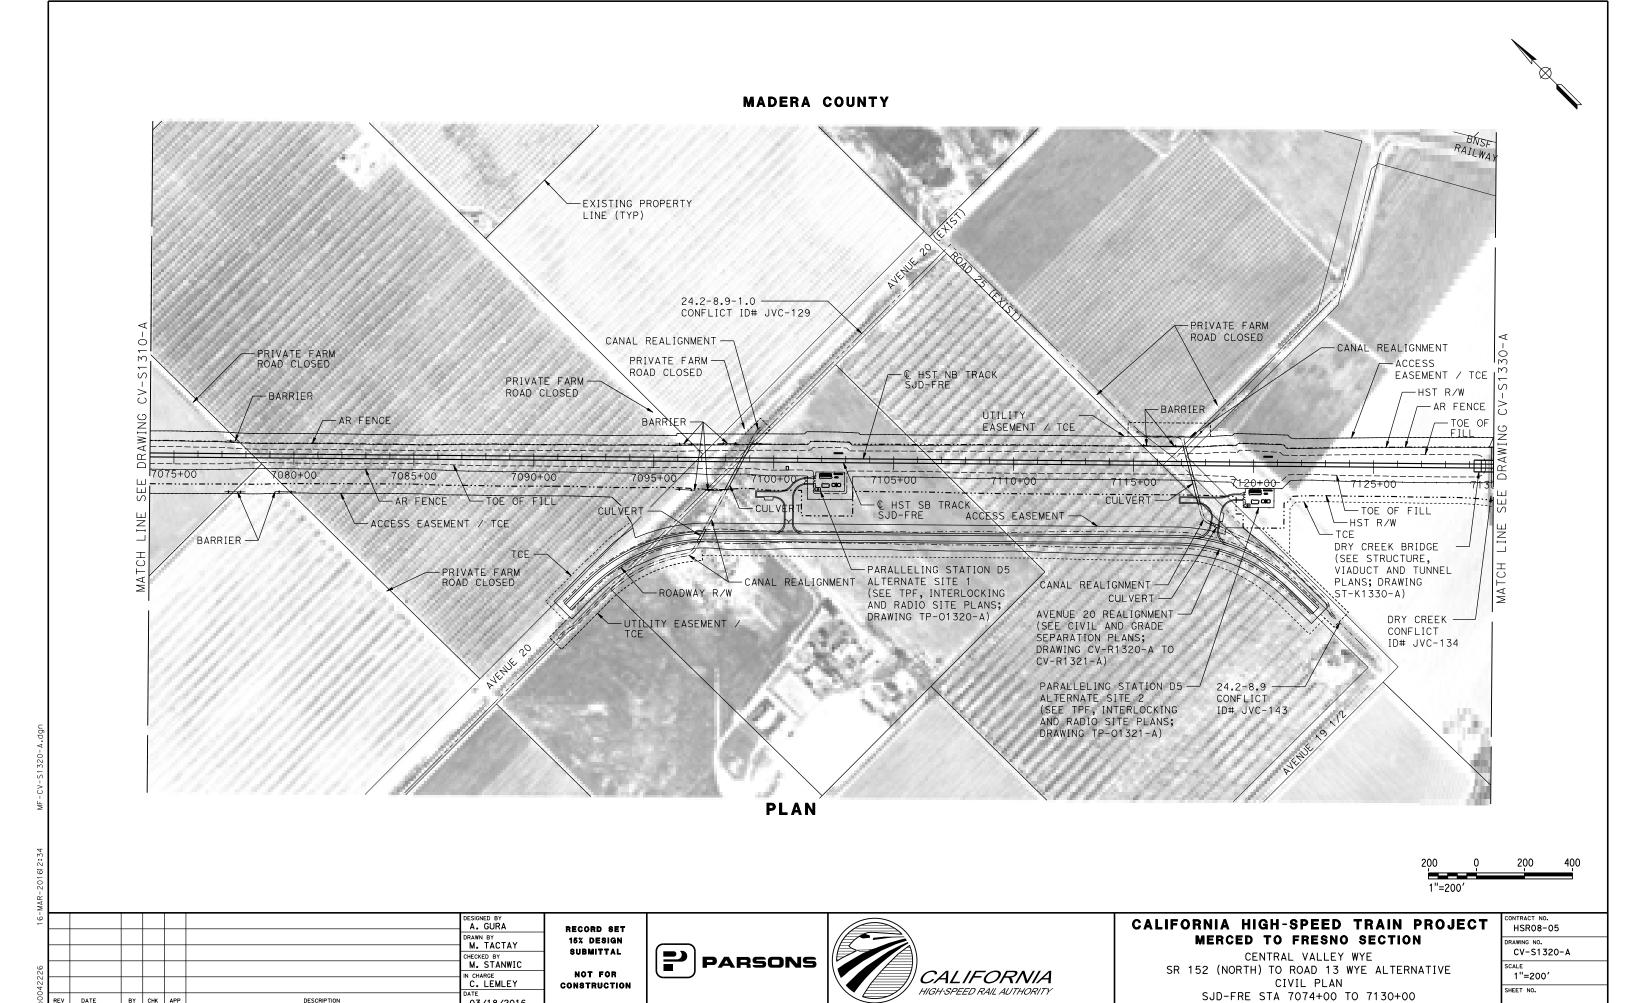

BY CHK APP

DESCRIPTION

03/18/2016

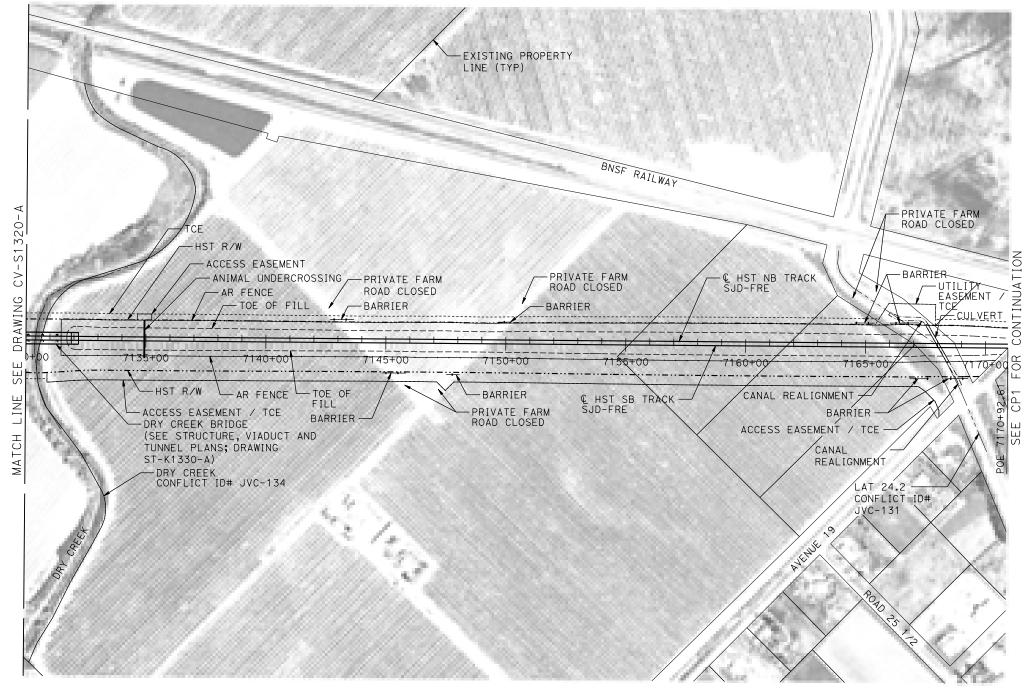

PLAN

200	Q	200	400
1"=20	0′		

➣								
15-							DESIGNED BY A. GURA	RE
							DRAWN BY M. TACTAY	15
							CHECKED BY	SI
56							M. STANWIC	N
422							C. LEMLEY	CON
р00 ₂	REV	DATE	BY	СНК	APP	DESCRIPTION	DATE 03/18/2016	

RECORD SET
15% DESIGN
SUBMITTAL
NOT FOR
DNSTRUCTION








# CALIFORNIA HIGH-SPEED TRAIN PROJECT MERCED TO FRESNO SECTION


CENTRAL VALLEY WYE
SR 152 (NORTH) TO ROAD 13 WYE ALTERNATIVE
CIVIL PLAN
SJD-FRE STA 7130+00 TO 7170+92.61


CONTRACT NO. HSR08-05
DRAWING NO. CV-S1330-A
SCALE 1"=200'
SHEET NO.

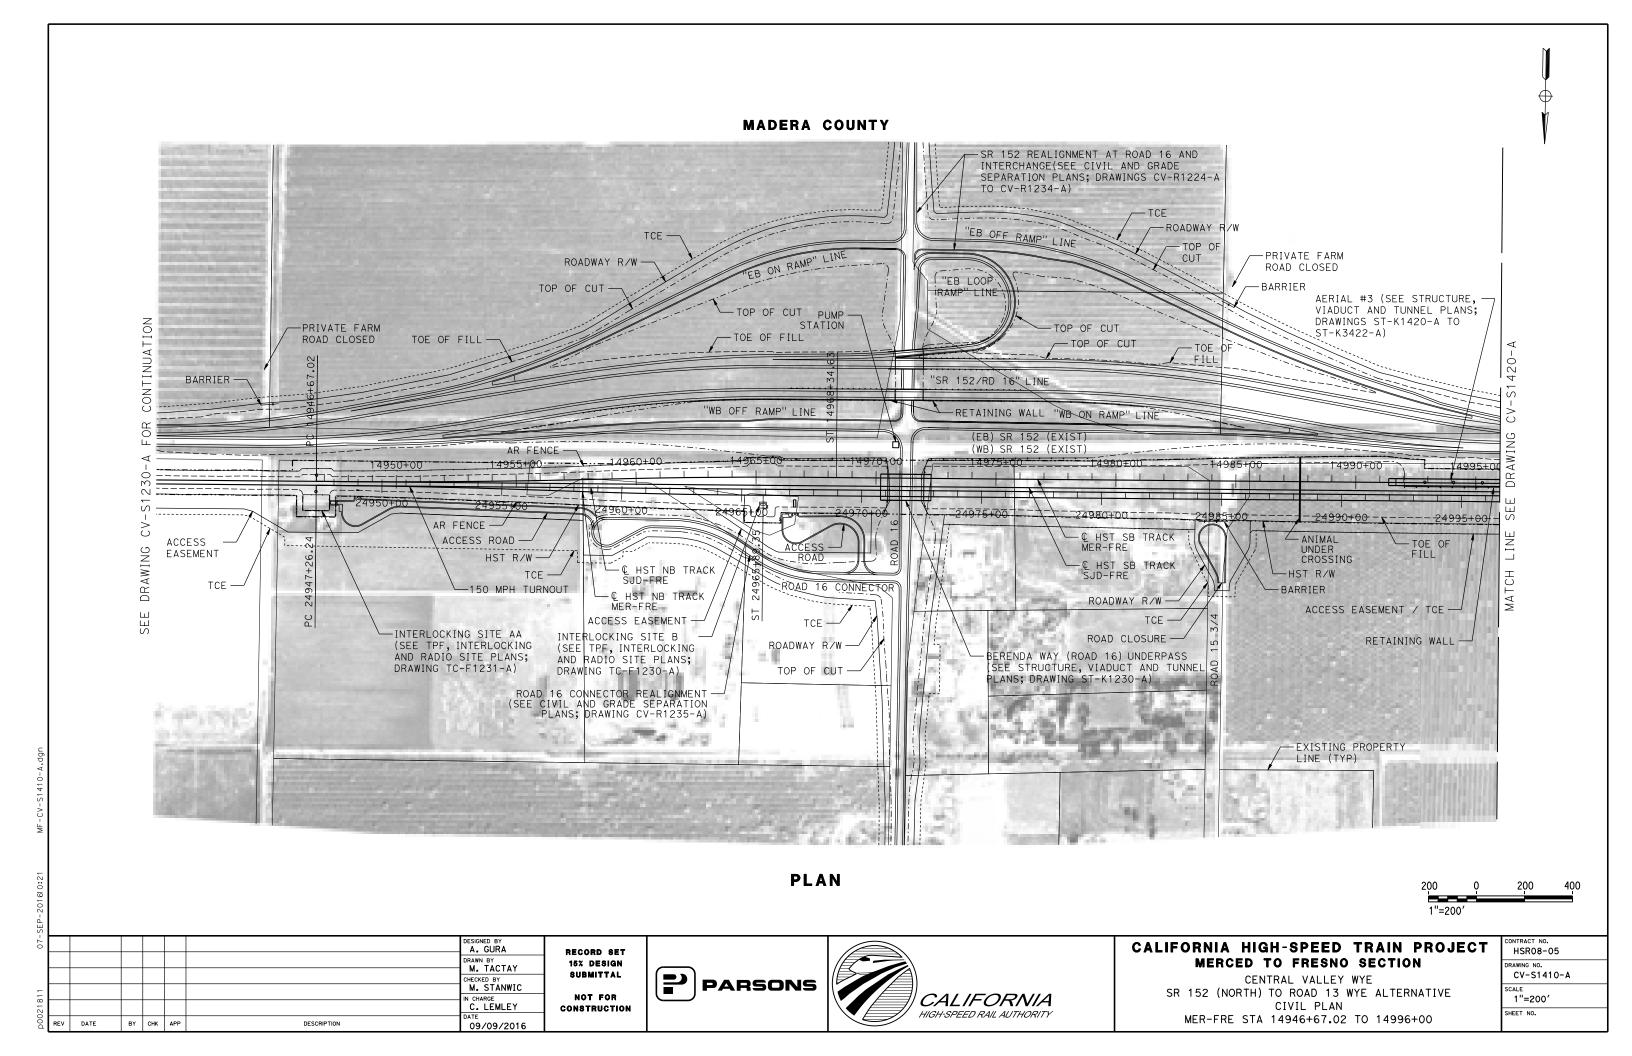

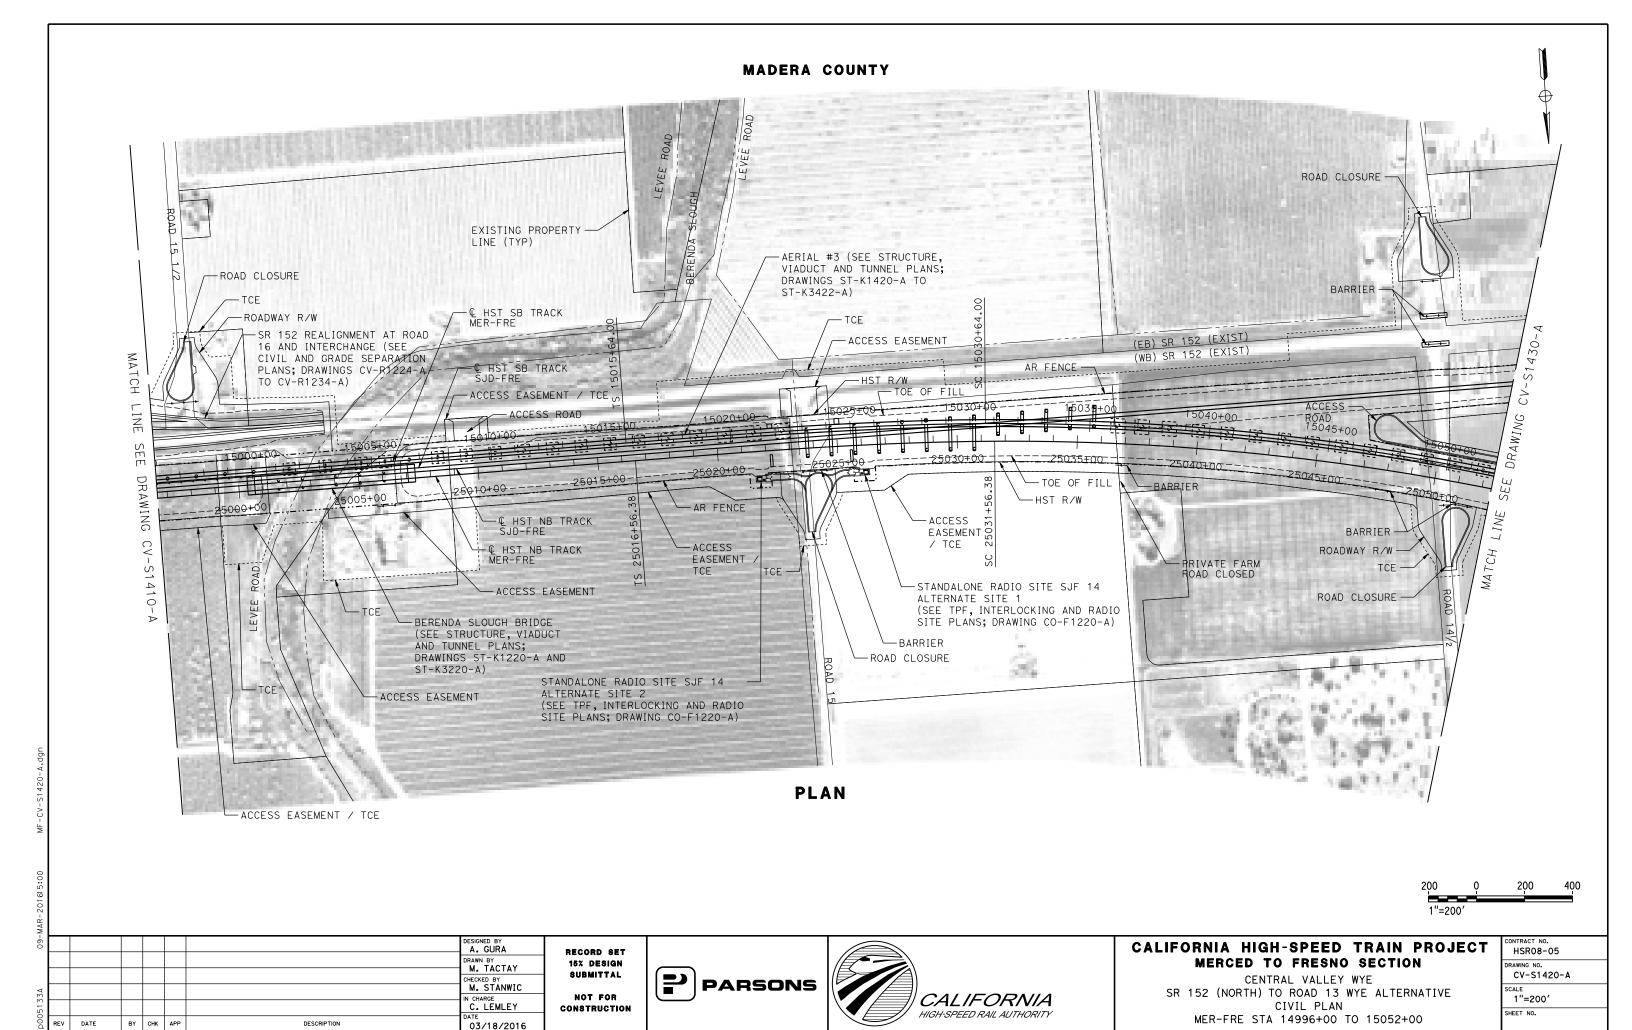

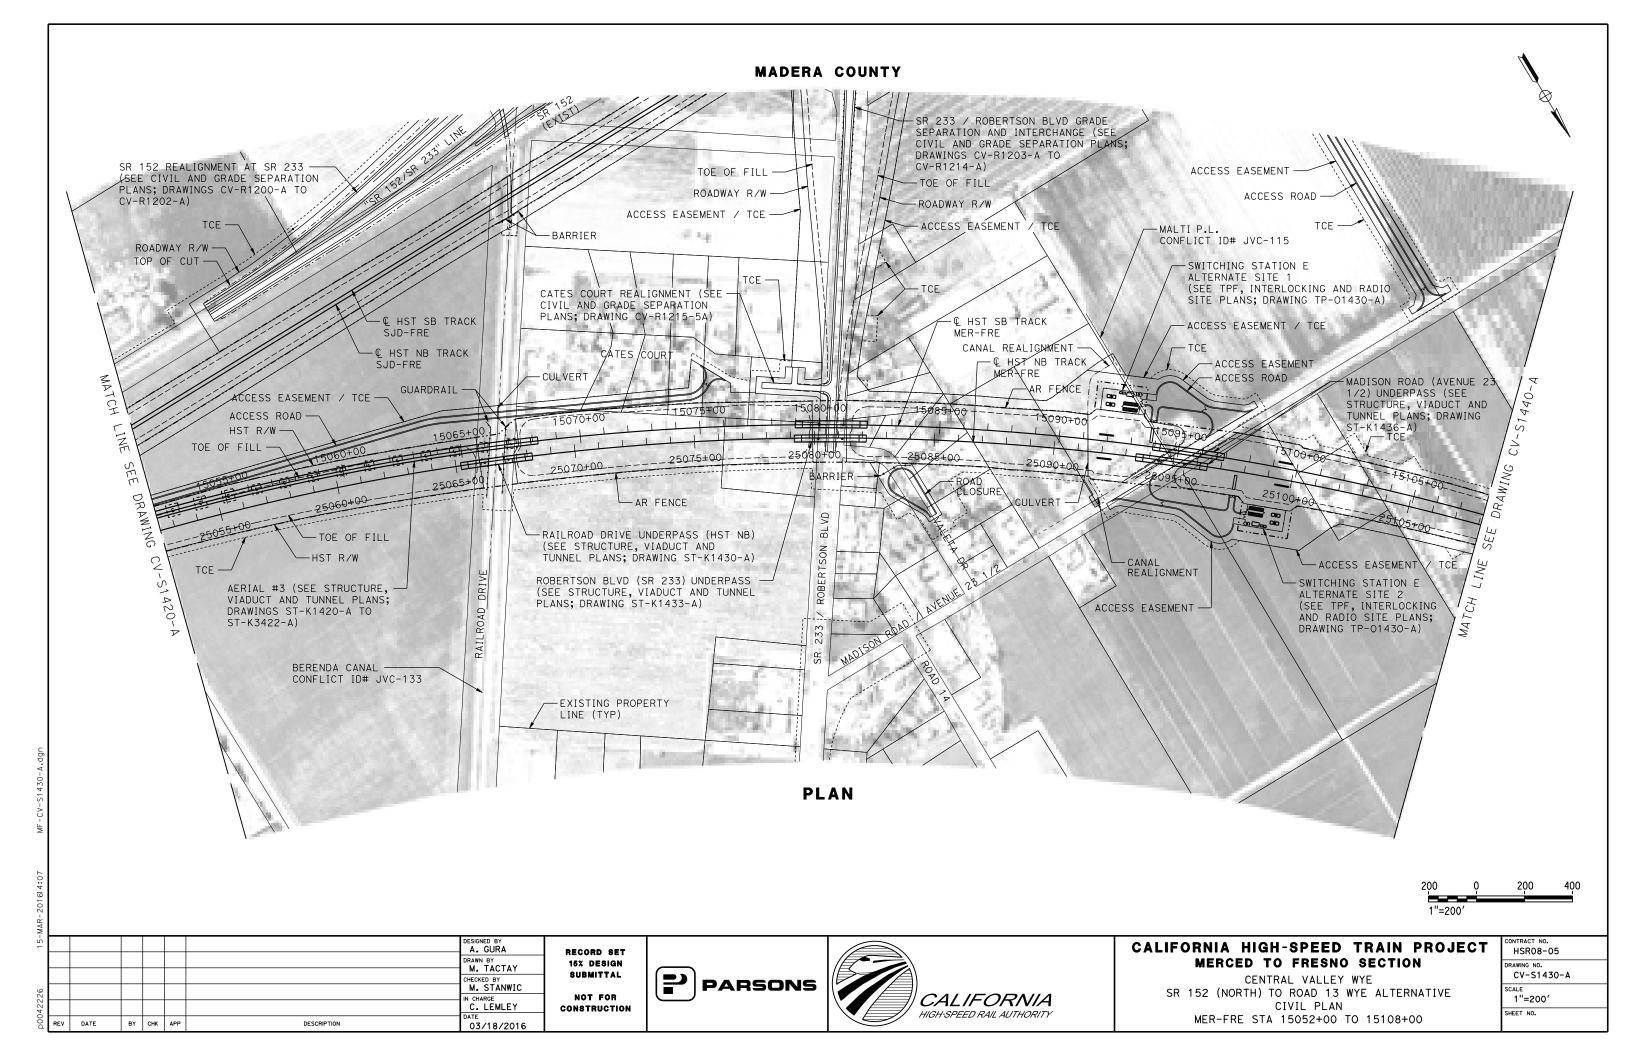

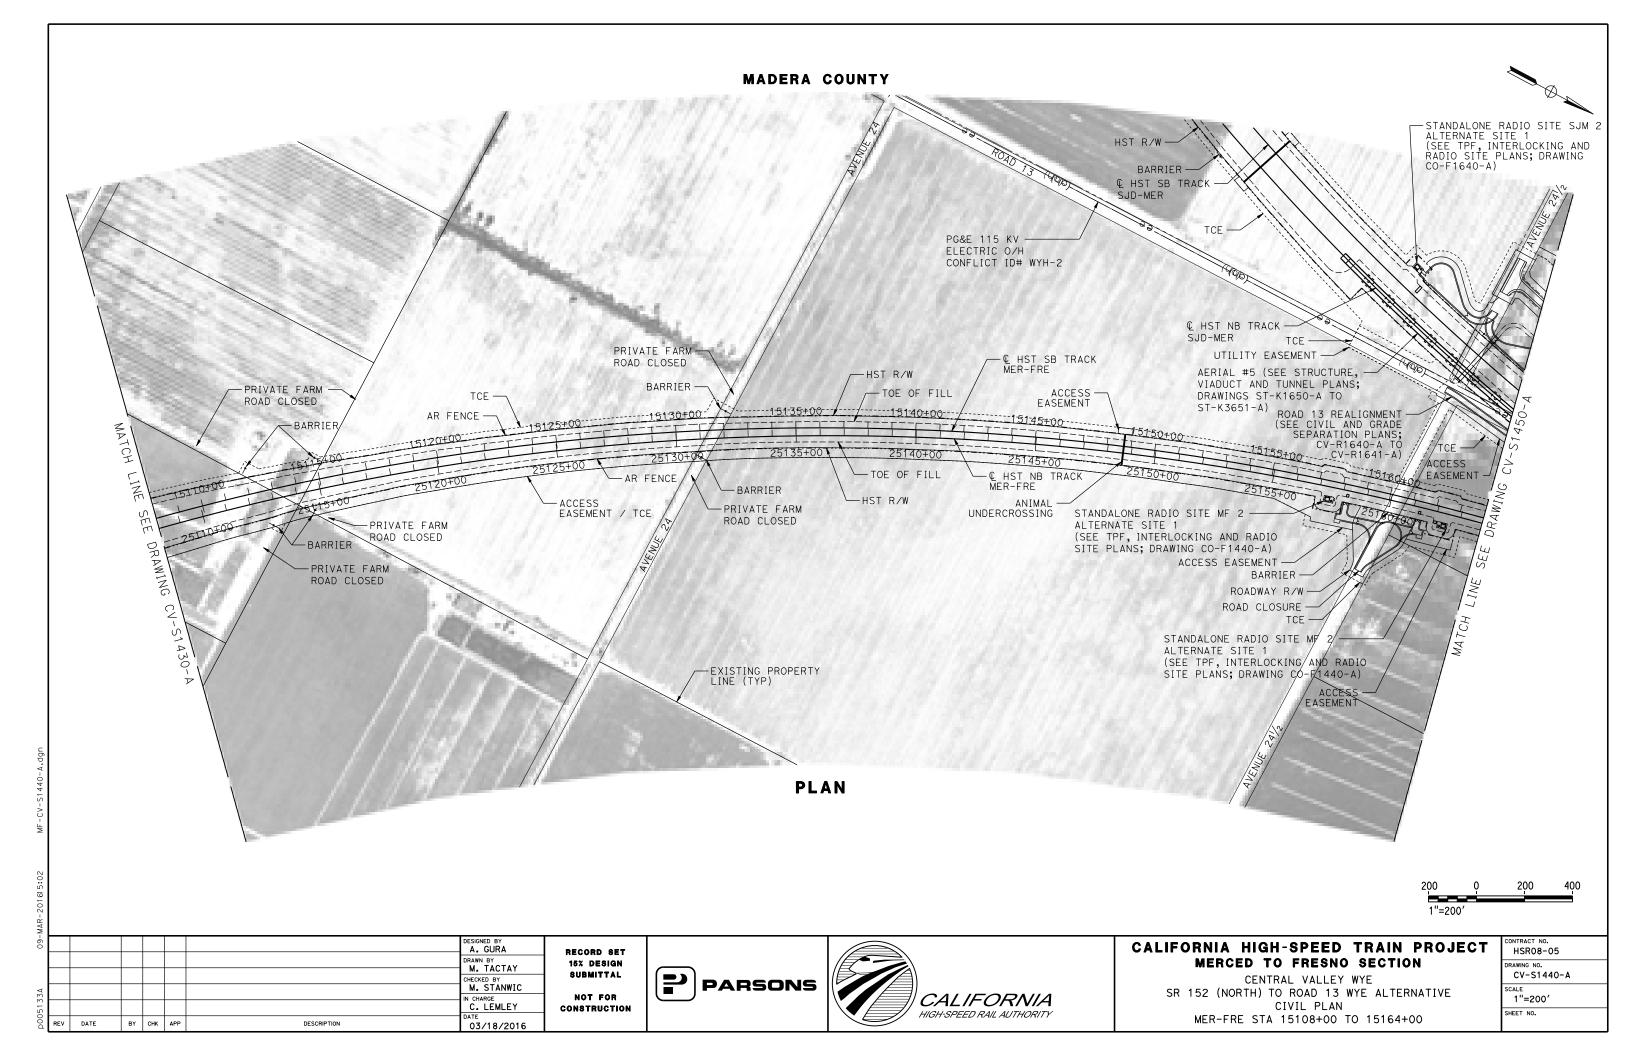

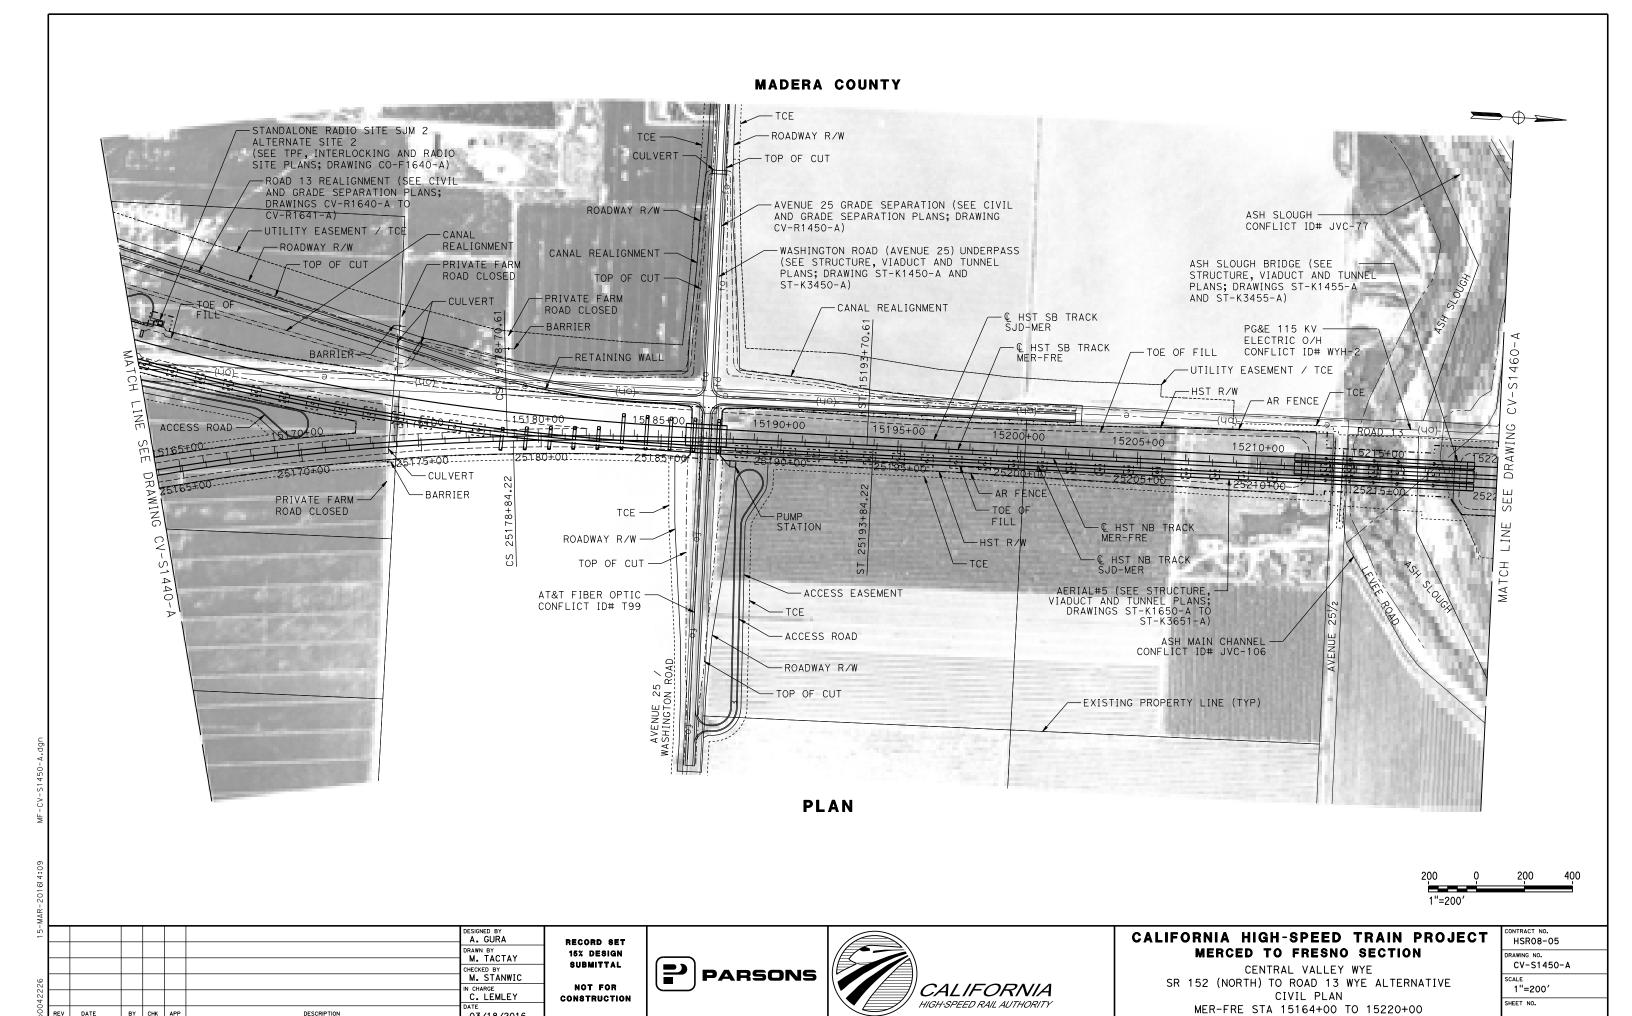


DATE

BY CHK APP

DESCRIPTION

03/18/2016



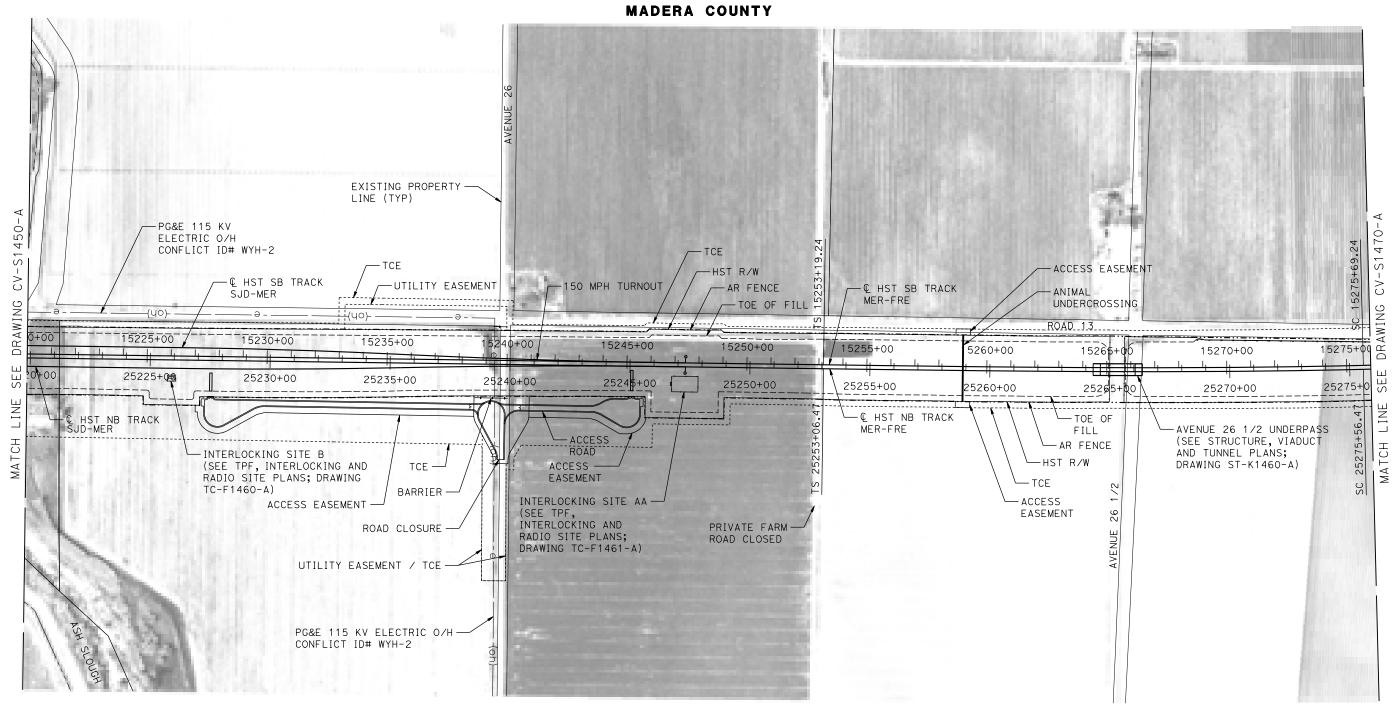

PLAN



16-M							DESIGNED BY A. GURA	
							DRAWN BY M. TACTAY	15
9							CHECKED BY M. STANWIC	∱ Sι
42226							IN CHARGE C. LEMLEY	CON
D00	REV	DATE	BY	снк	APP	DESCRIPTION	03/18/2016	

RECORD SET
15% DESIGN
SUBMITTAL
NOT FOR
CONSTRUCTION






# CALIFORNIA HIGH-SPEED TRAIN PROJECT MERCED TO FRESNO SECTION

CENTRAL VALLEY WYE
SR 152 (NORTH) TO ROAD 13 WYE ALTERNATIVE
CIVIL PLAN
MER-FRE STA 15220+00 TO 15276+00

CONTRACT NO. HSRO8-05
DRAWING NO. CV-S1460-A
SCALE 1"=200'
SHEET NO.
<u> </u>



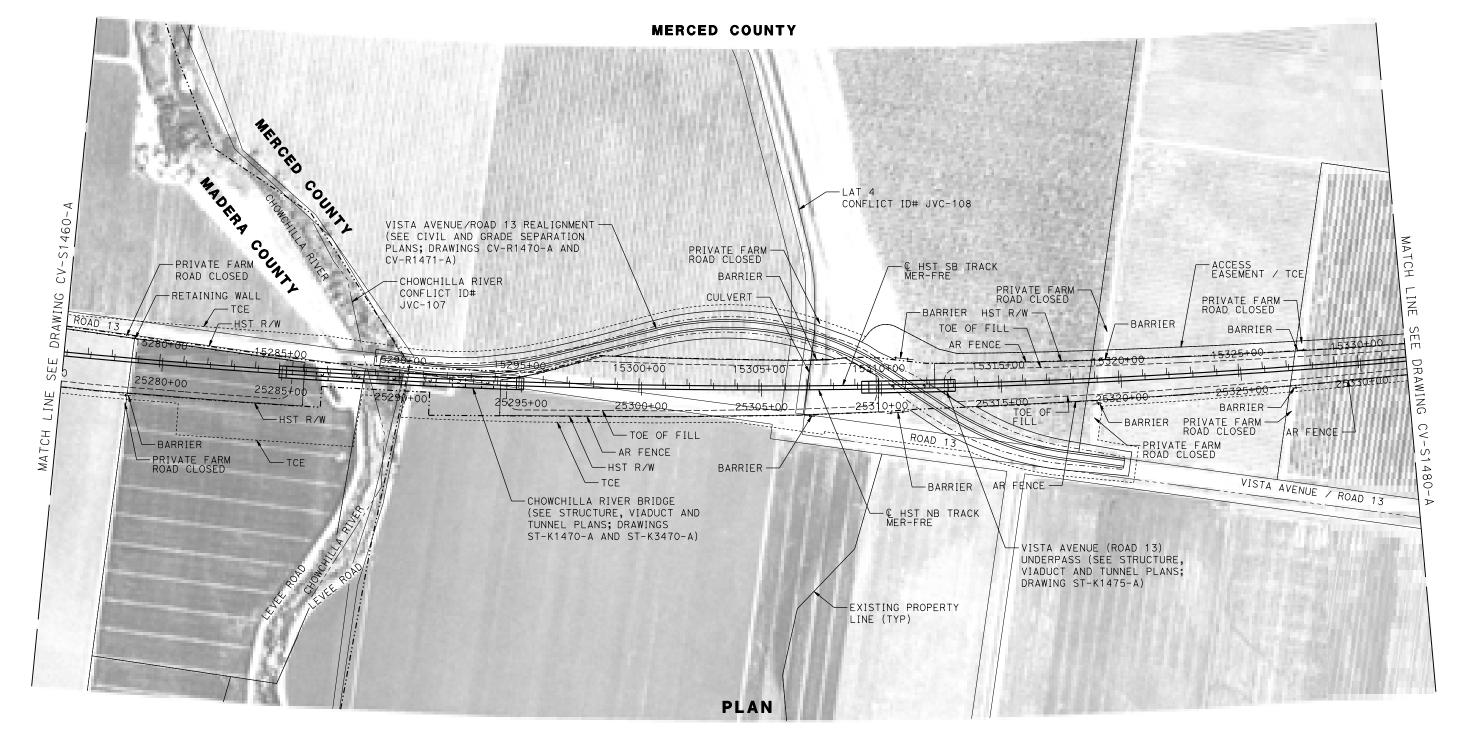

200	Q	200	400
1"=20	0′		

-								
16-							DESIGNED BY A. GURA	١,
							DRAWN BY M. TACTAY	Ι.
							CHECKED BY	l
56							M. STANWIC IN CHARGE	l
422							C. LEMLEY	c
D00	REV	DATE	BY	СНК	APP	DESCRIPTION	03/18/2016	

RECORD SET
15% DESIGN
SUBMITTAL
NOT FOR
CONSTRUCTION








# CALIFORNIA HIGH-SPEED TRAIN PROJECT MERCED TO FRESNO SECTION


CENTRAL VALLEY WYE
SR 152 (NORTH) TO ROAD 13 WYE ALTERNATIVE
CIVIL PLAN
MER-FRE STA 15276+00 TO 15332+00


CONTRACT NO. HSR08-05
DRAWING NO. CV-S1470-A
SCALE 1"=200'
SHEET NO.

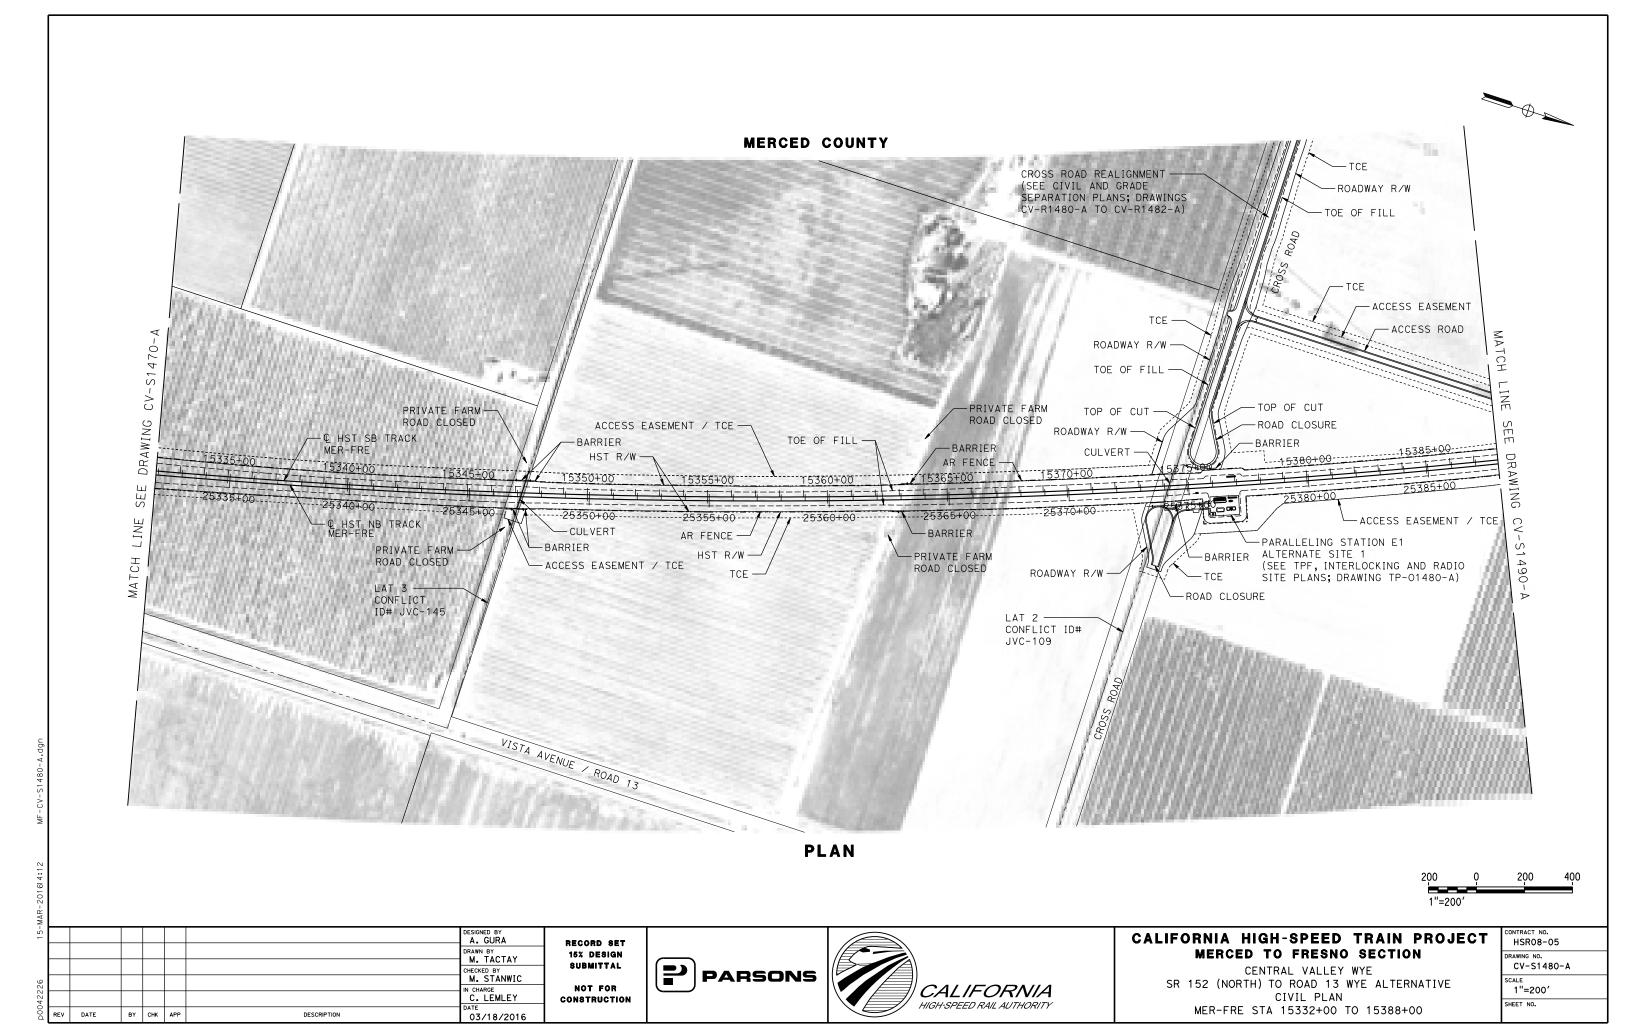

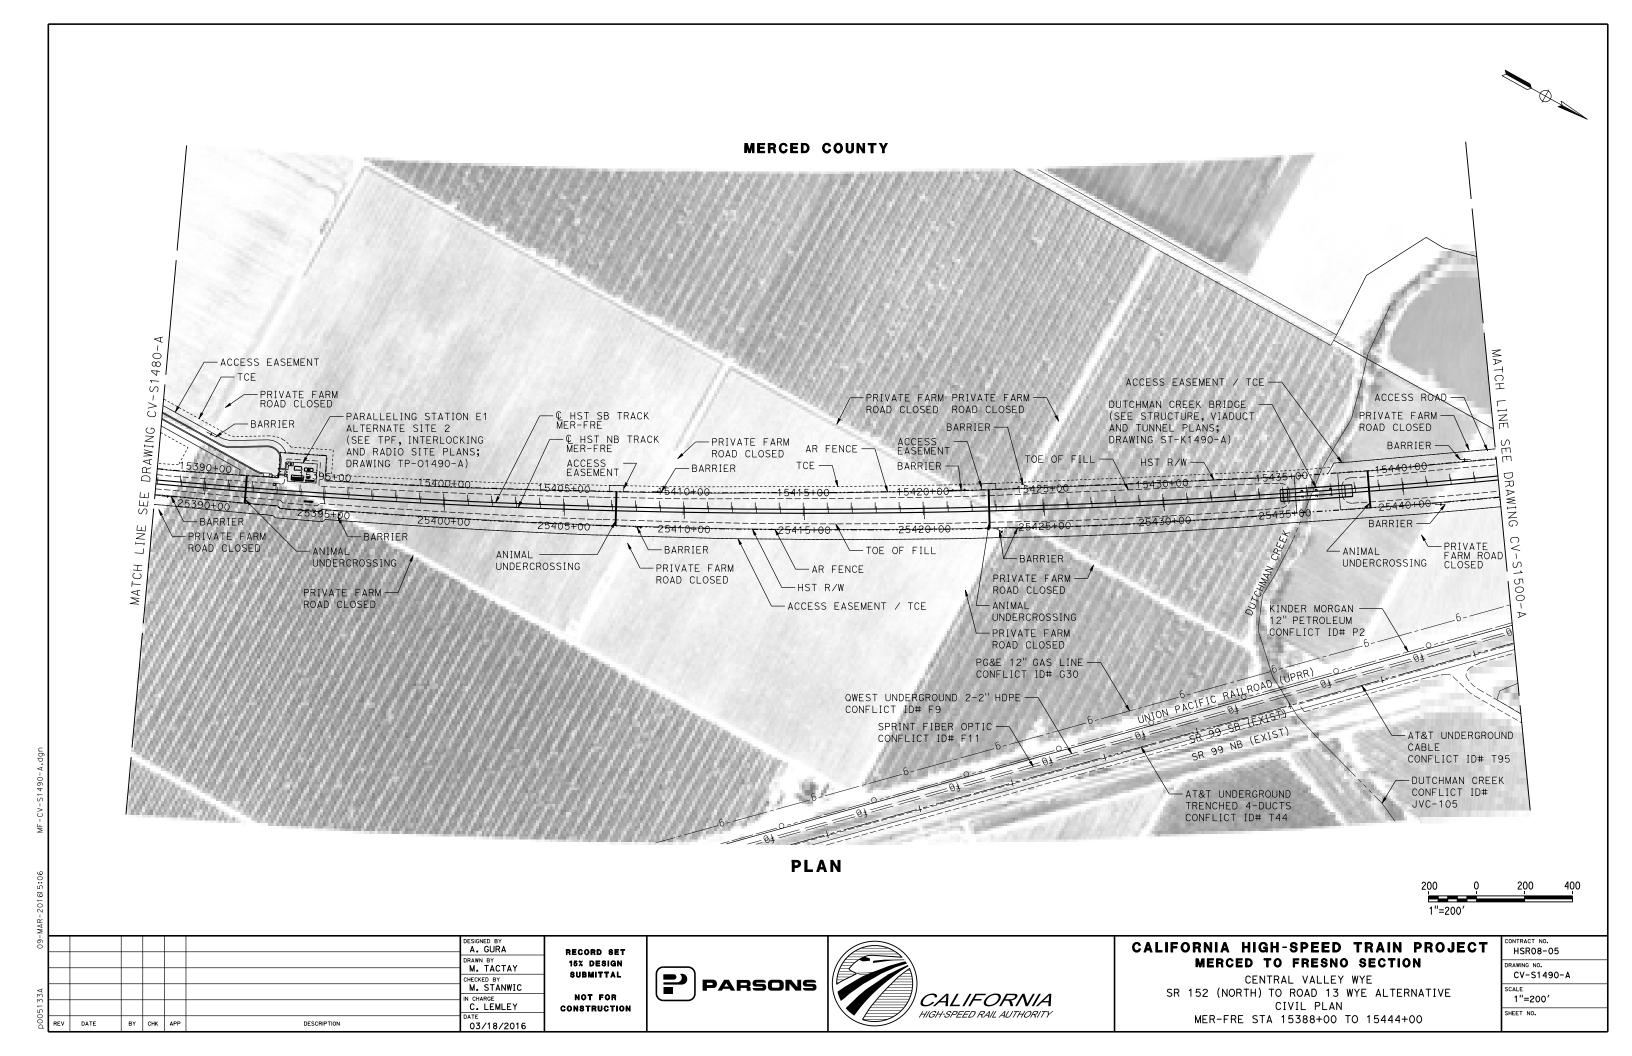

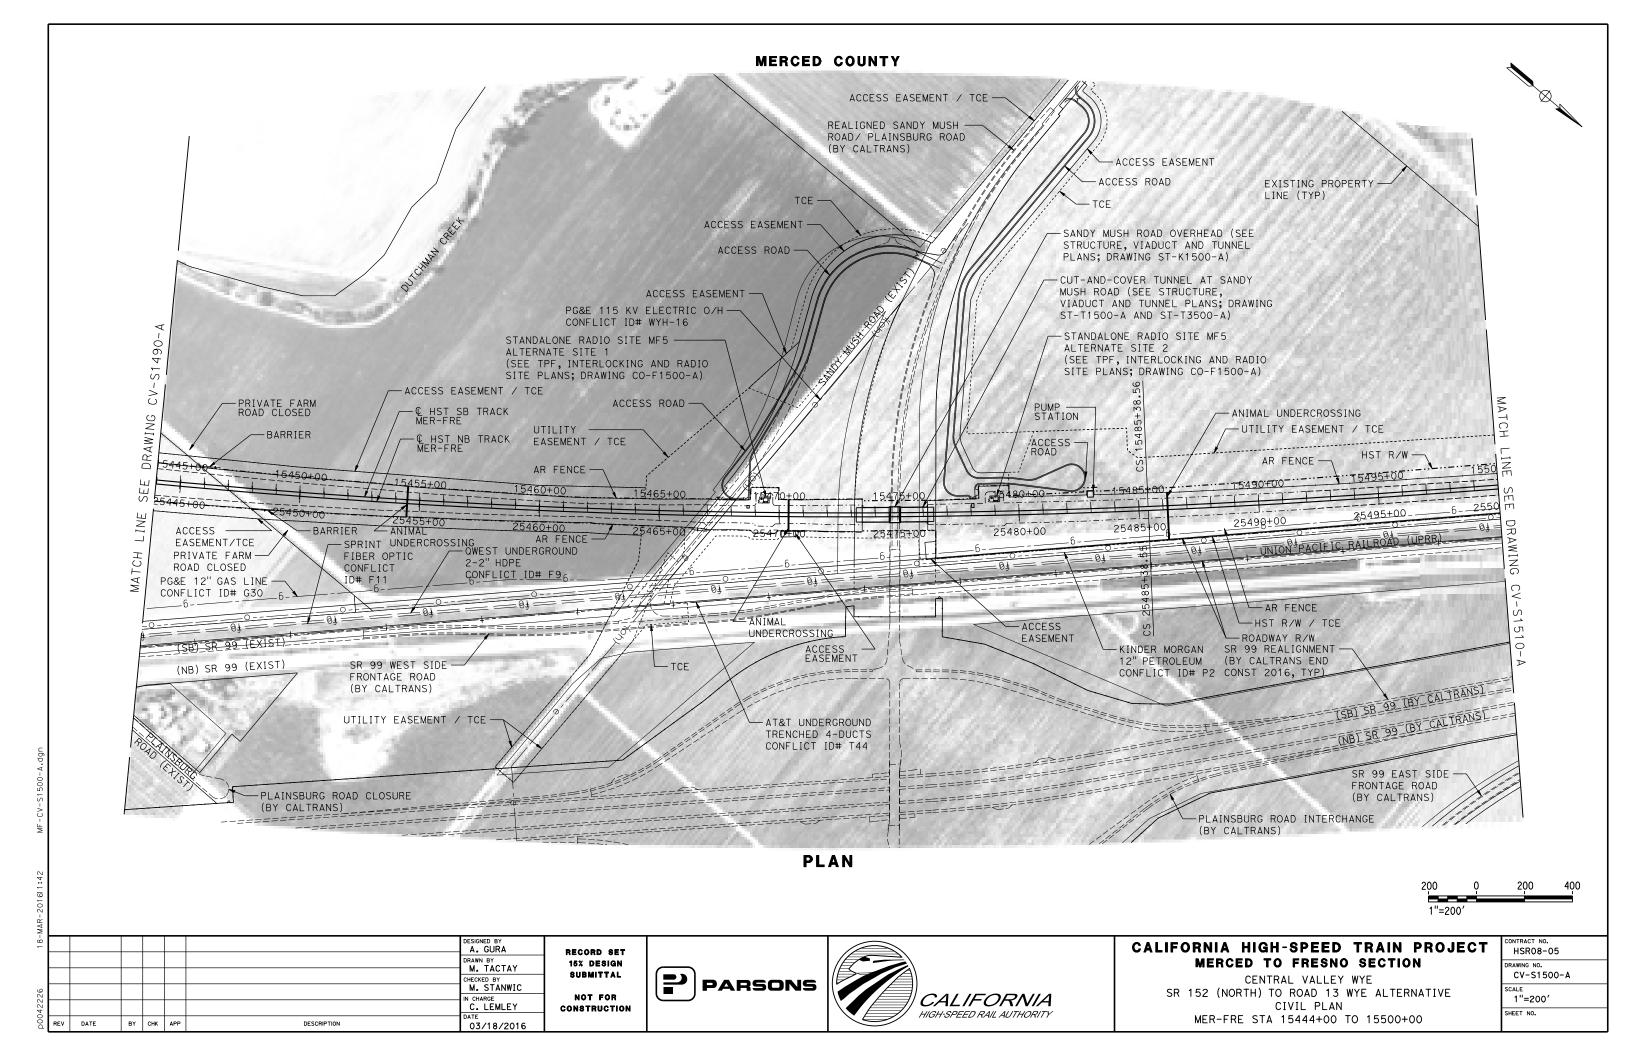

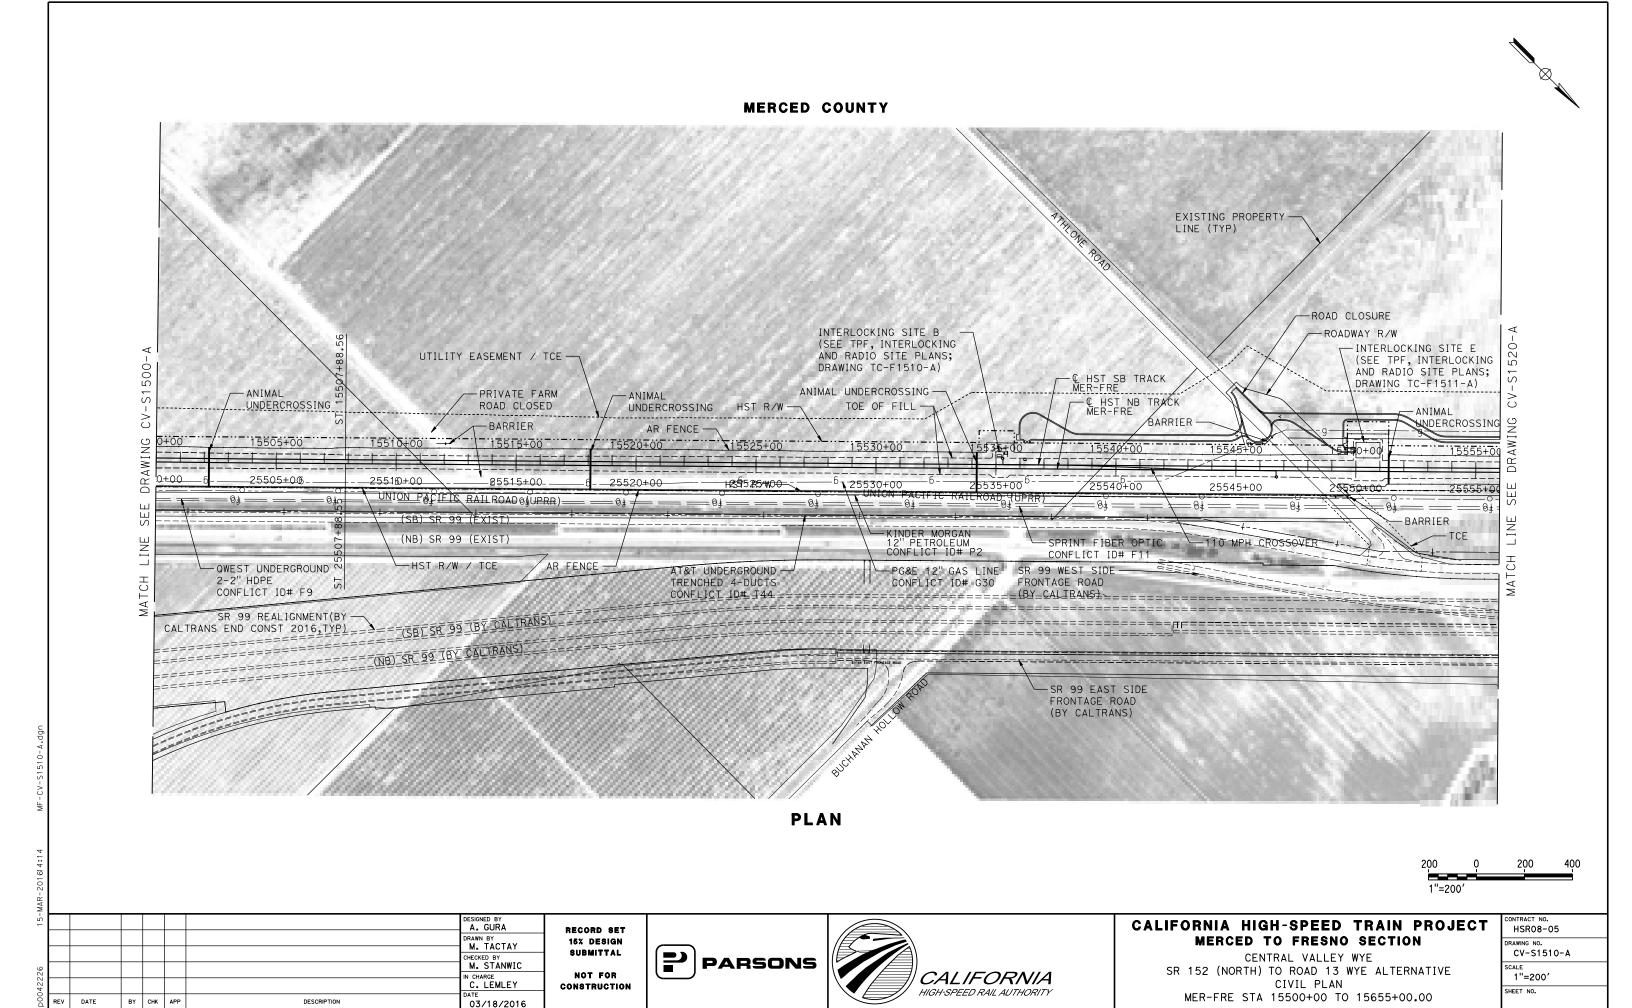


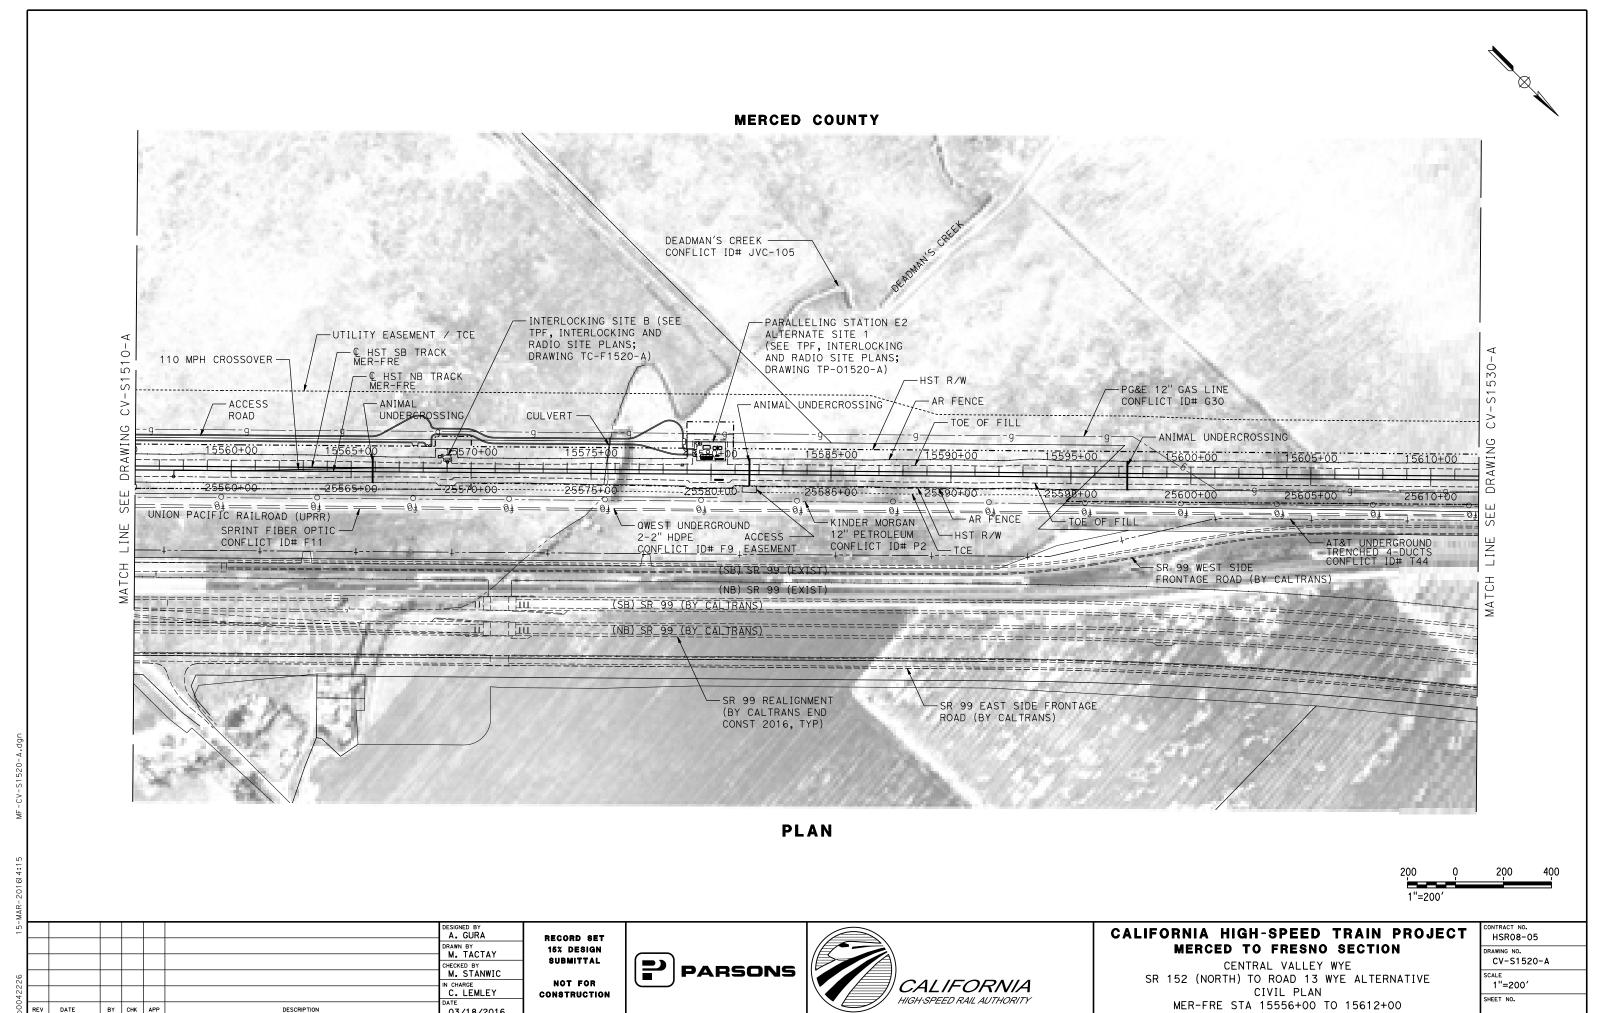

BY CHK APP

DESCRIPTION

03/18/2016

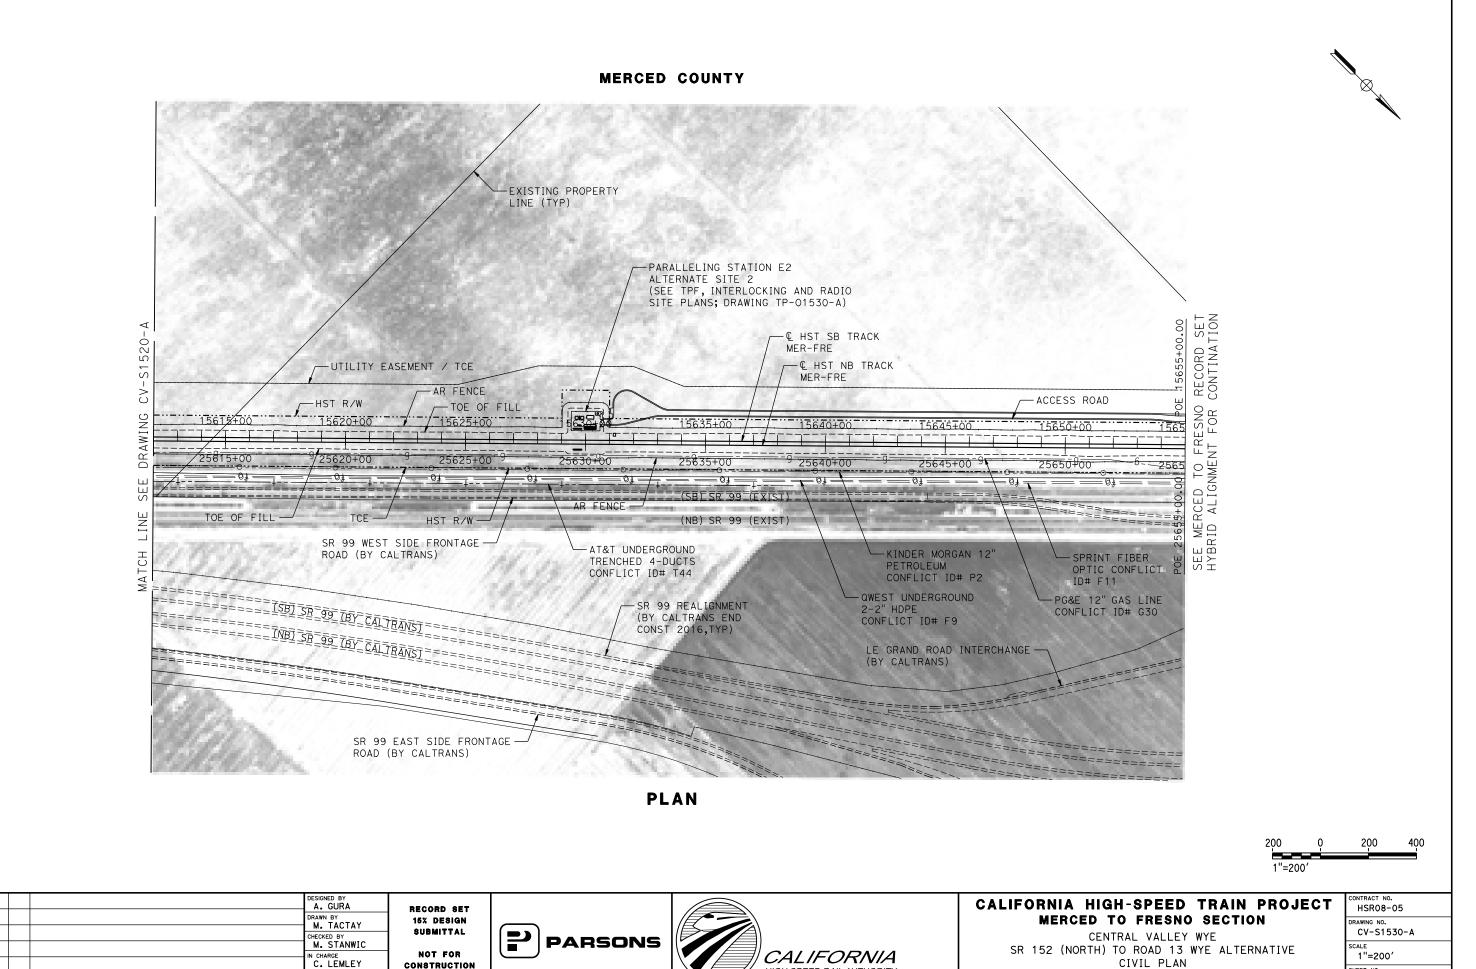

HIGH-SPEED RAIL AUTHORITY

CONSTRUCTION

03/18/2016

DATE


BY CHK APP


DESCRIPTION


CIVIL PLAN


MER-FRE STA 15612+00 TO 15655+00

SHEET NO.

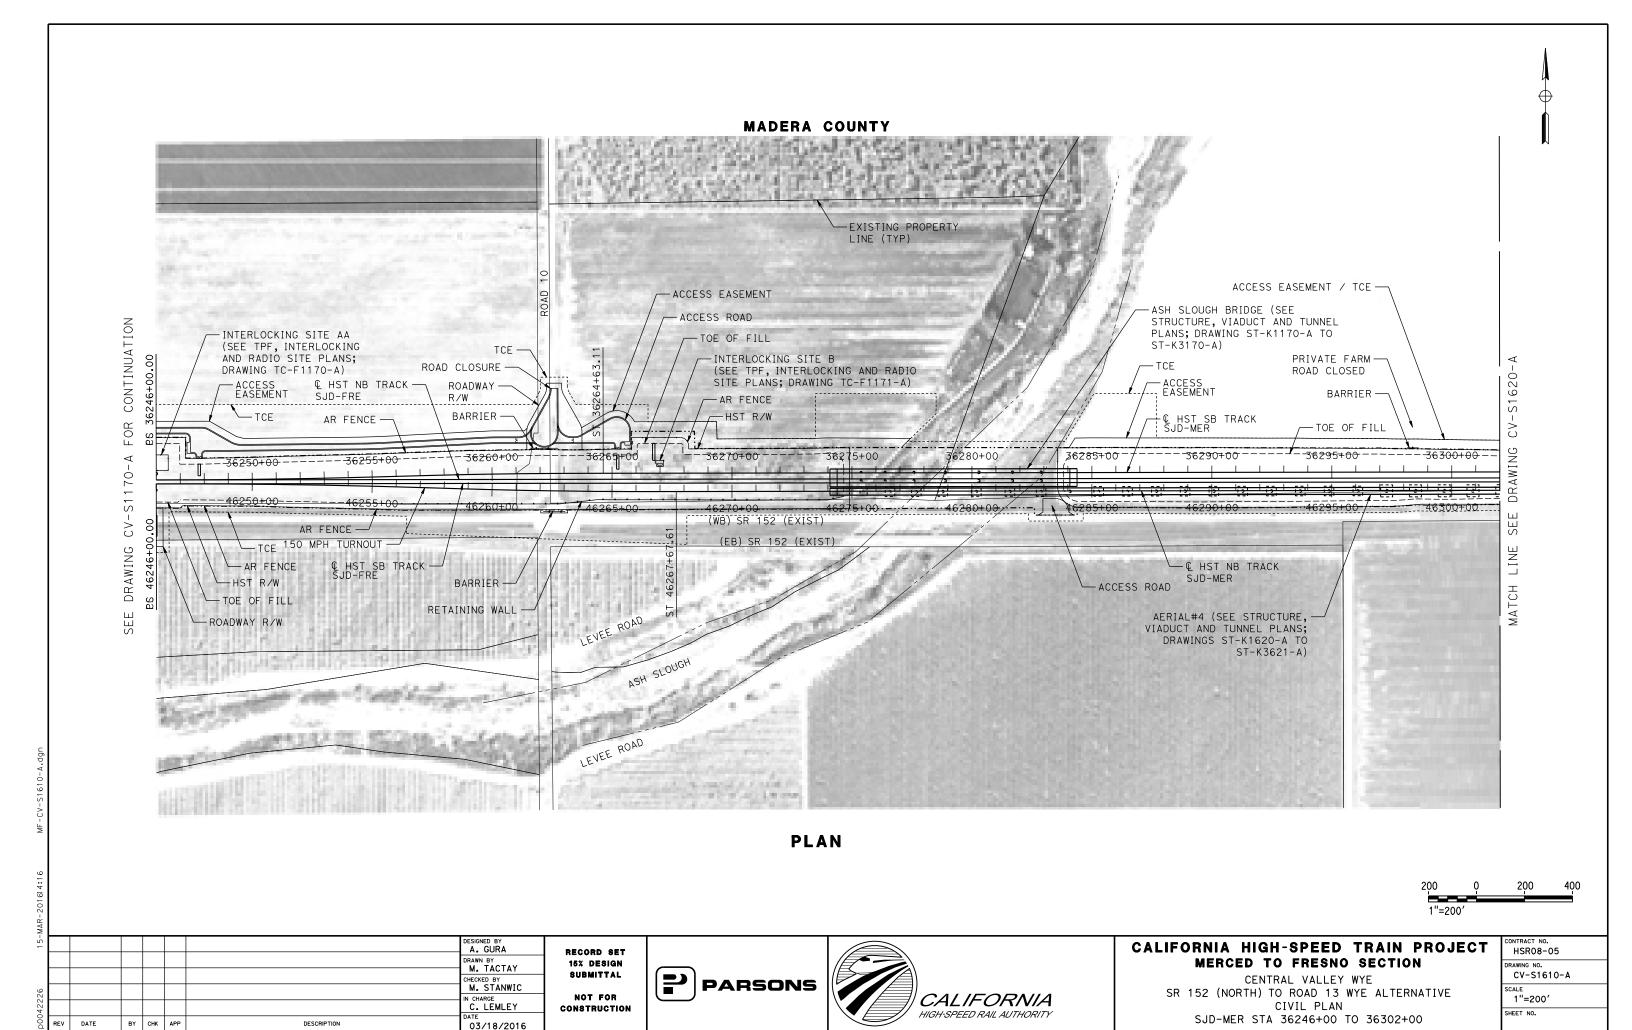

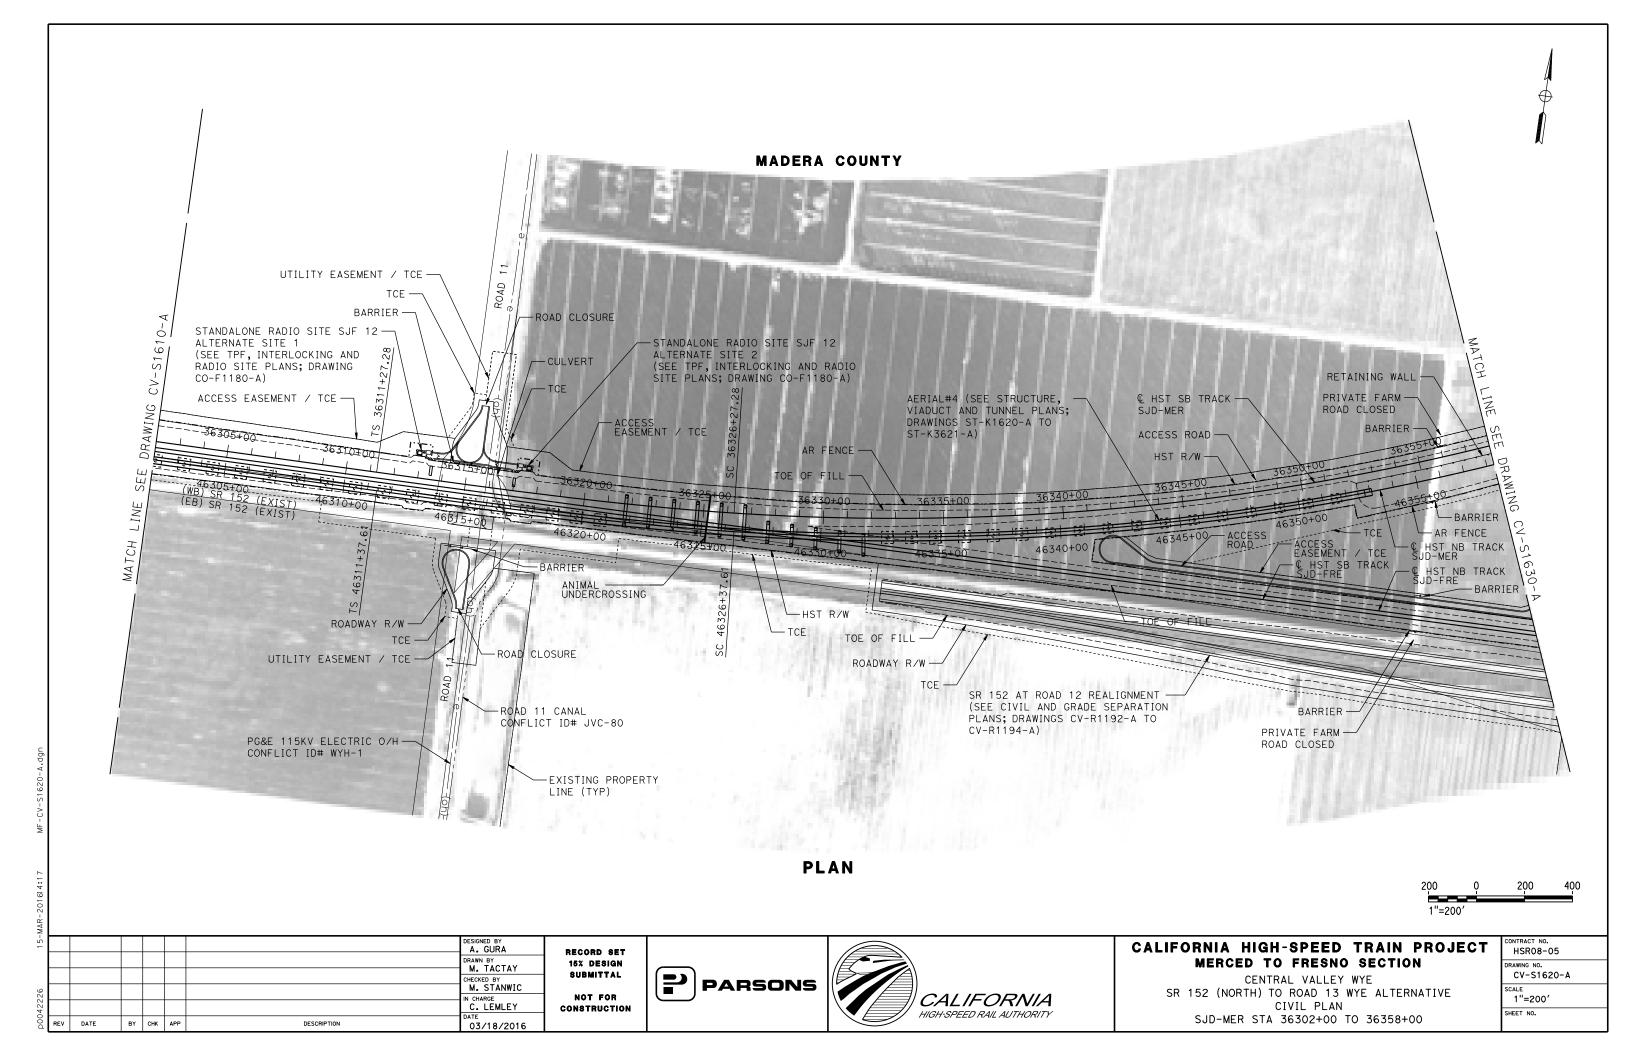

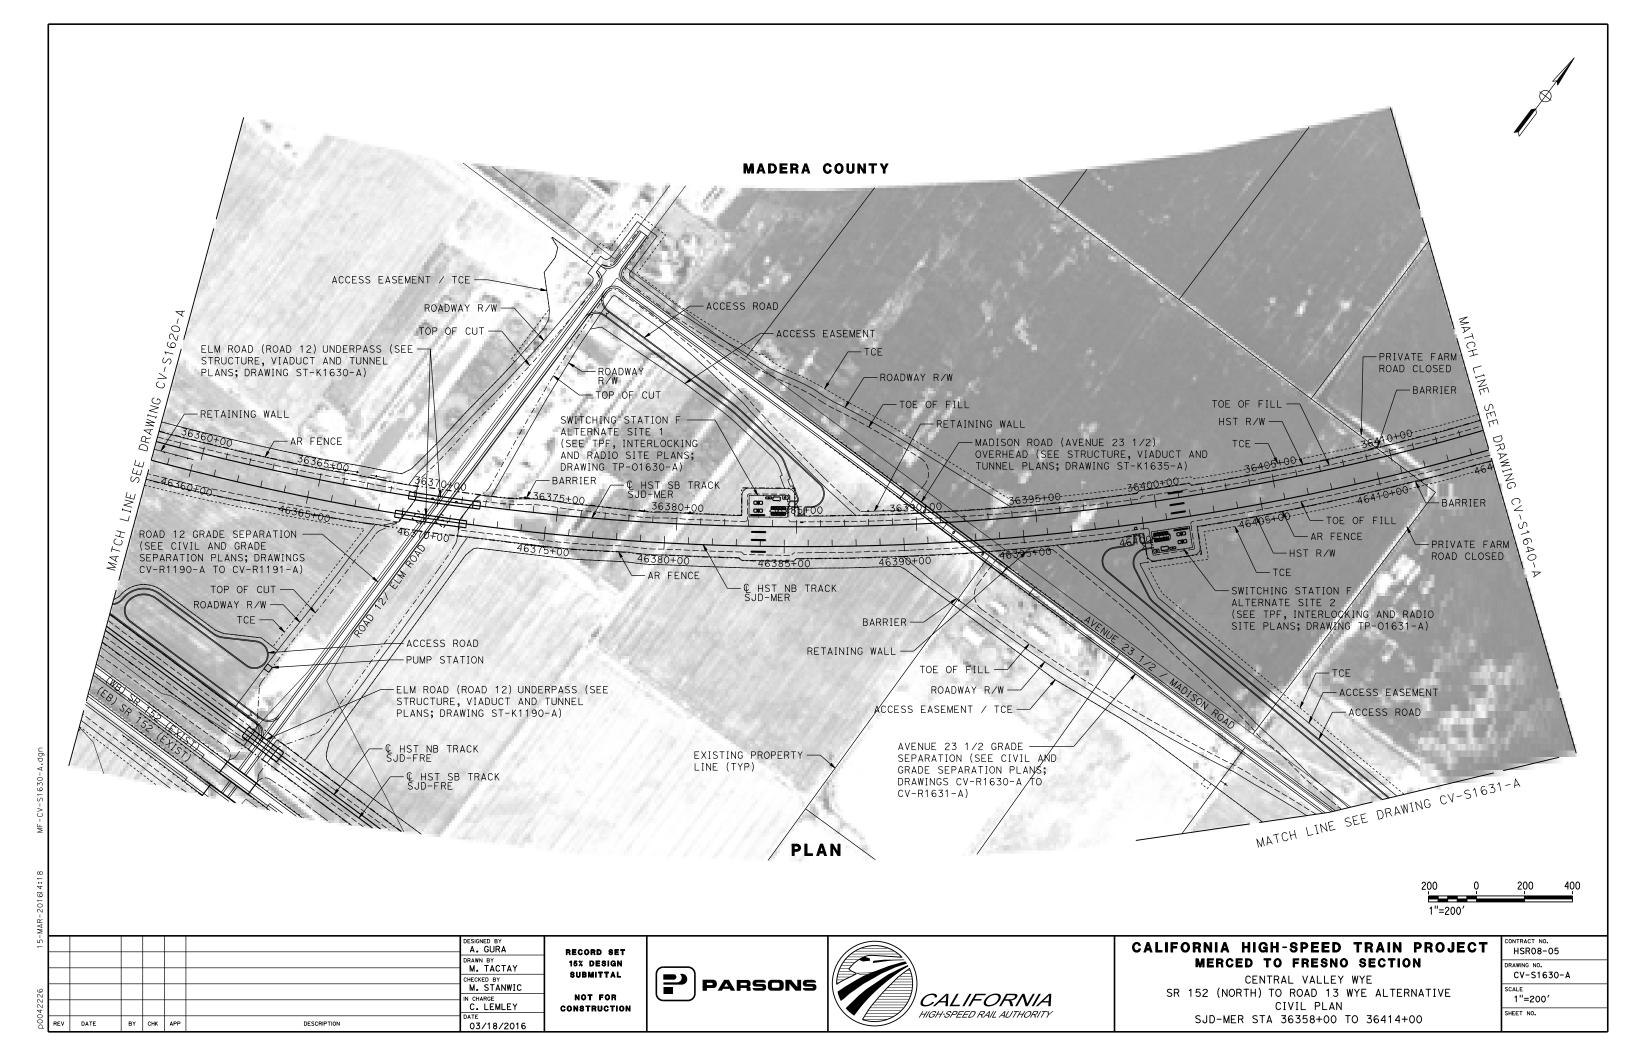

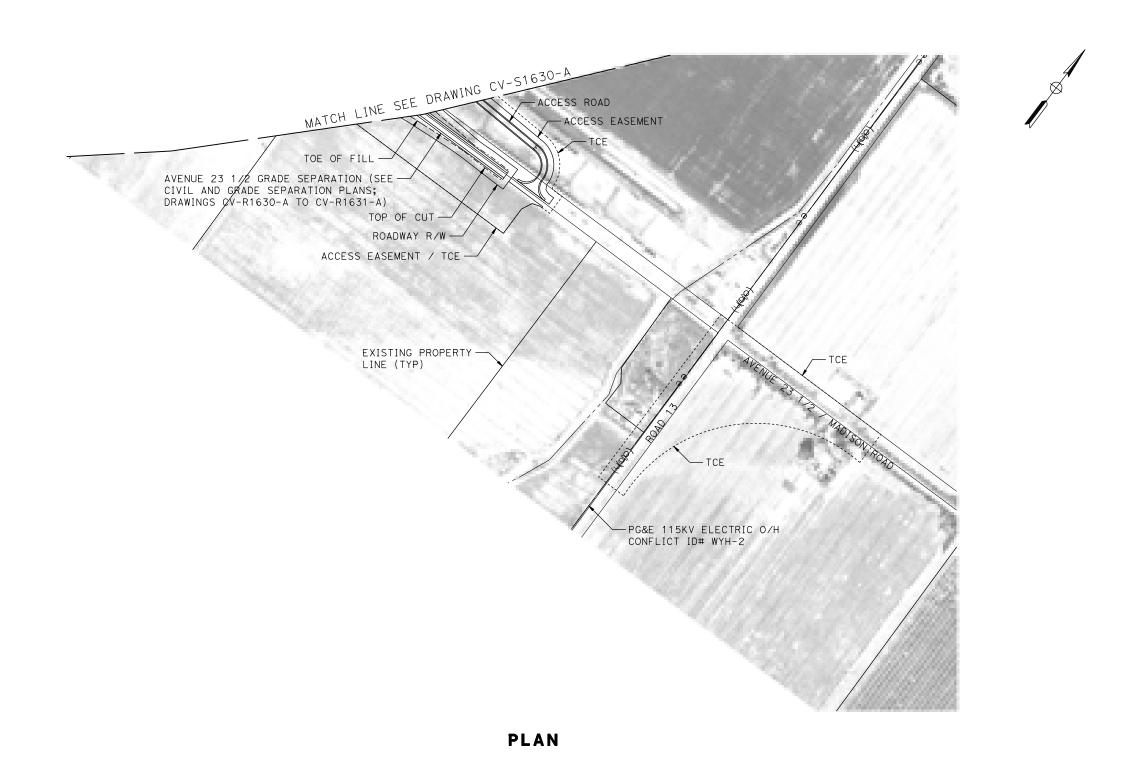

200 0 200 400

5							DESIGNED BY A. GURA	
							DRAWN BY M. TACTAY	<b>1</b>
							CHECKED BY	ł
γ							M. STANWIC	
513							C. LEMLEY	c
000	REV	DATE	BY	СНК	APP	DESCRIPTION	DATE 03/18/2016	

RECORD SET
15% DESIGN
SUBMITTAL
NOT FOR
CONSTRUCTION







# CALIFORNIA HIGH-SPEED TRAIN PROJECT MERCED TO FRESNO SECTION

CENTRAL VALLEY WYE
SR 152 (NORTH) TO ROAD 13 WYE ALTERNATIVE
CIVIL PLAN
SJD-MER ACCESS ROAD

CONTRACT NO.
HSR08-05
DRAWING NO.
CV-S1631-A
SCALE
1"=200′
SHEET NO.

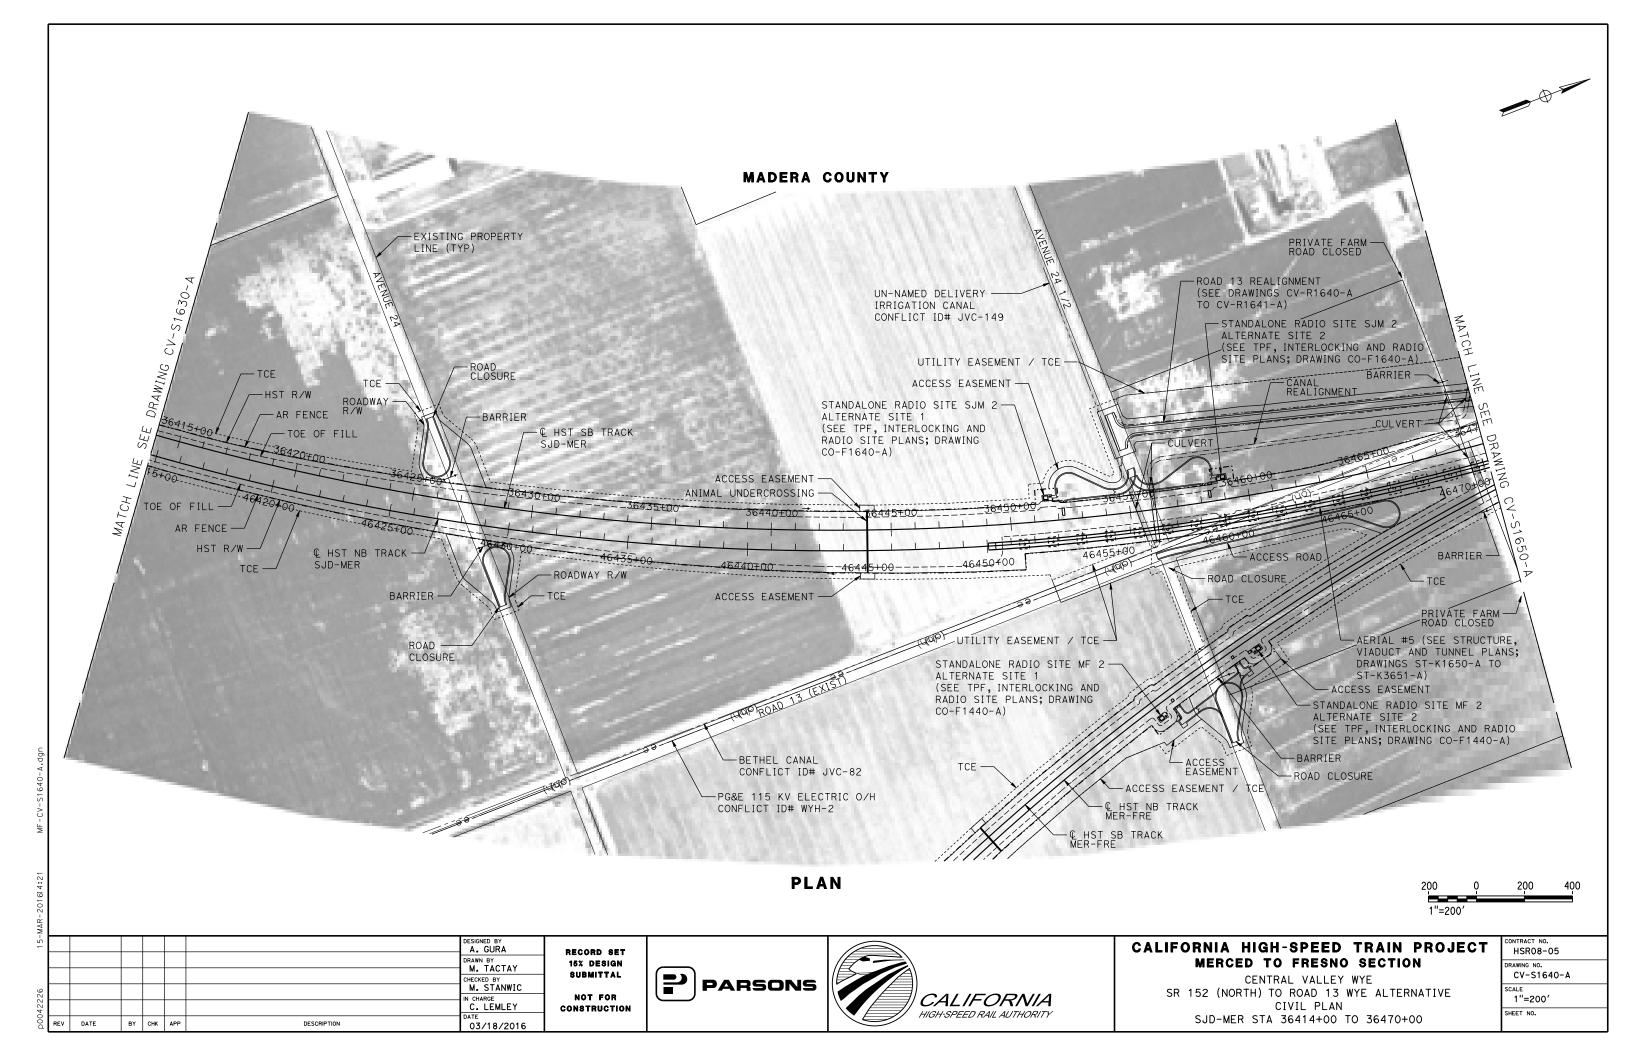



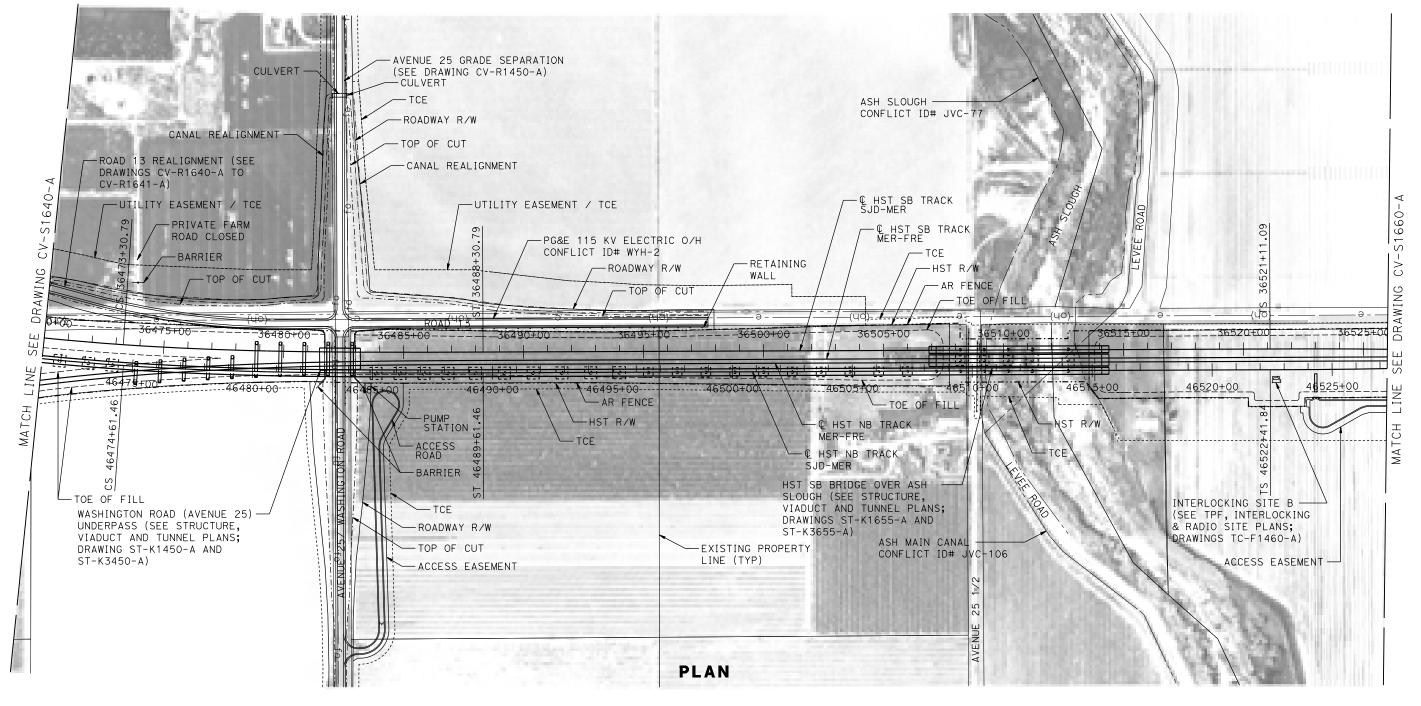

200	Q	200	400
1"=200	)'		

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15-							DESIGNED BY A. GURA	
							DRAWN BY M. TACTAY	l '
							CHECKED BY	i
526							M. STANWIC	
1422							C. LEMLEY	C
00d	REV	DATE	BY	СНК	APP	DESCRIPTION	03/18/2016	

RECORD SET
15% DESIGN
SUBMITTAL
NOT FOR
CONSTRUCTION







# CALIFORNIA HIGH-SPEED TRAIN PROJECT MERCED TO FRESNO SECTION

CENTRAL VALLEY WYE
SR 152 (NORTH) TO ROAD 13 WYE ALTERNATIVE
CIVIL PLAN
SJD-MER STA 36470+00 TO 36526+00

	CONTRACT NO. HSR08-05
	DRAWING NO. CV-S1650-A
	1"=200'
	SHEET NO.

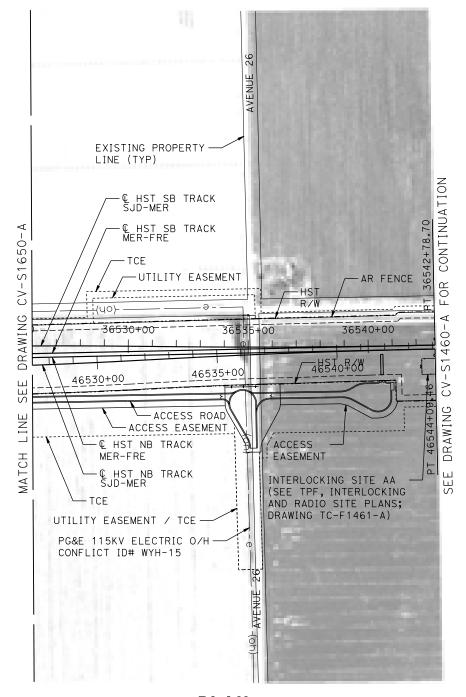

PLAN

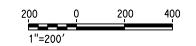

							DESIGNED BY A. GURA	R
							DRAWN BY M. TACTAY	1
							CHECKED BY	•
							M. STANWIC	
							C. LEMLEY	co
_	REV	DATE	BY	снк	APP	DESCRIPTION	03/18/2016	

RECORD SET
15% DESIGN
SUBMITTAL
NOT FOR
CONSTRUCTION








# CALIFORNIA HIGH-SPEED TRAIN PROJECT MERCED TO FRESNO SECTION


CENTRAL VALLEY WYE
SR 152 (NORTH) TO ROAD 13 WYE ALTERNATIVE
CIVIL PLAN
SJD-MER STA 36526+00 TO 36542+78.70


CONTRACT NO. HSR08-05	
DRAWING NO. CV-S1660-A	
SCALE 1"=200'	
SHEET NO.	

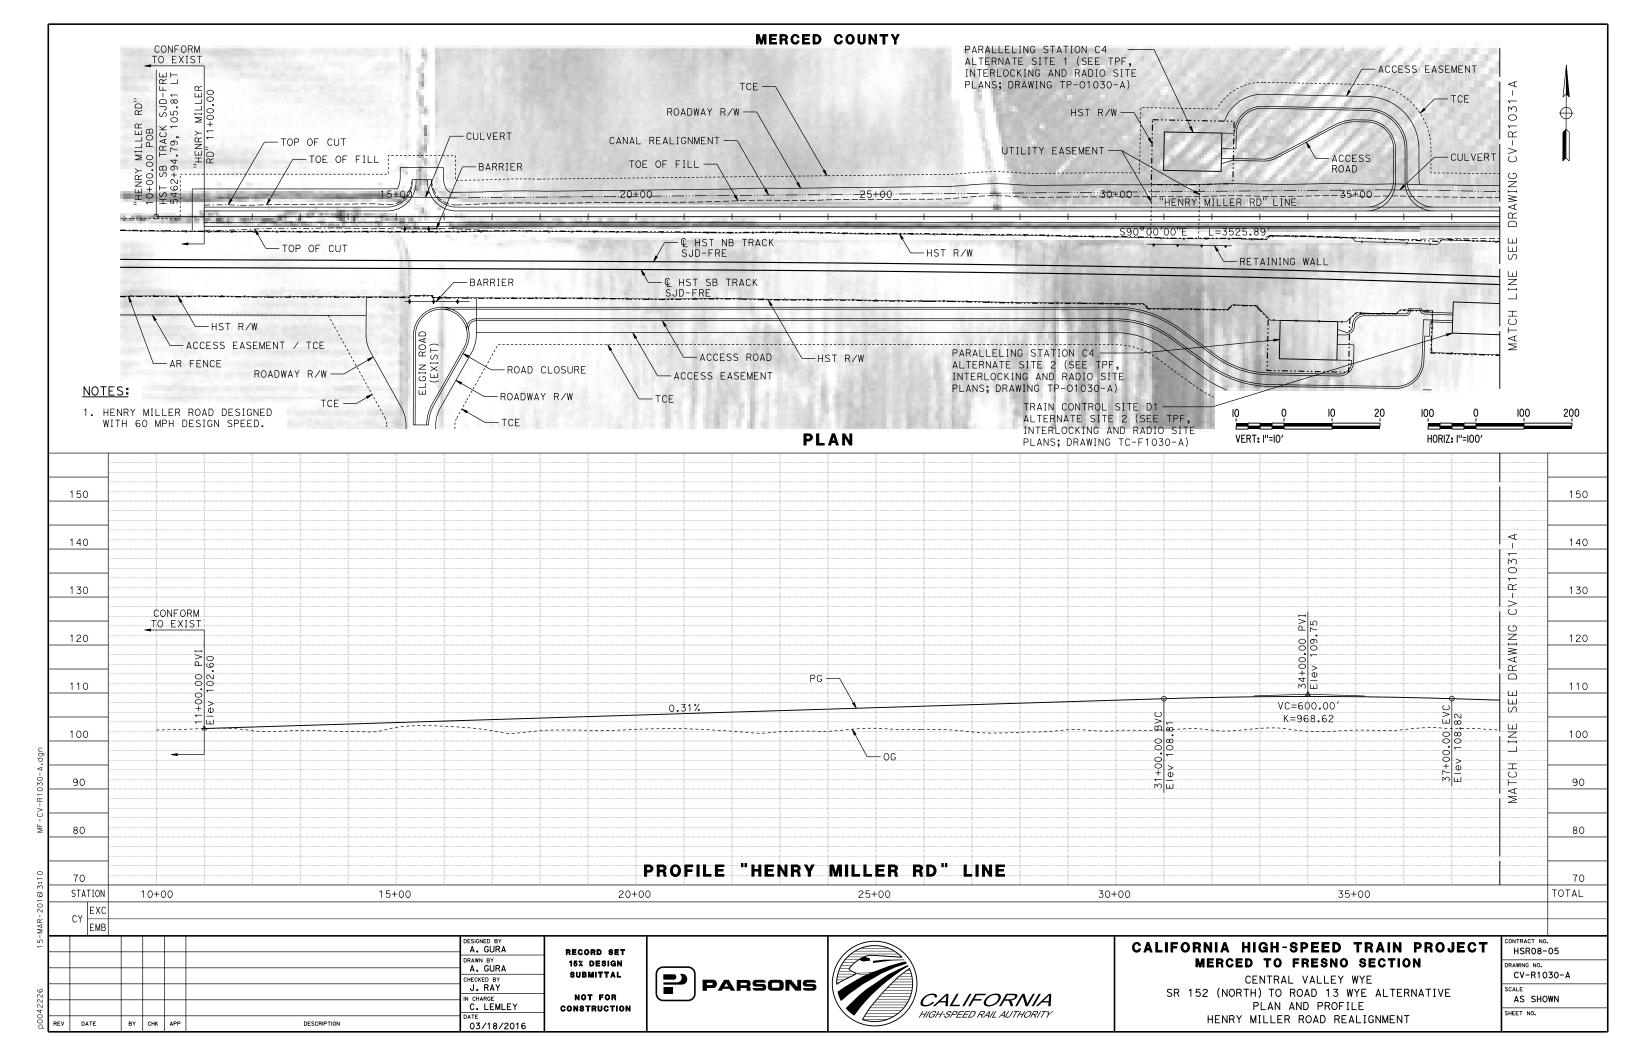


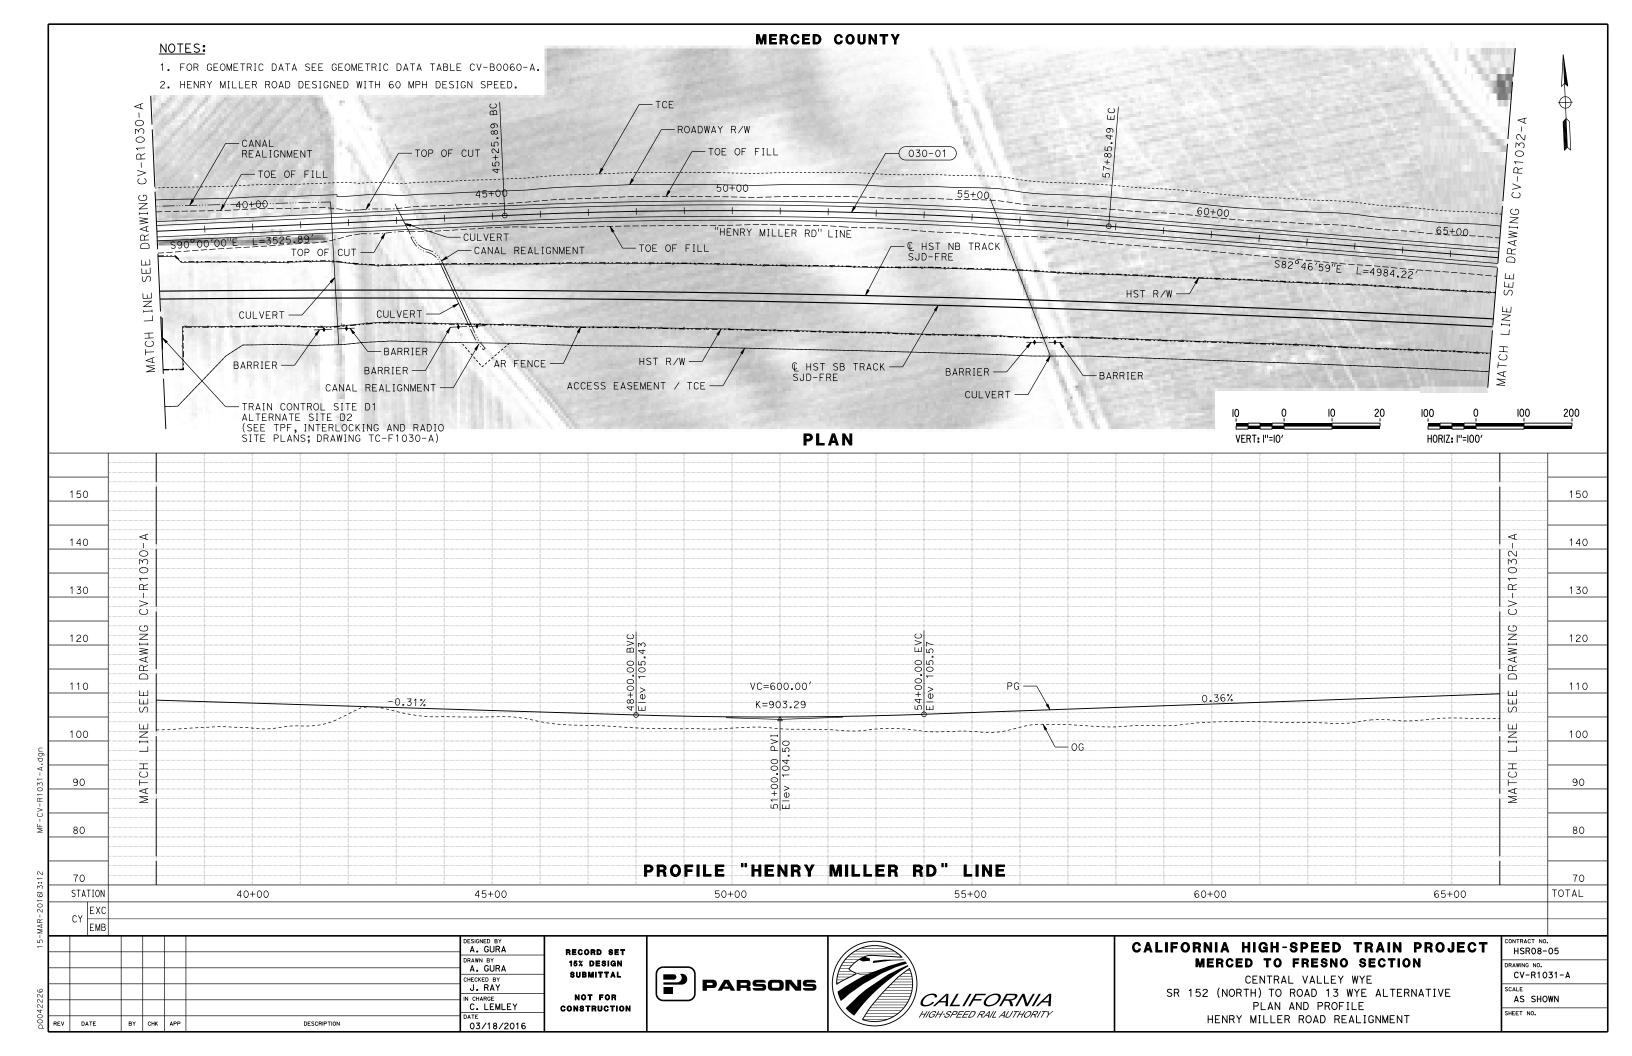


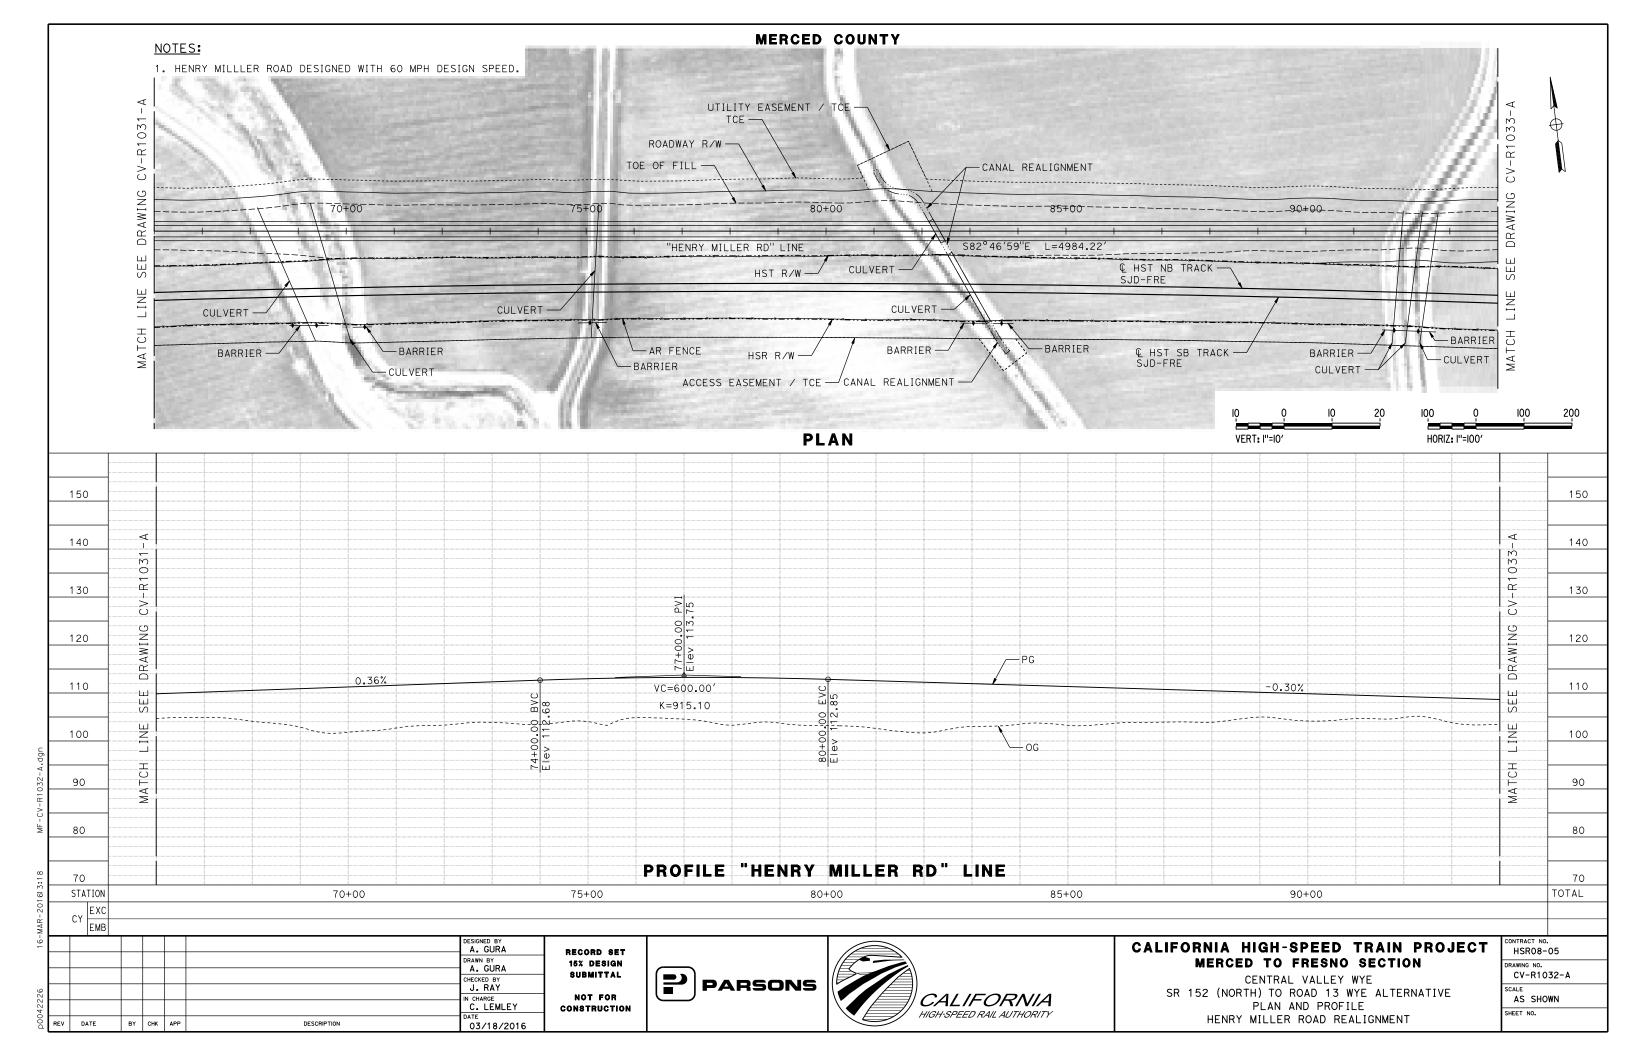


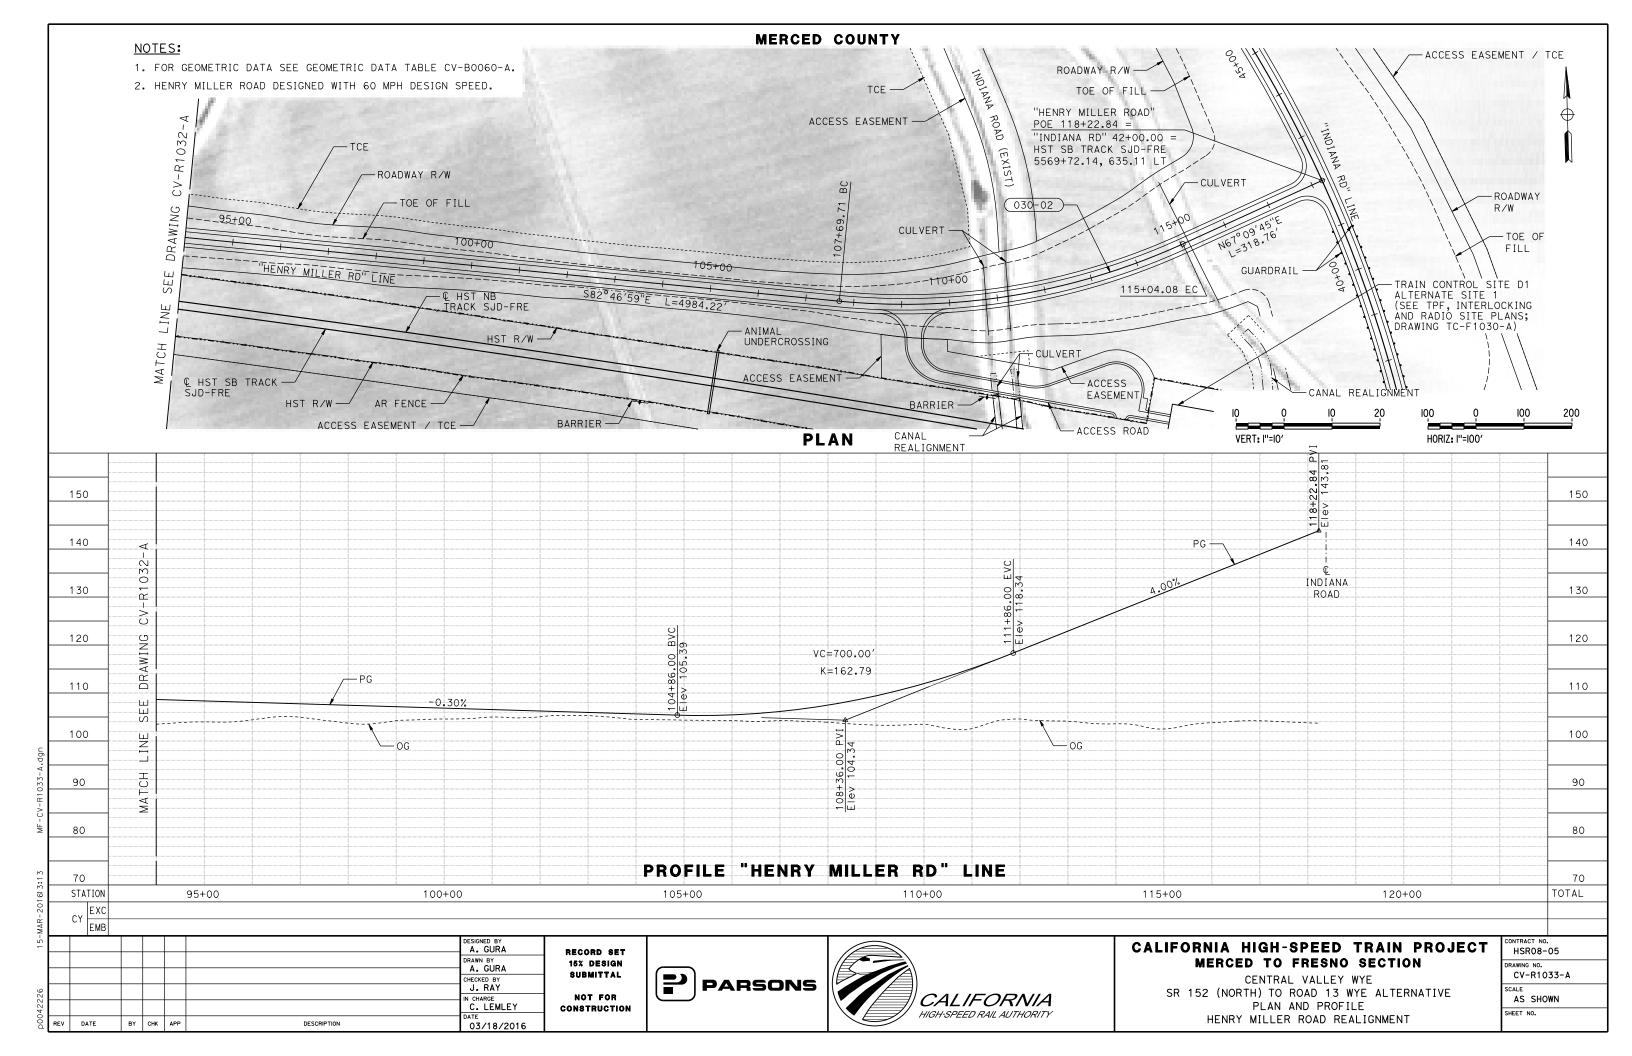


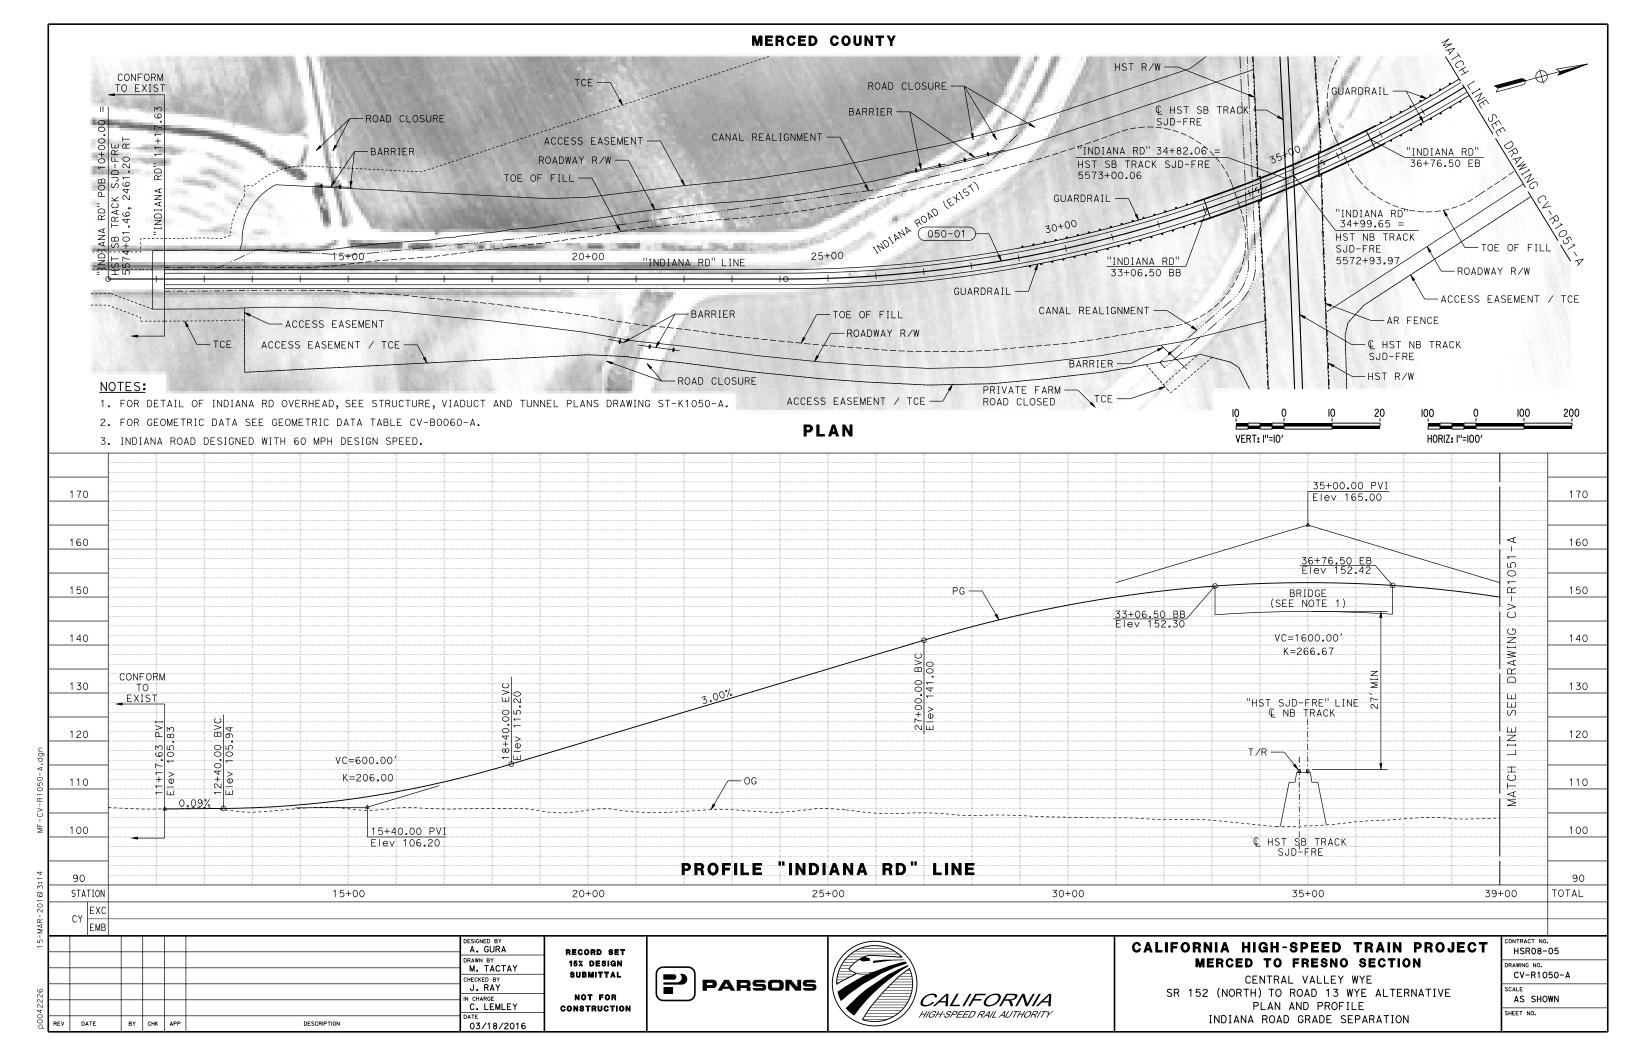


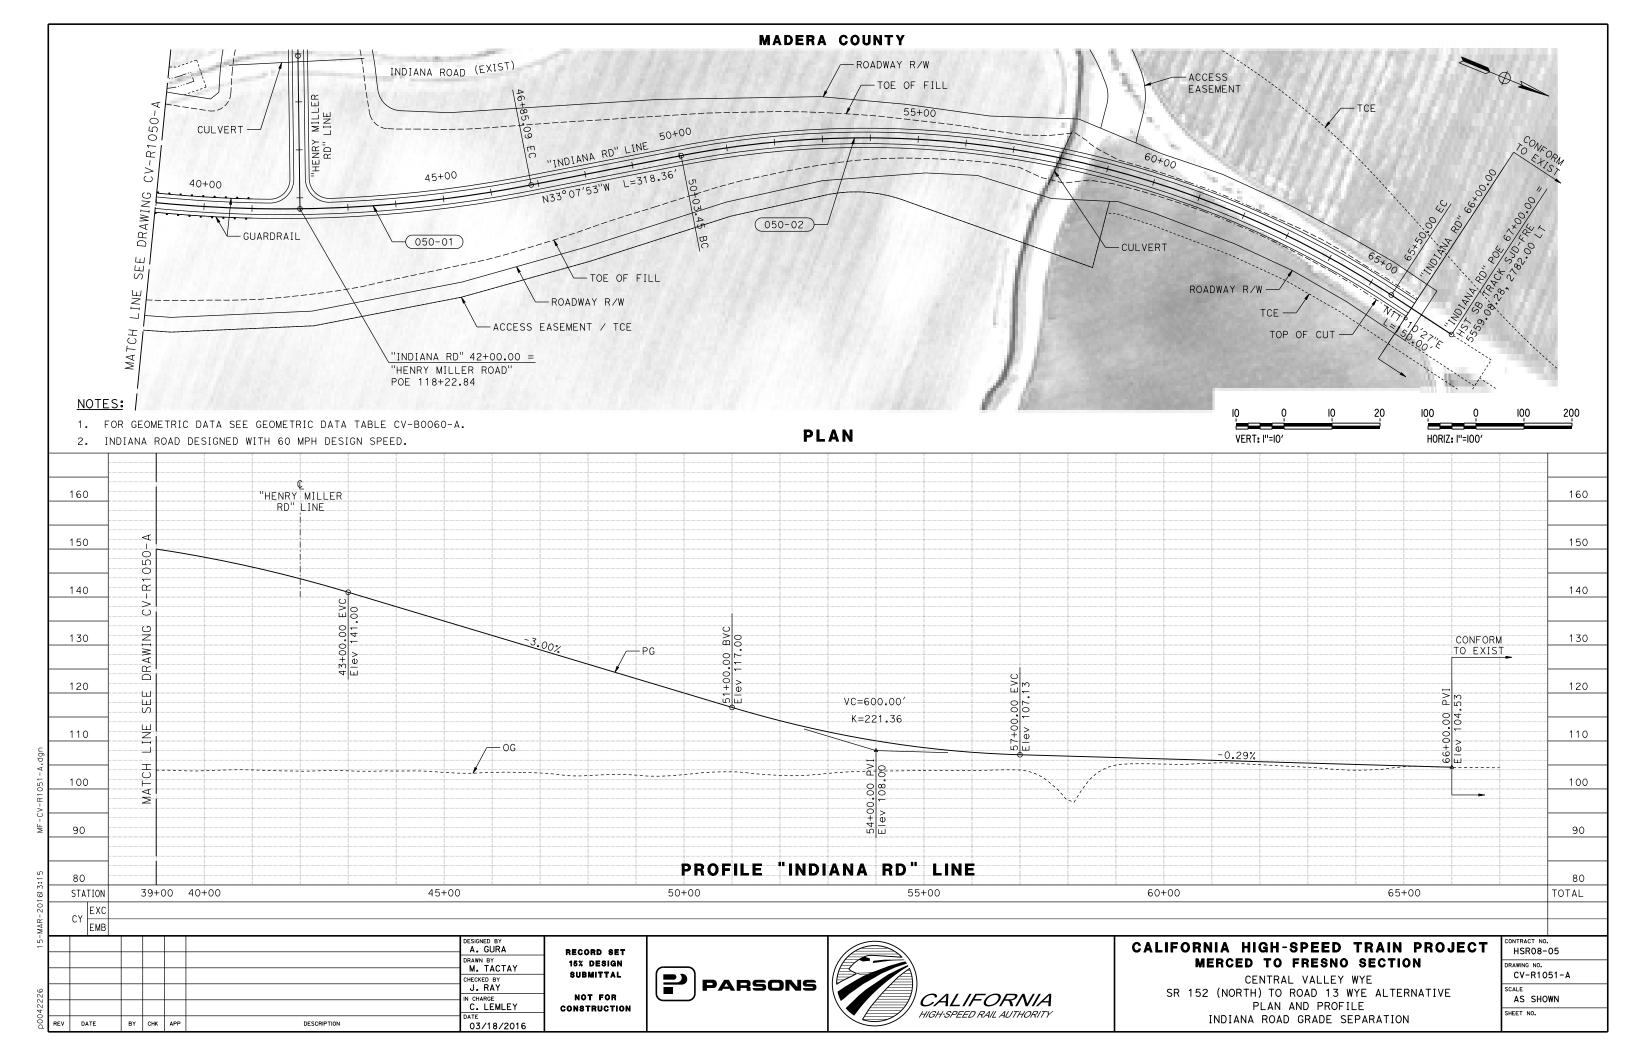


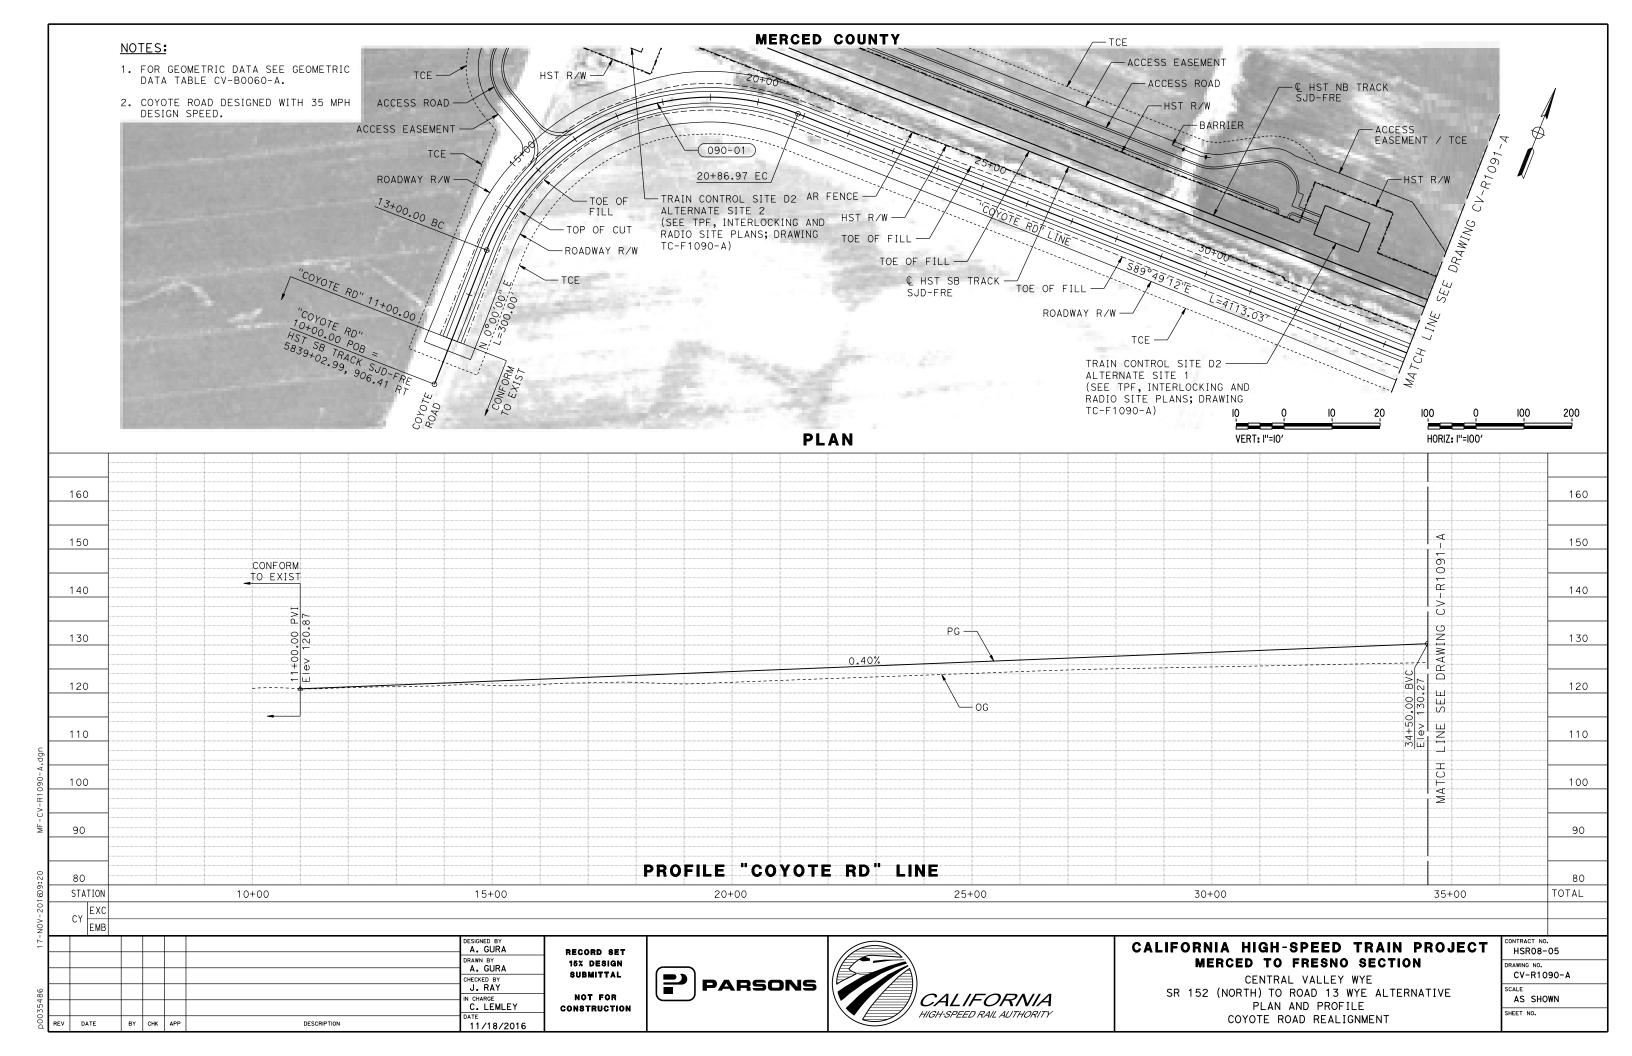


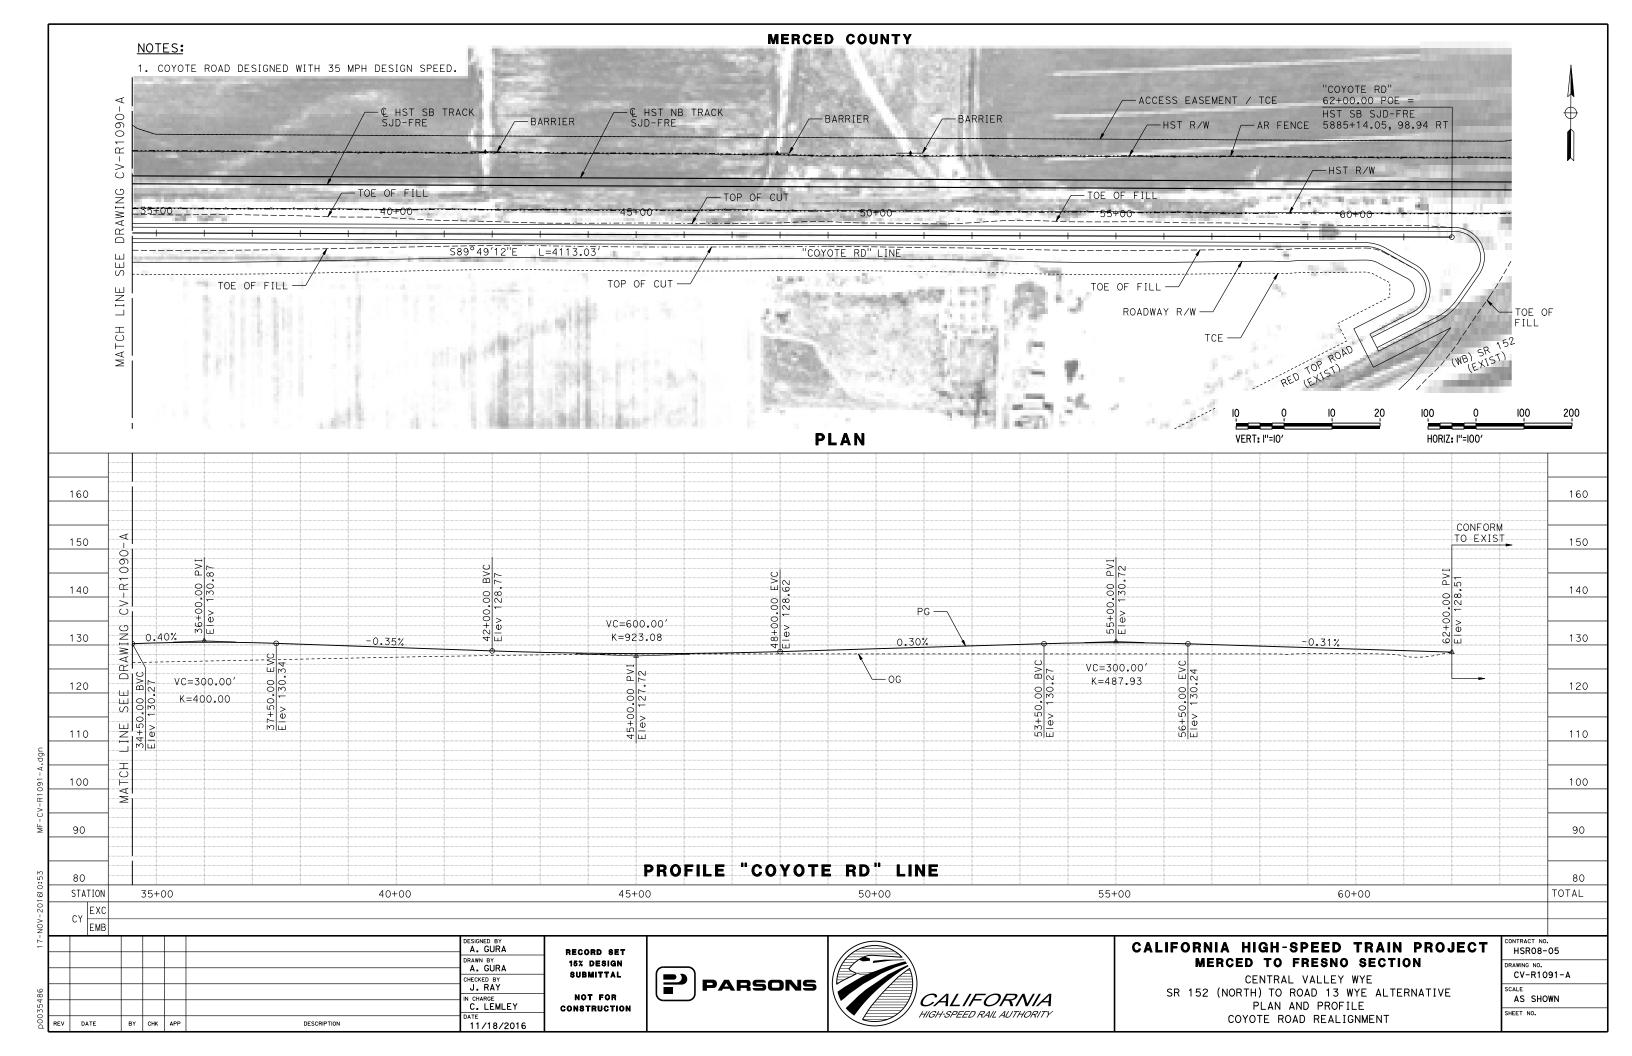


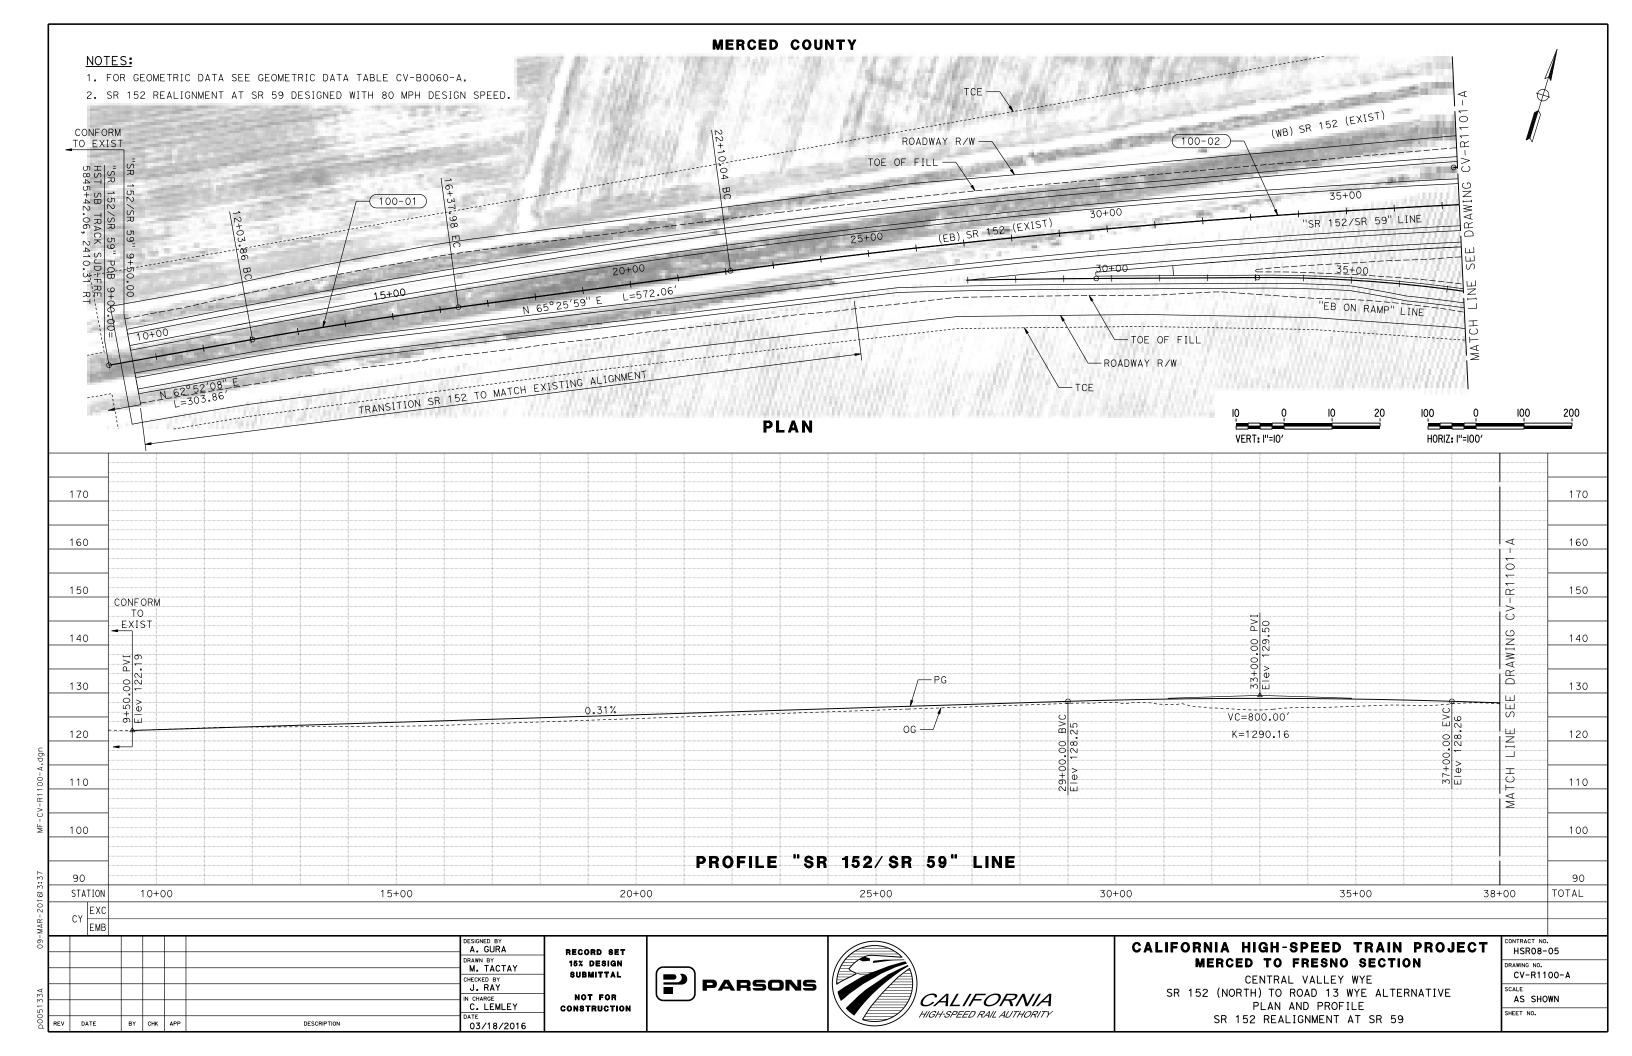


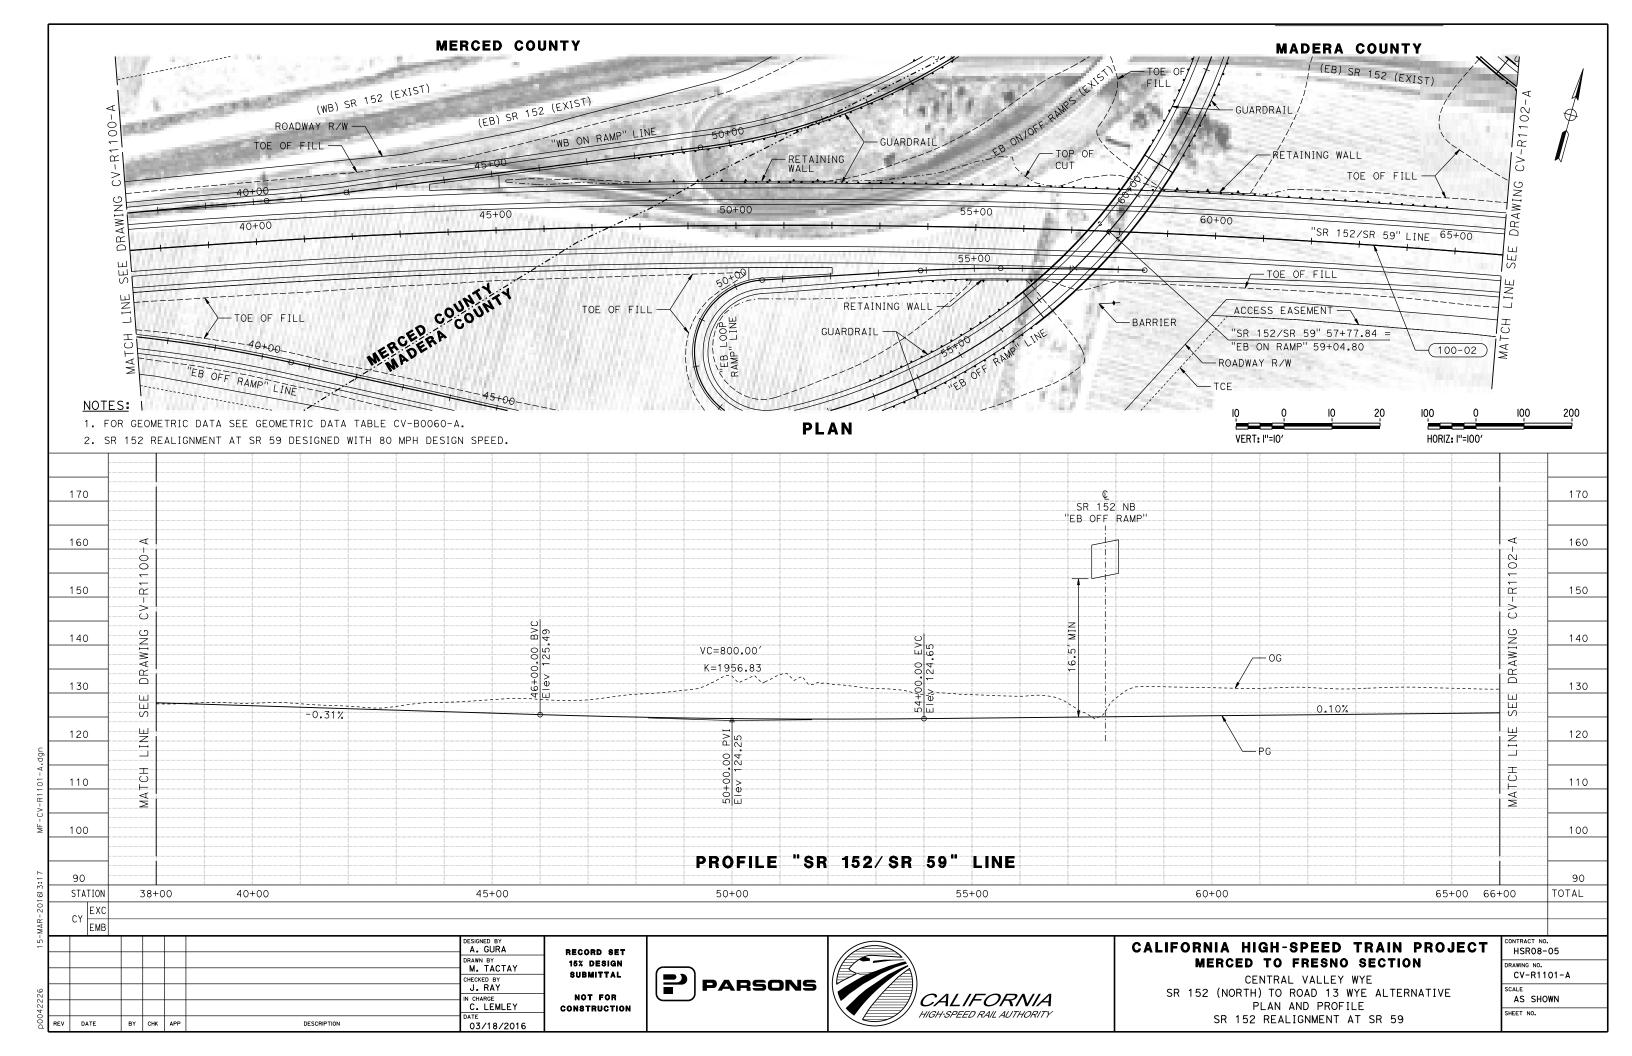


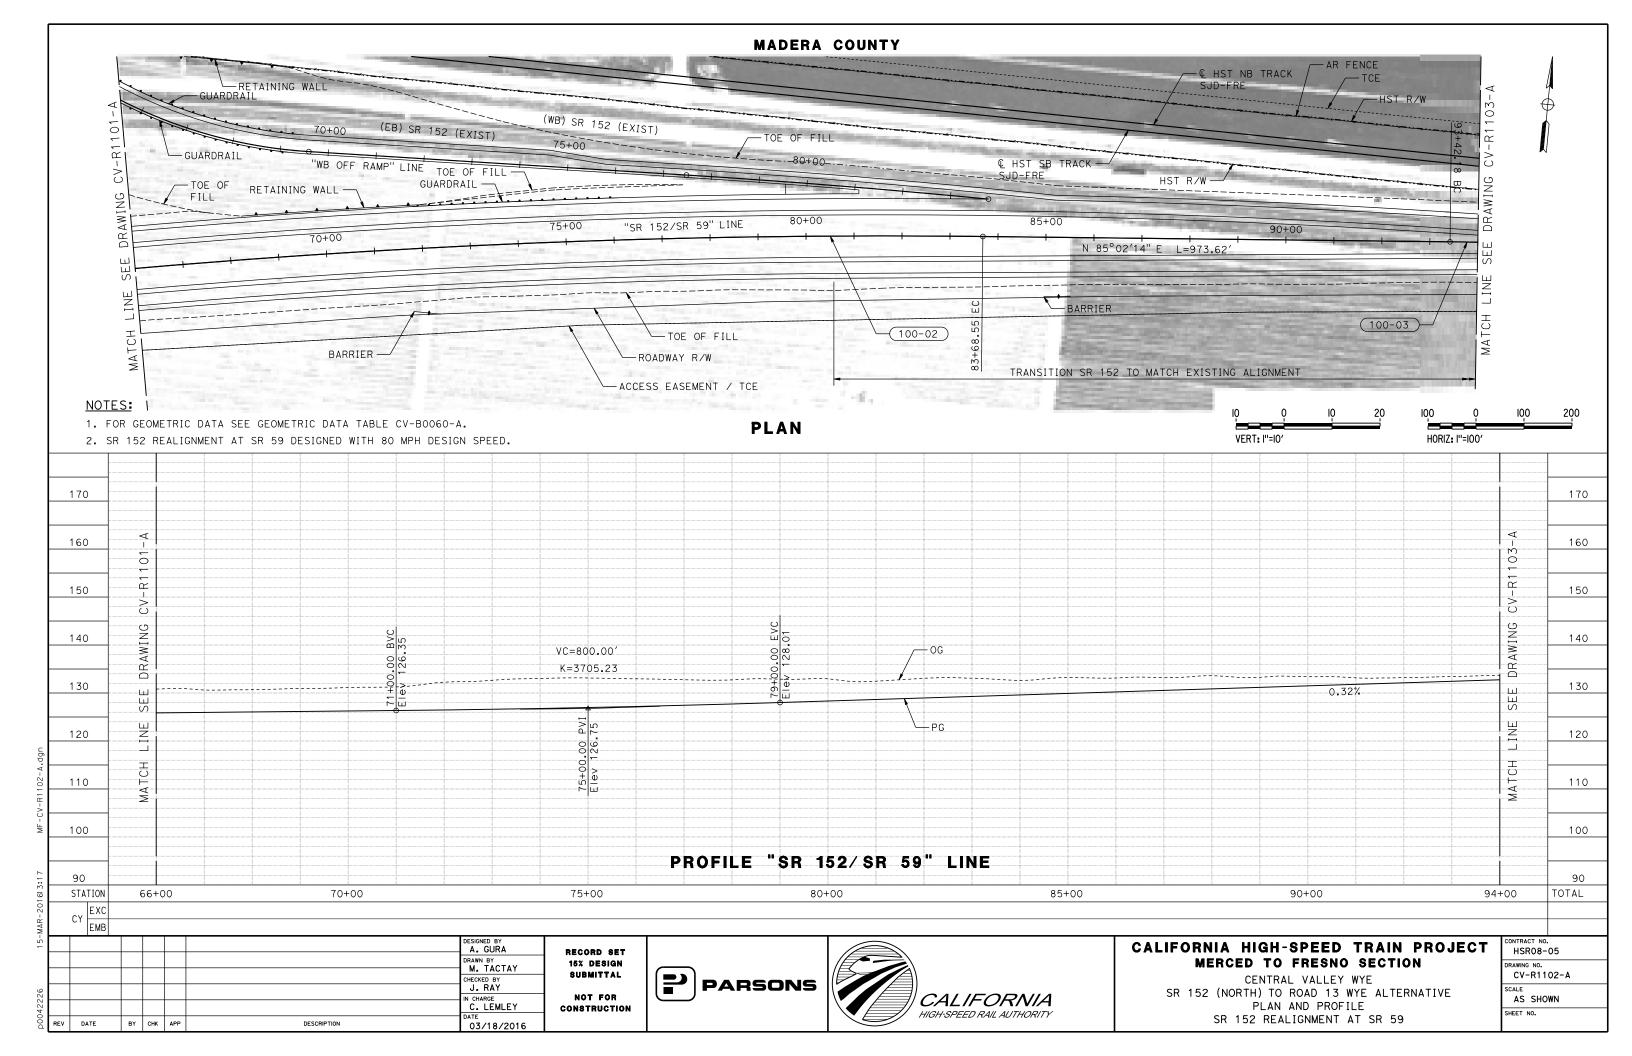


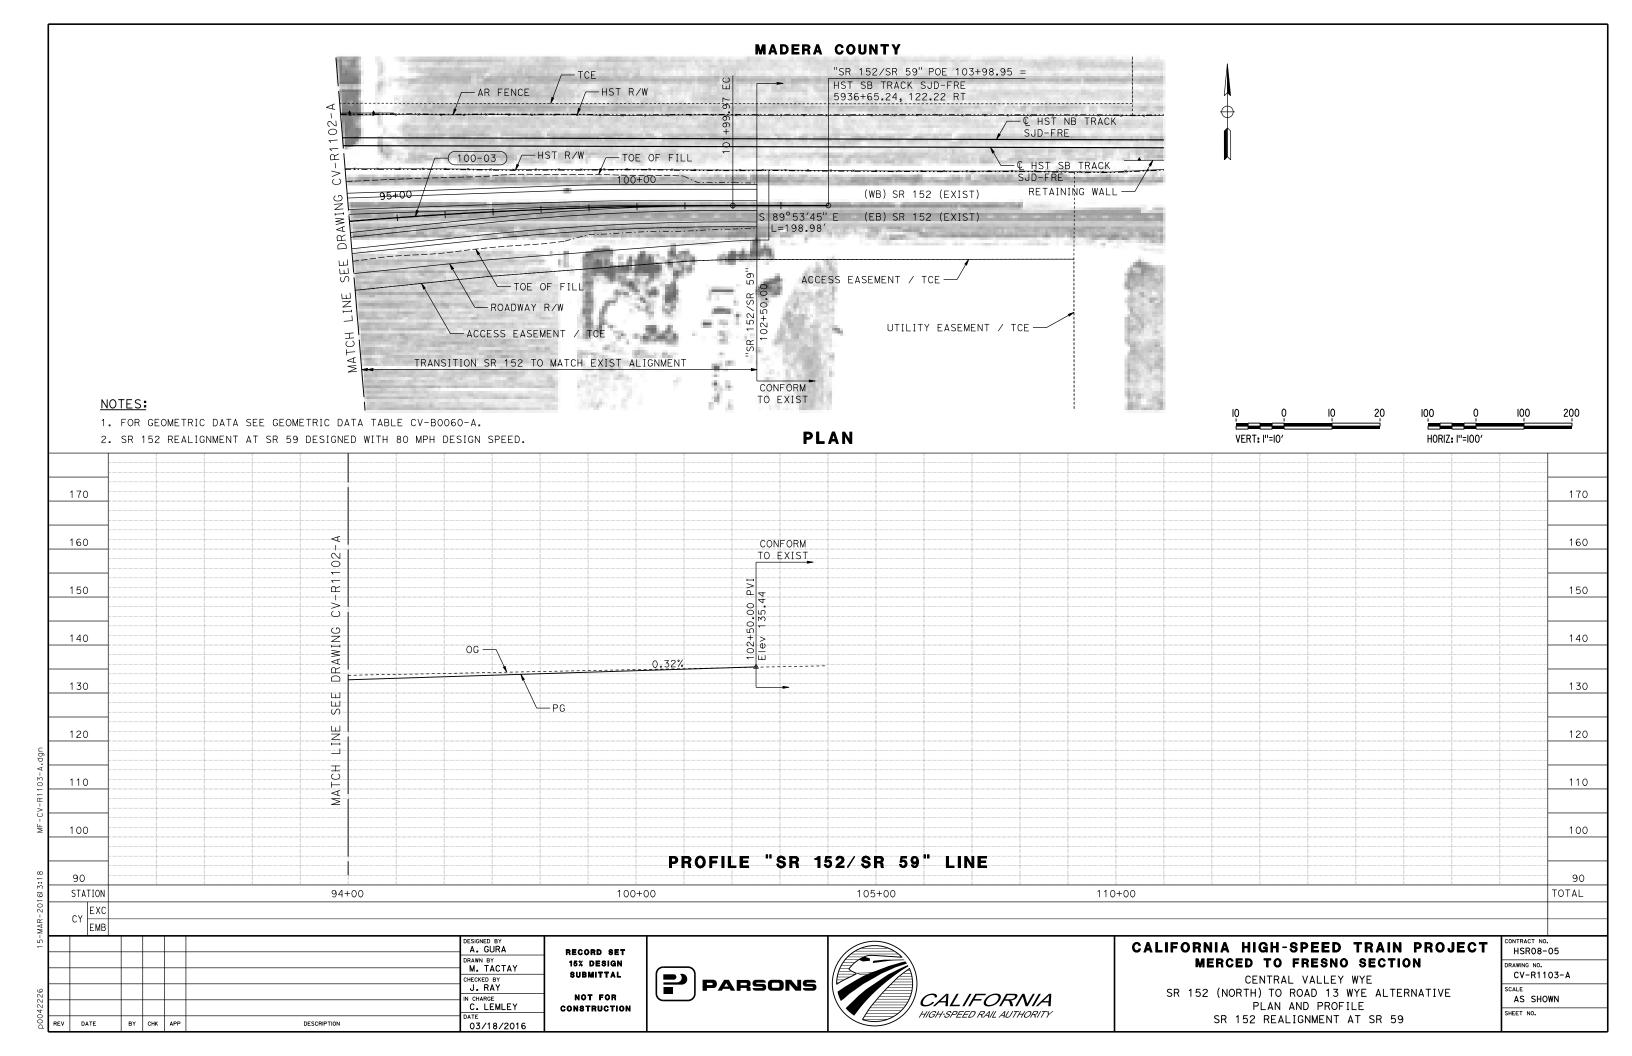


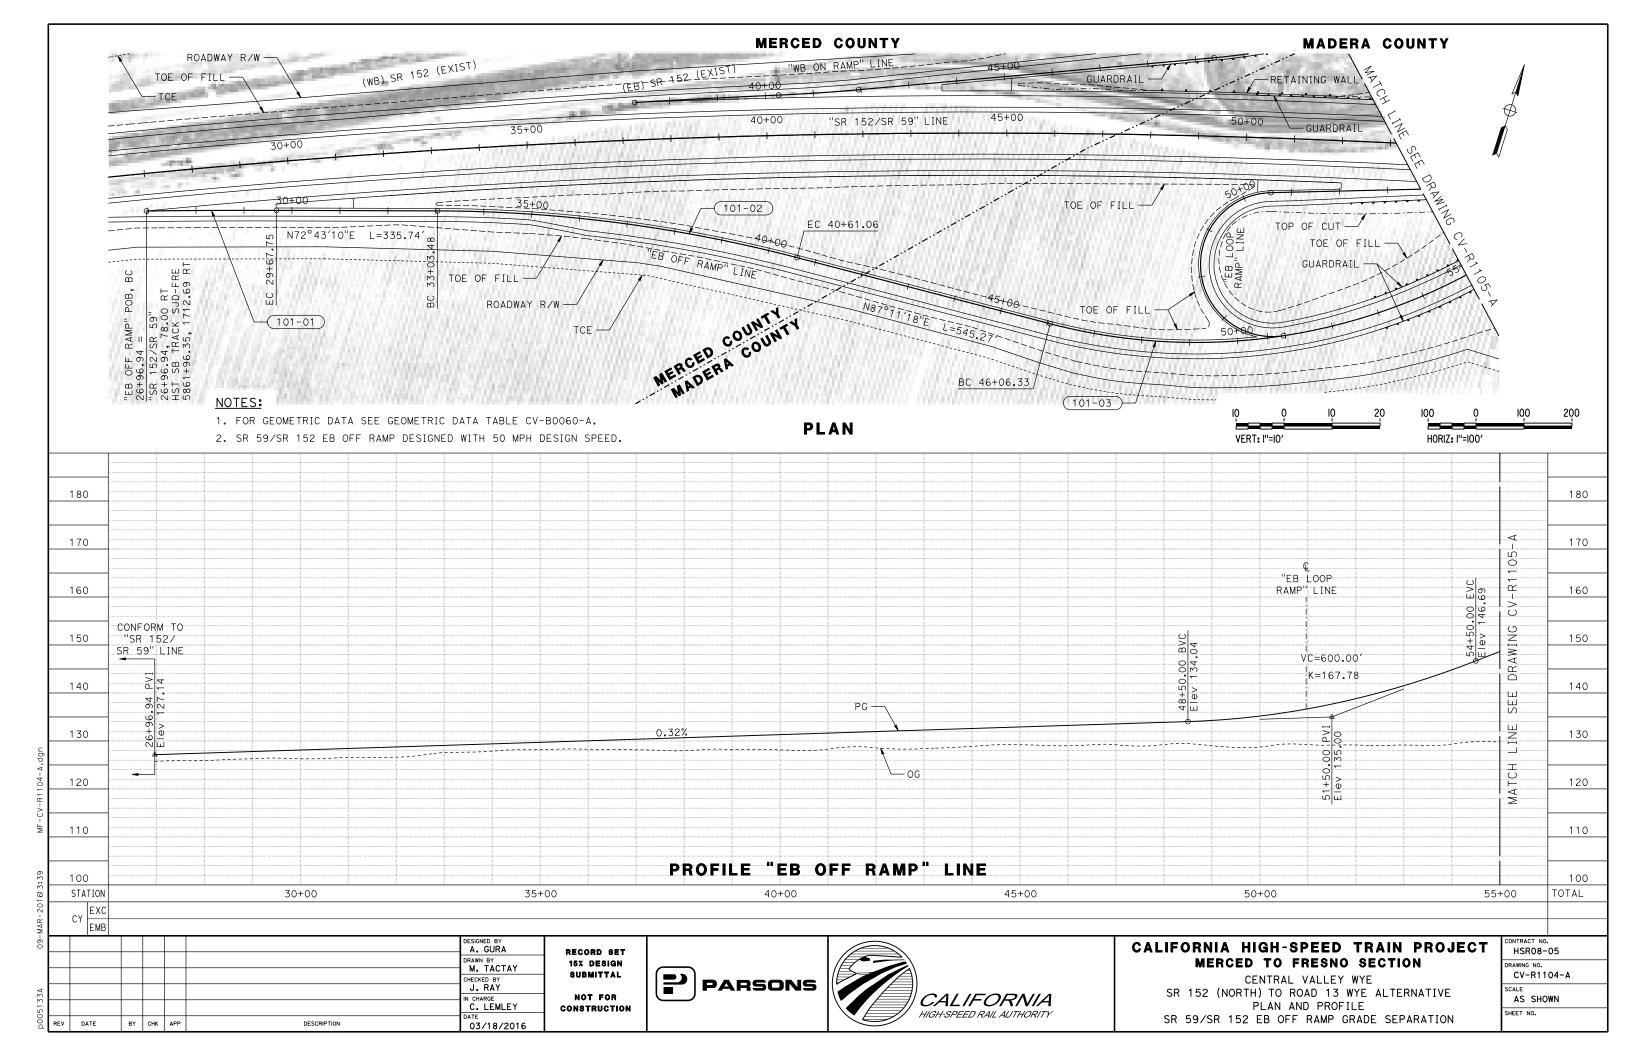


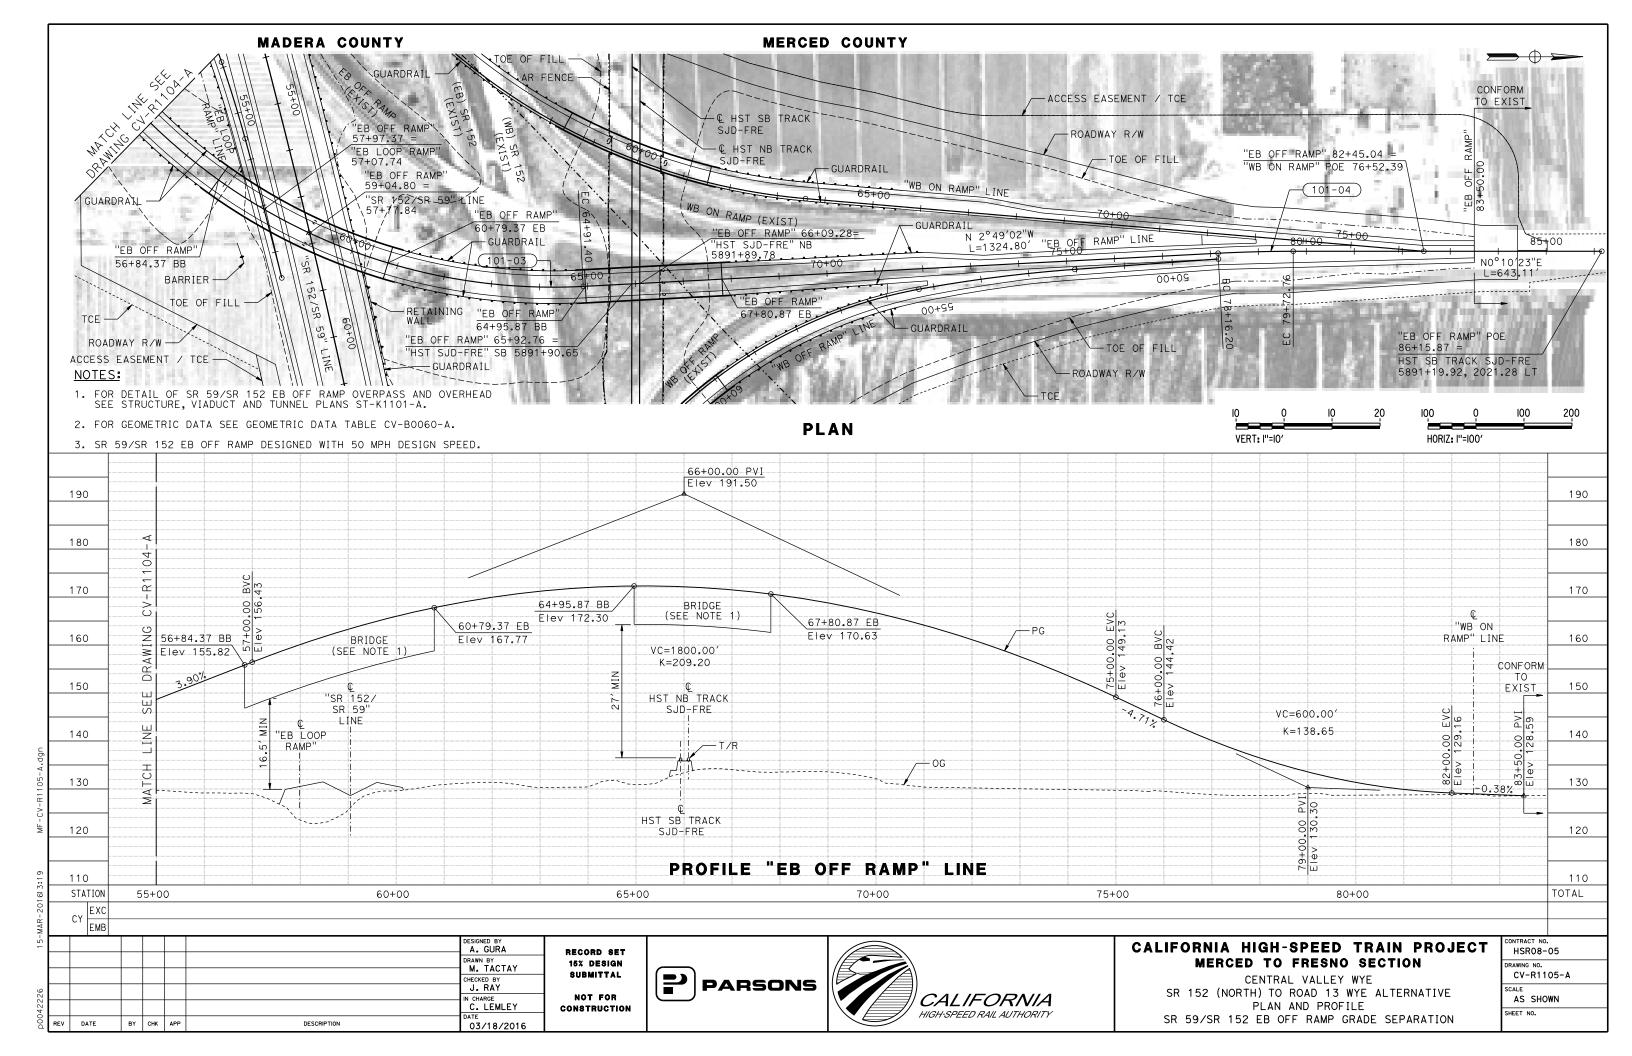


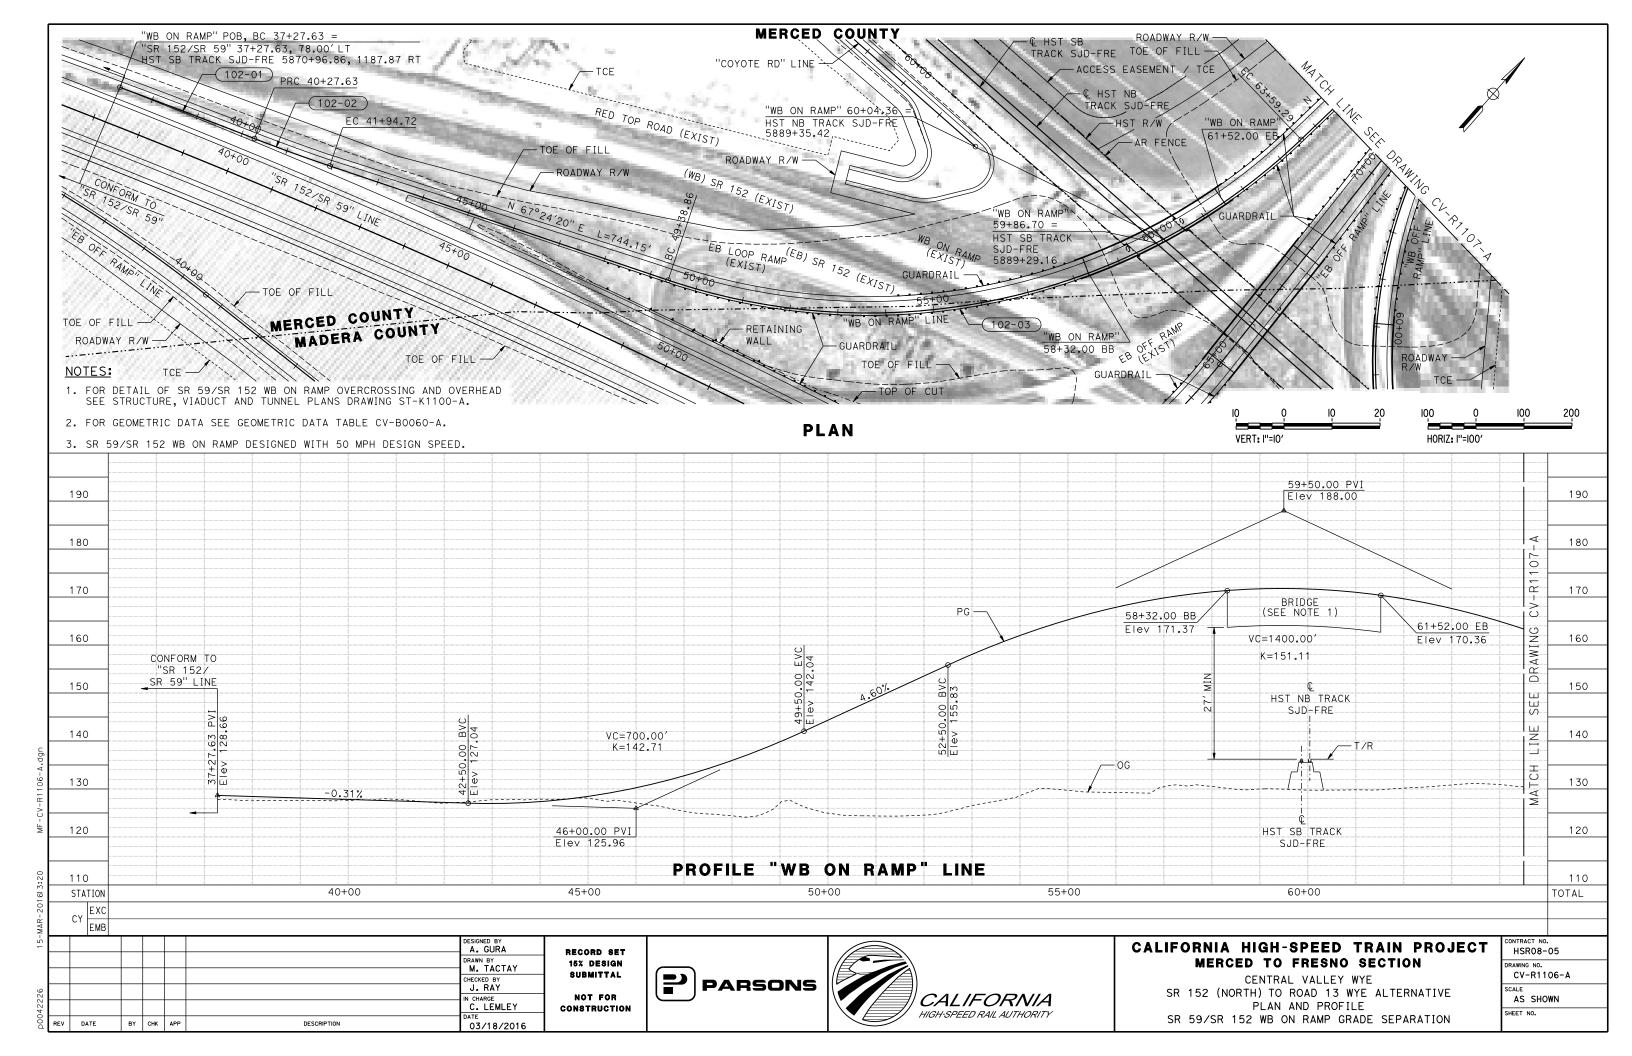


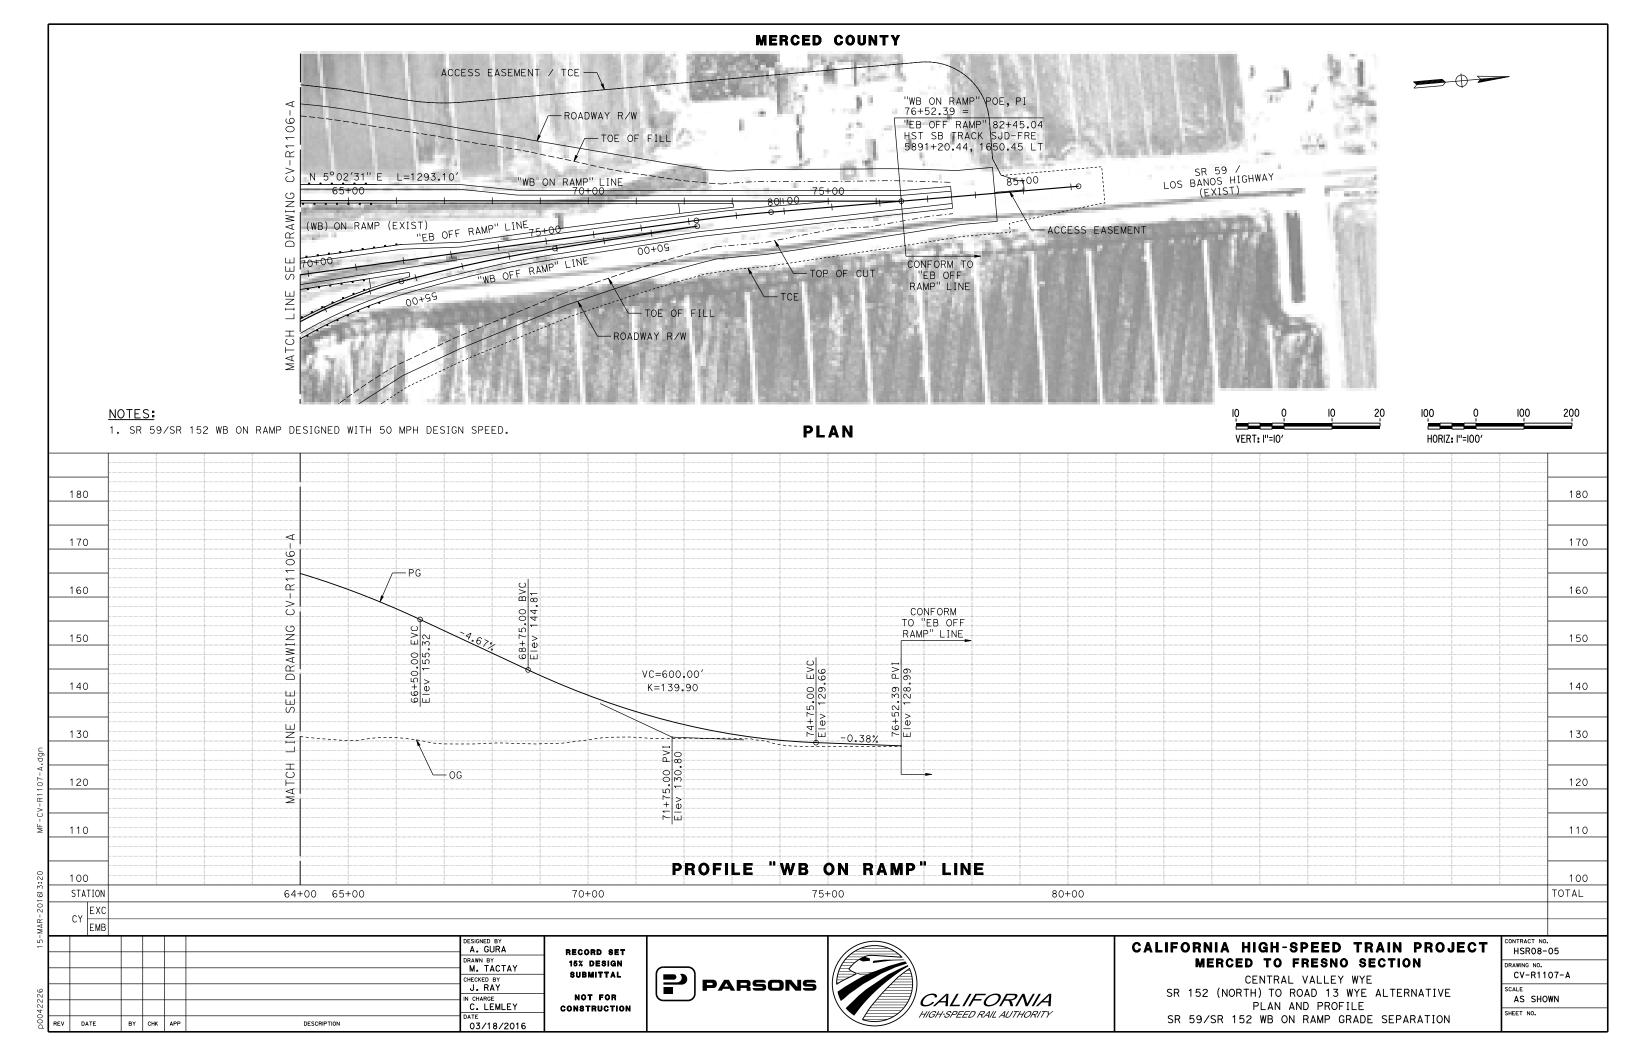


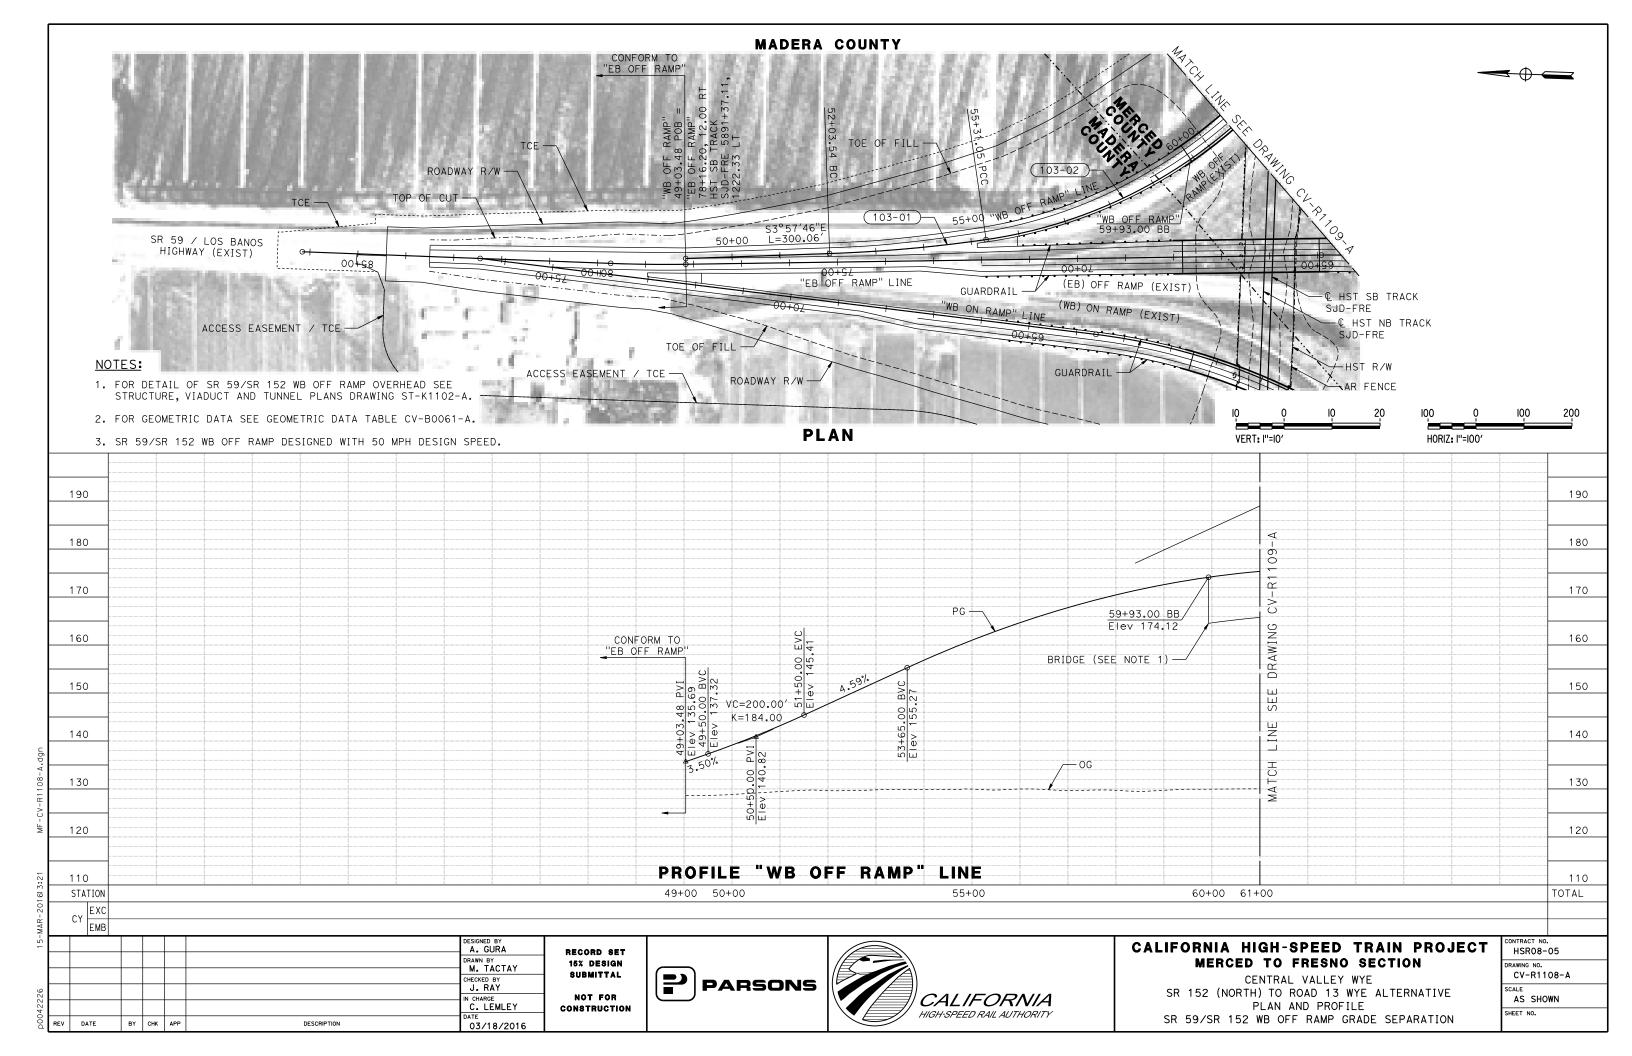


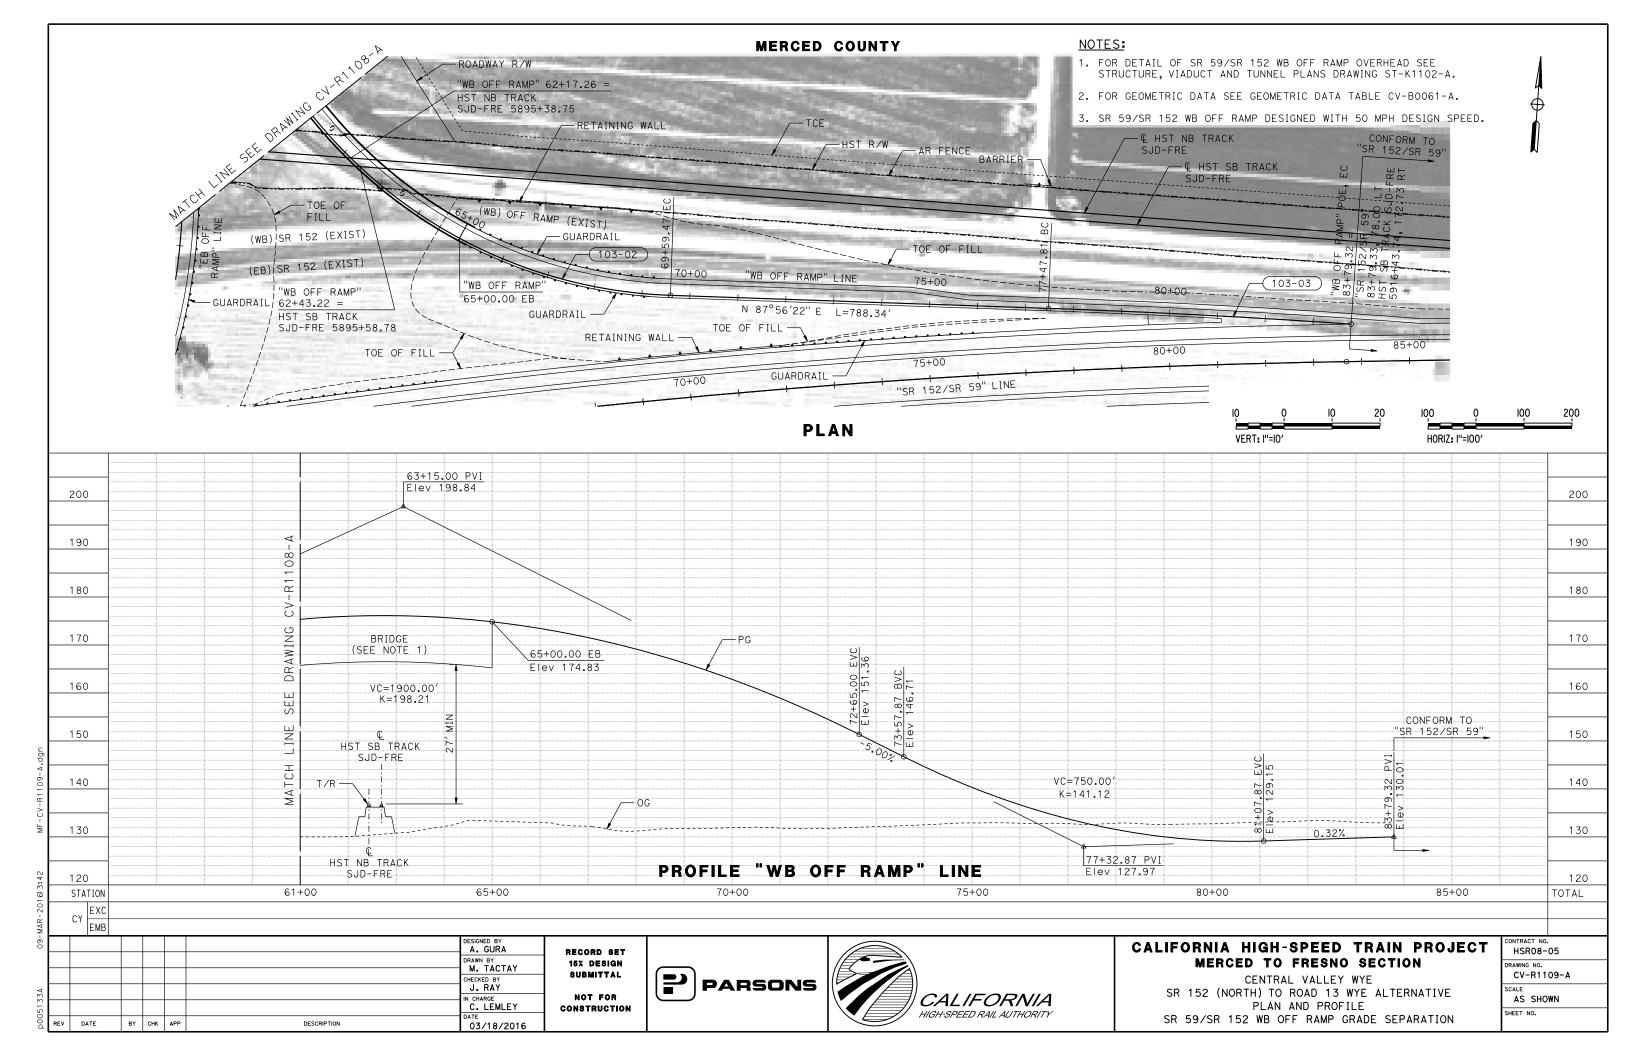


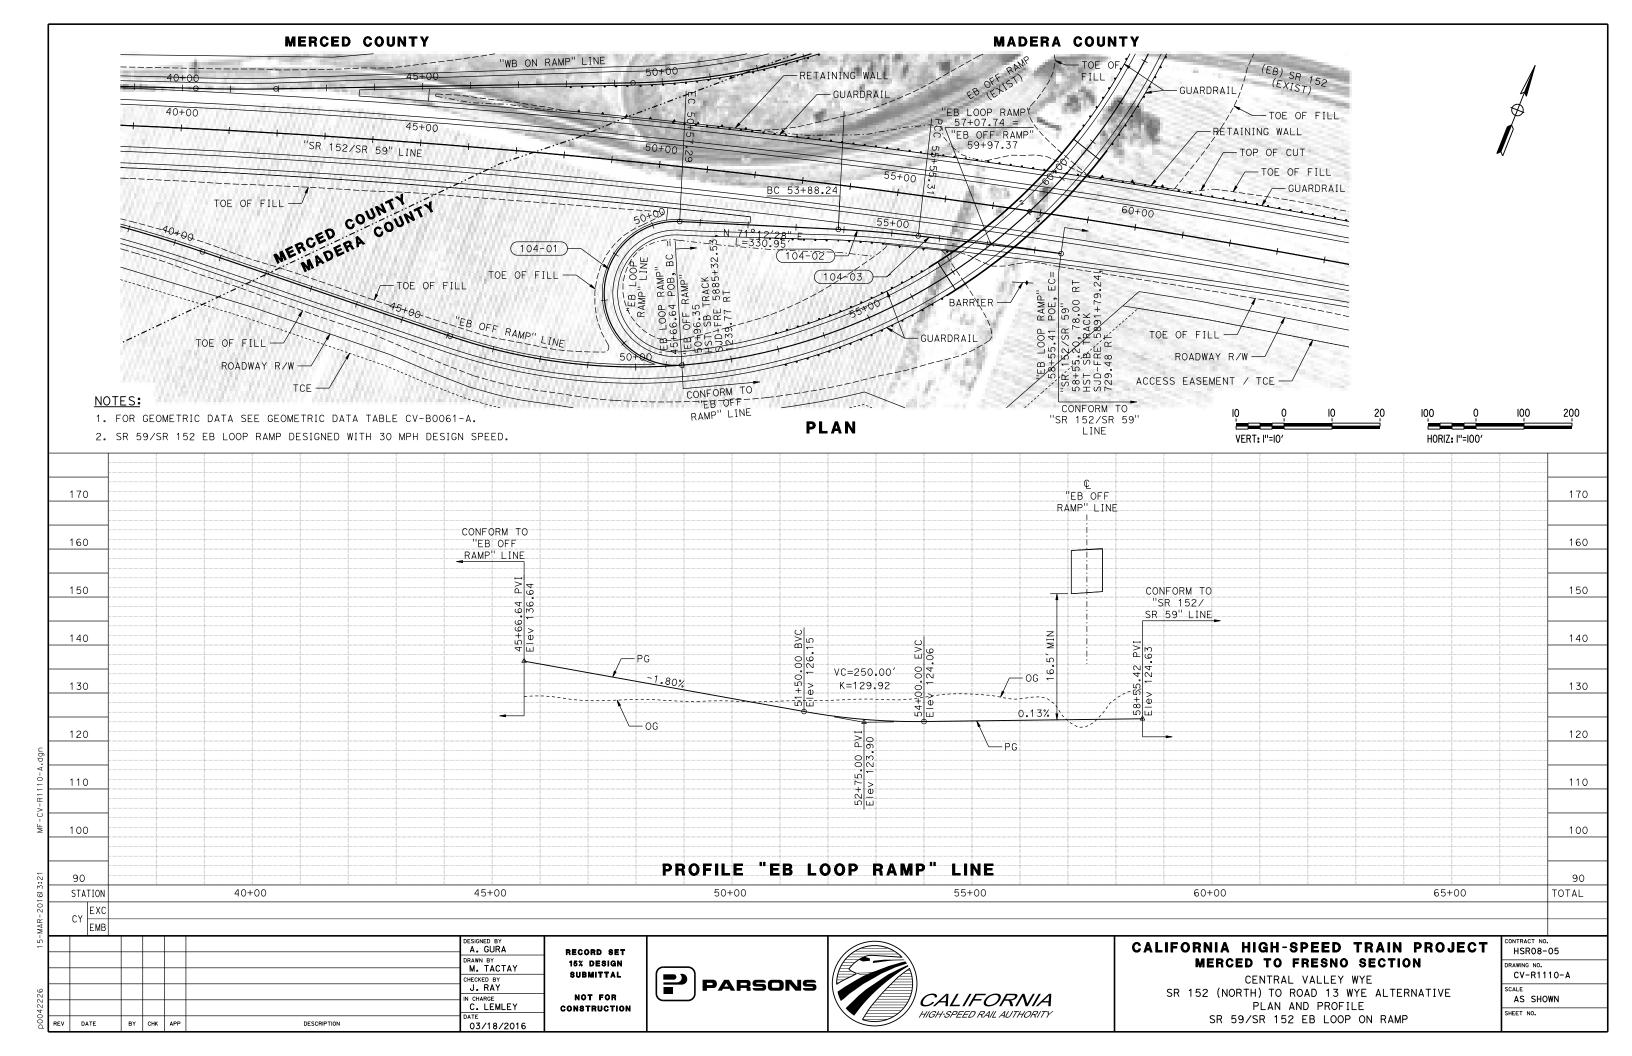


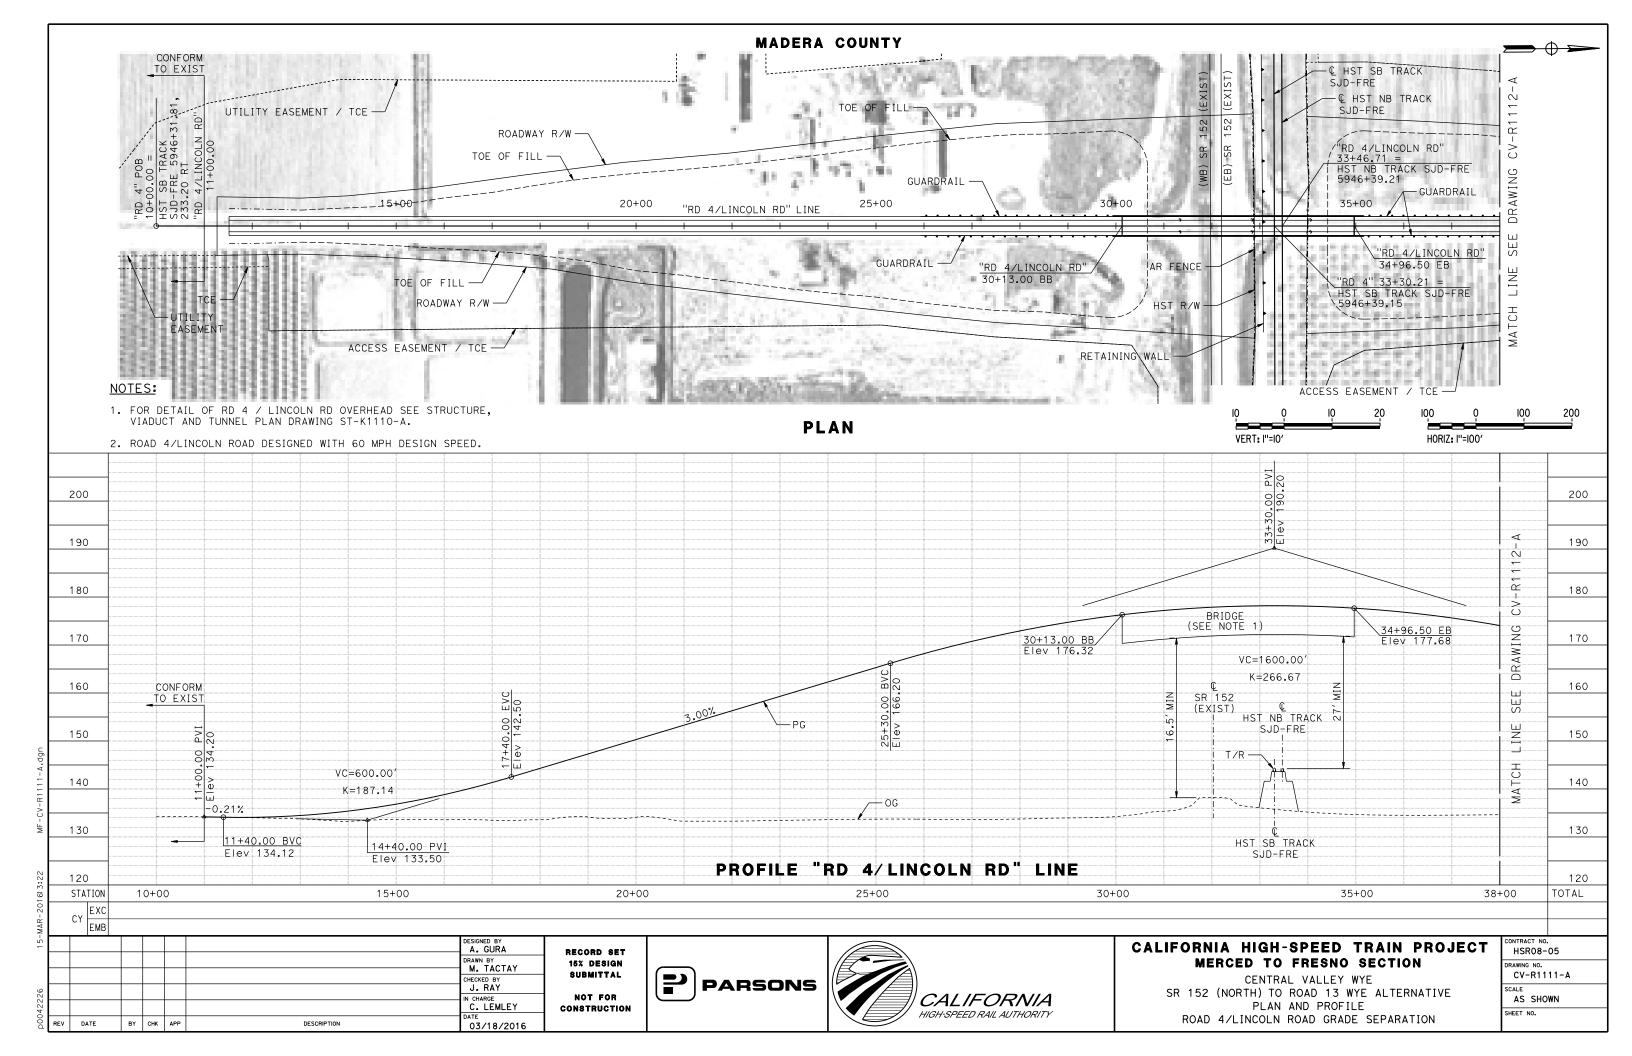


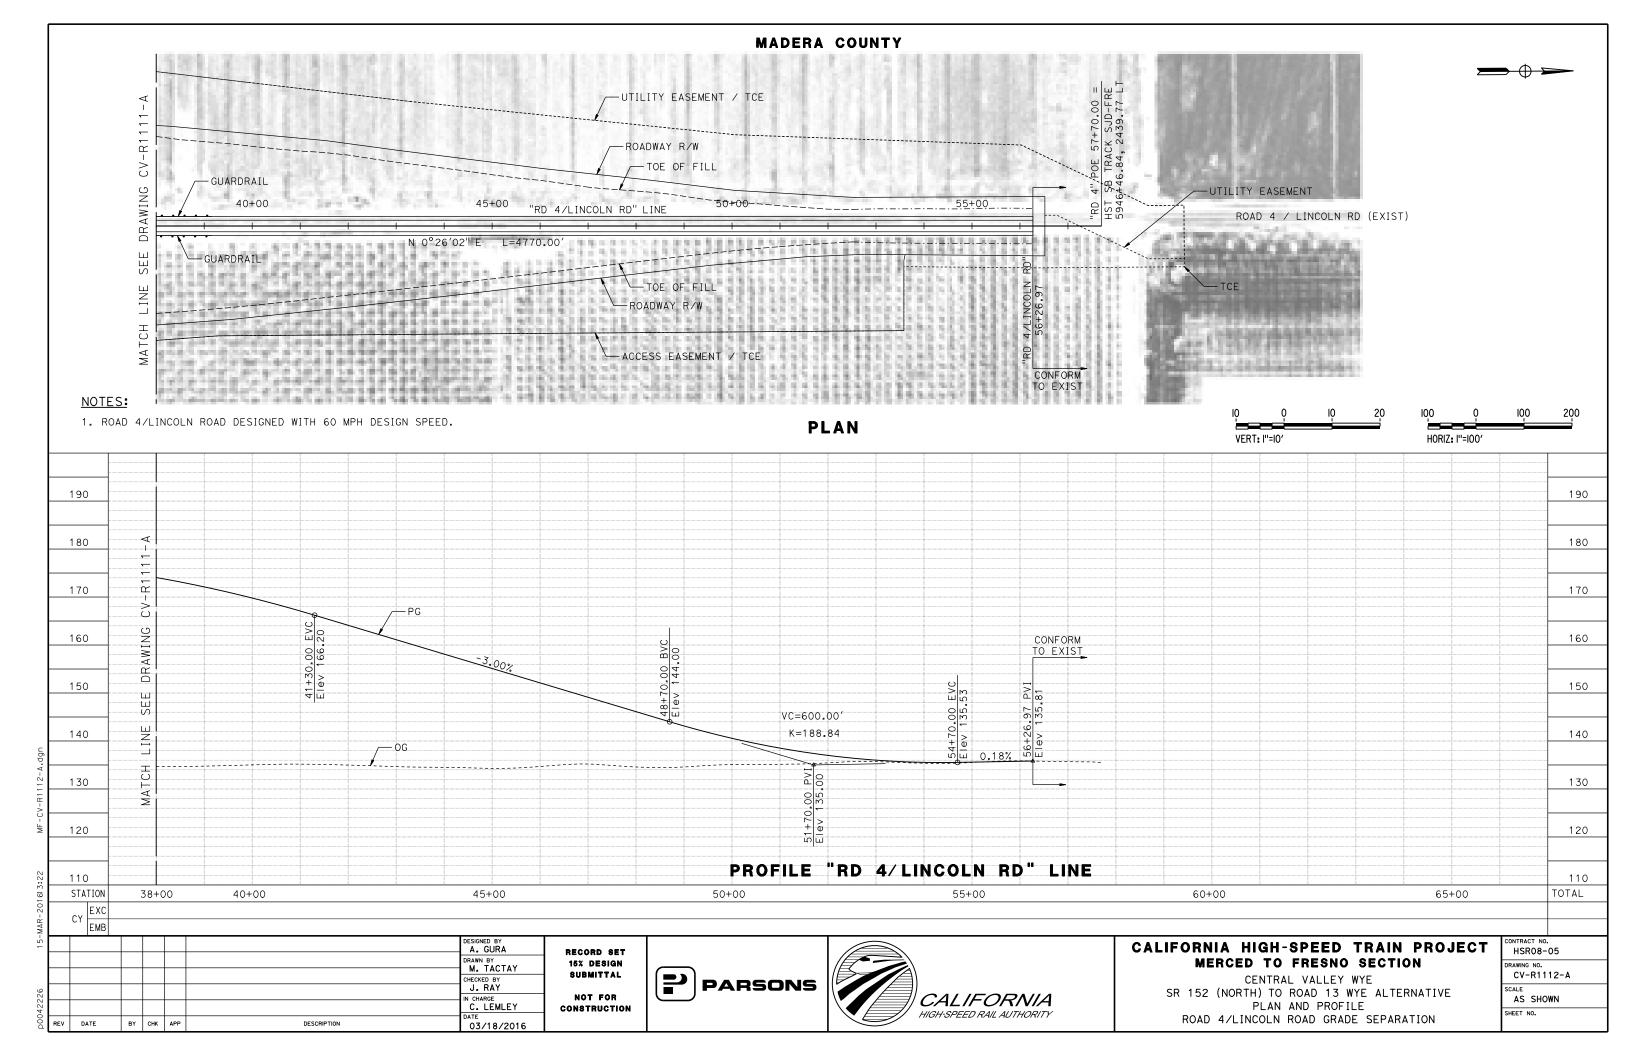


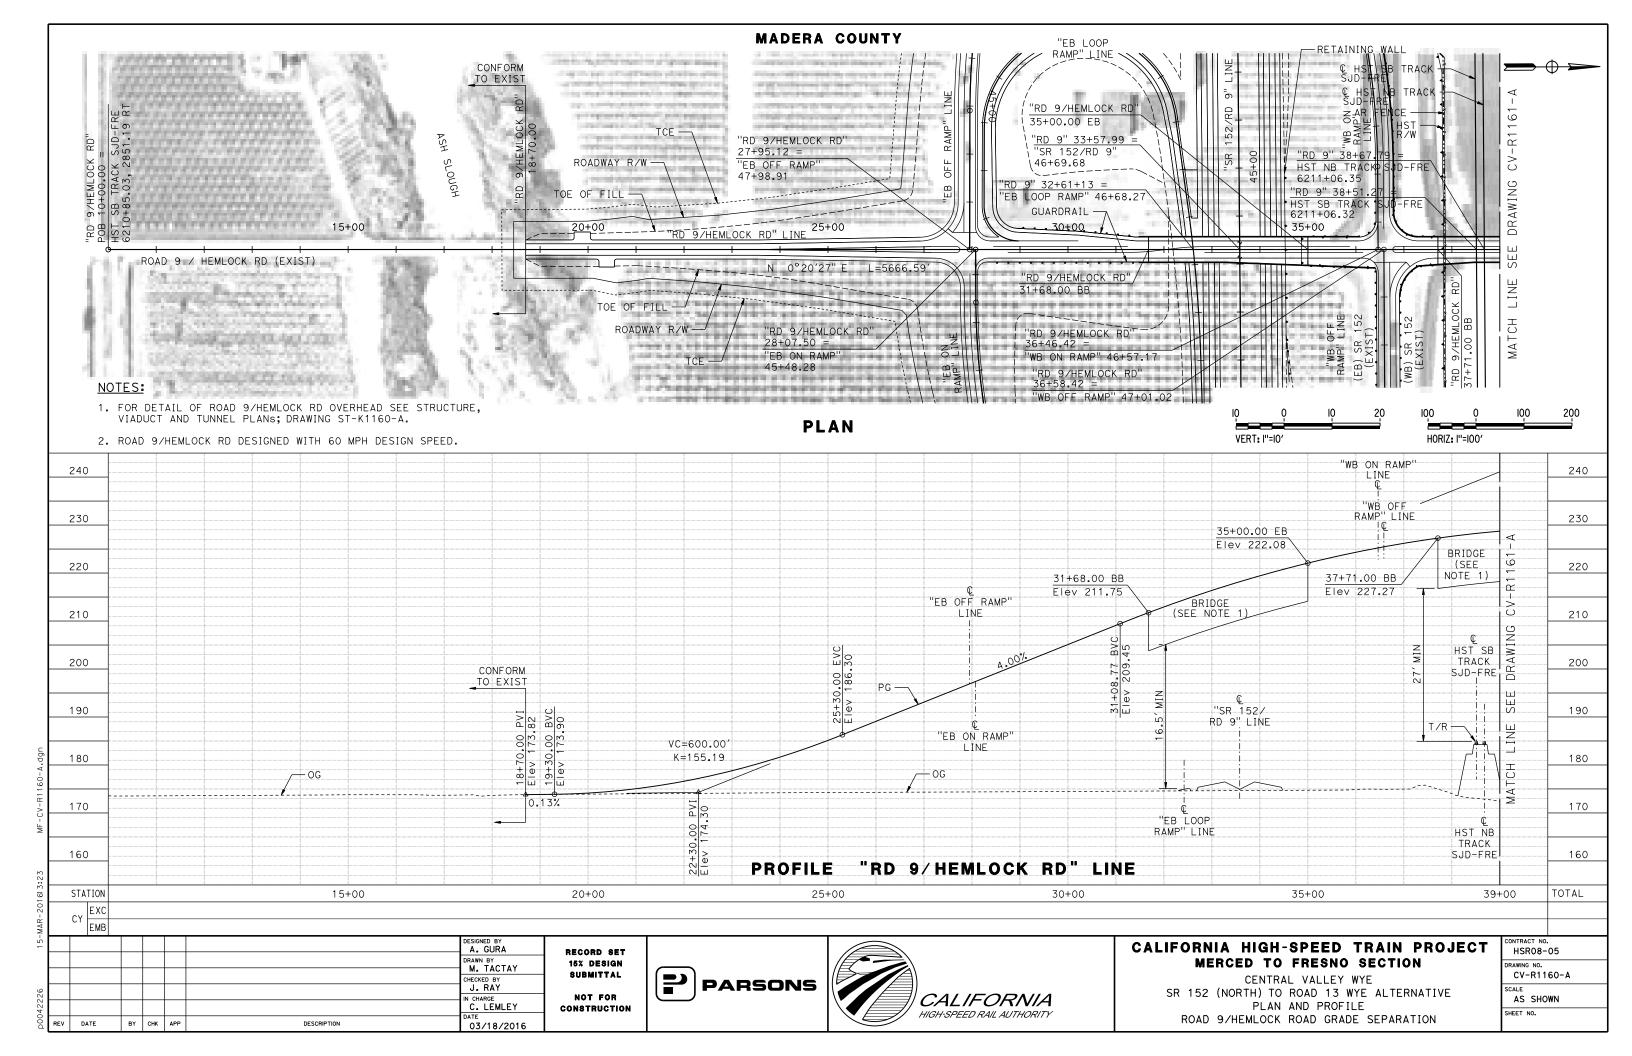


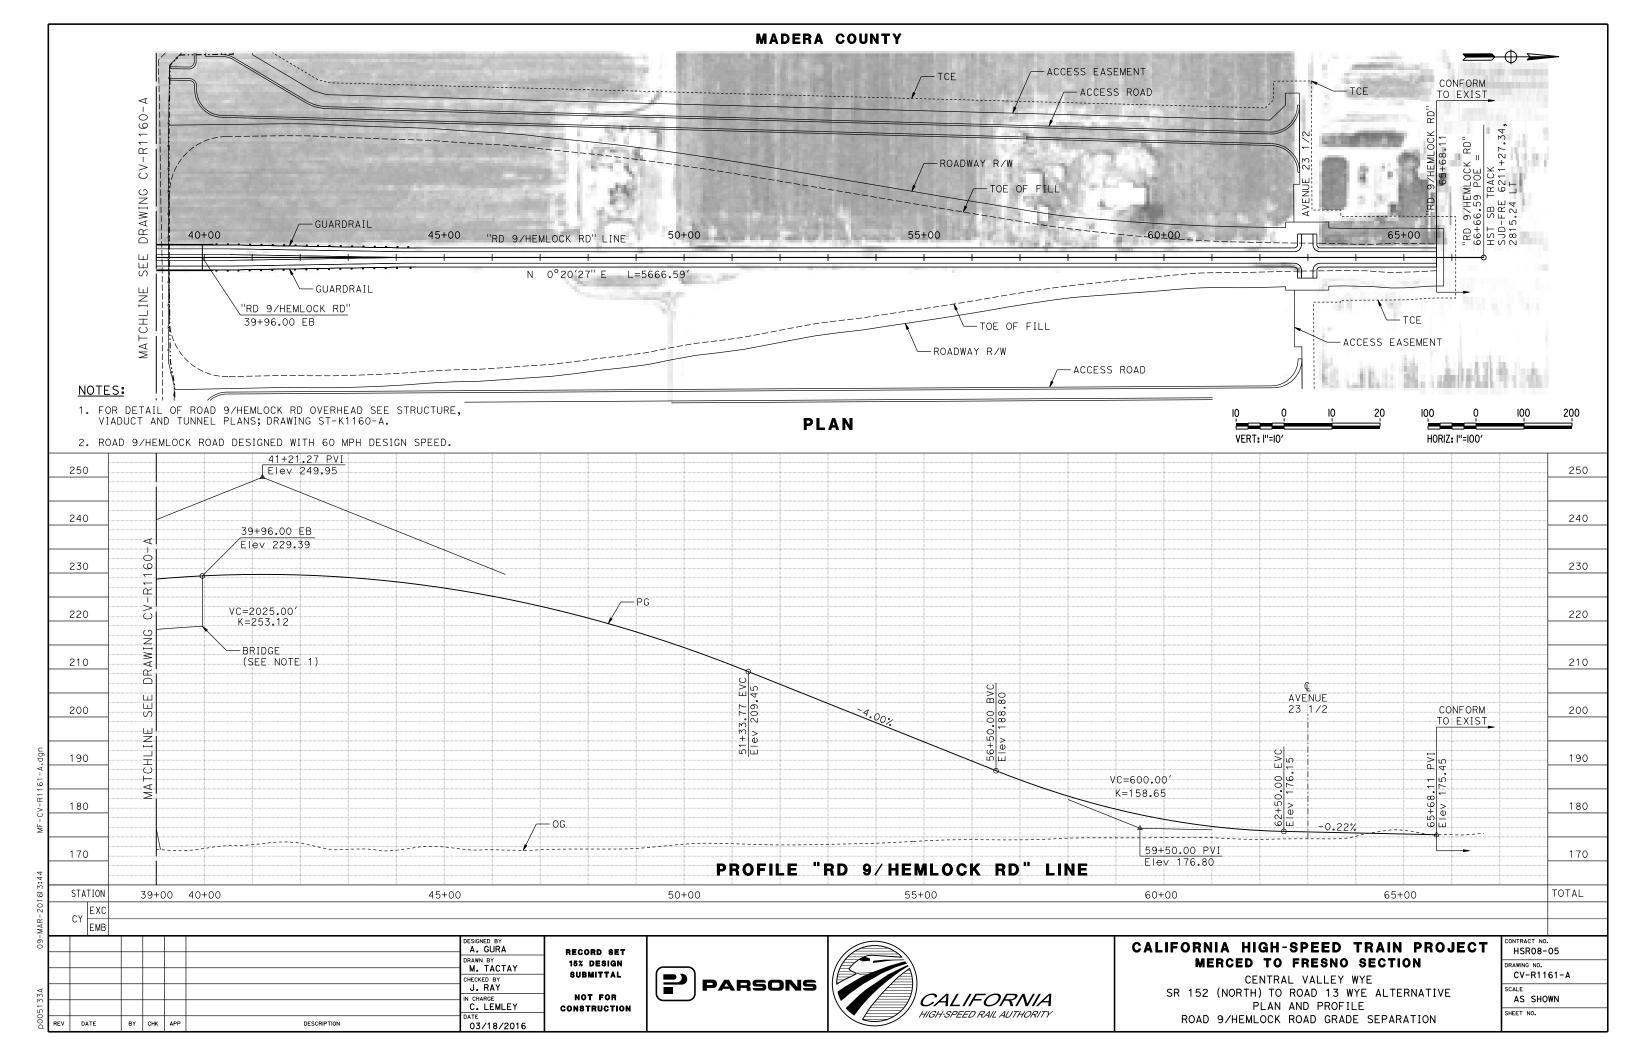


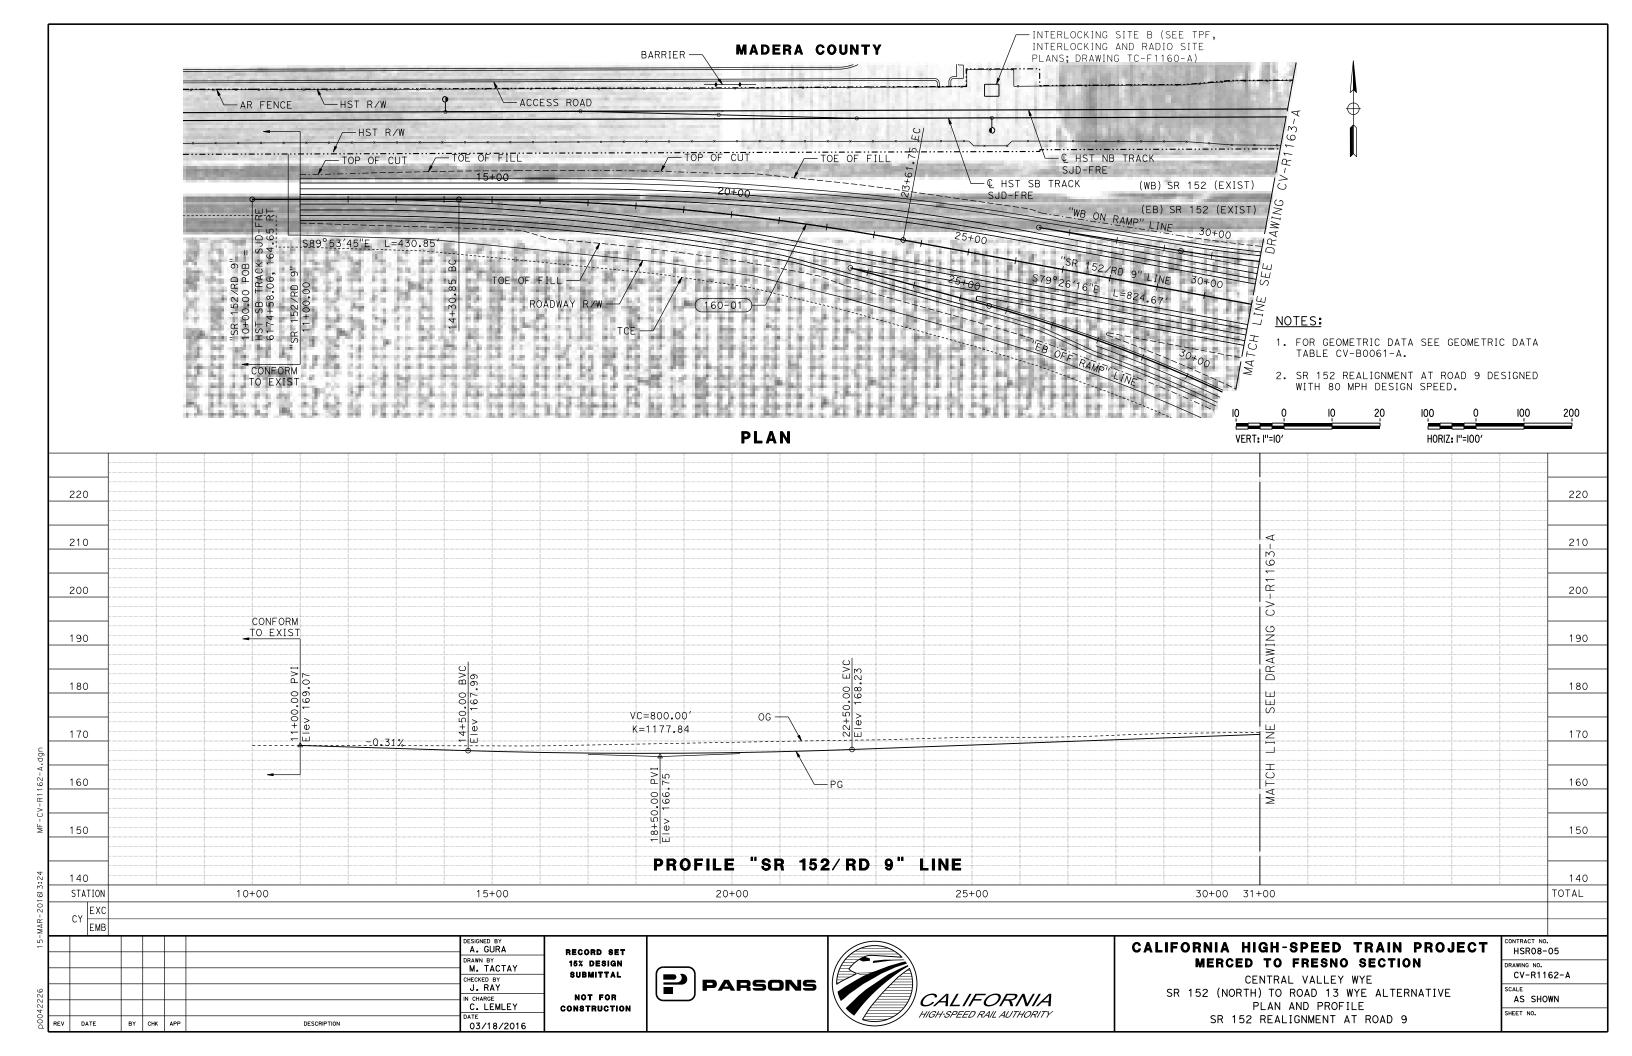


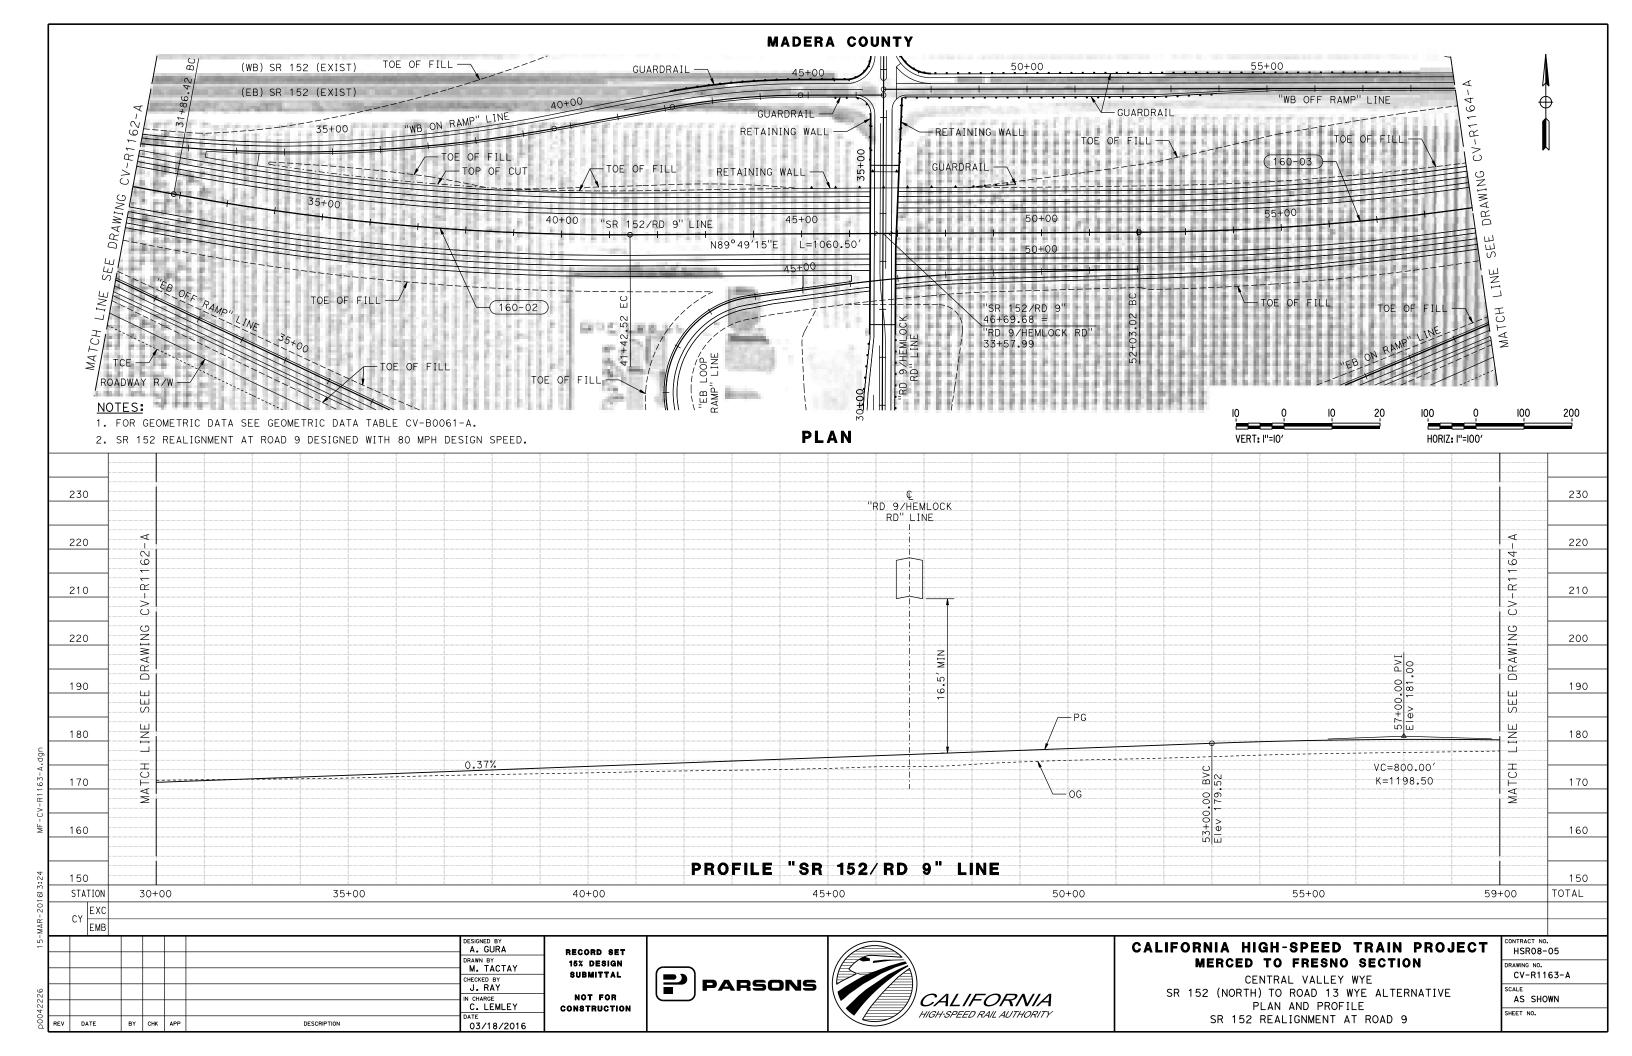


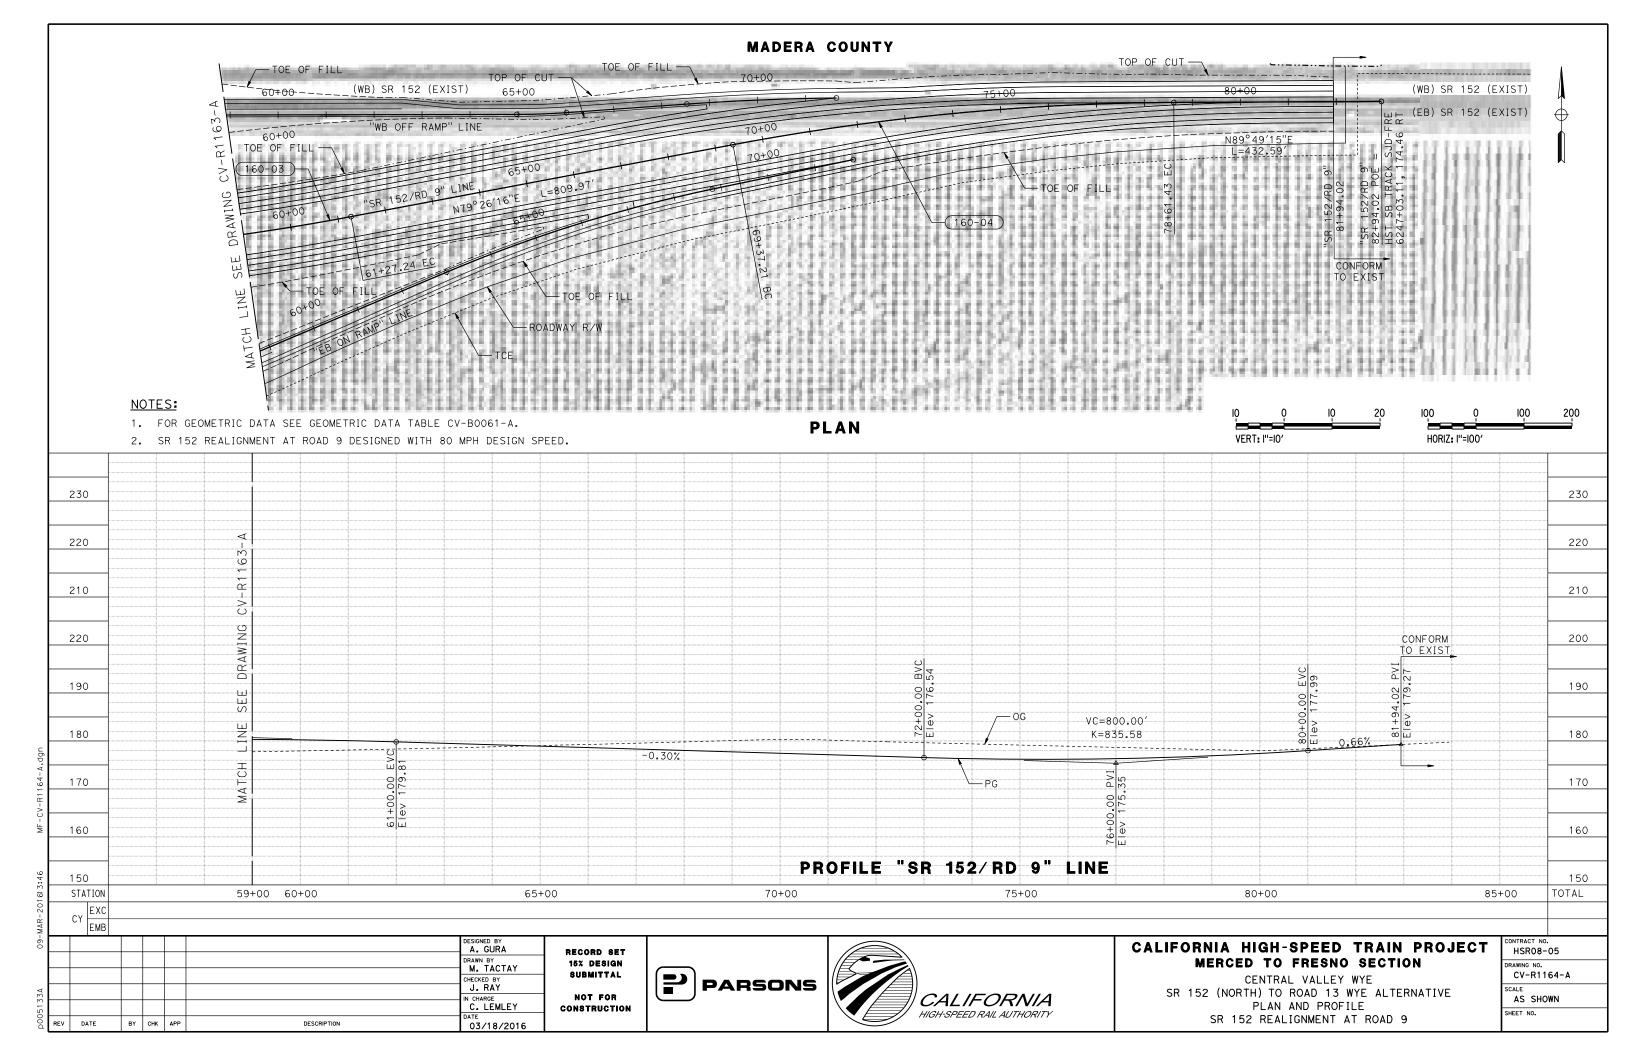


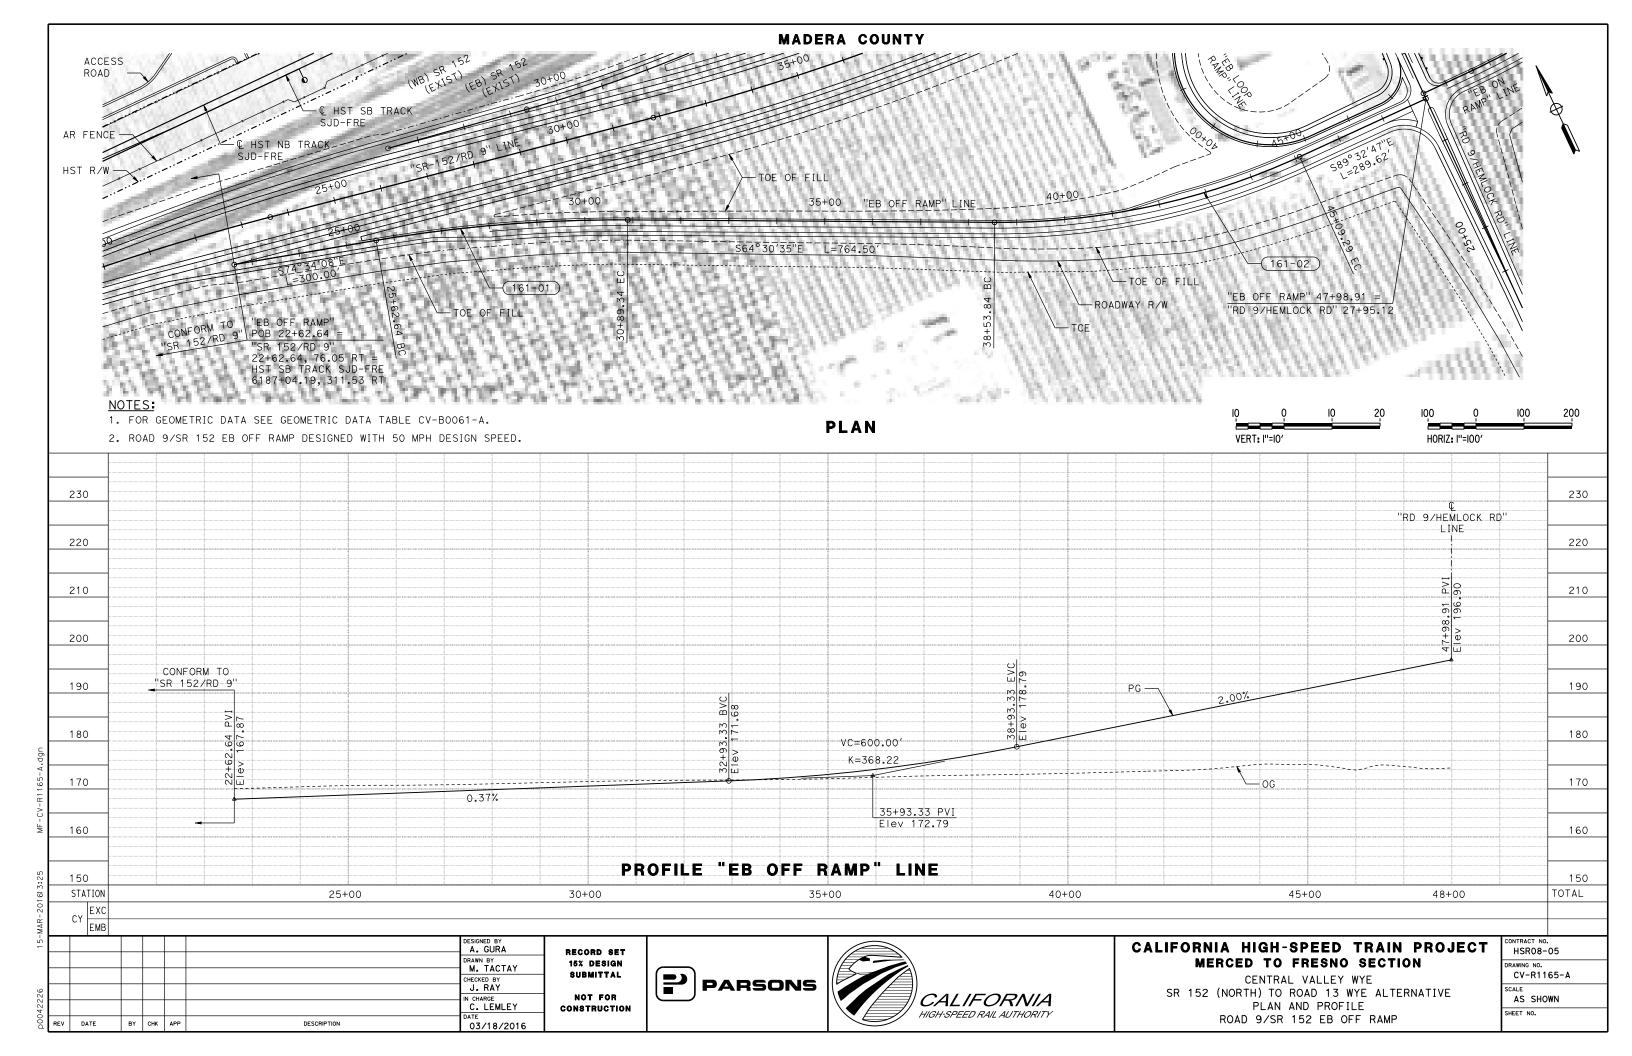


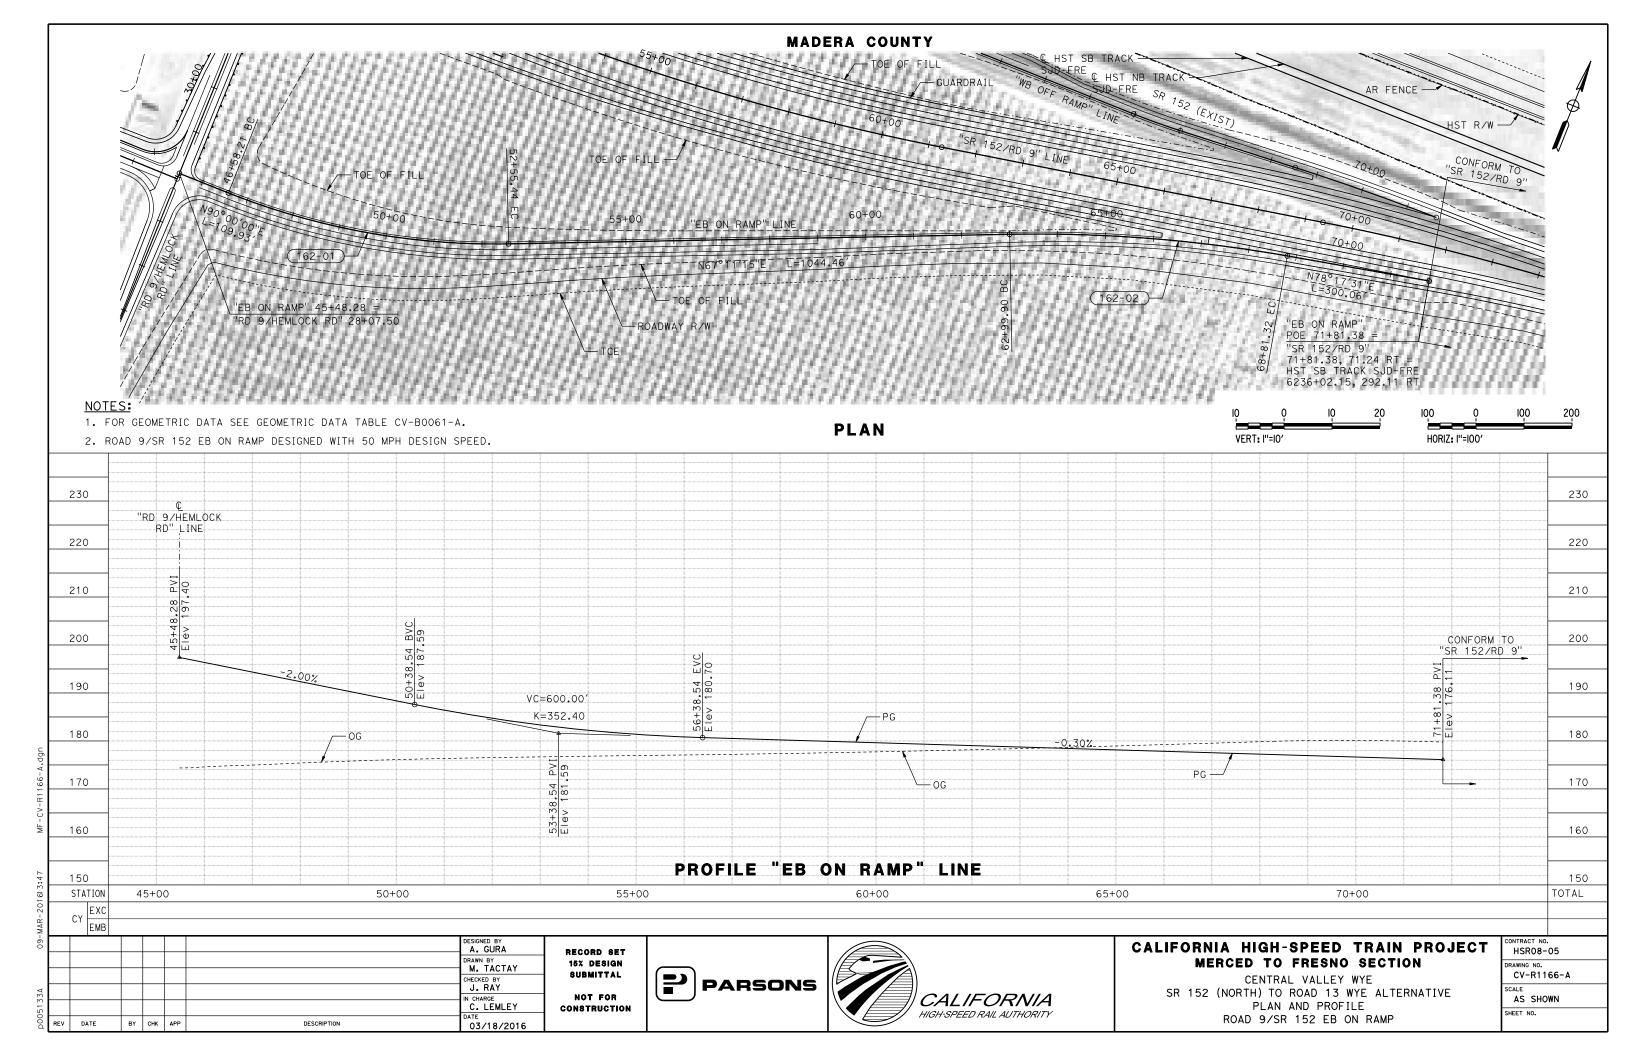


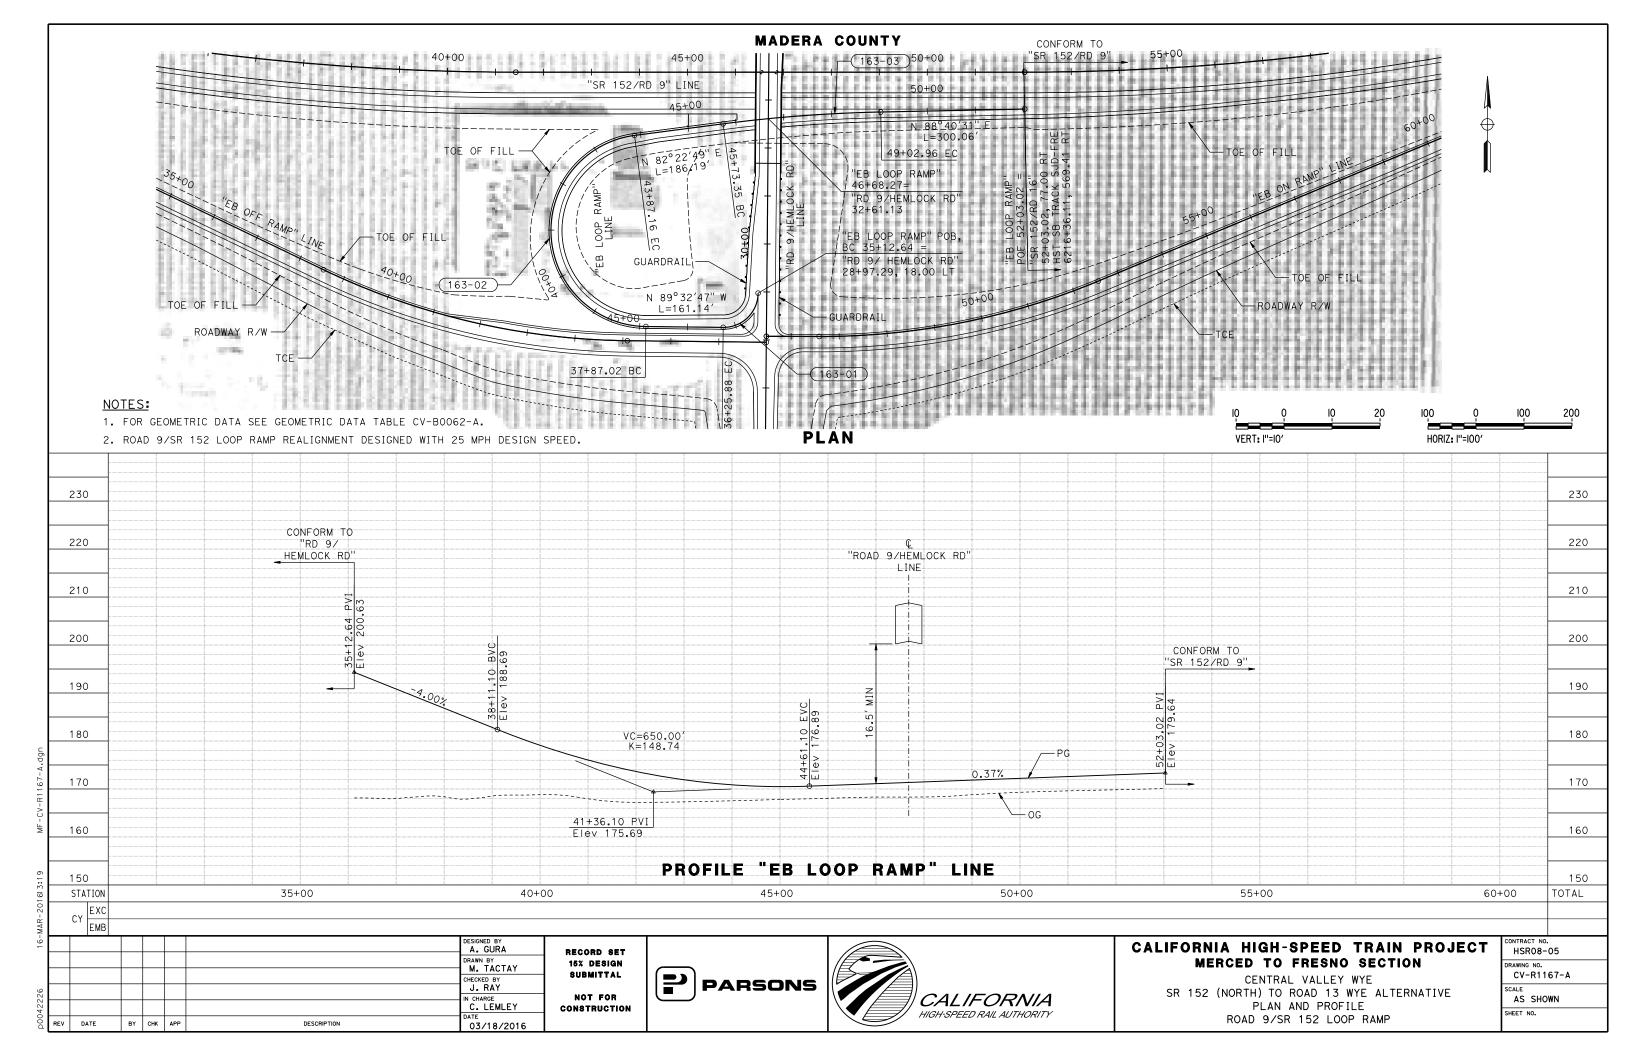


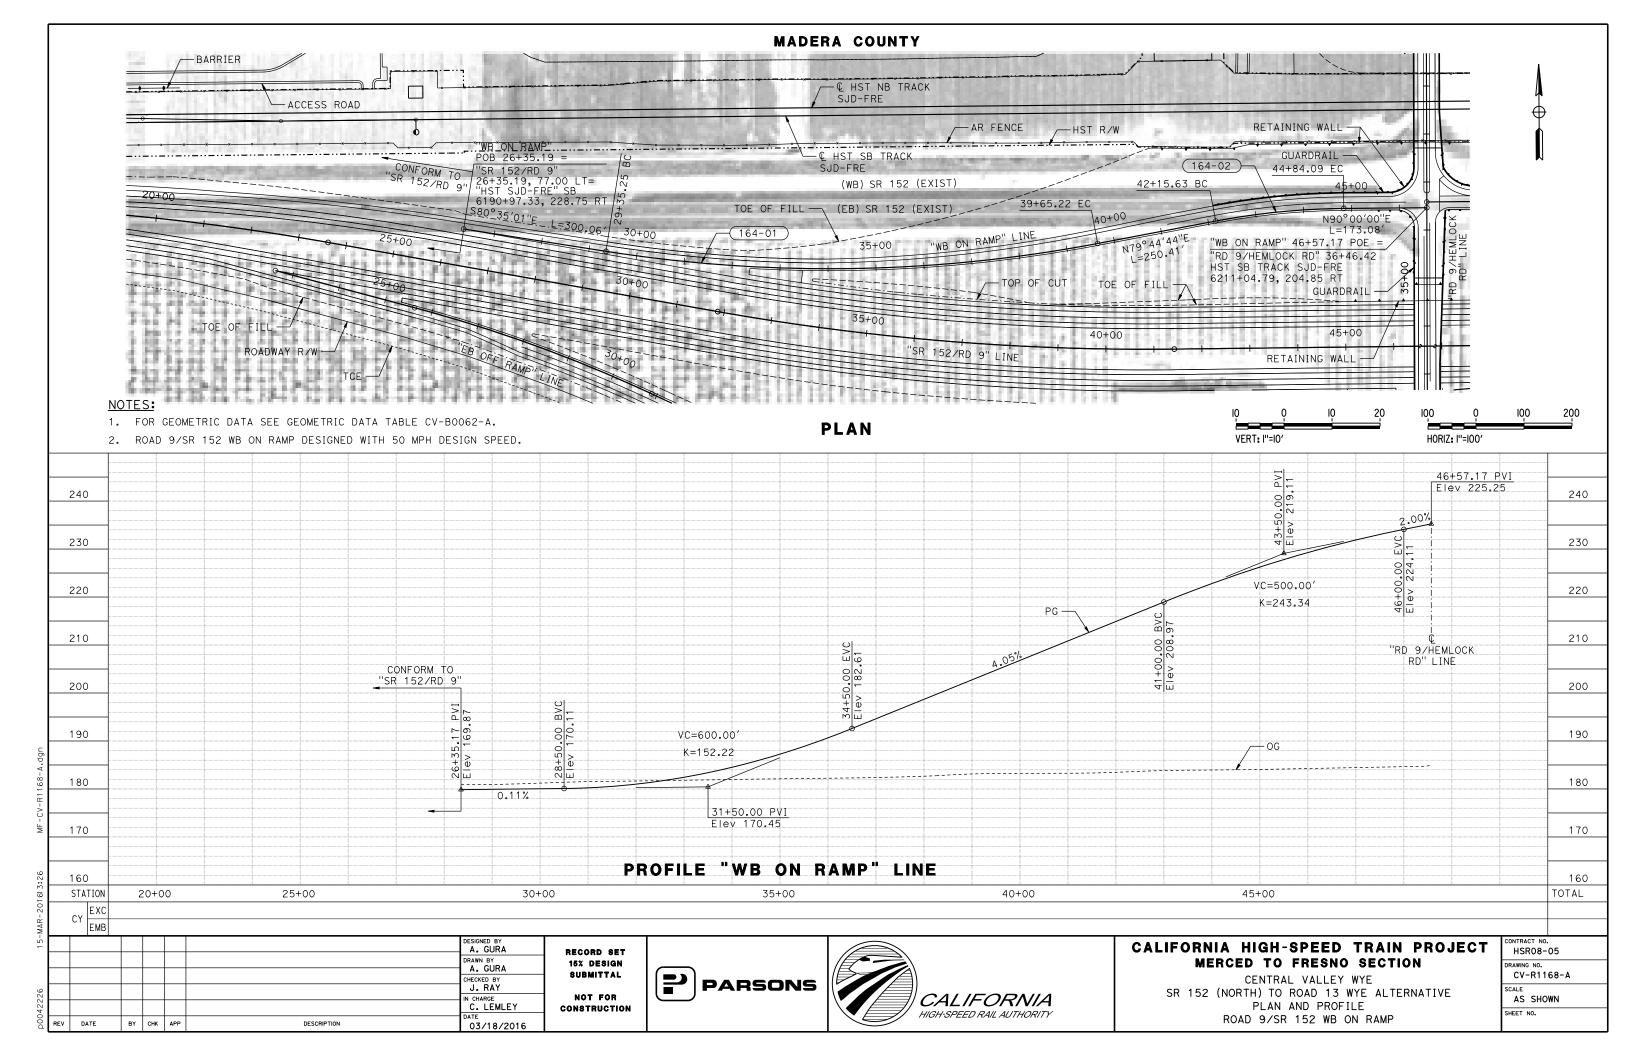


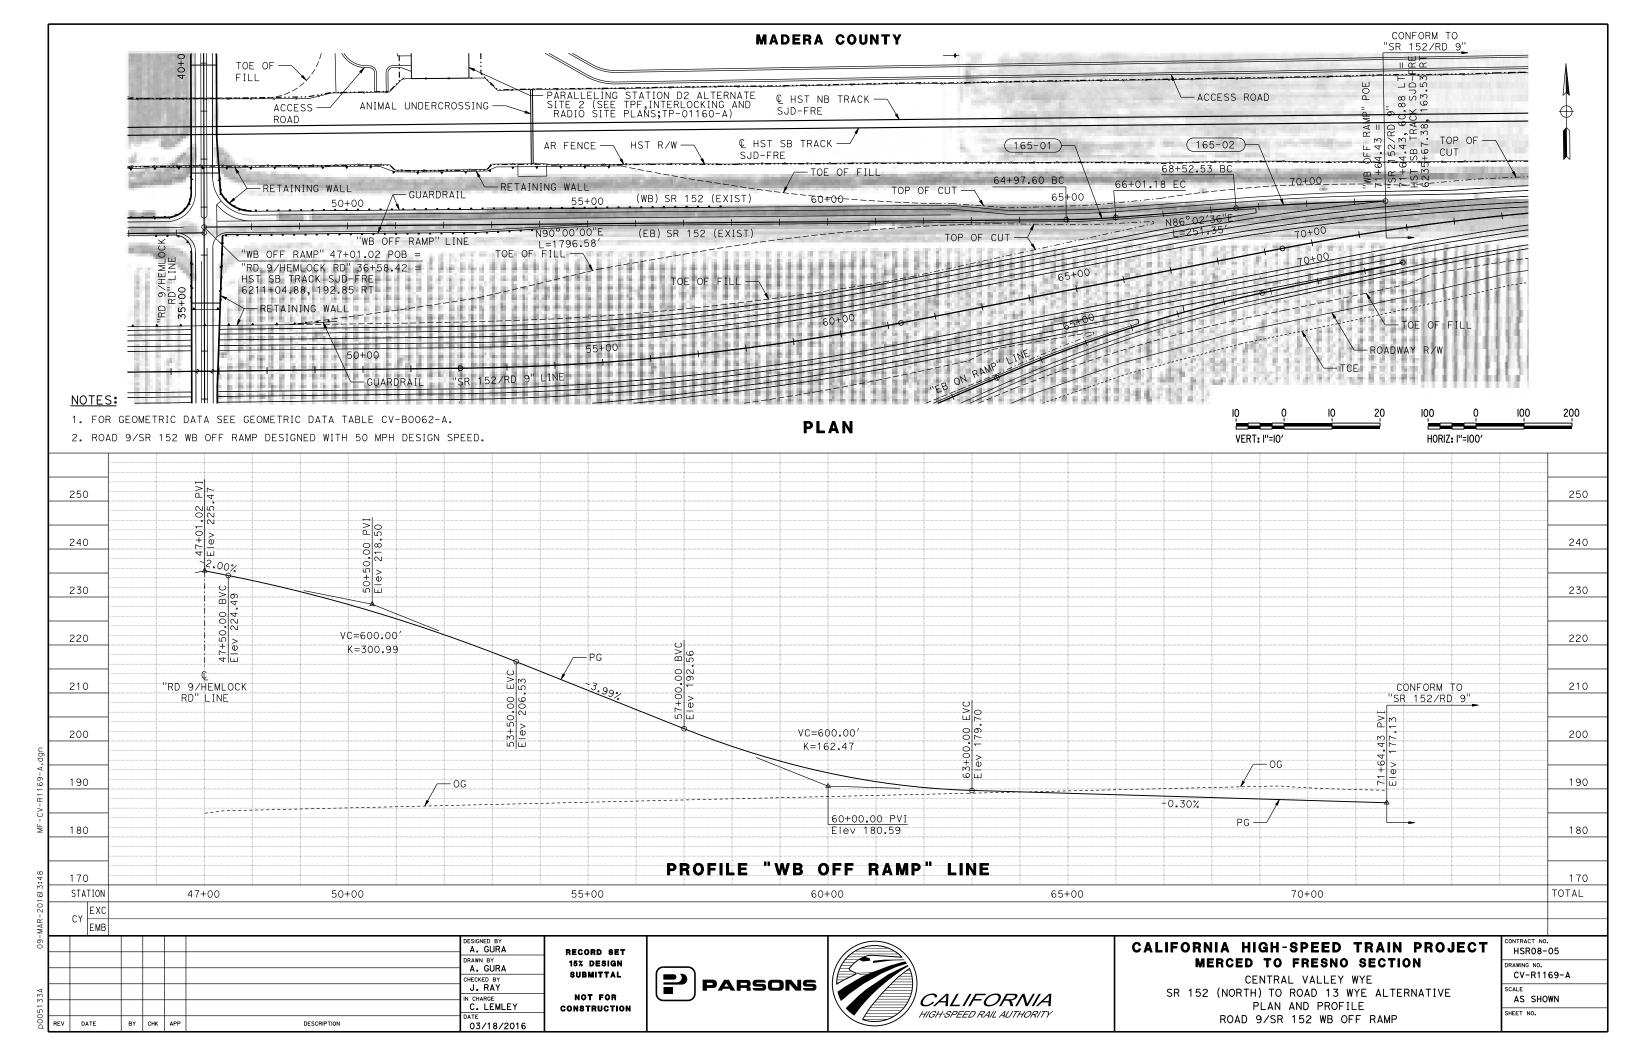


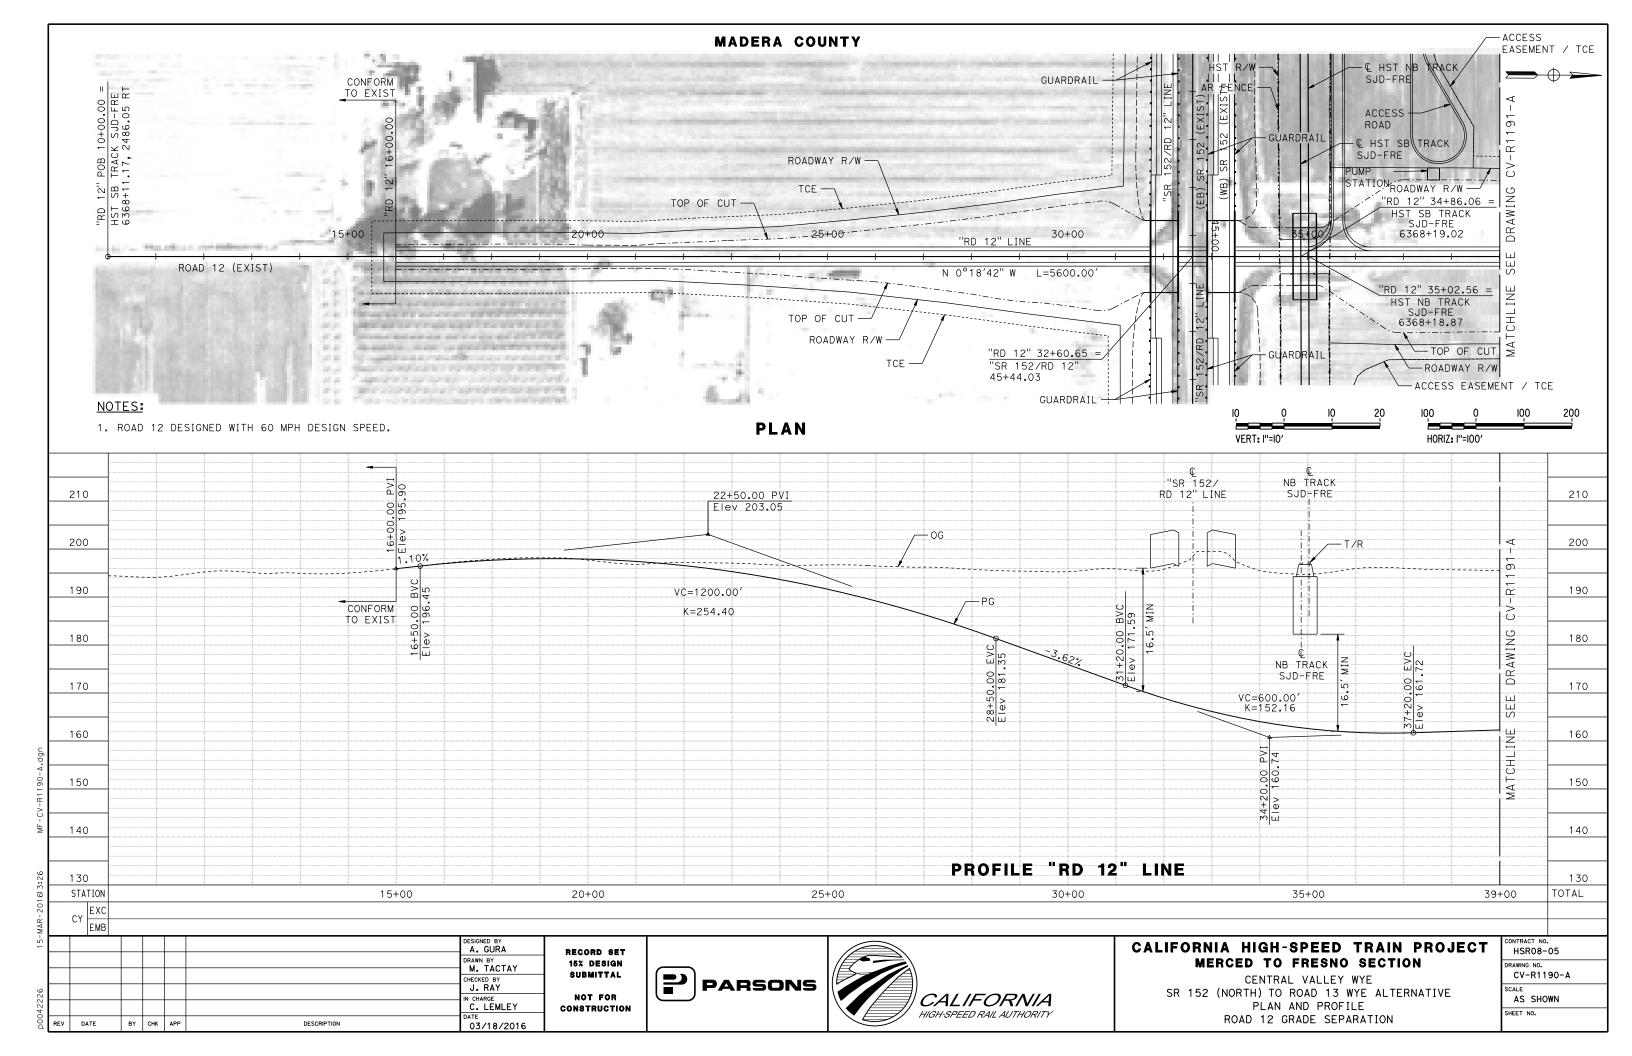


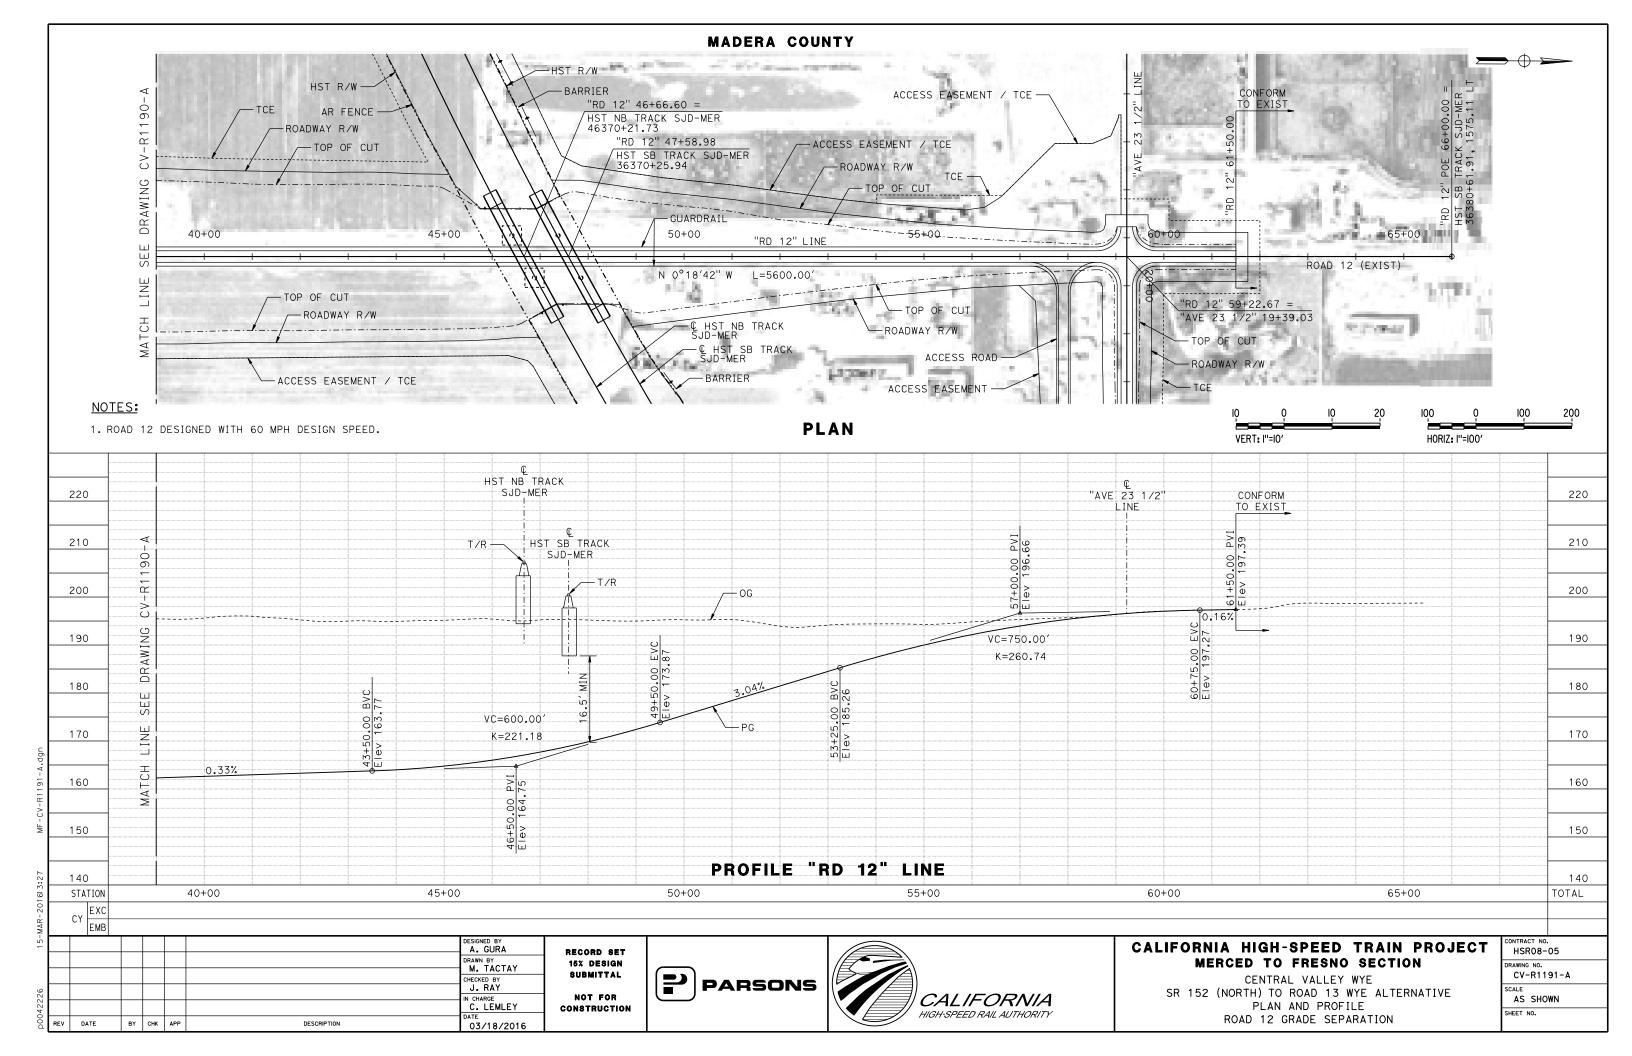


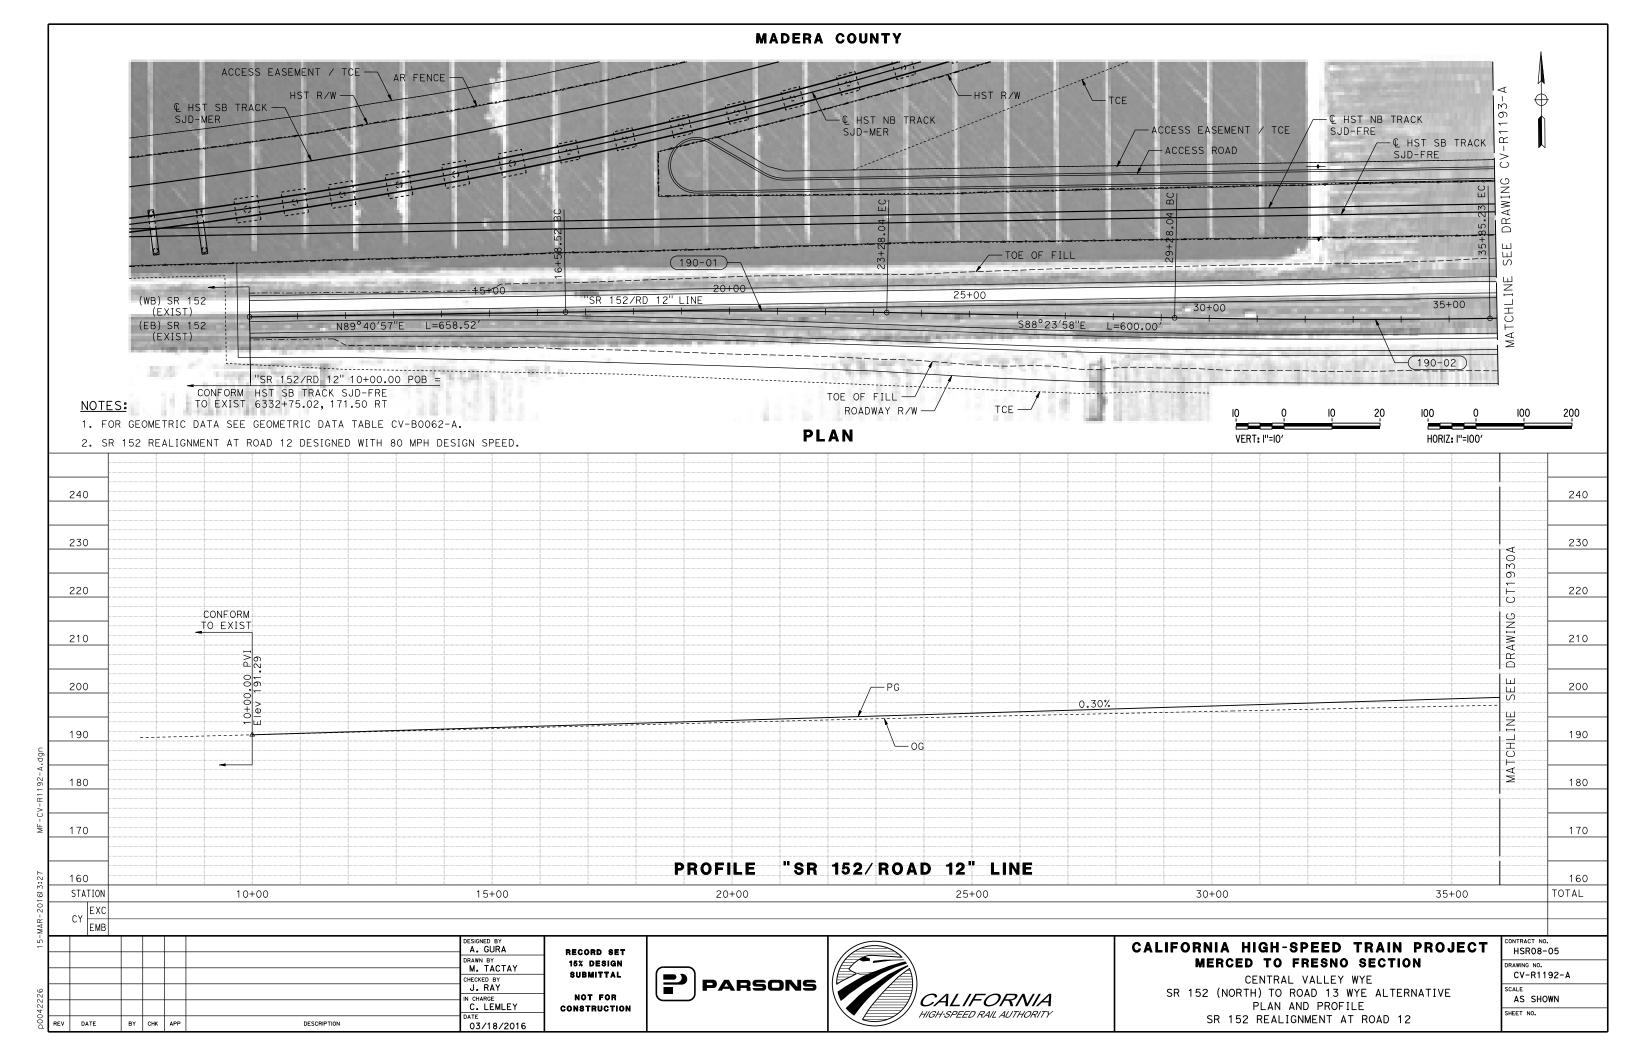


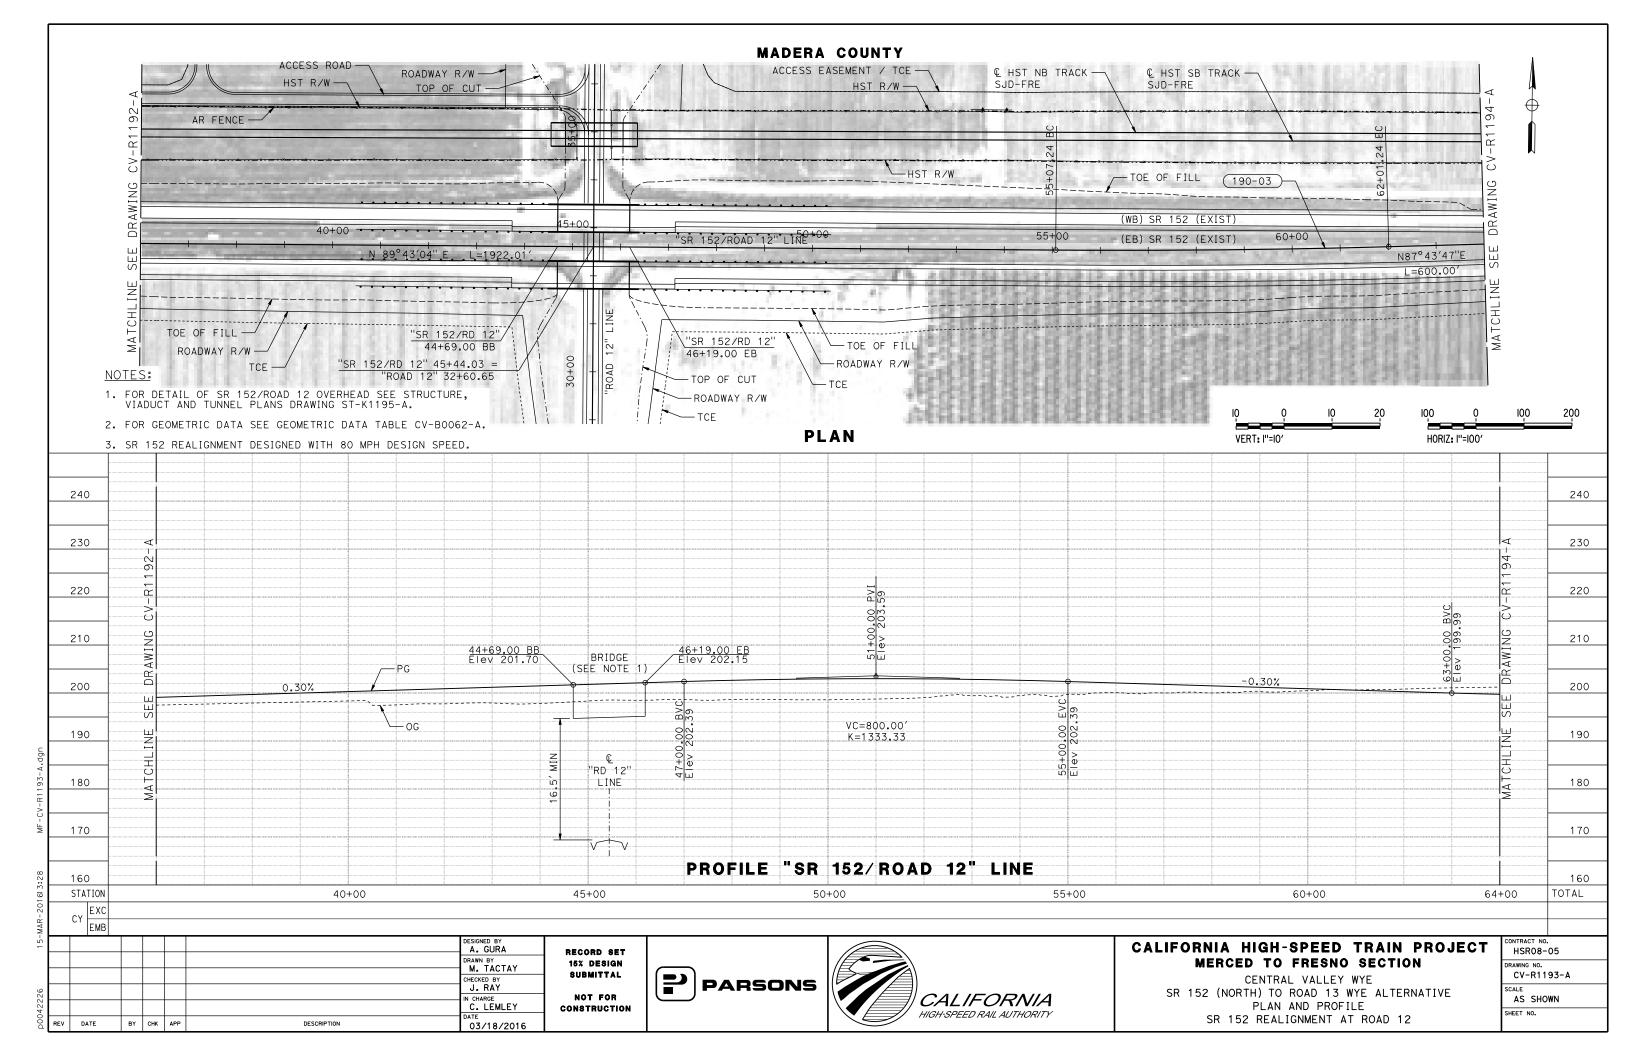


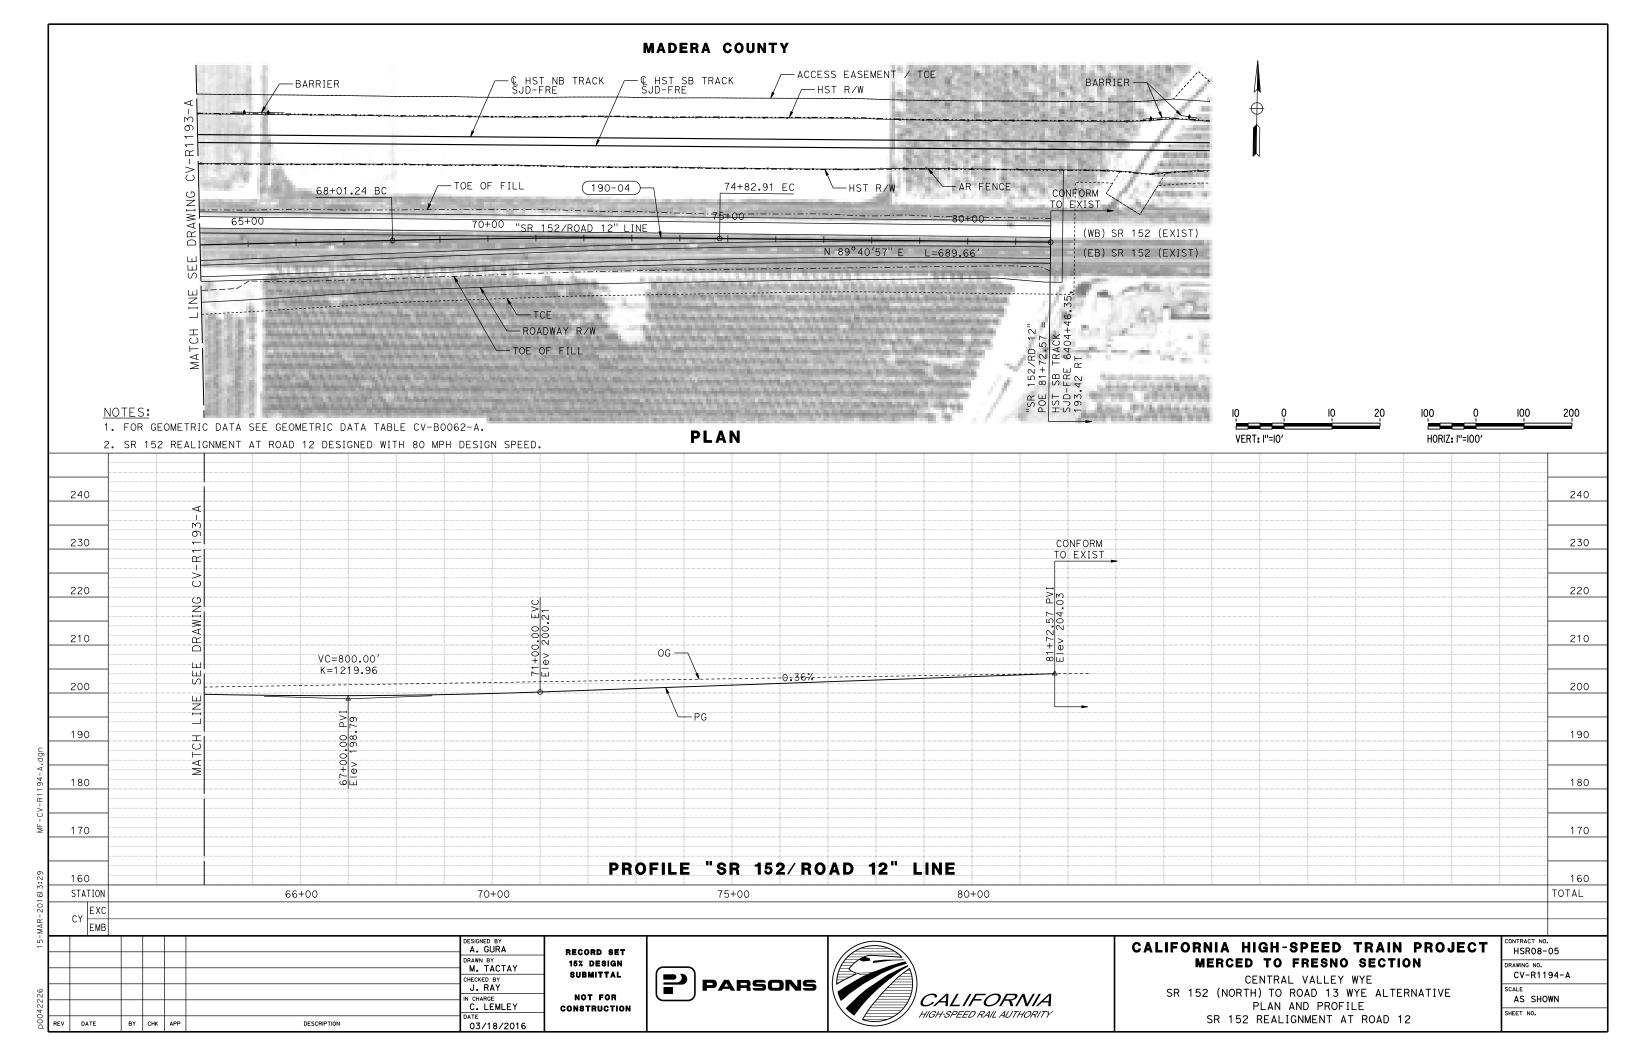


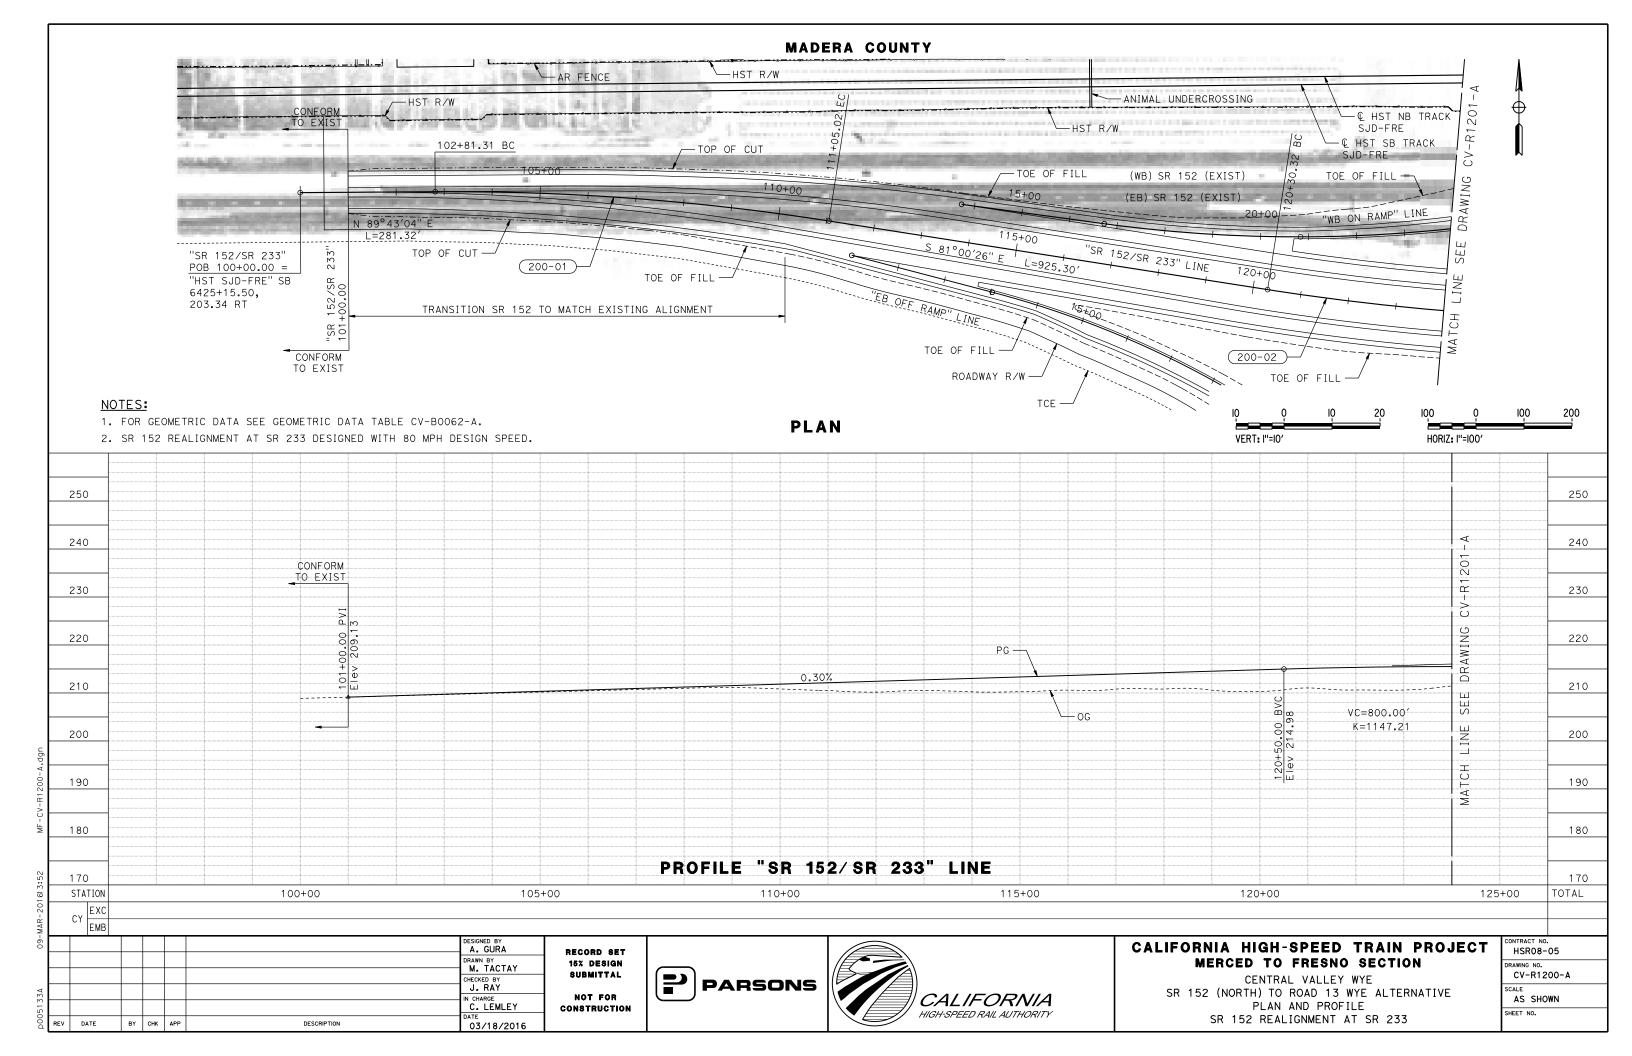


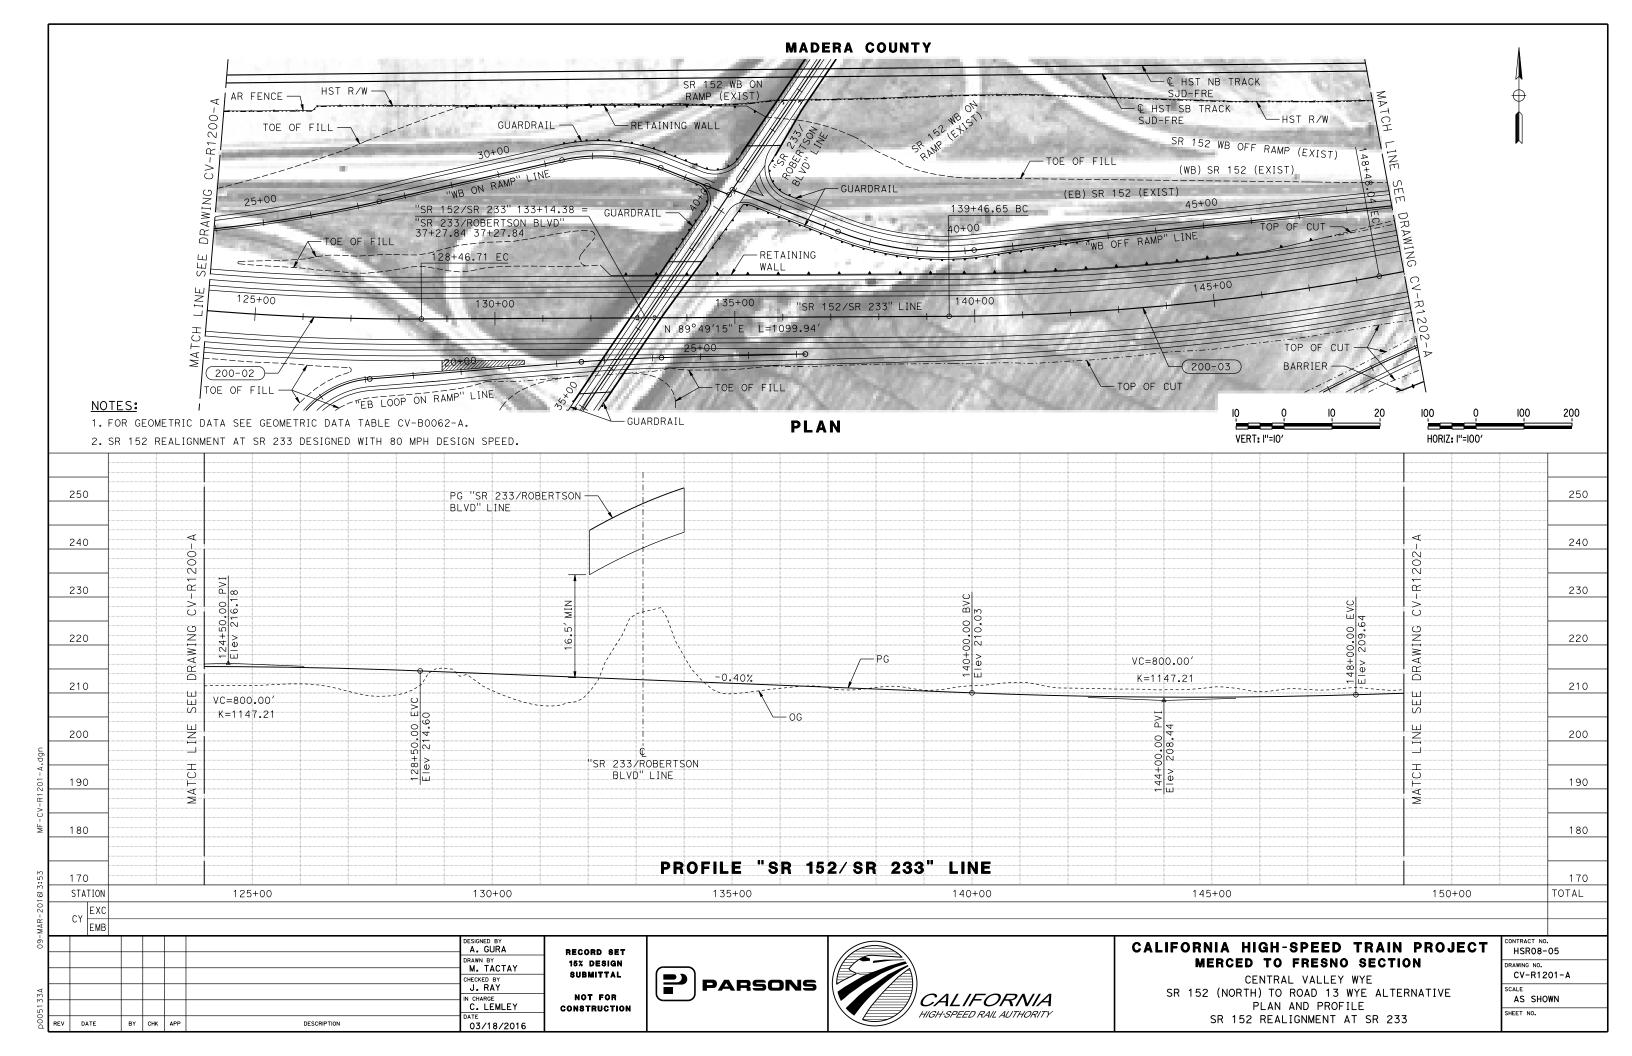


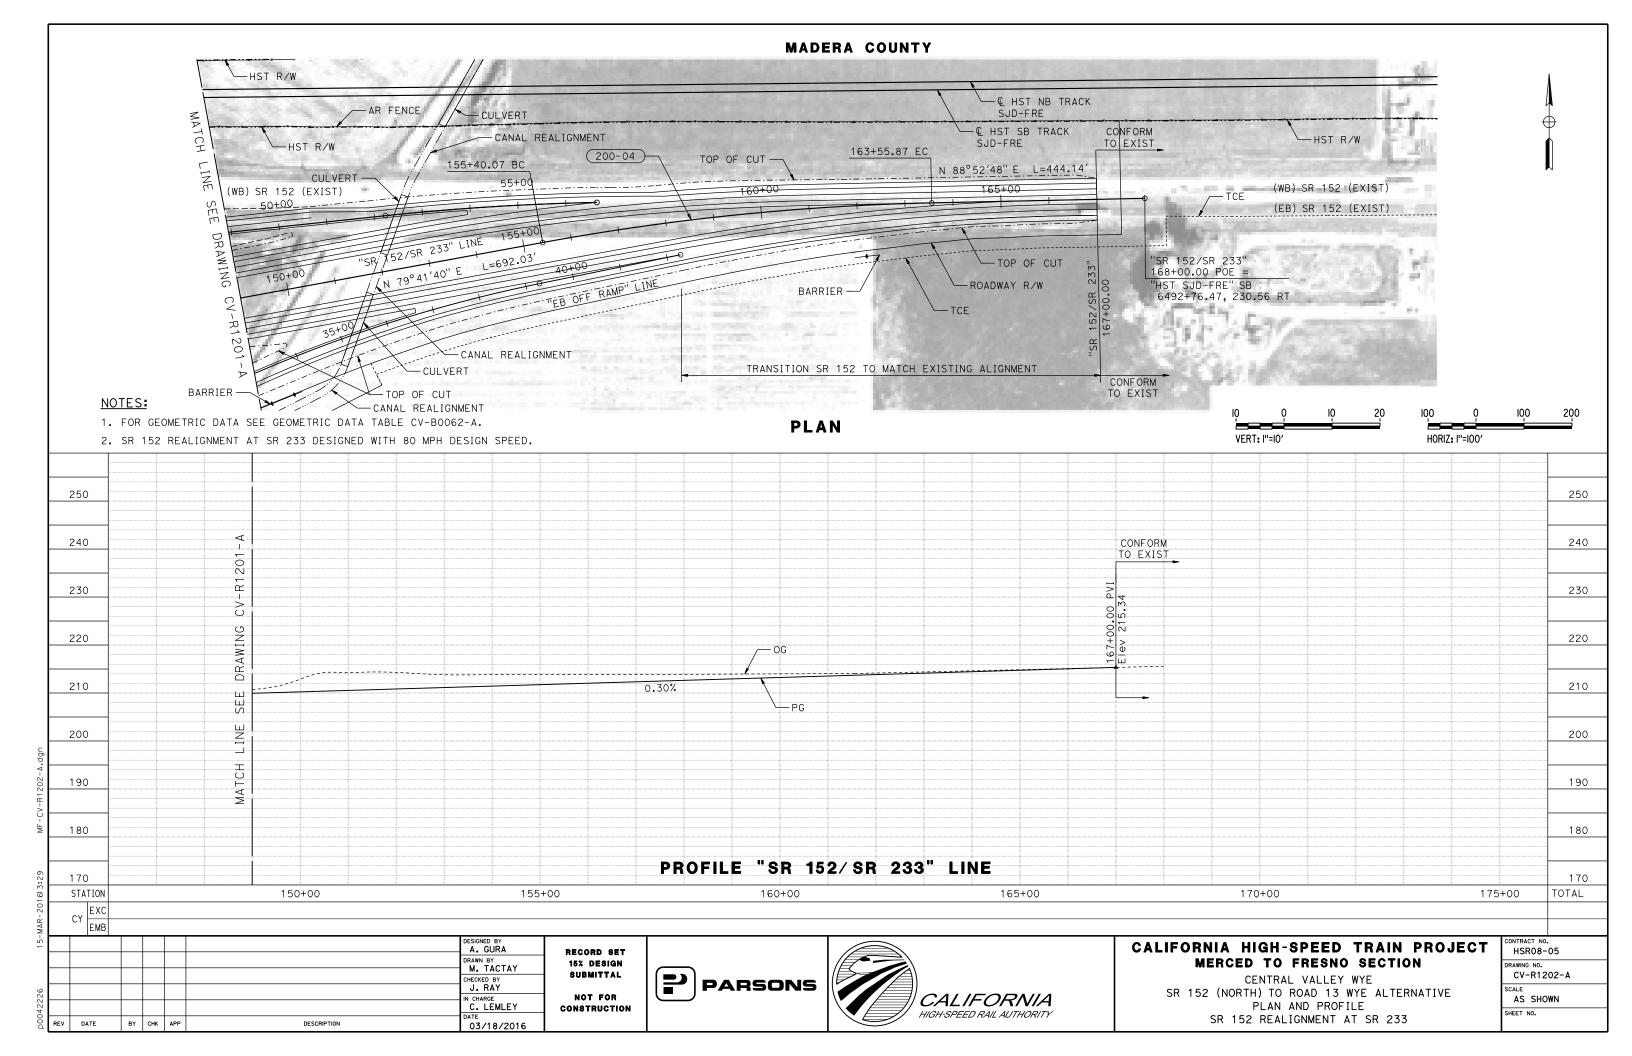


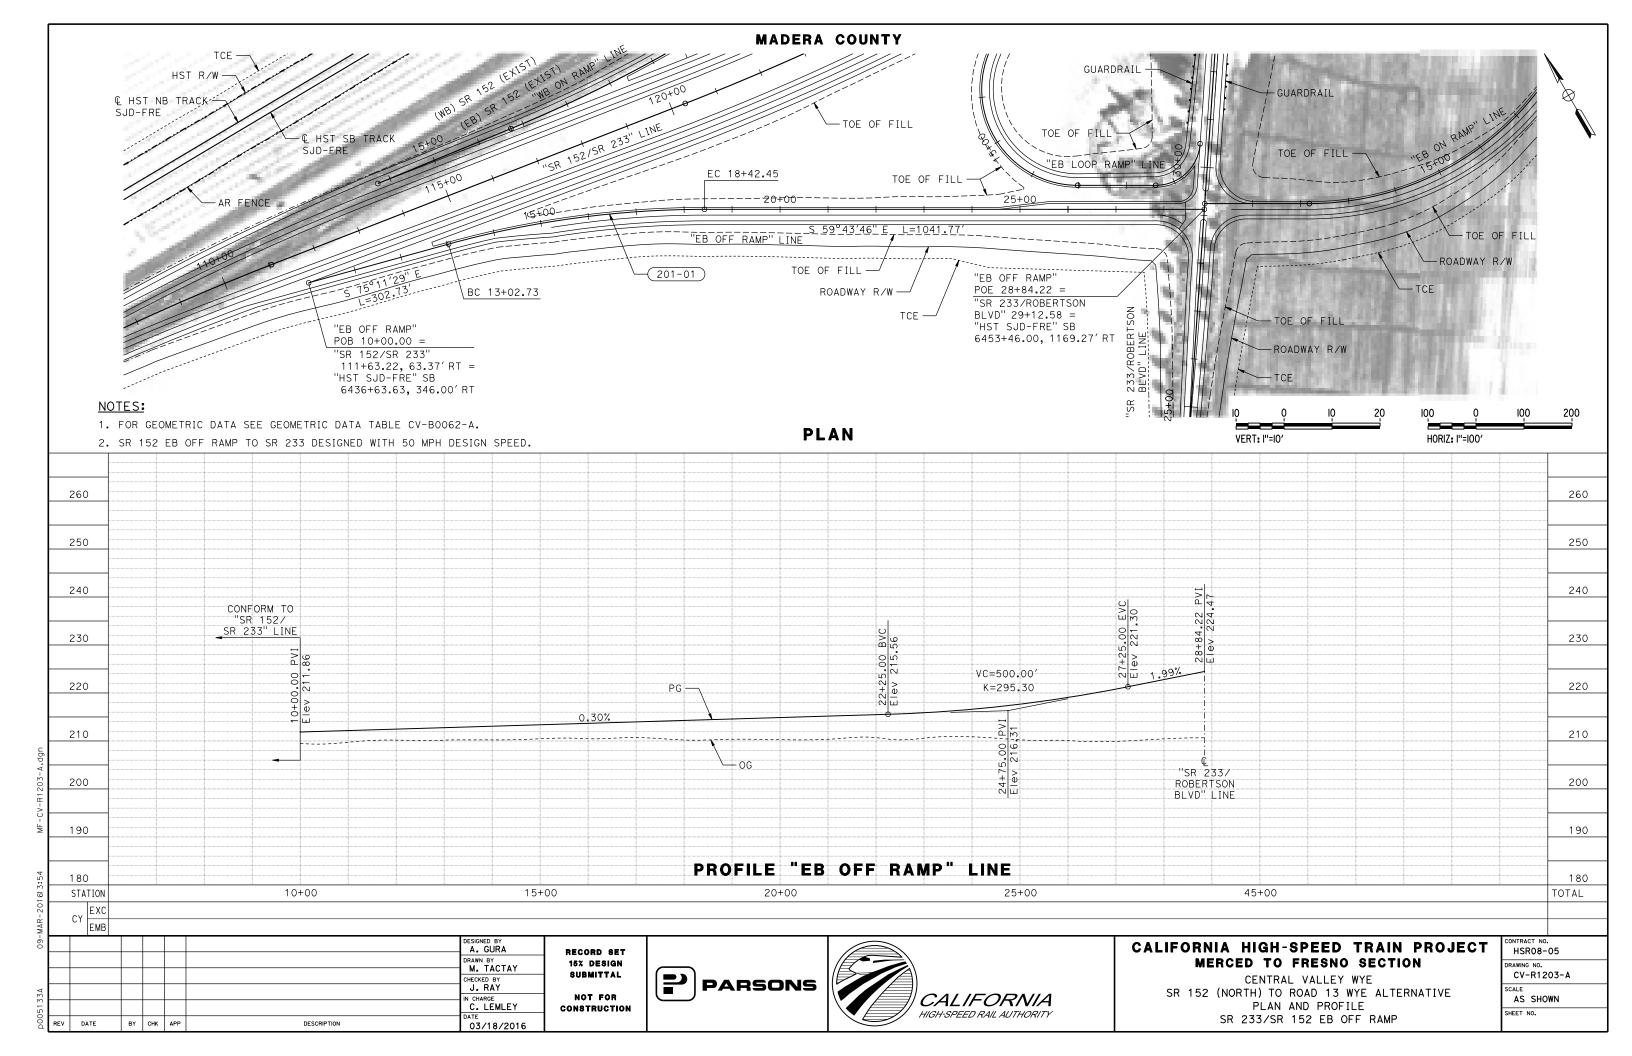


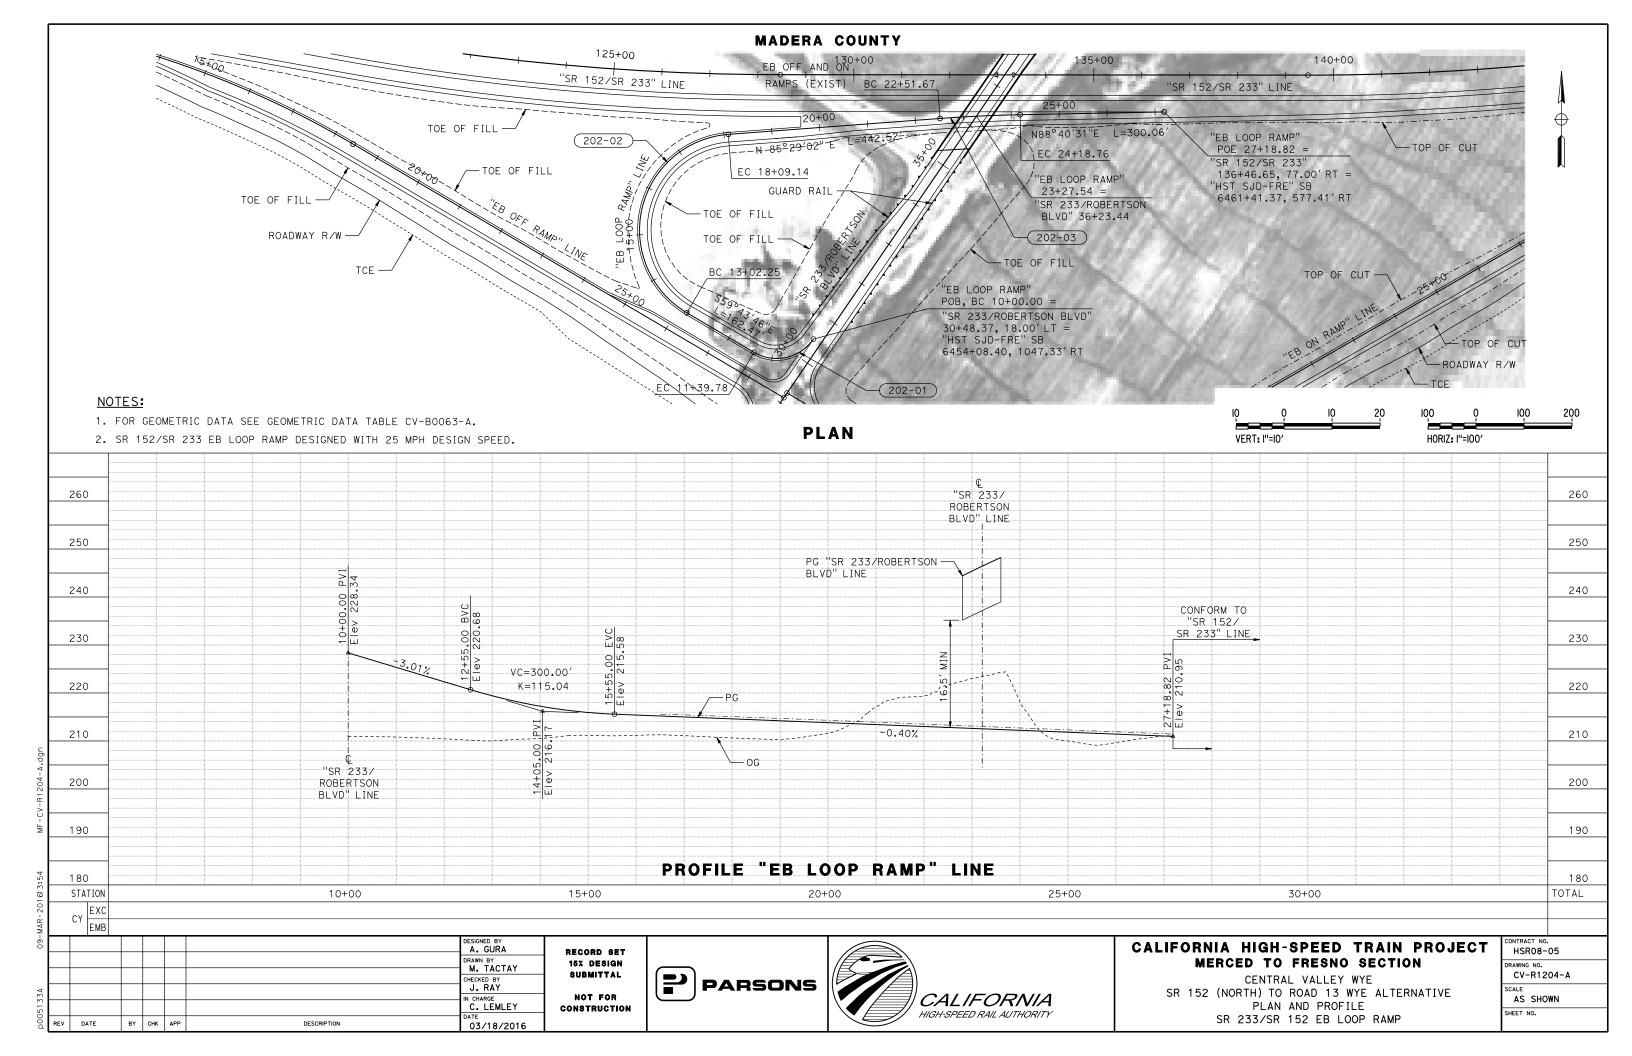


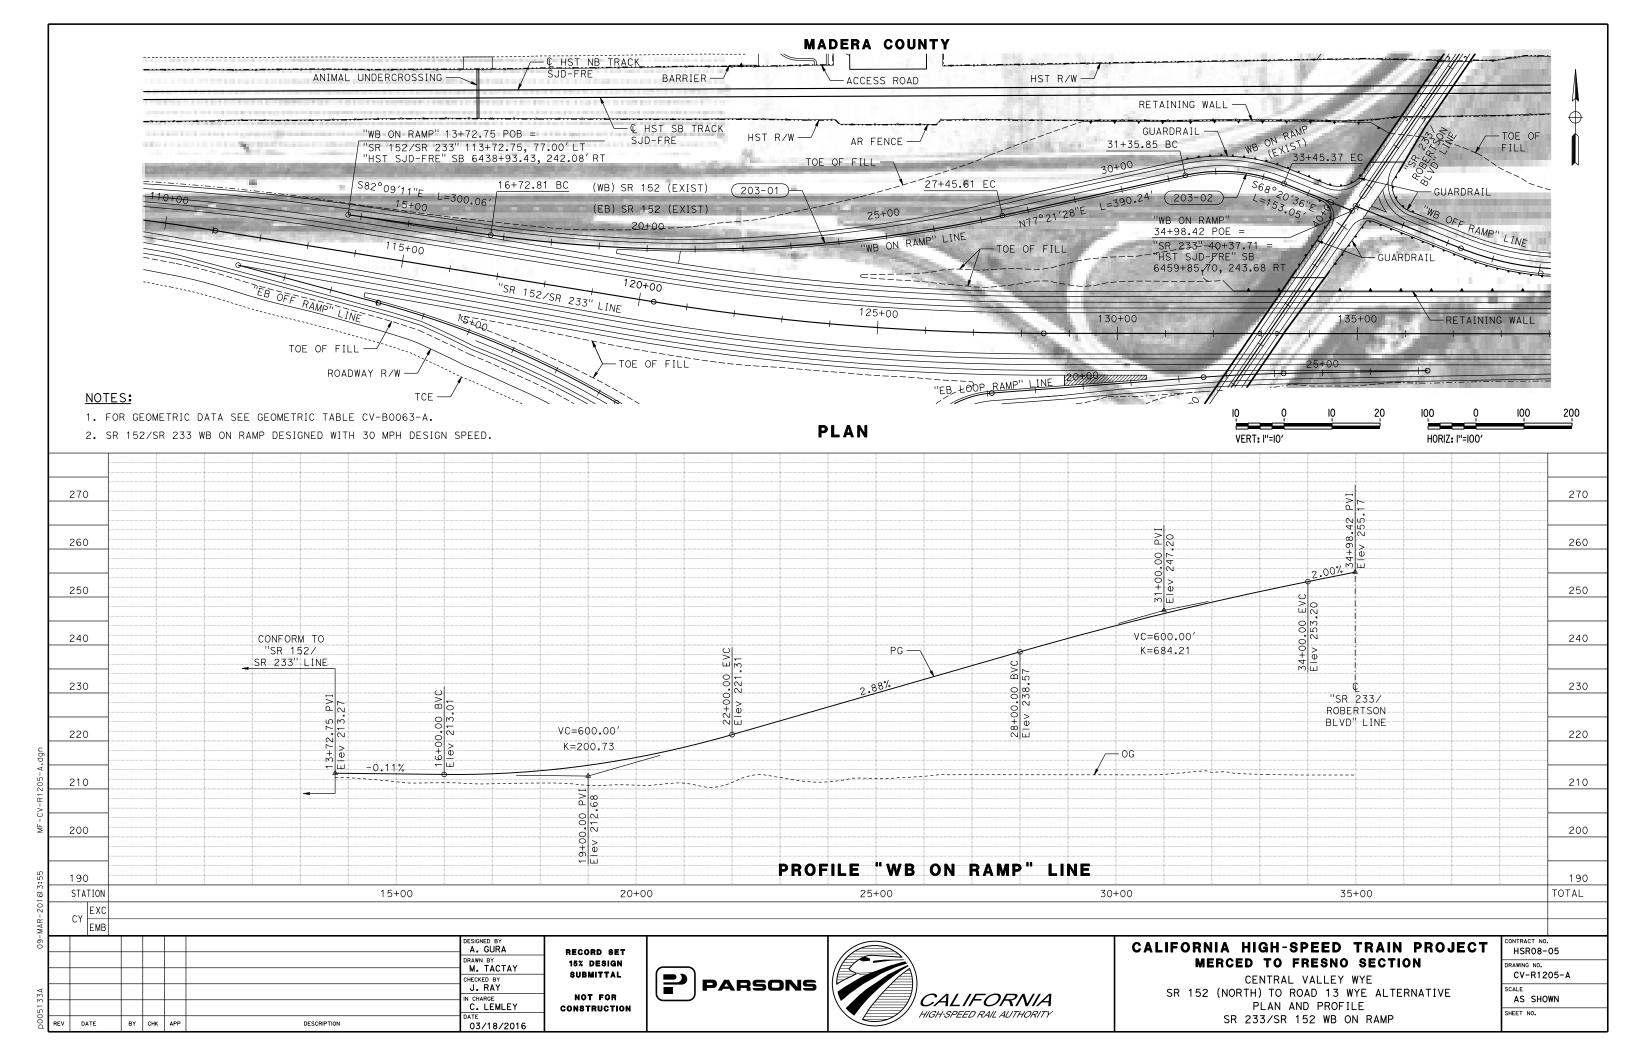


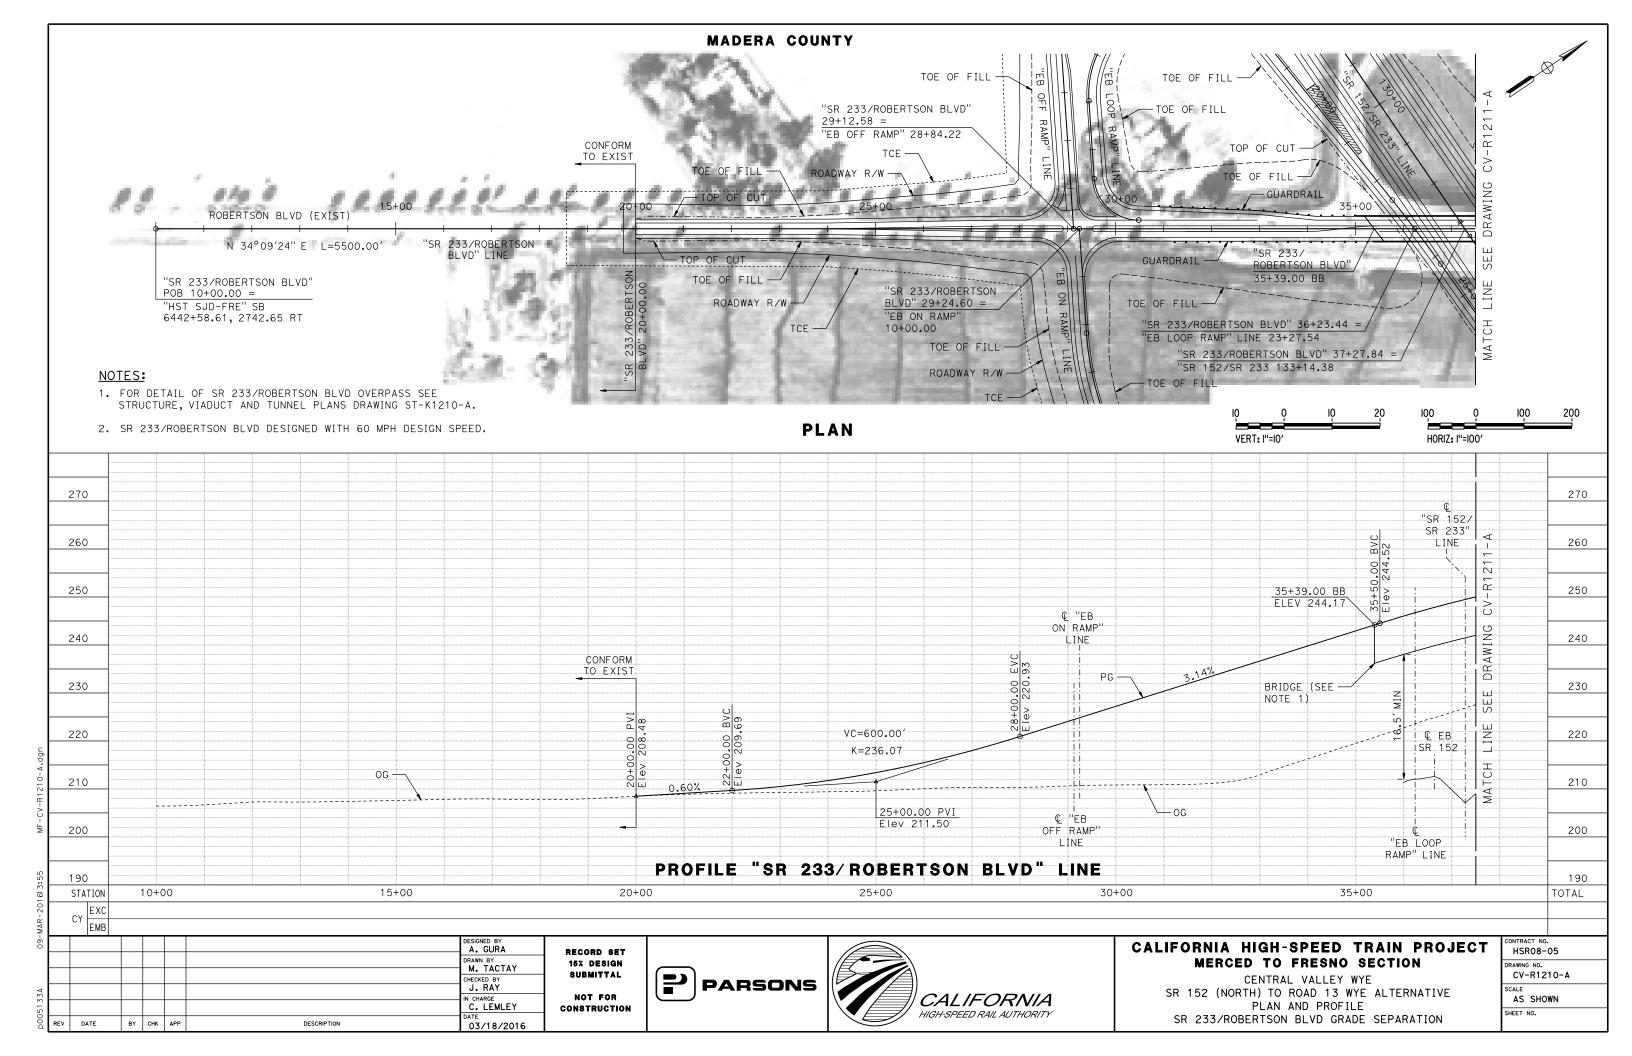


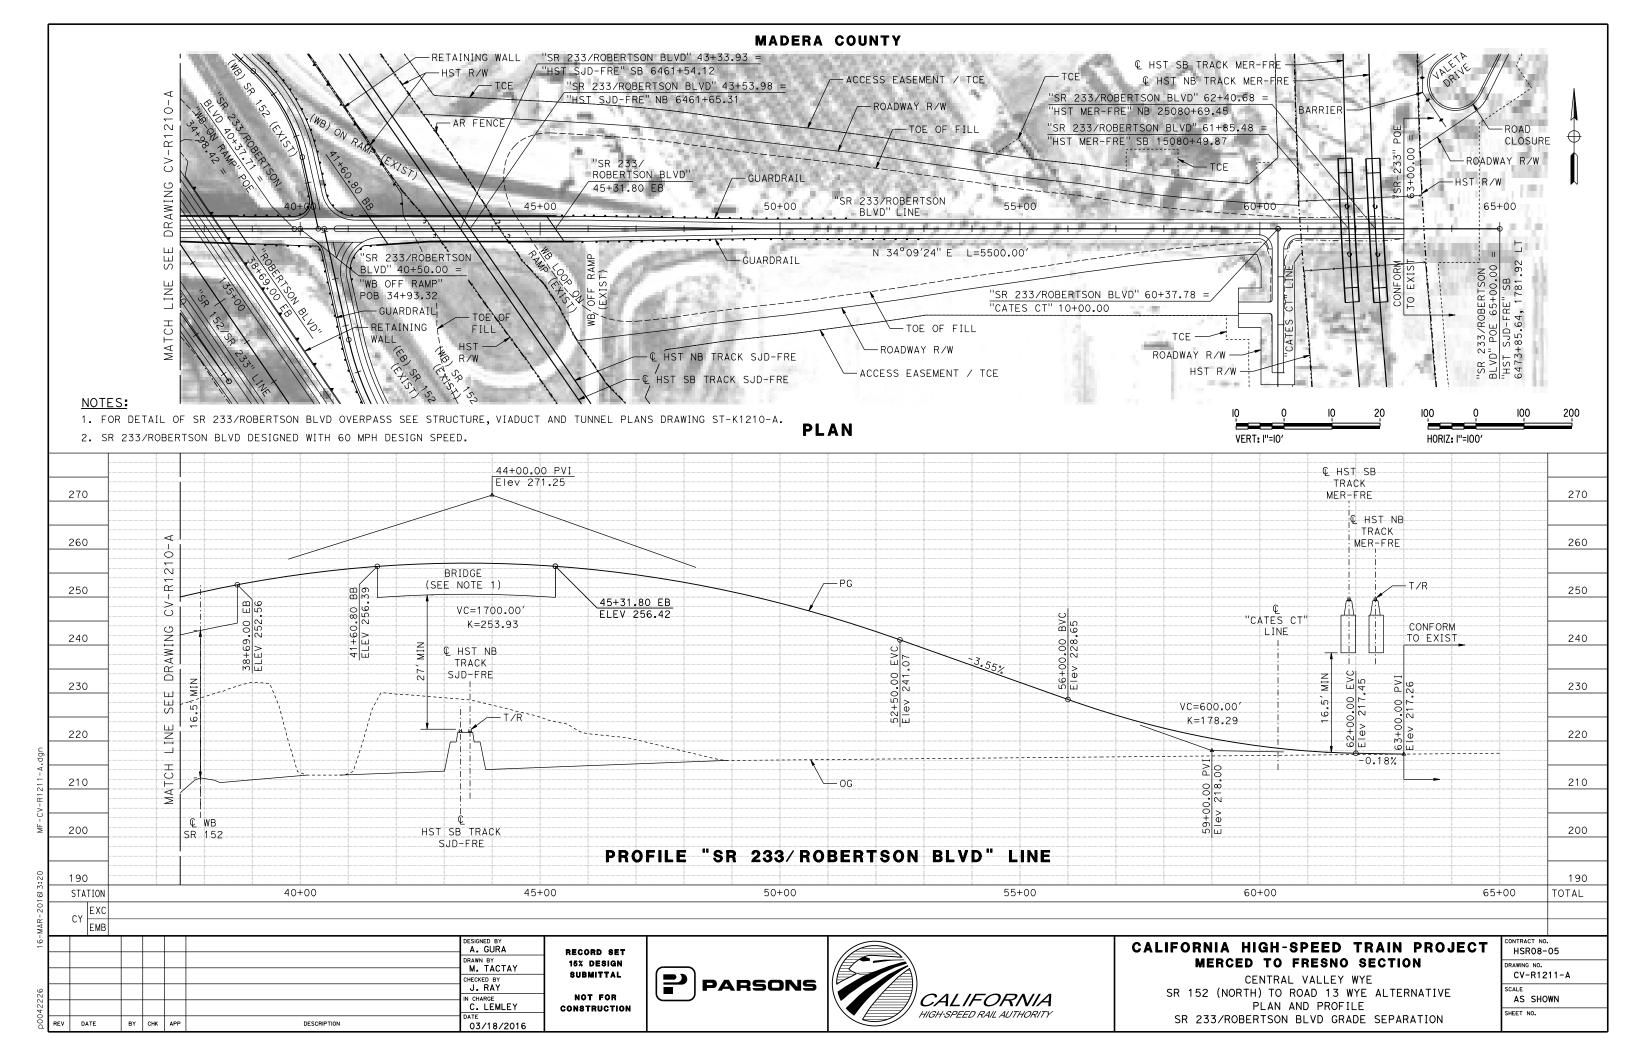


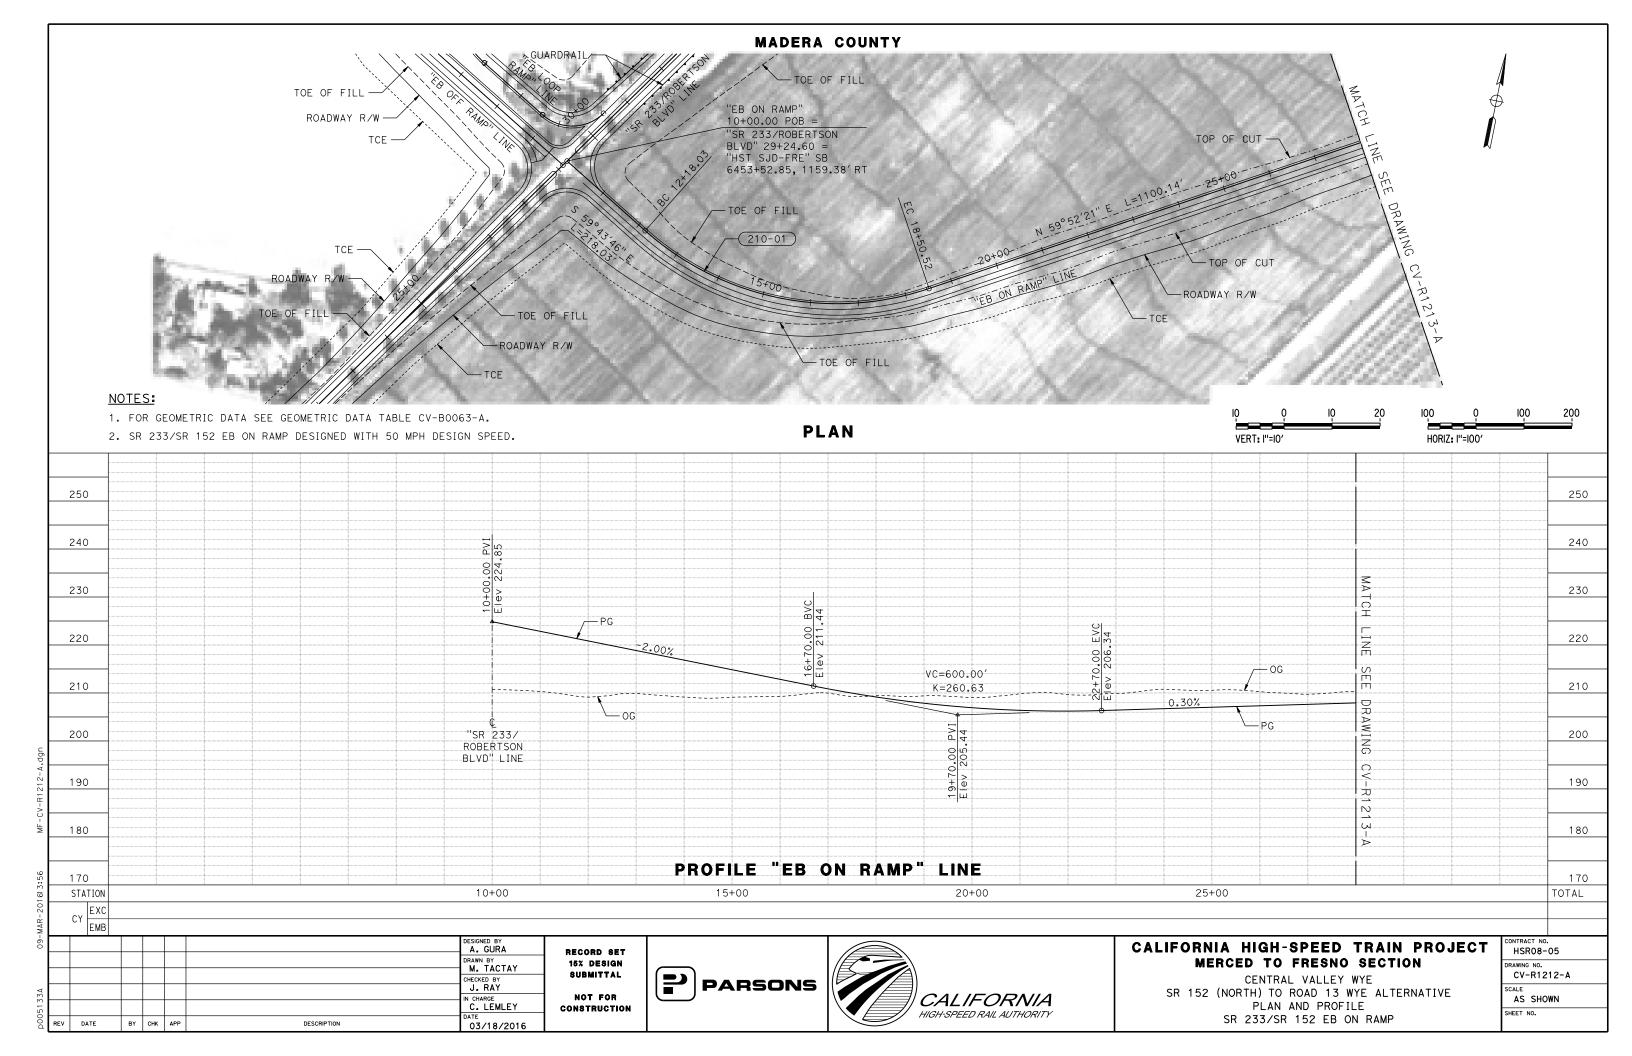


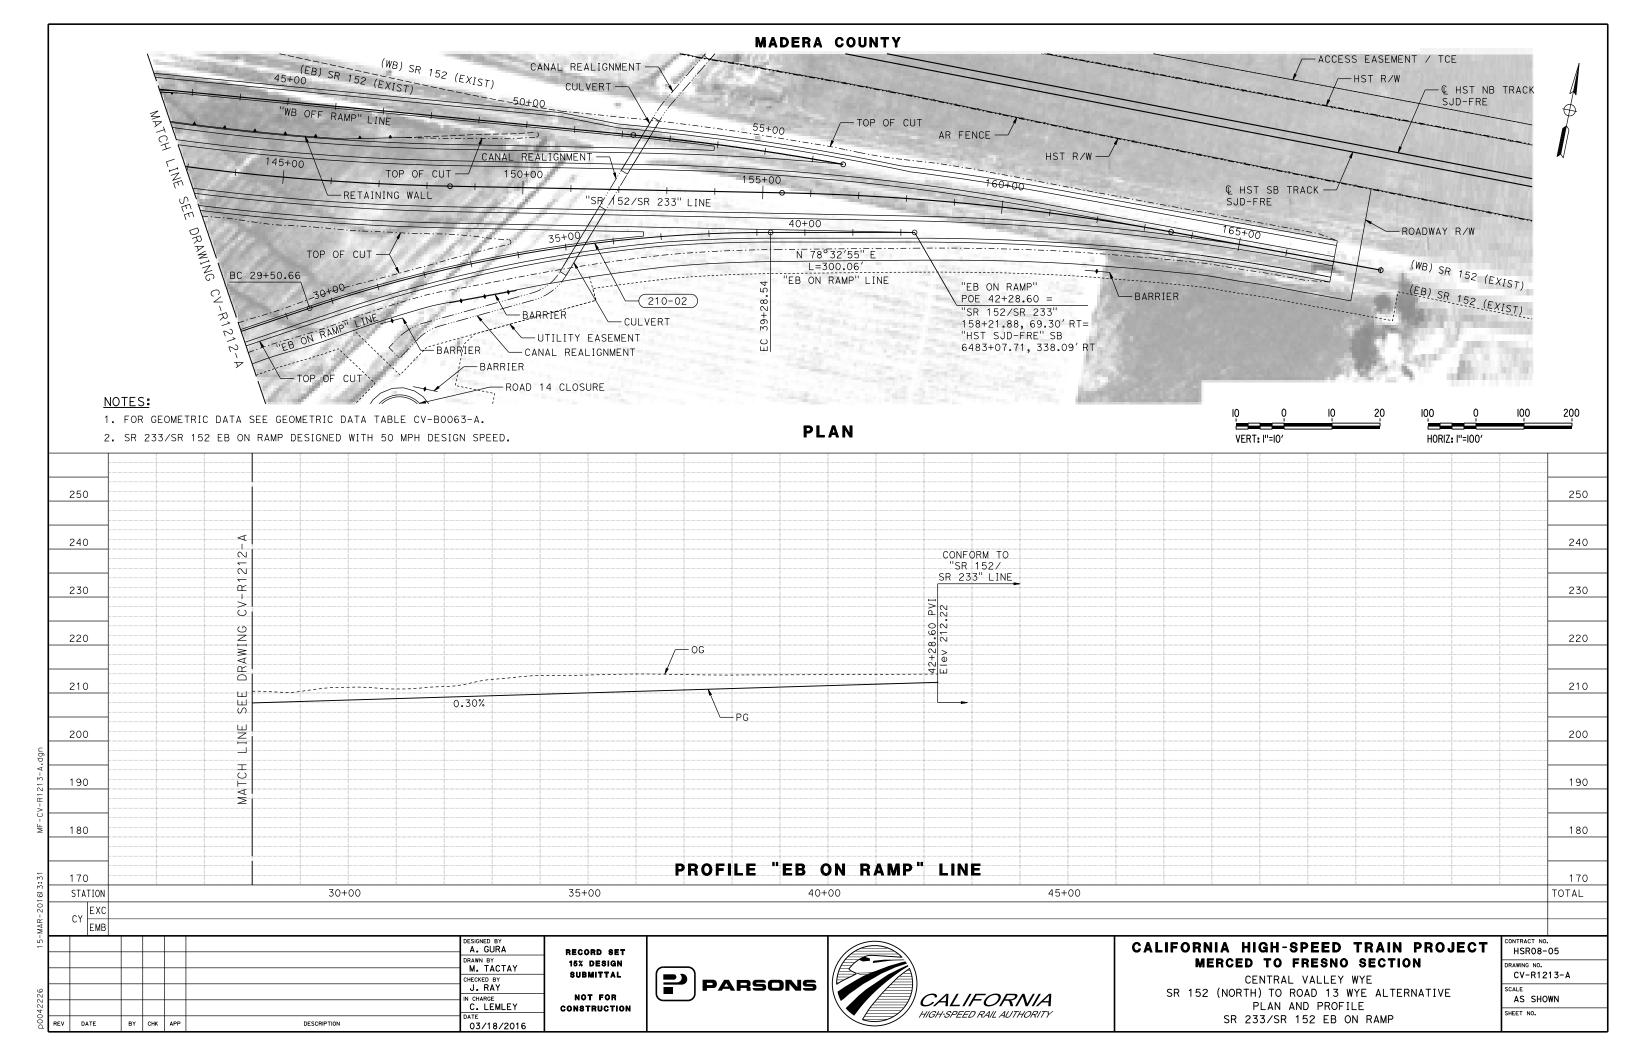


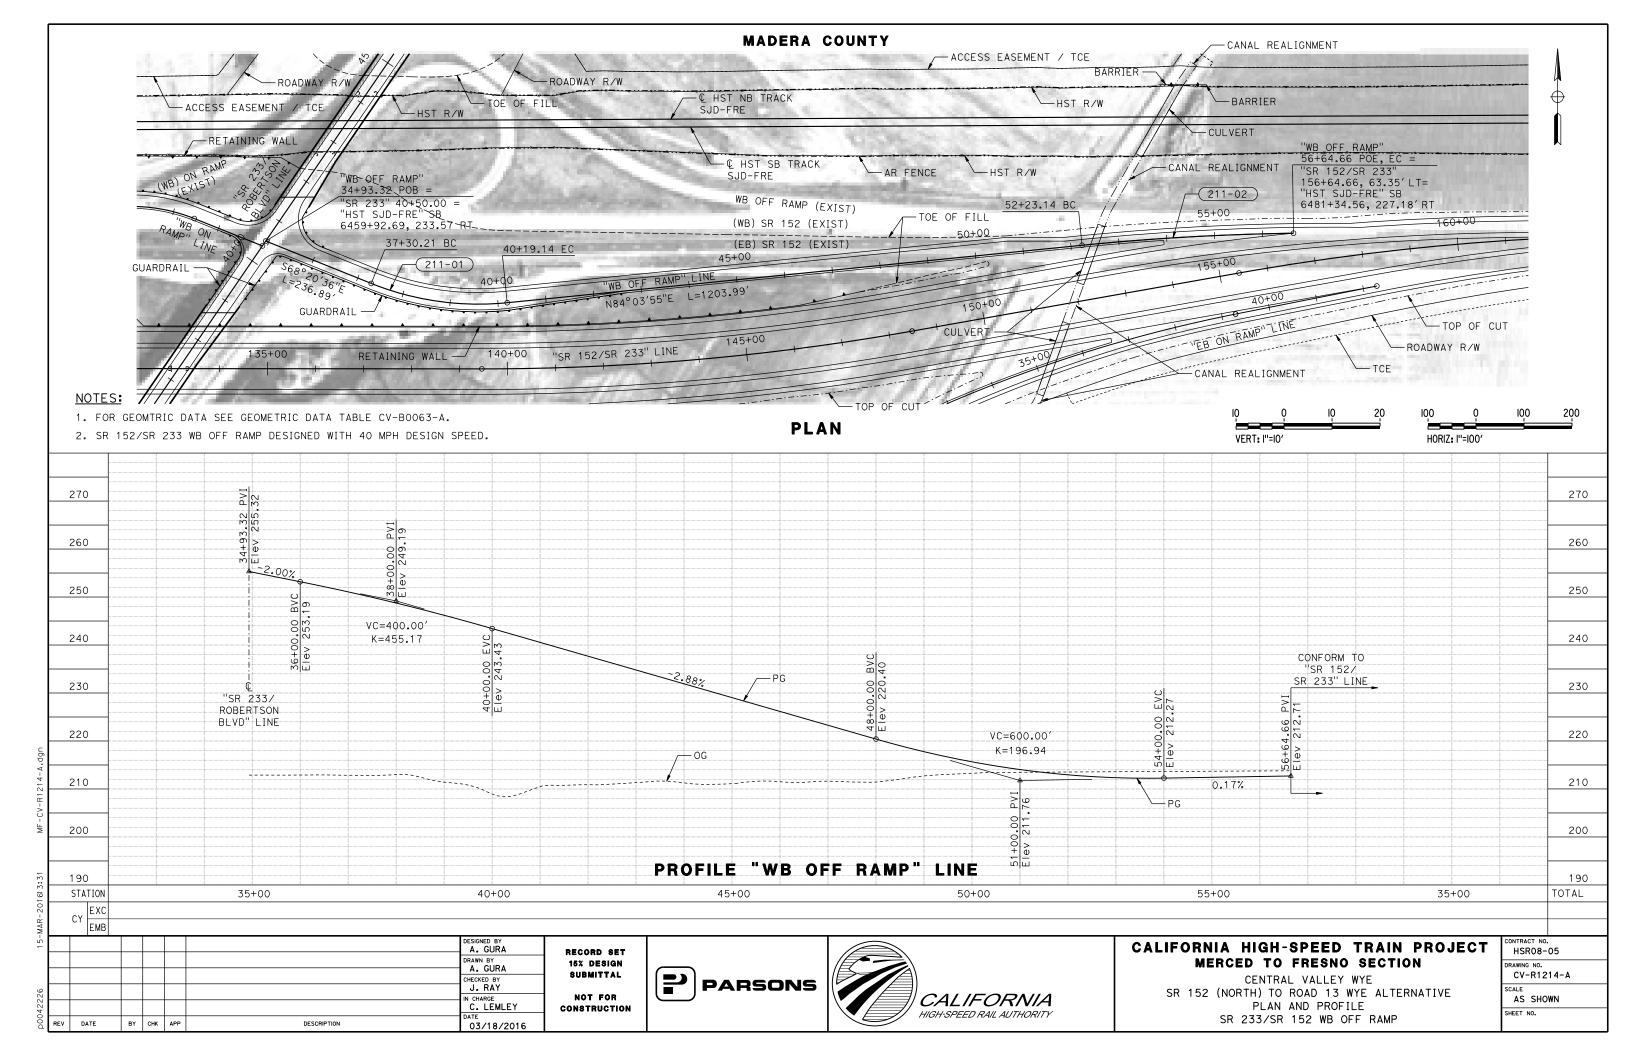


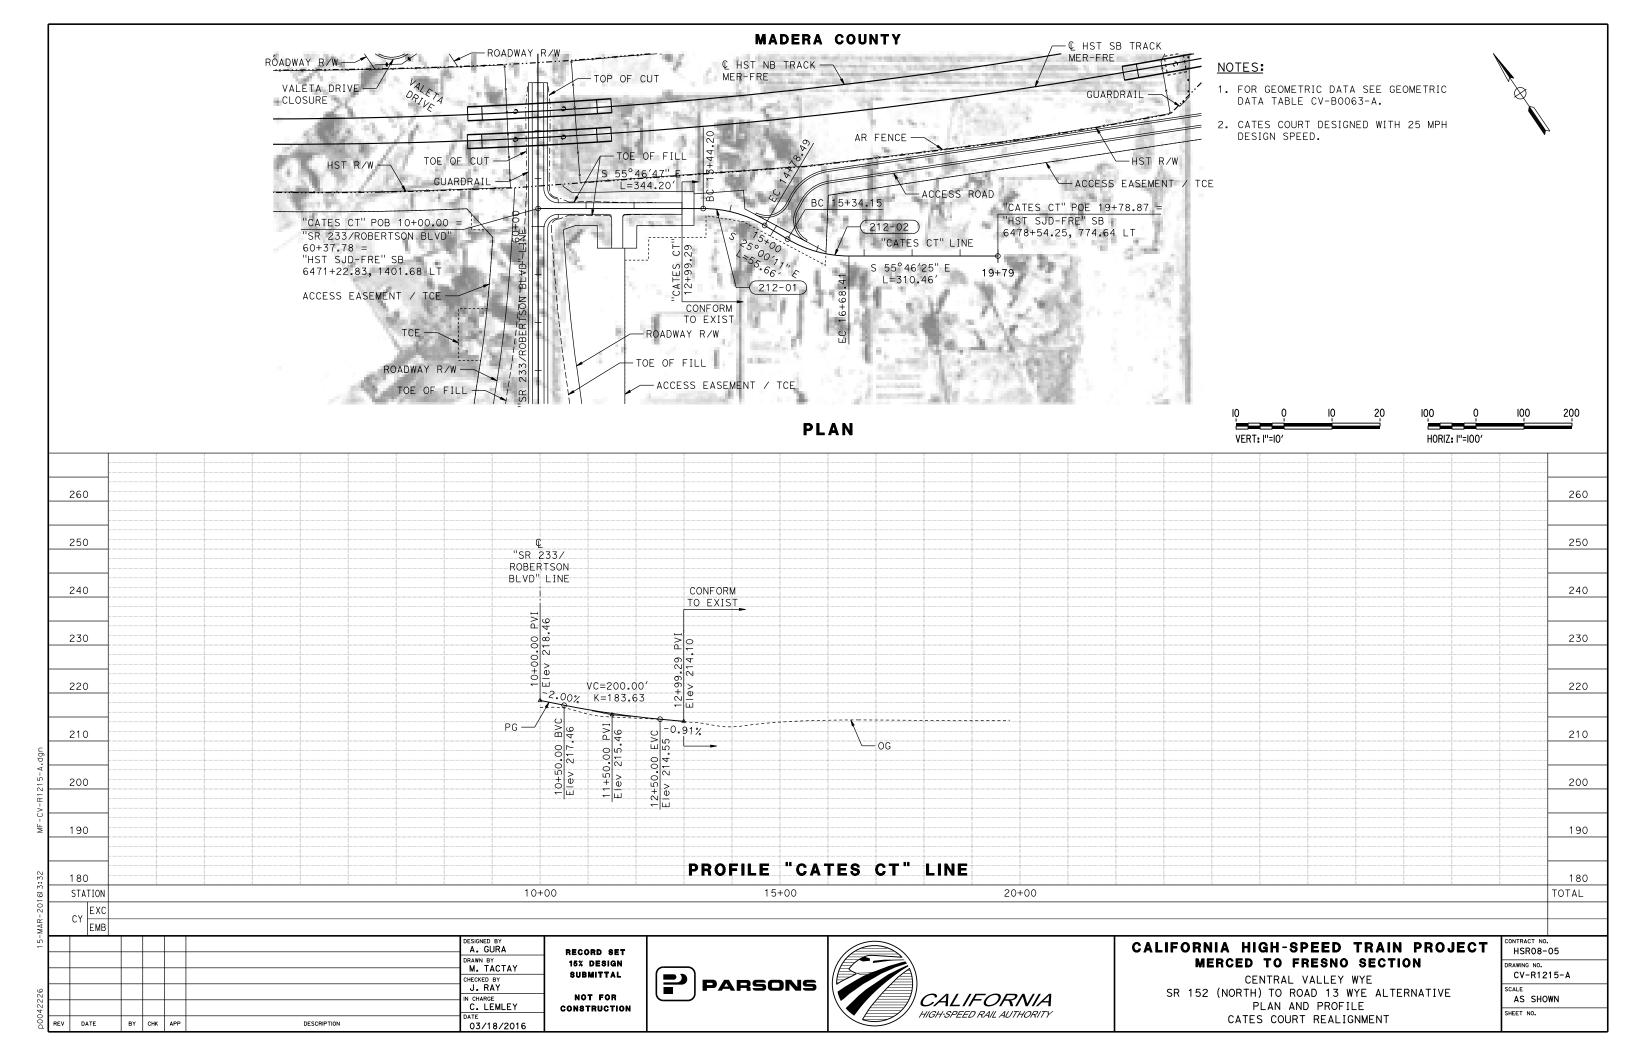


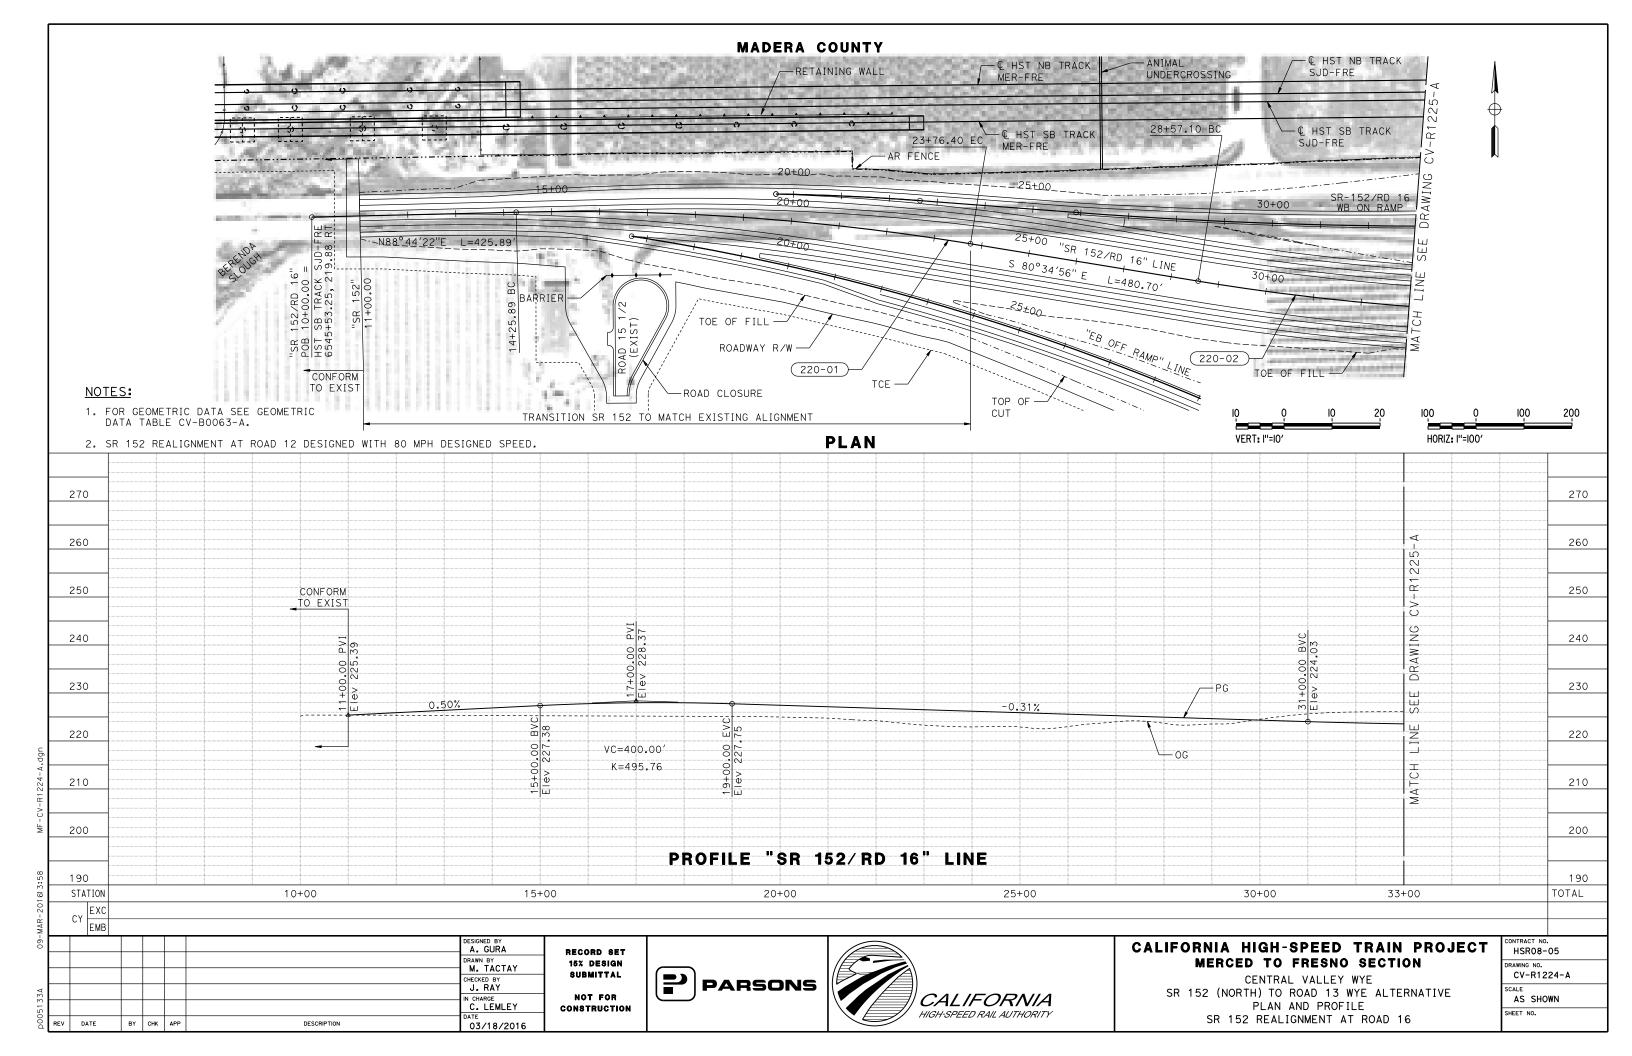


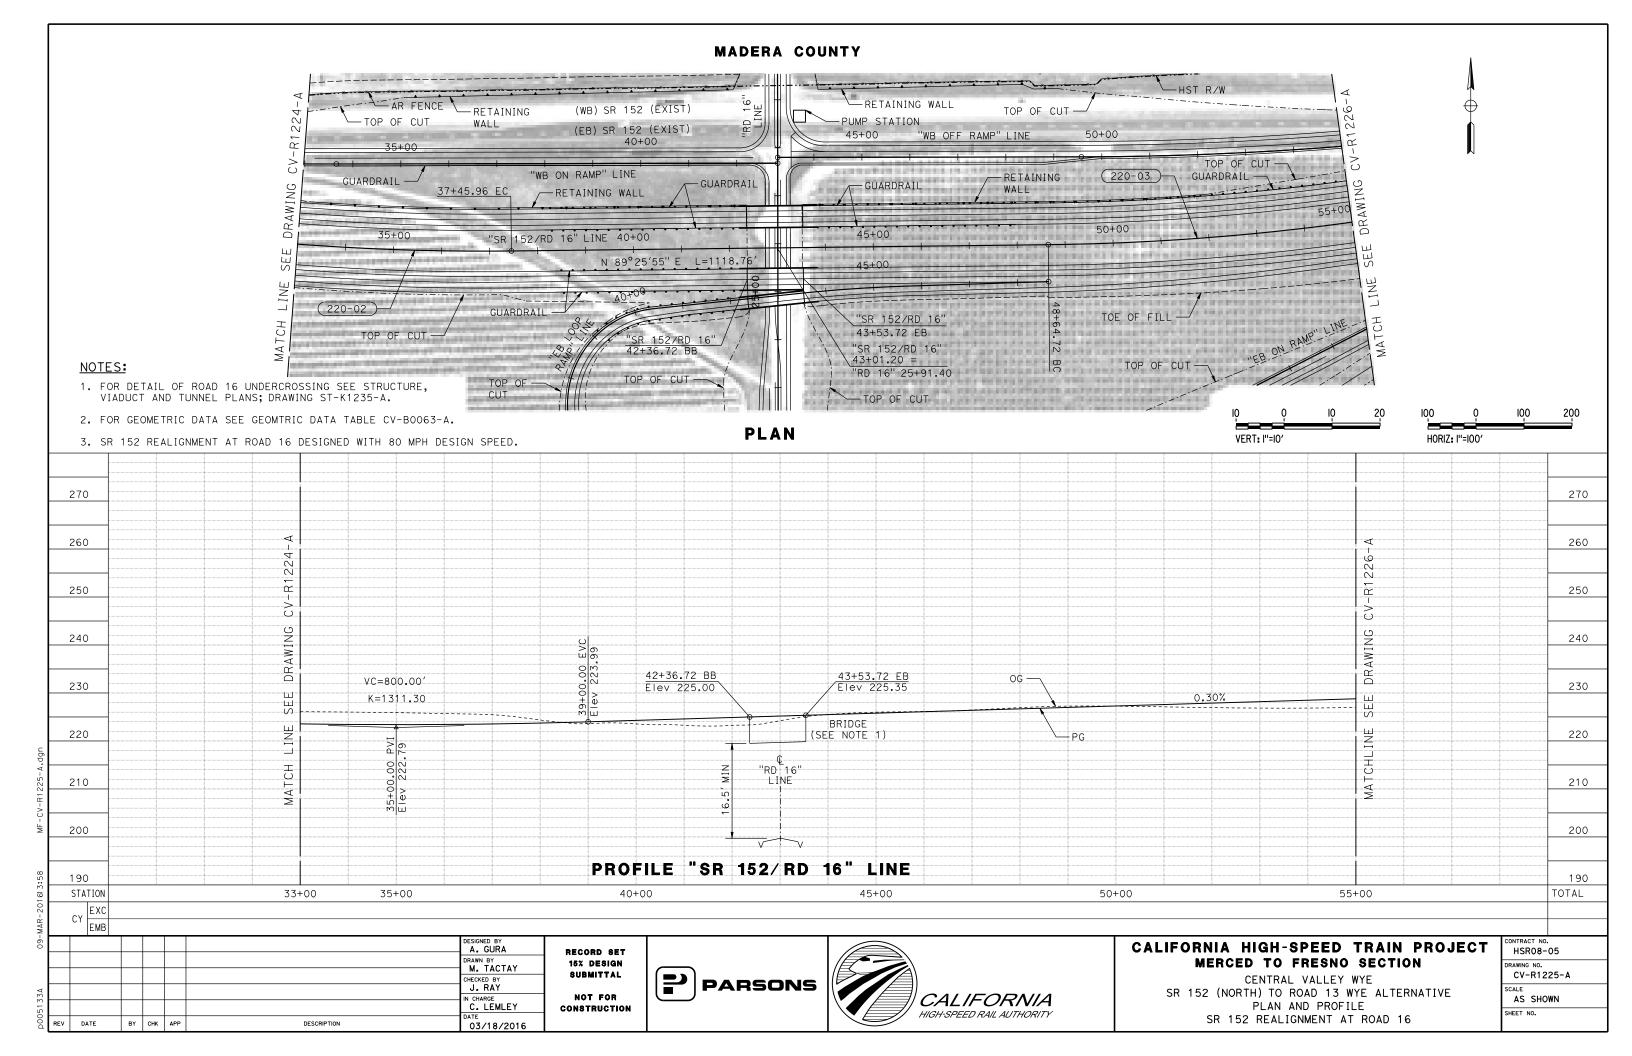


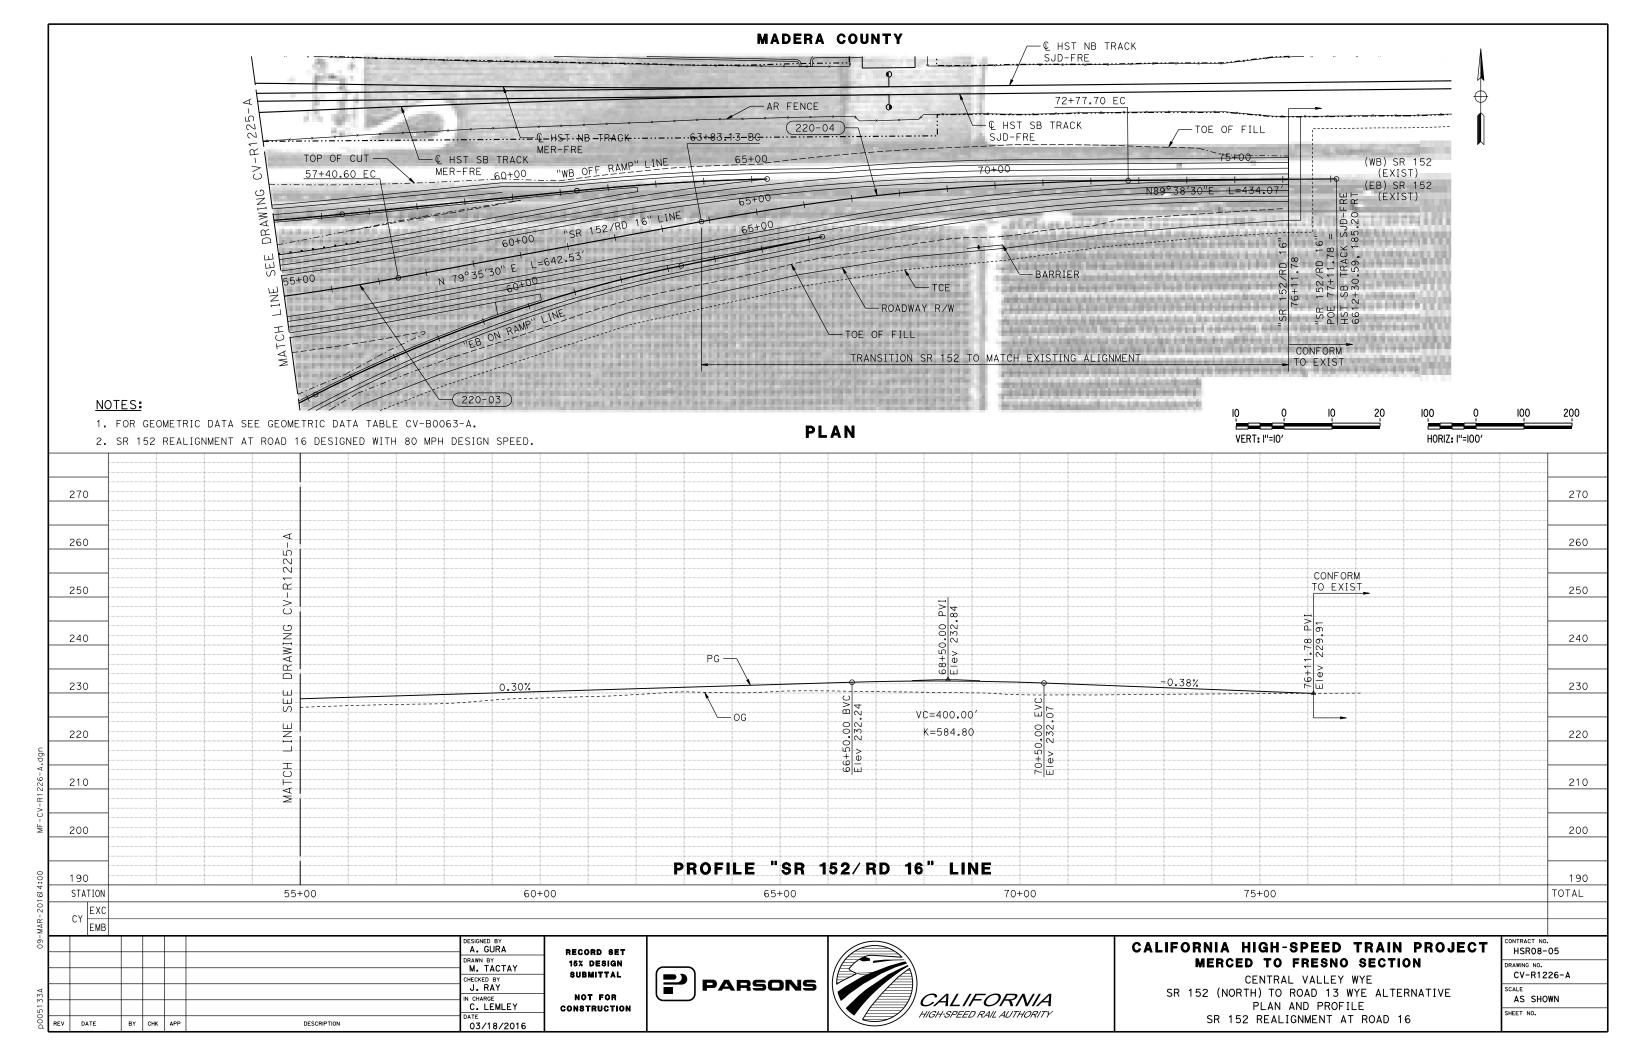


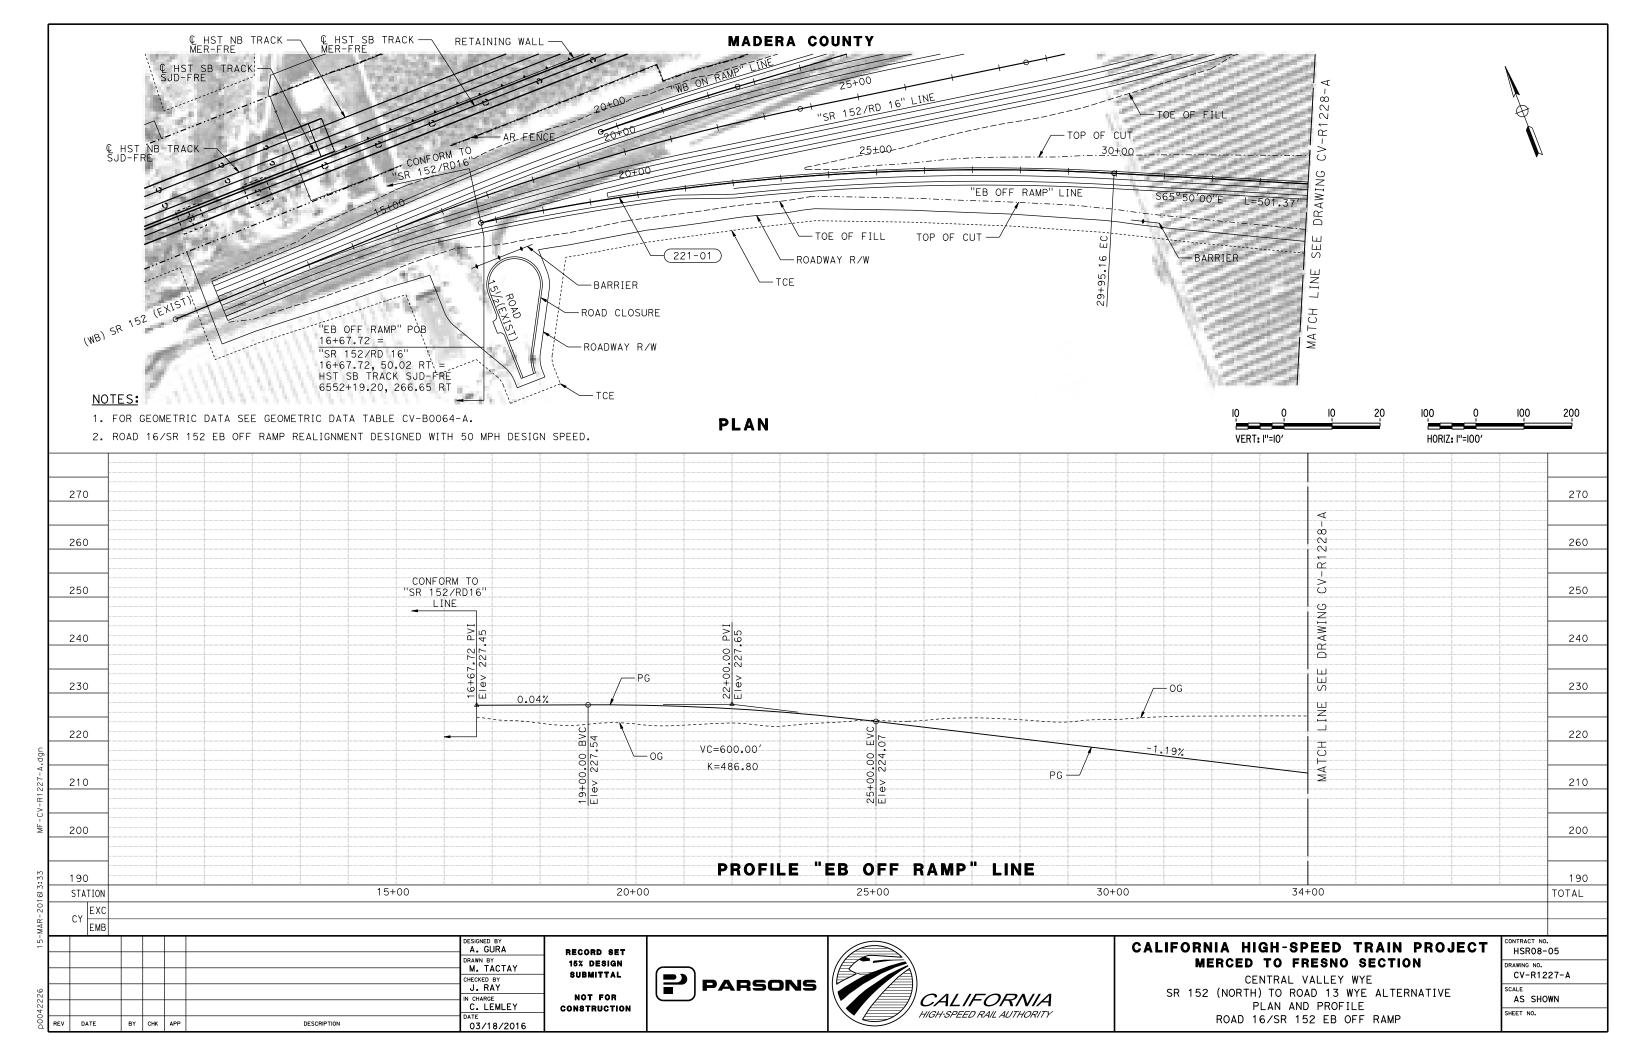


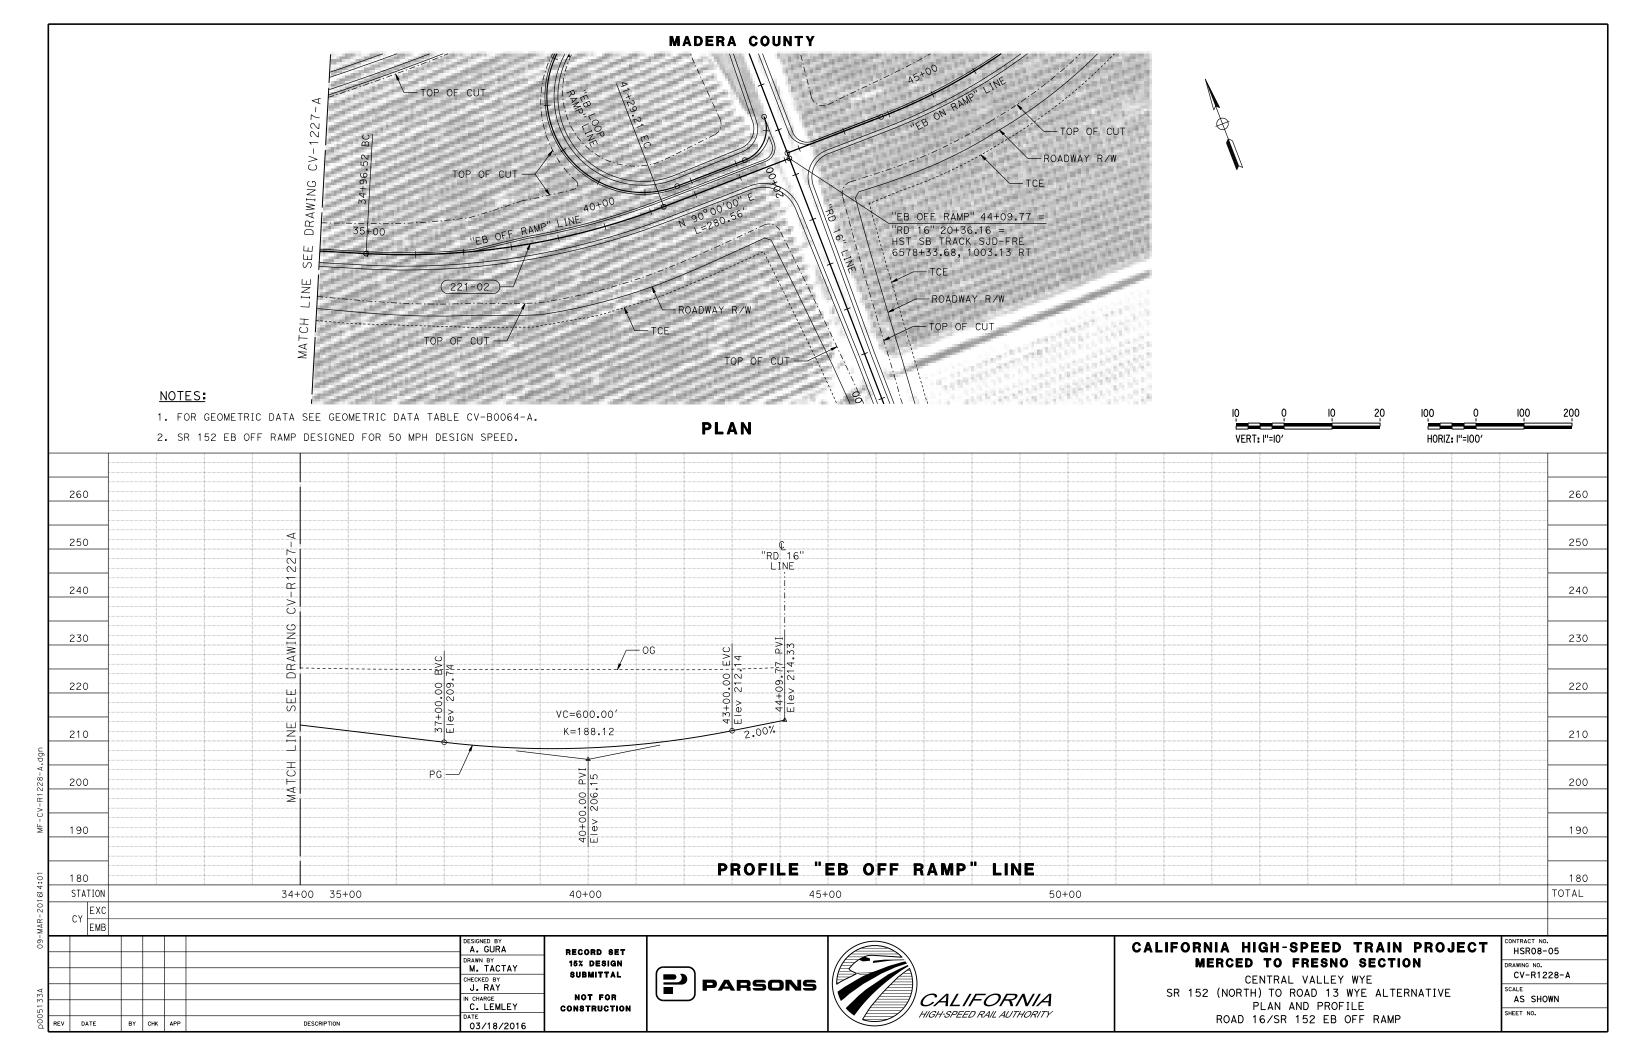


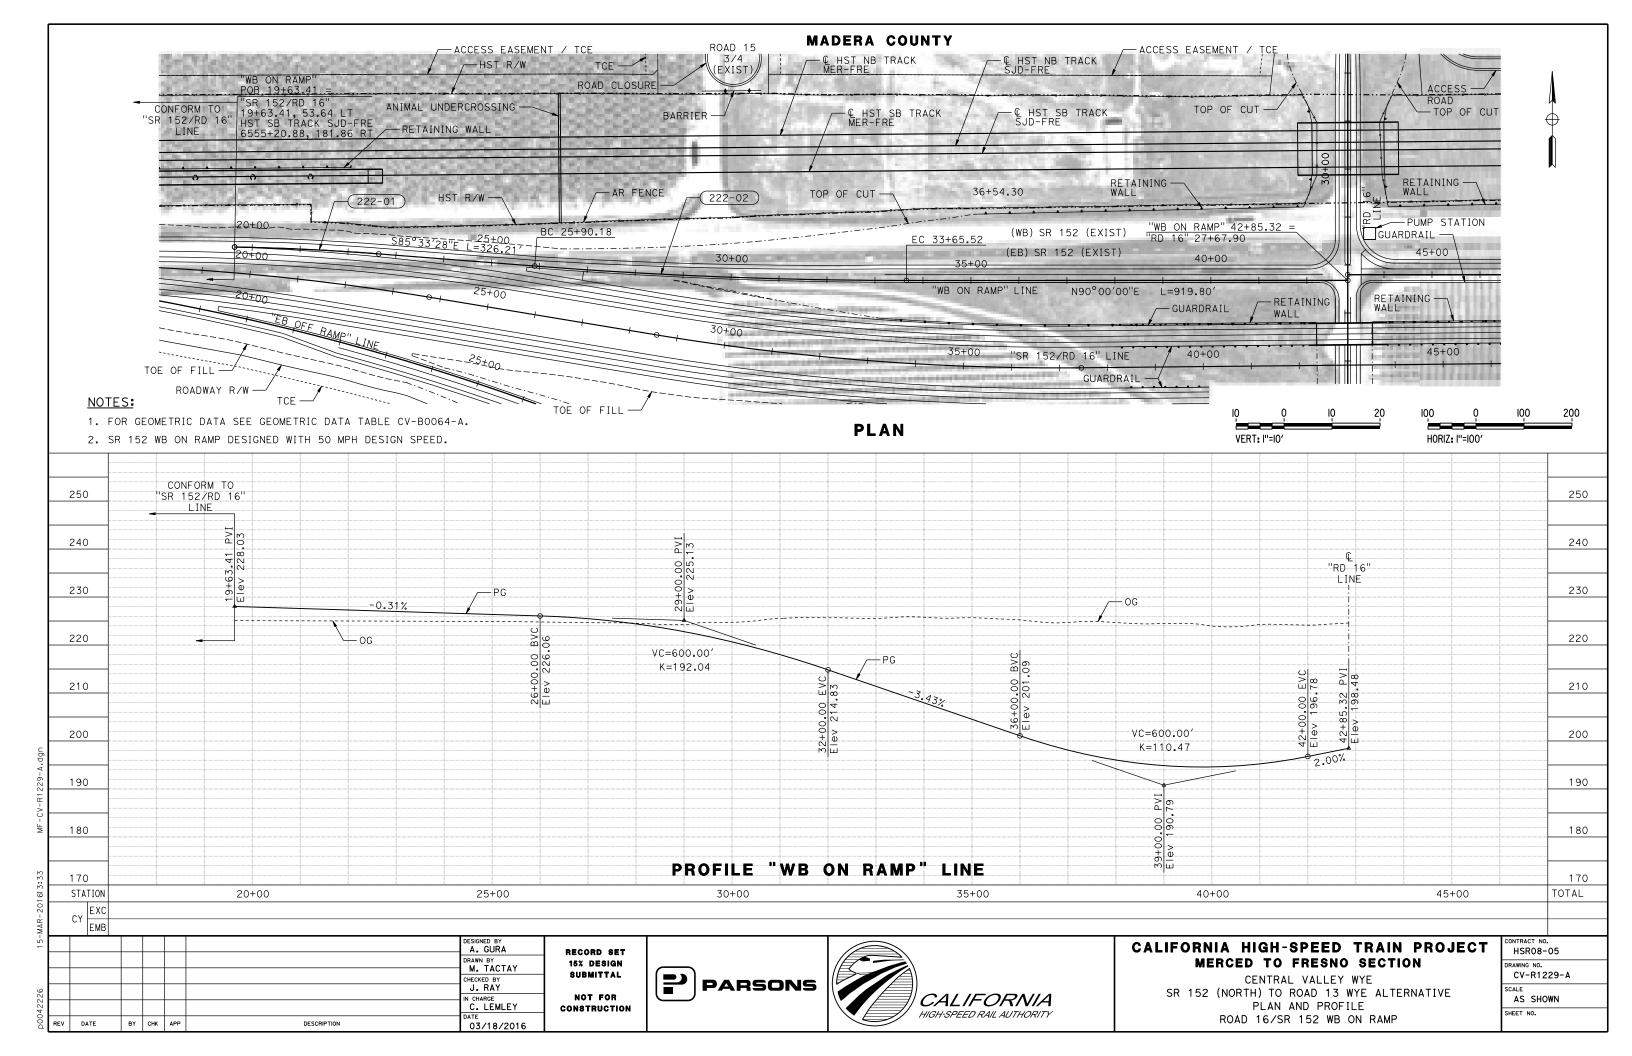


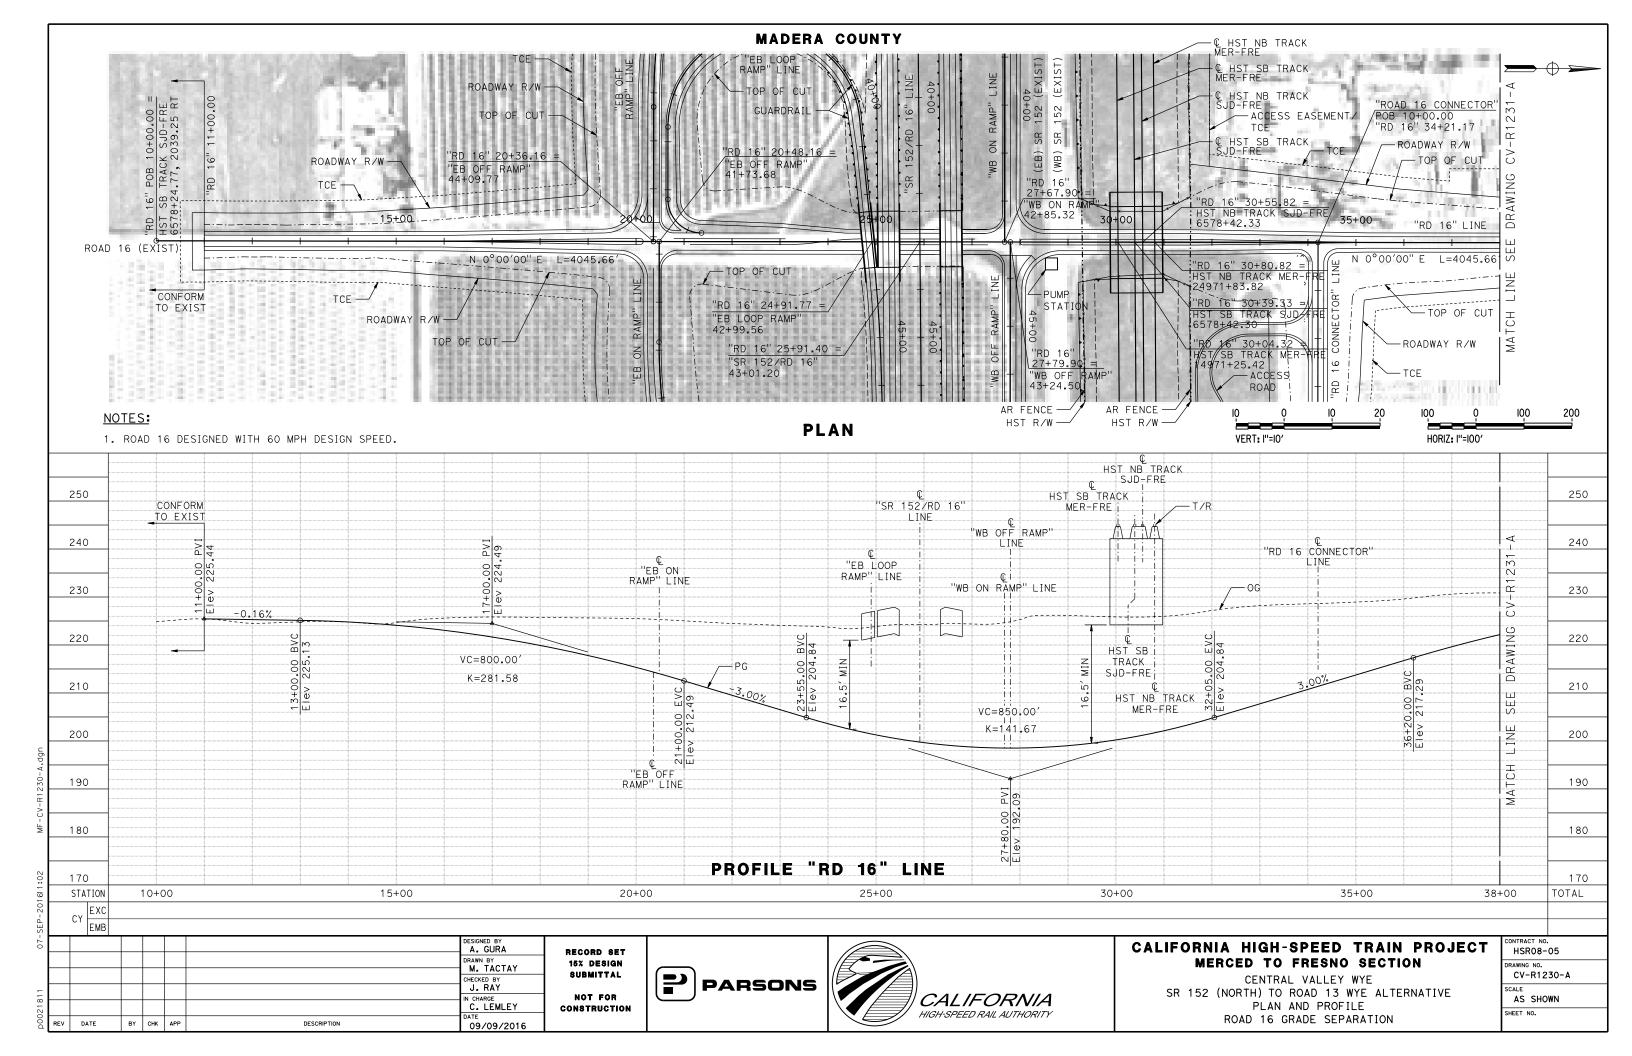


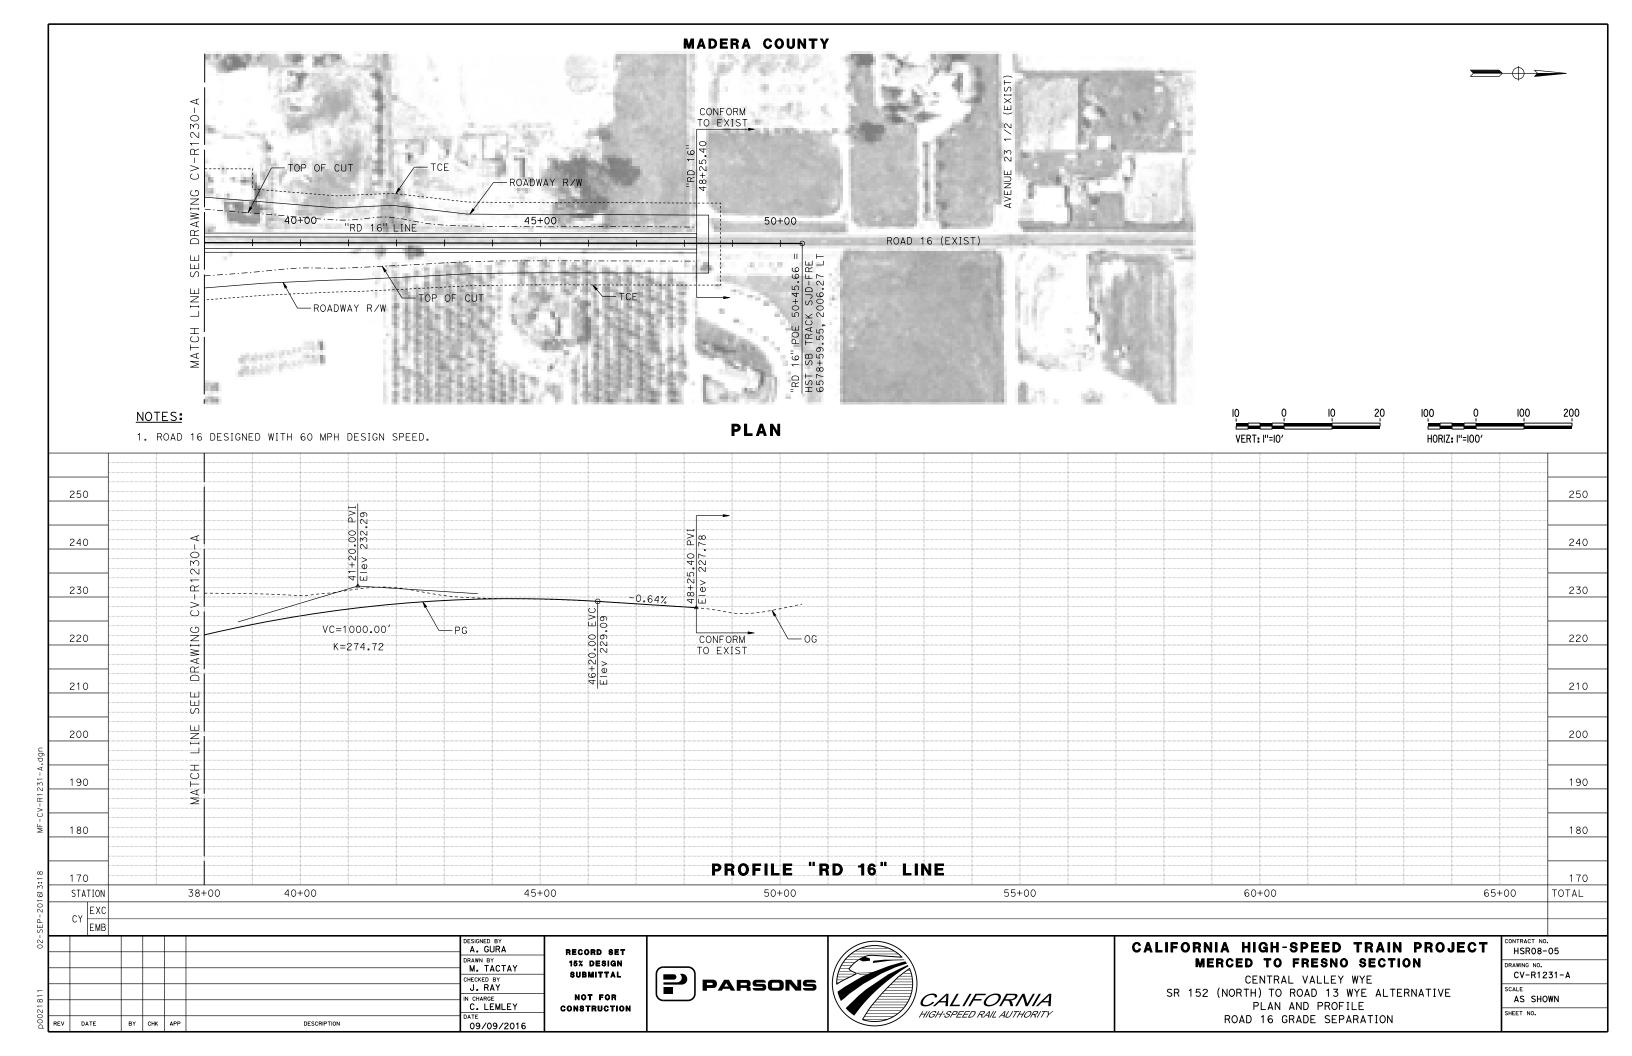


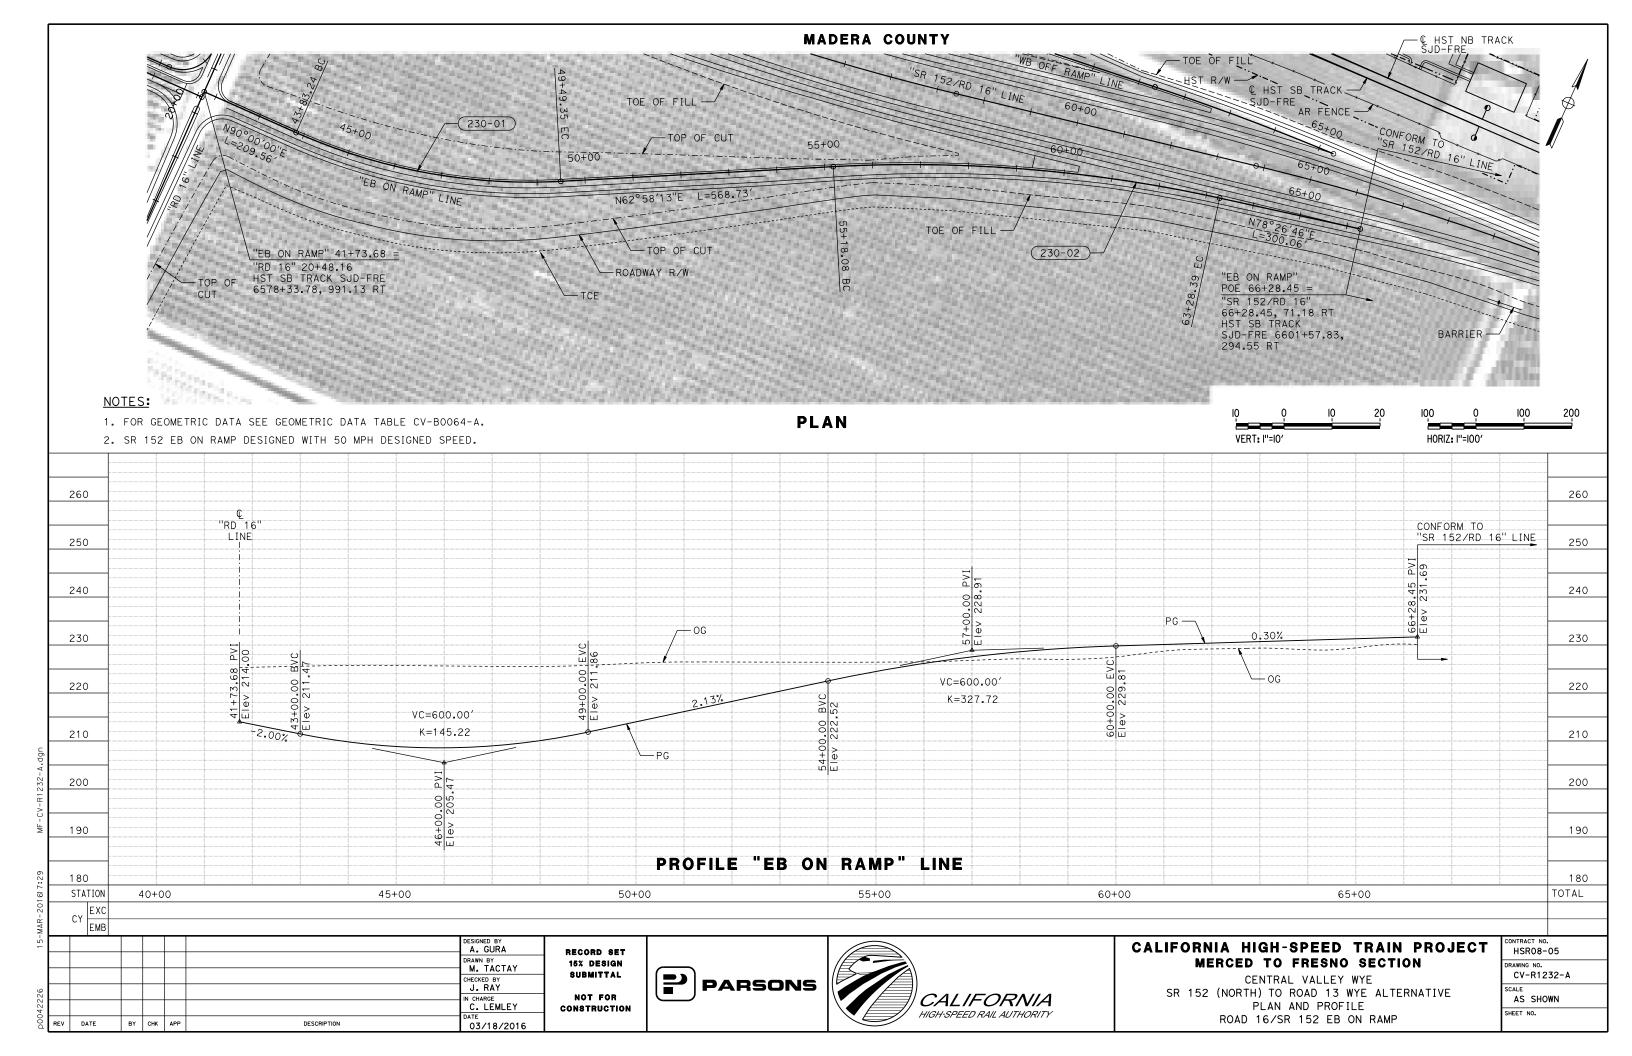


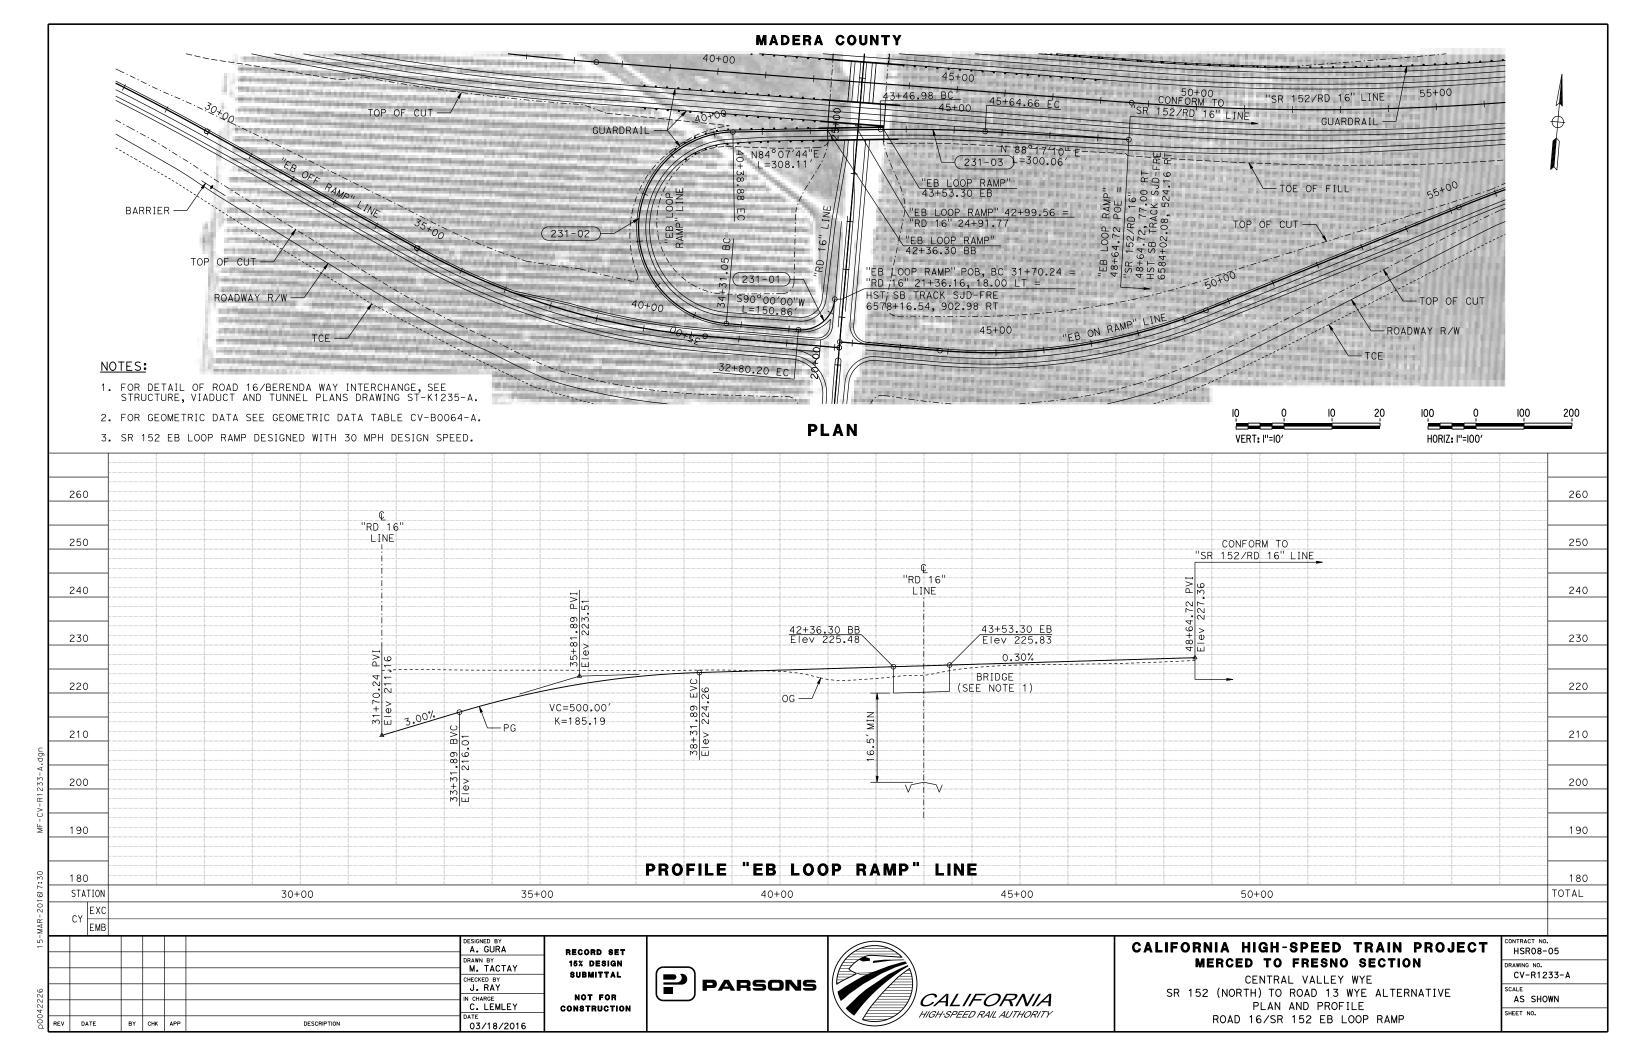


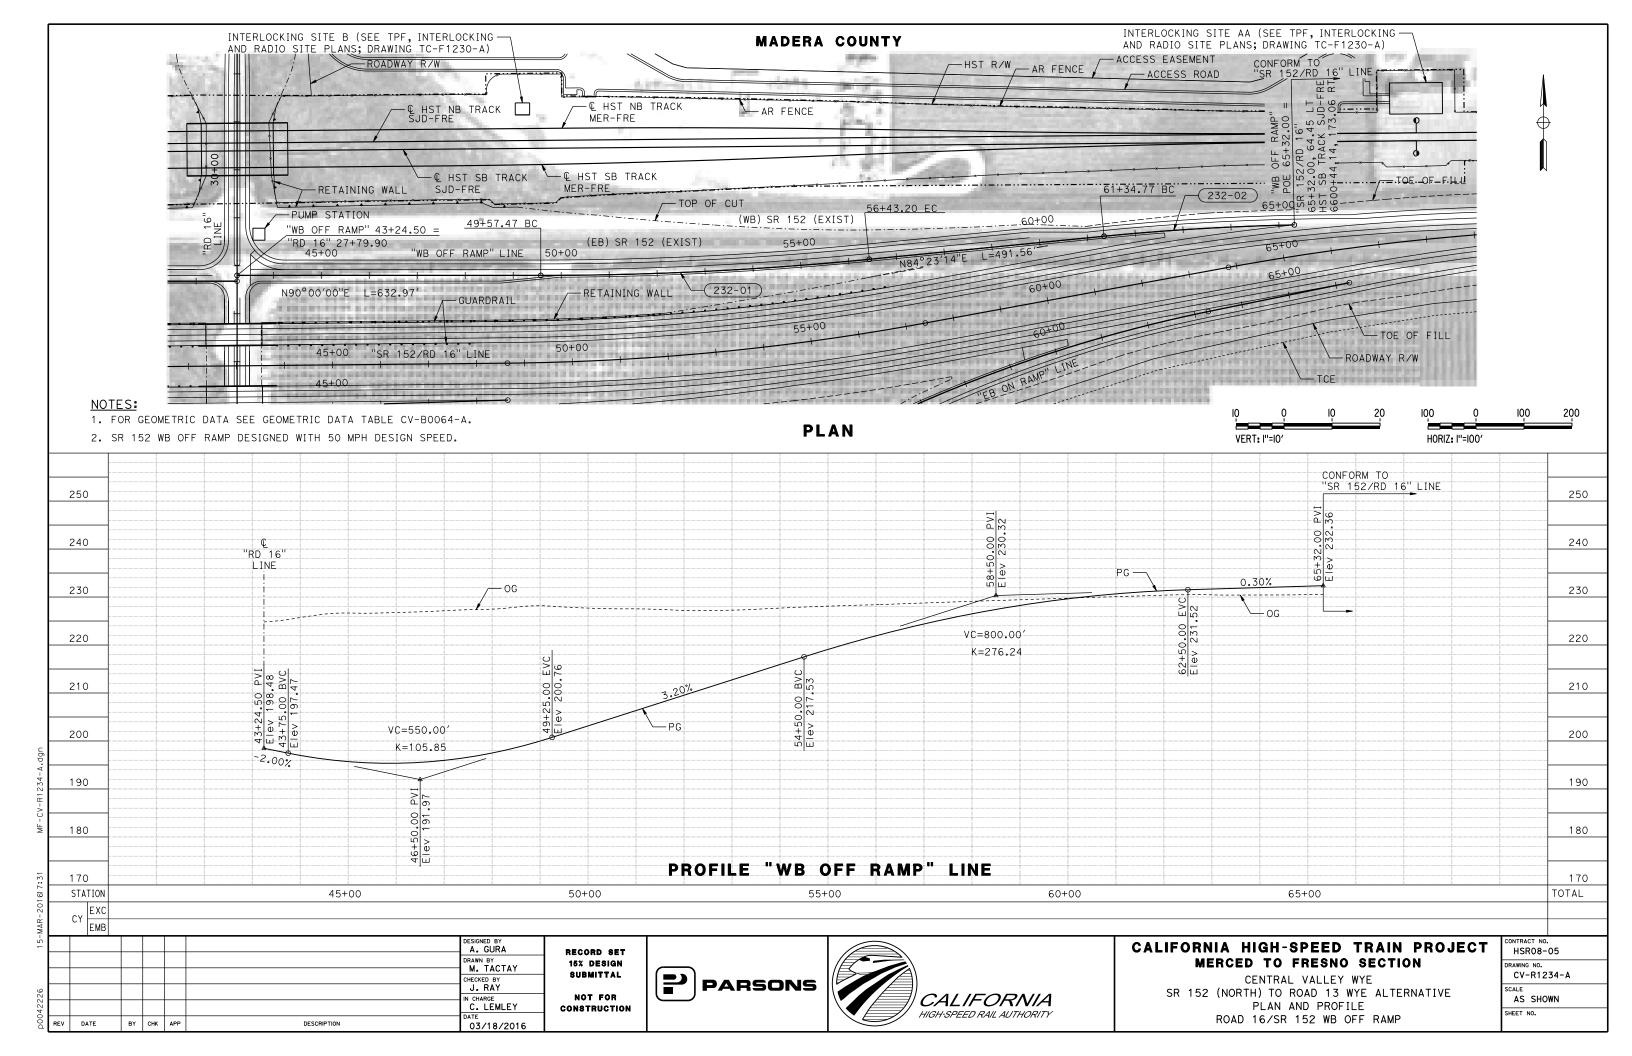


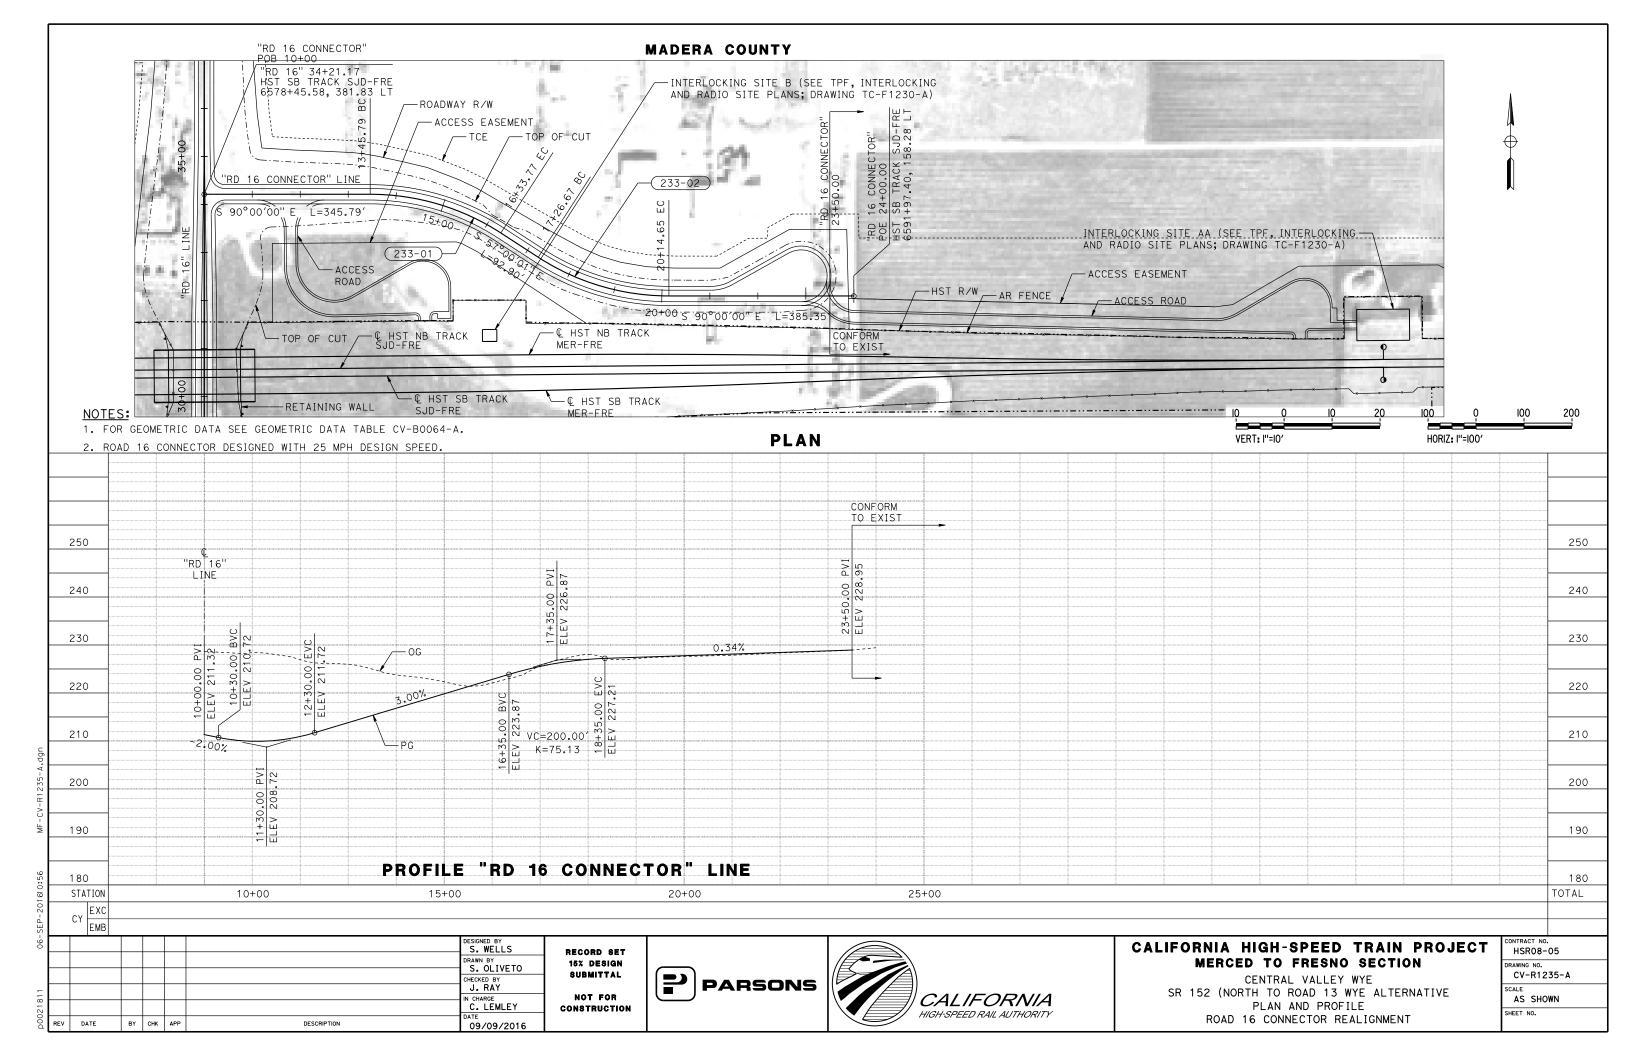


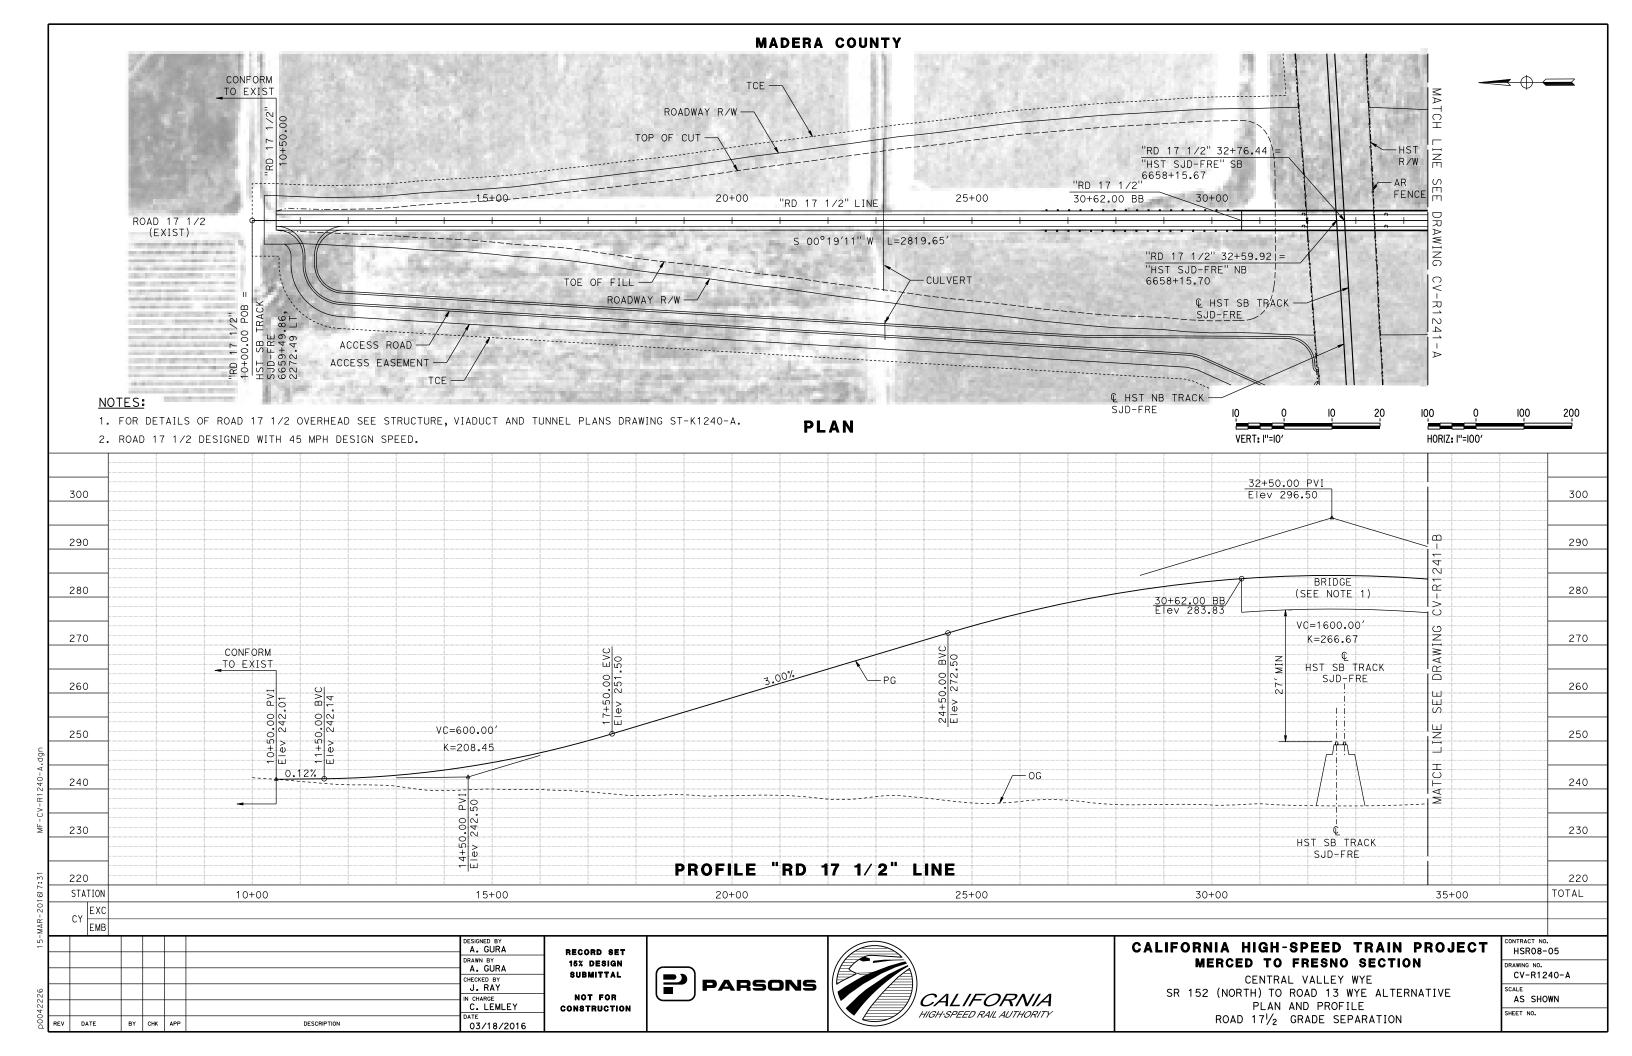


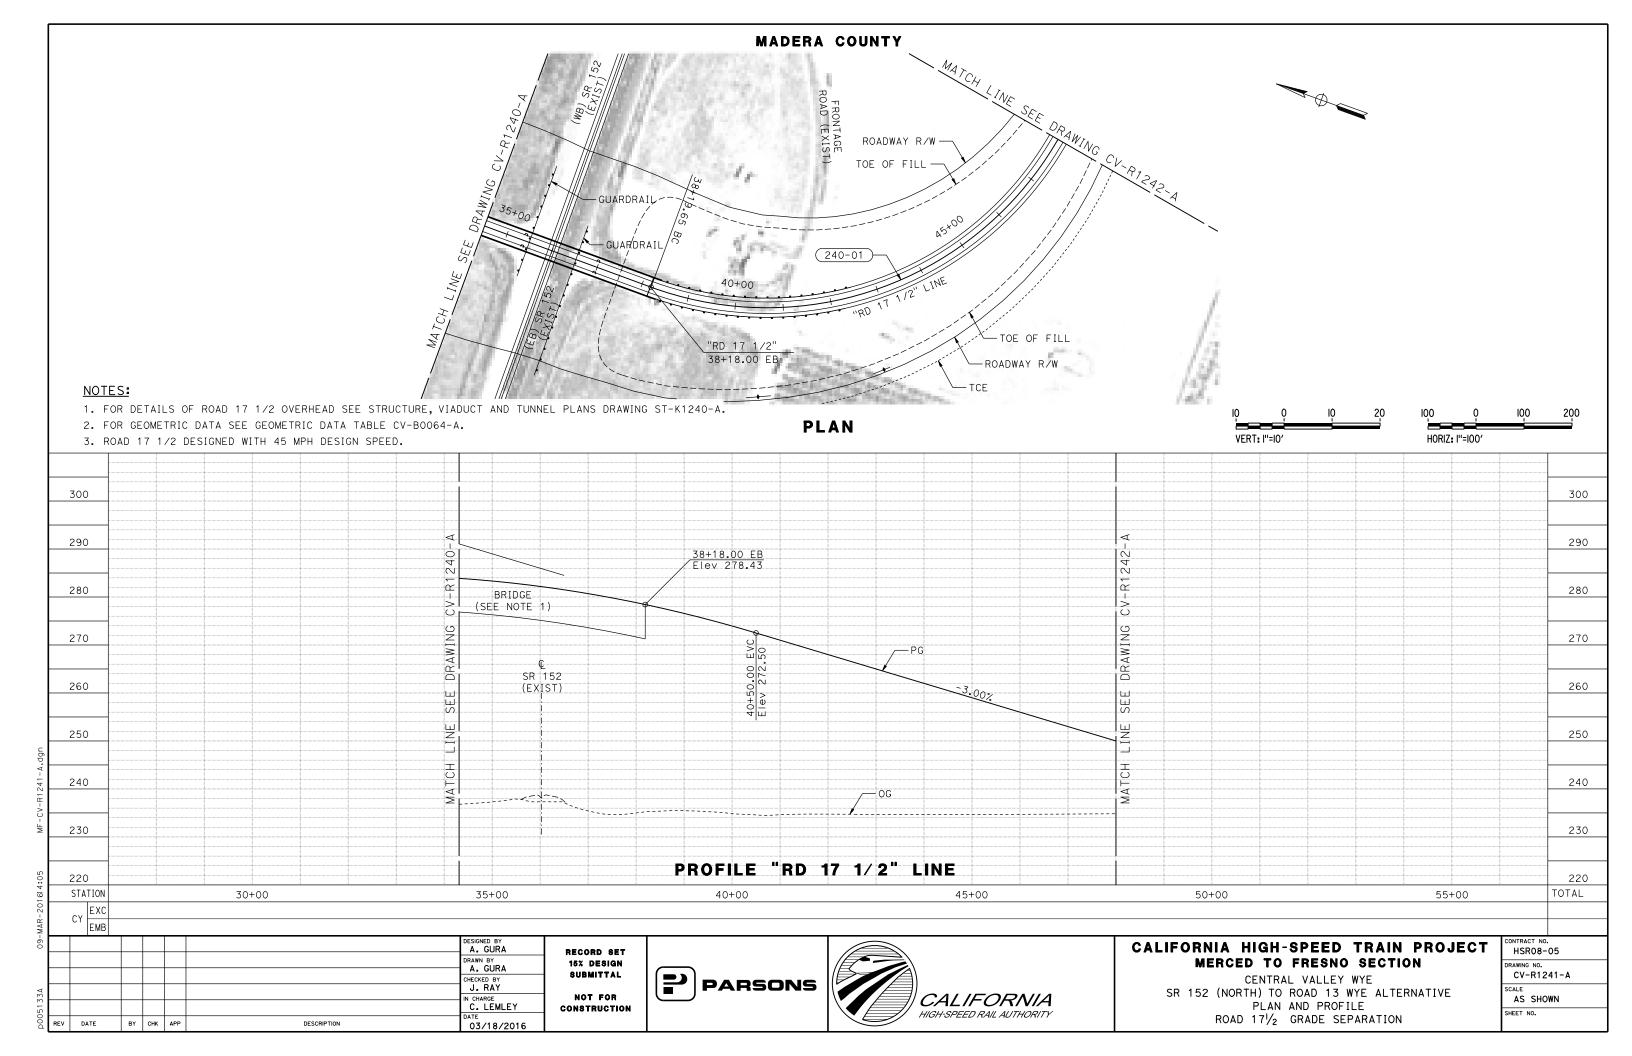


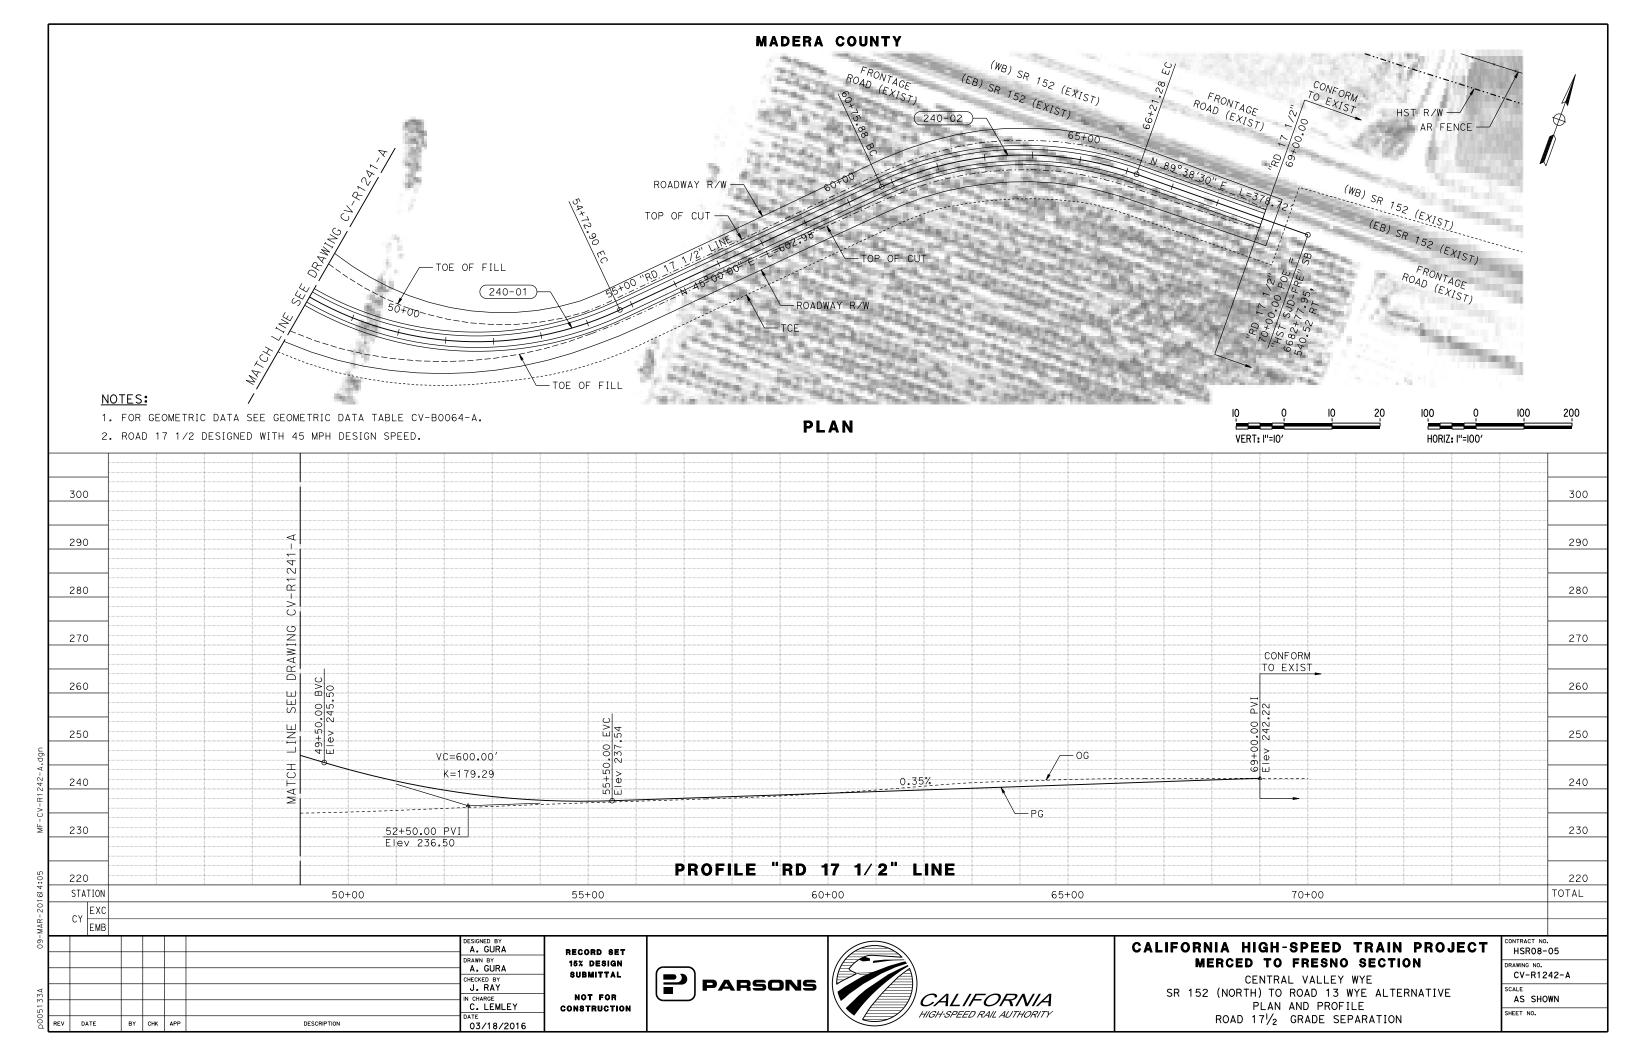


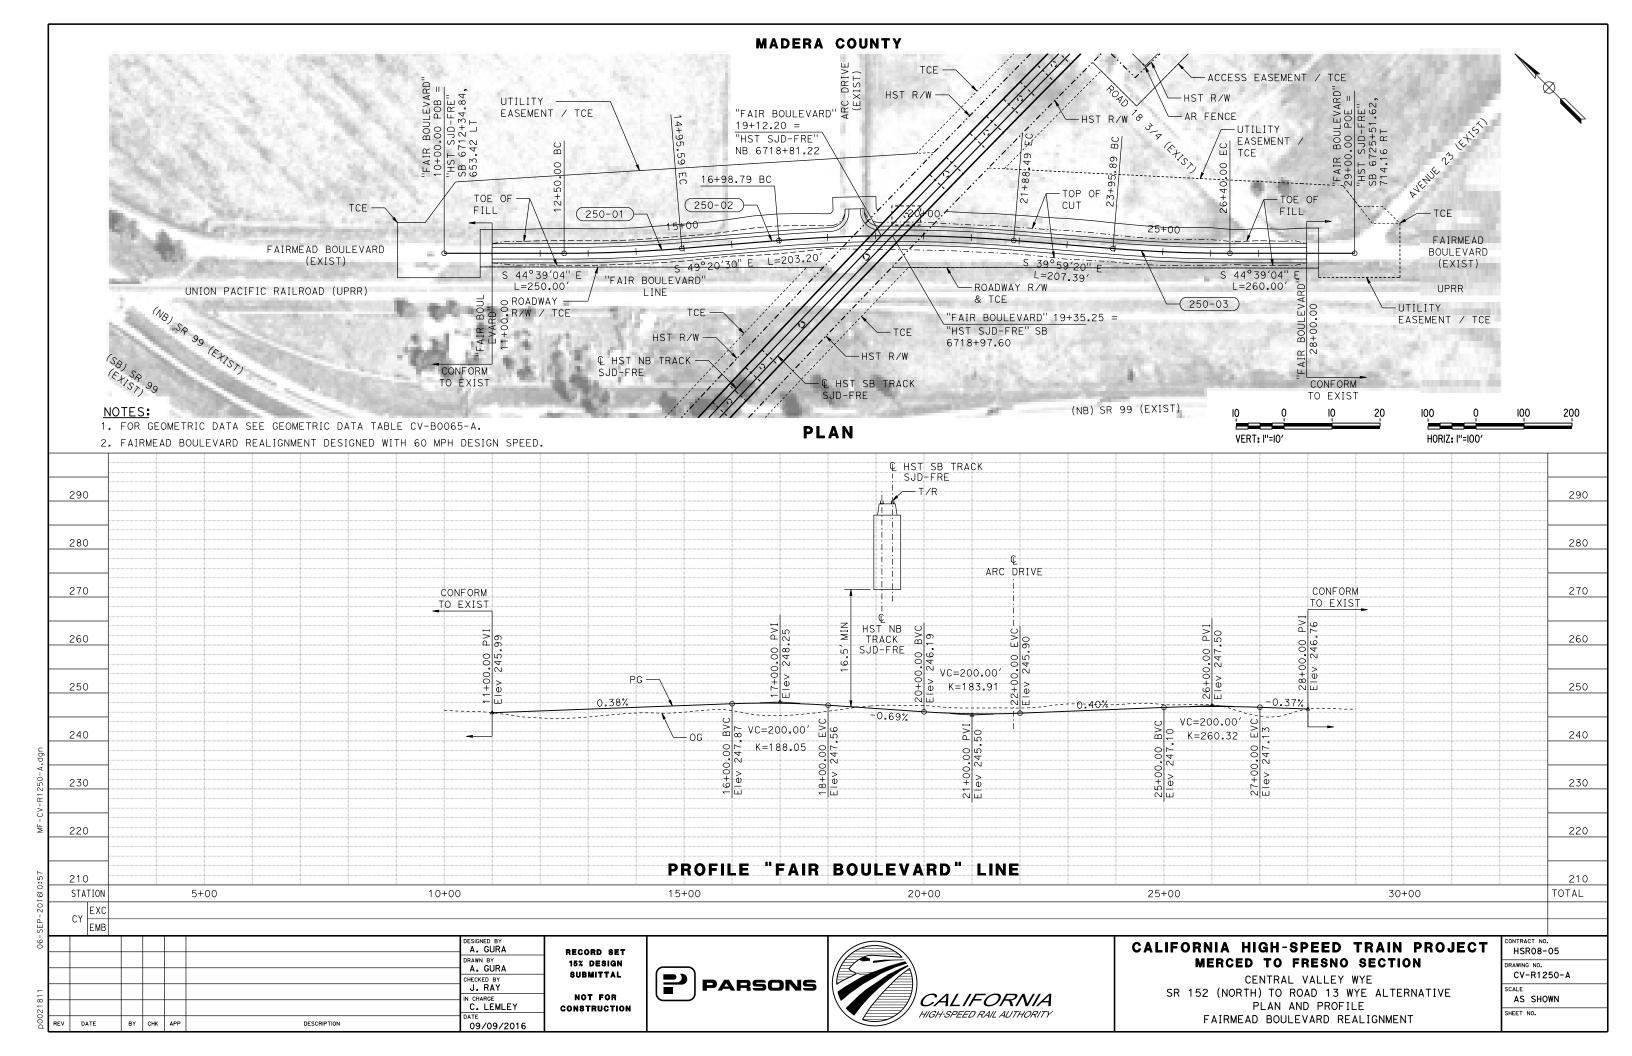


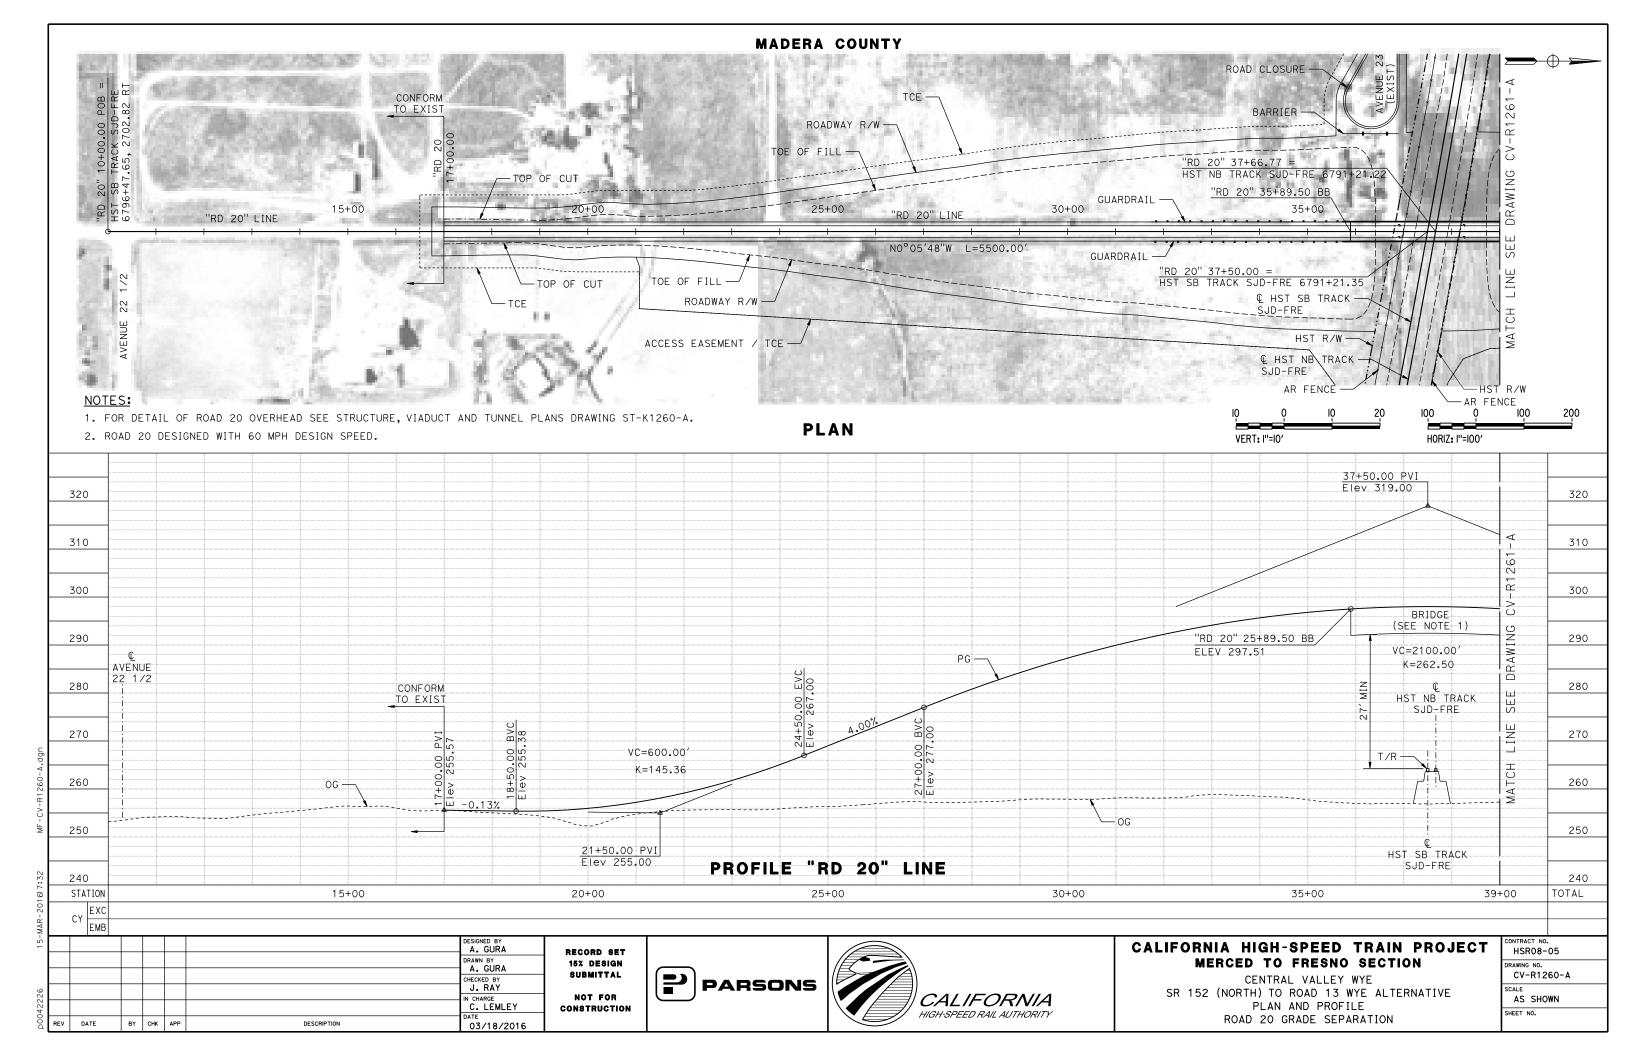


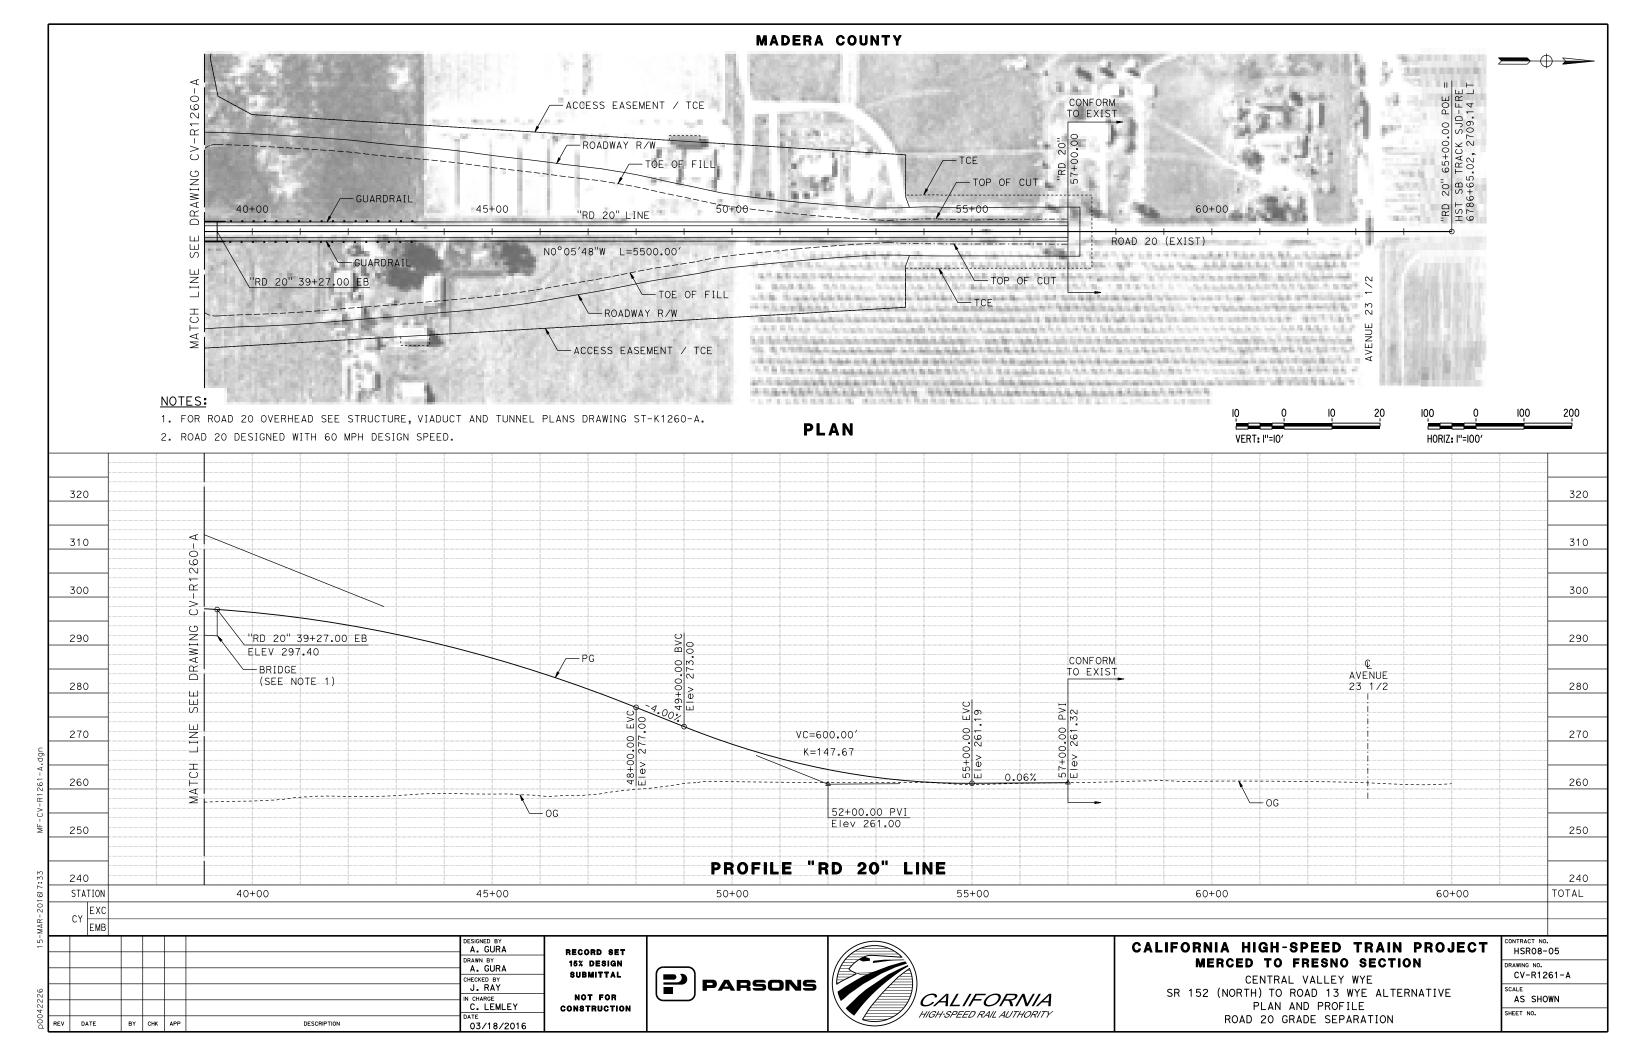


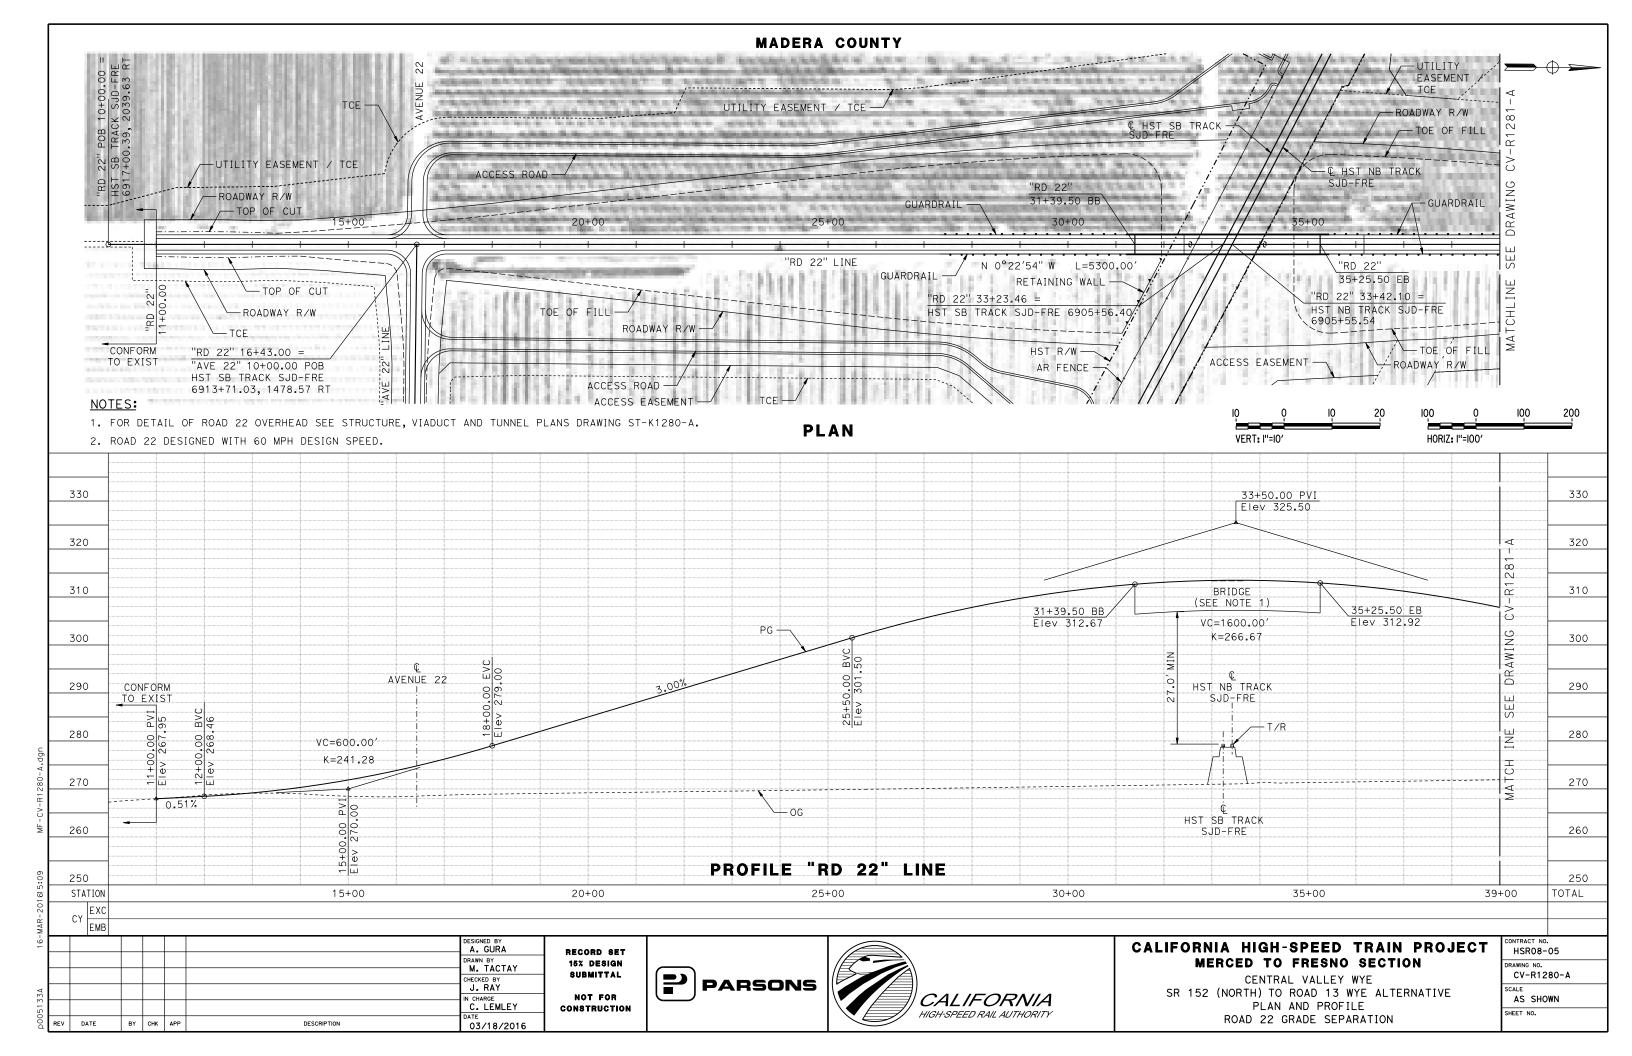


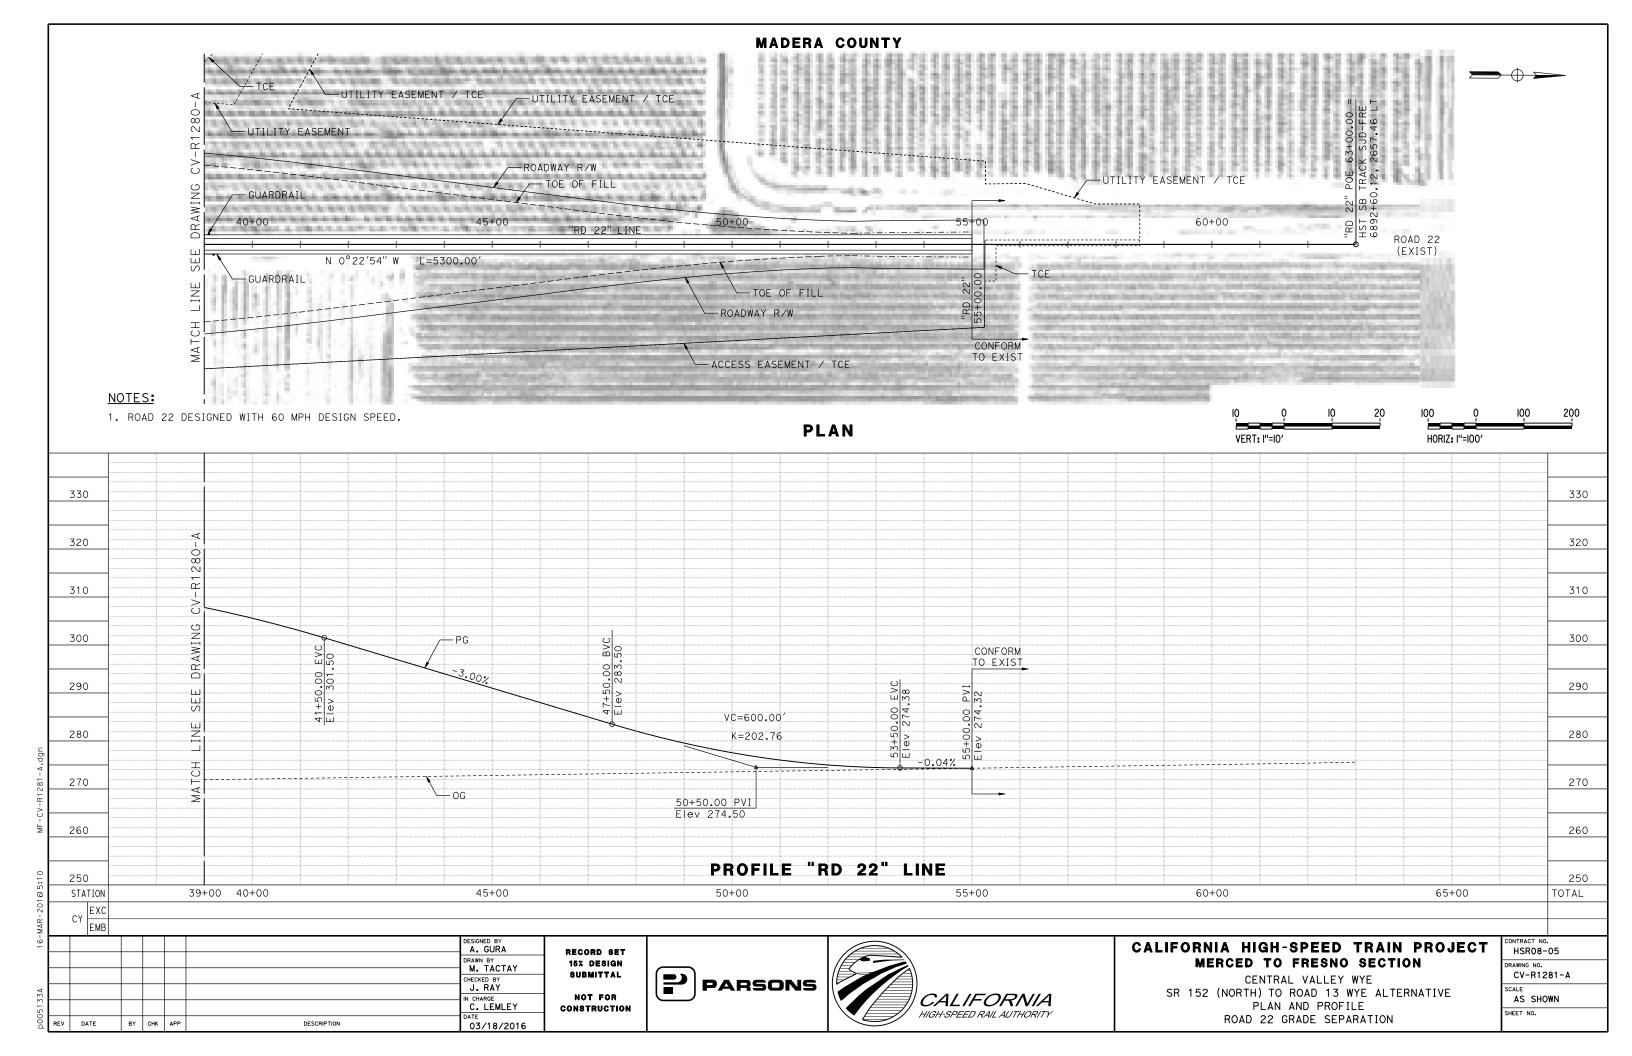


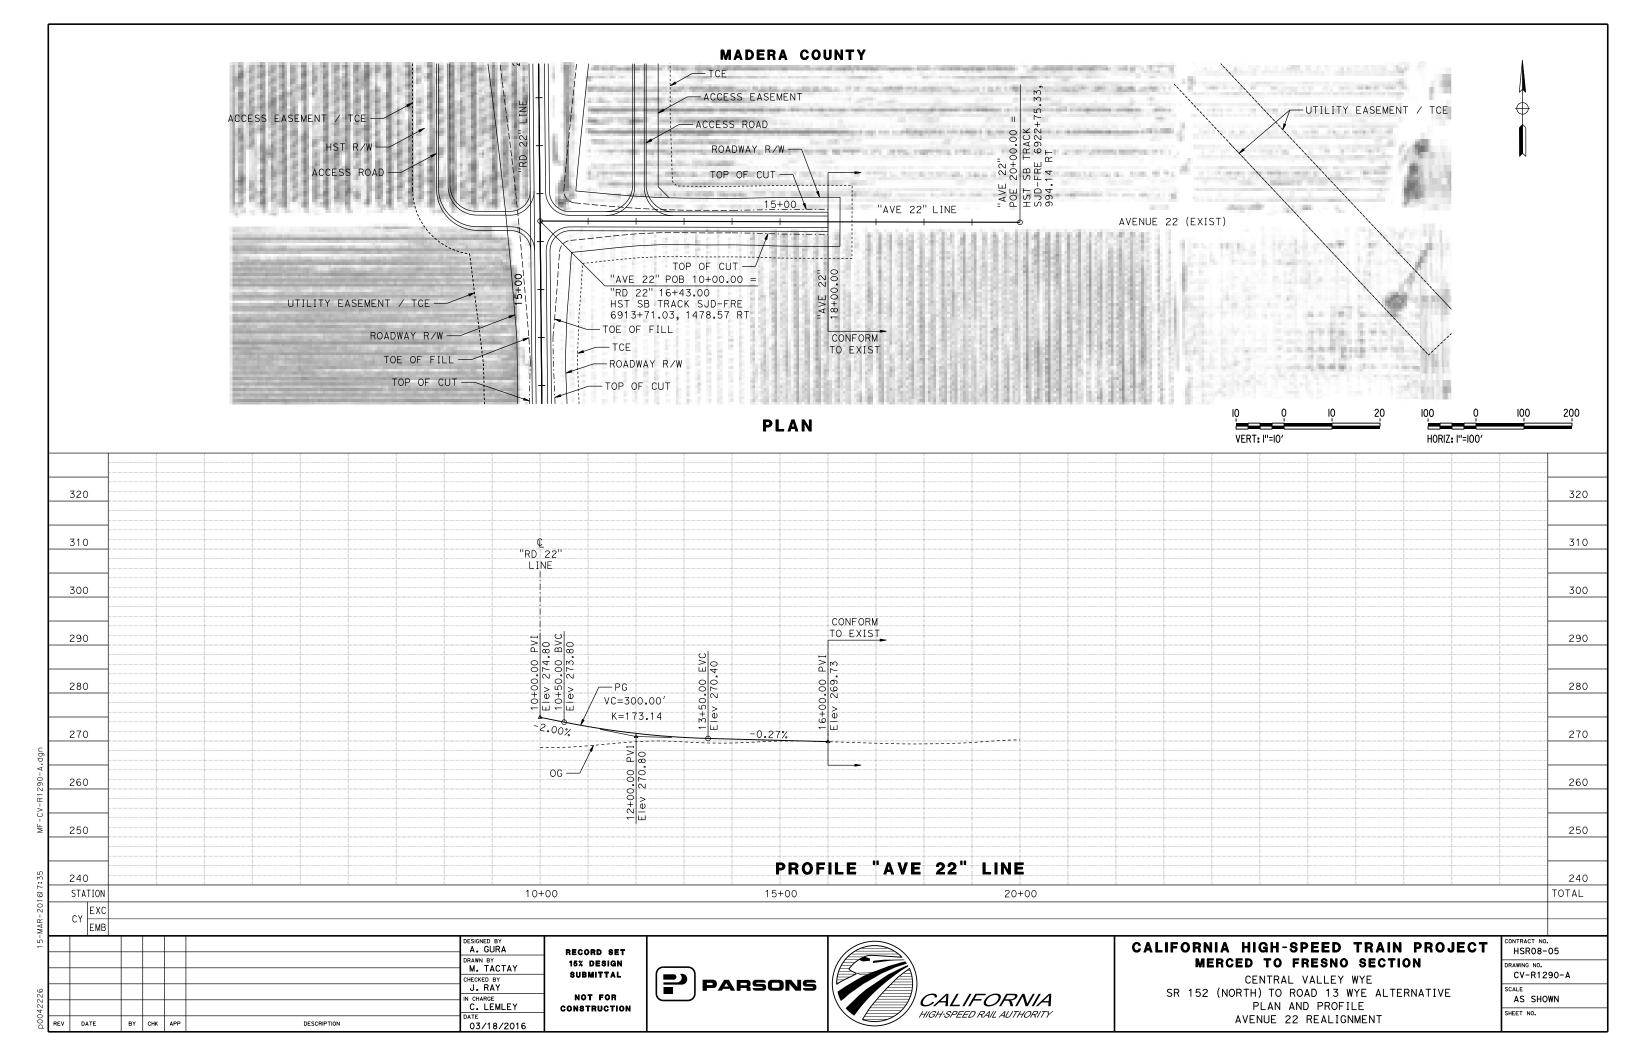


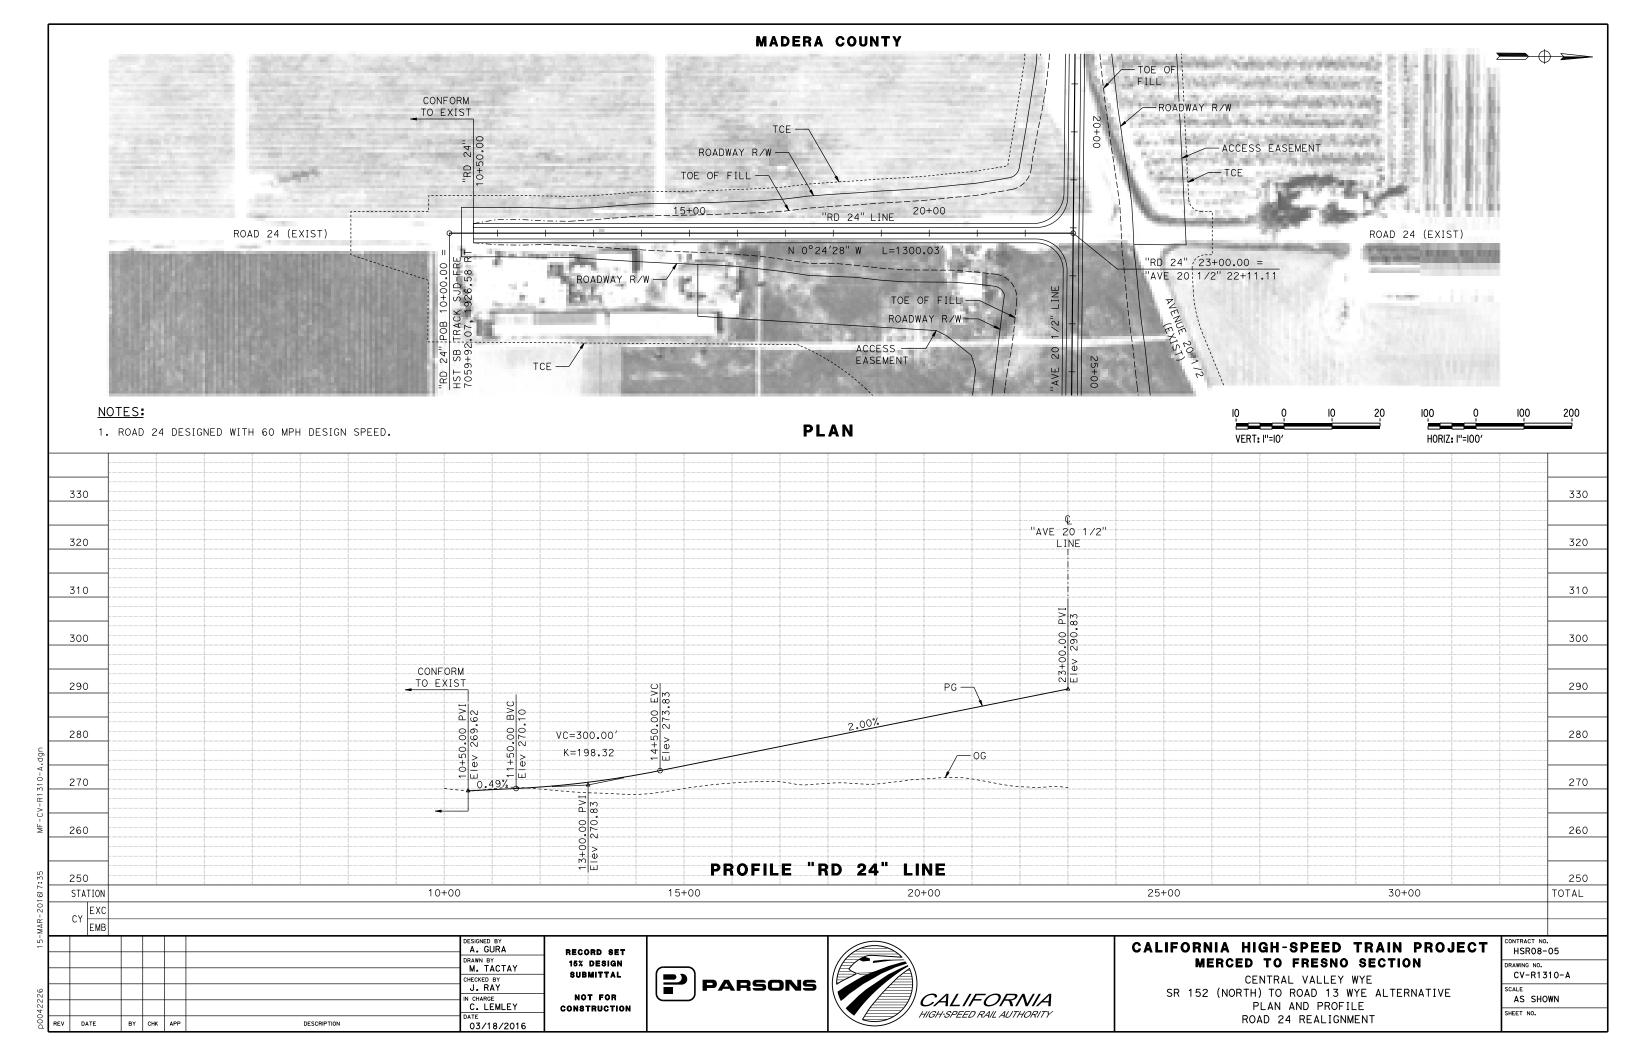


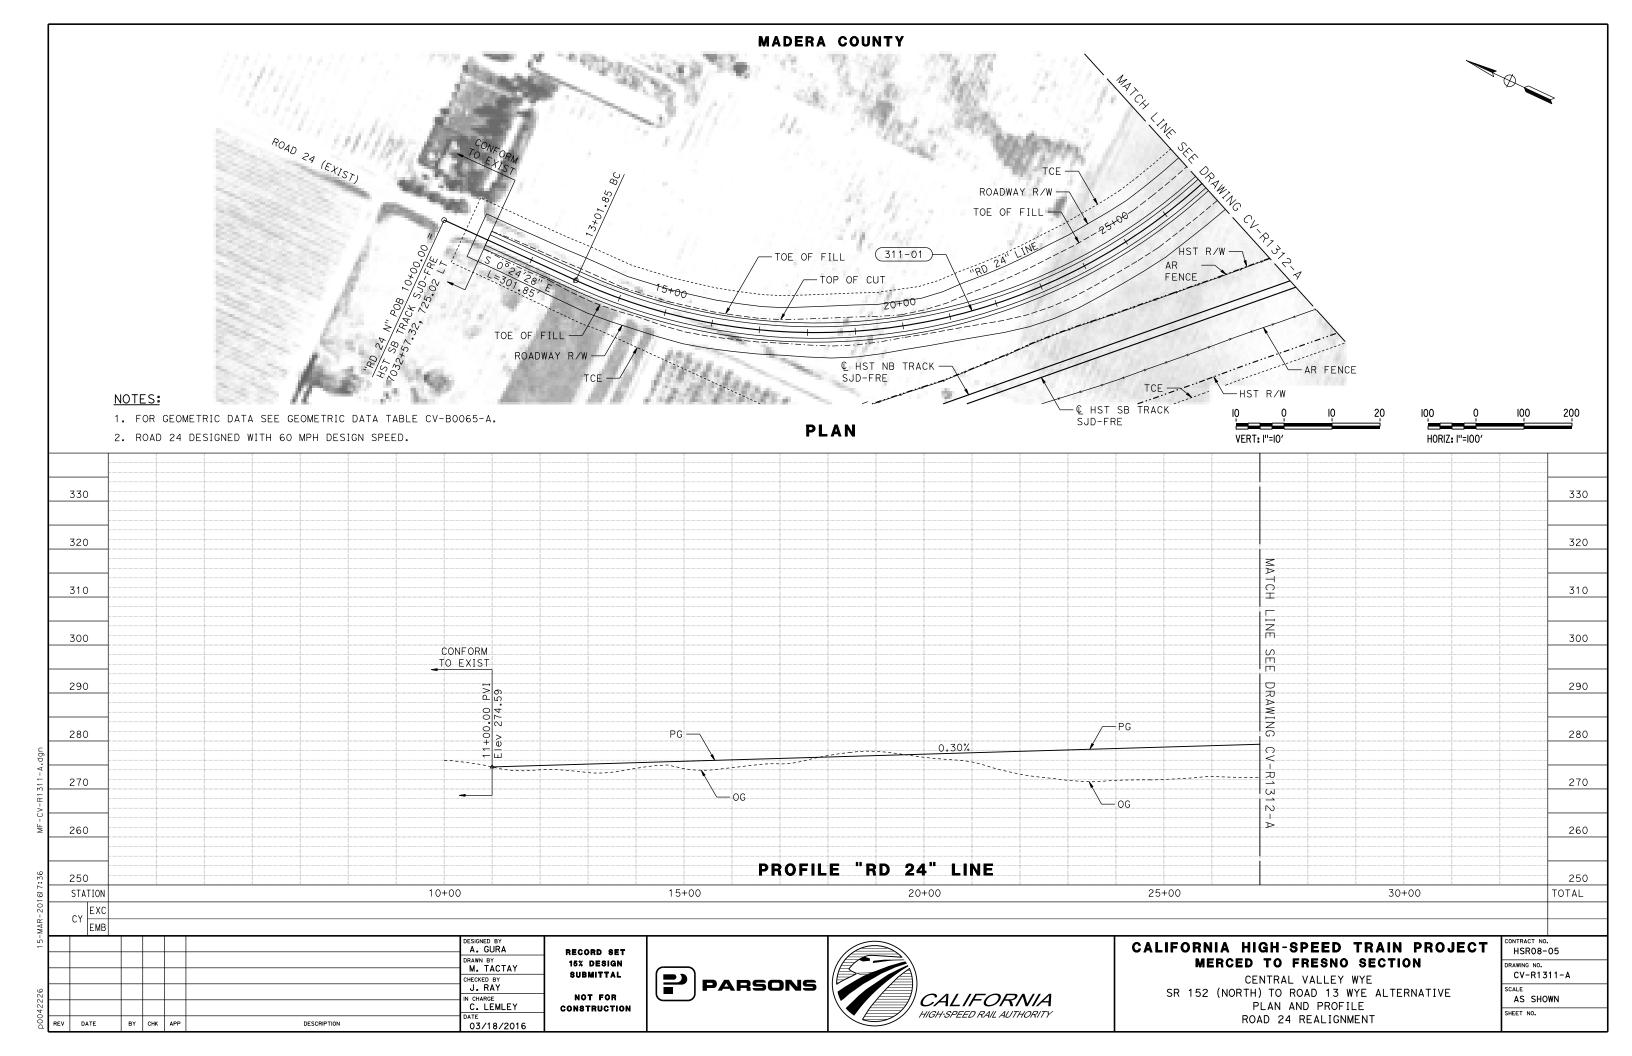


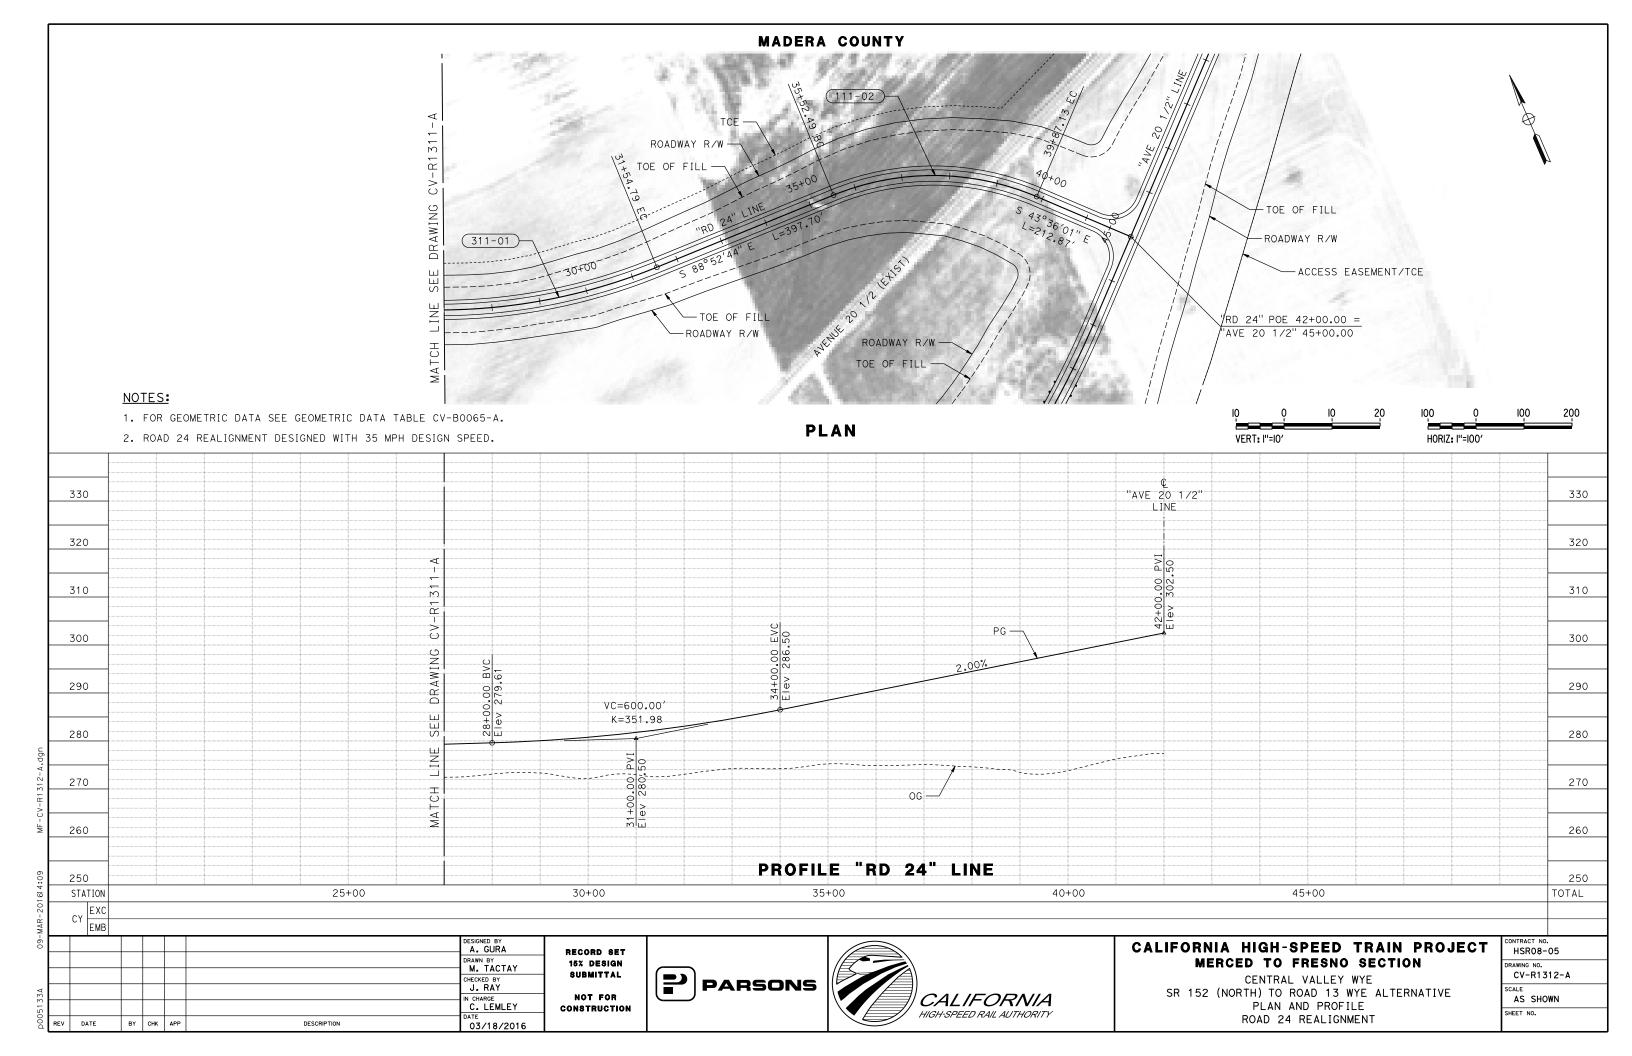


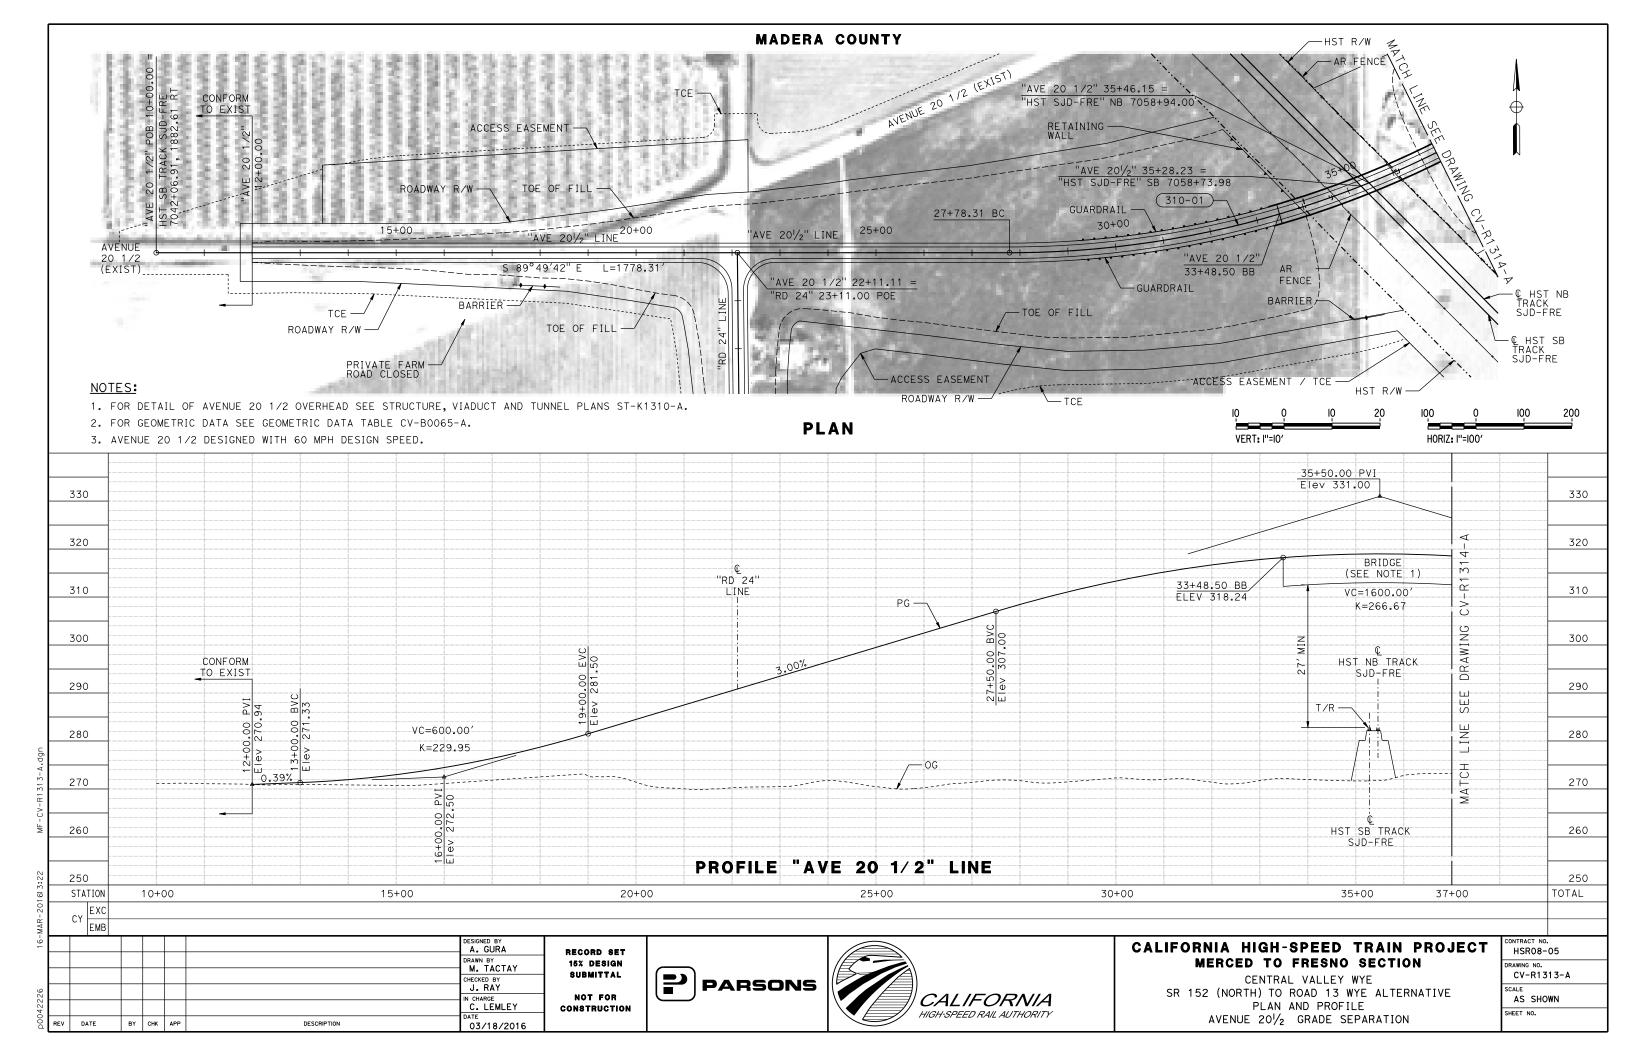


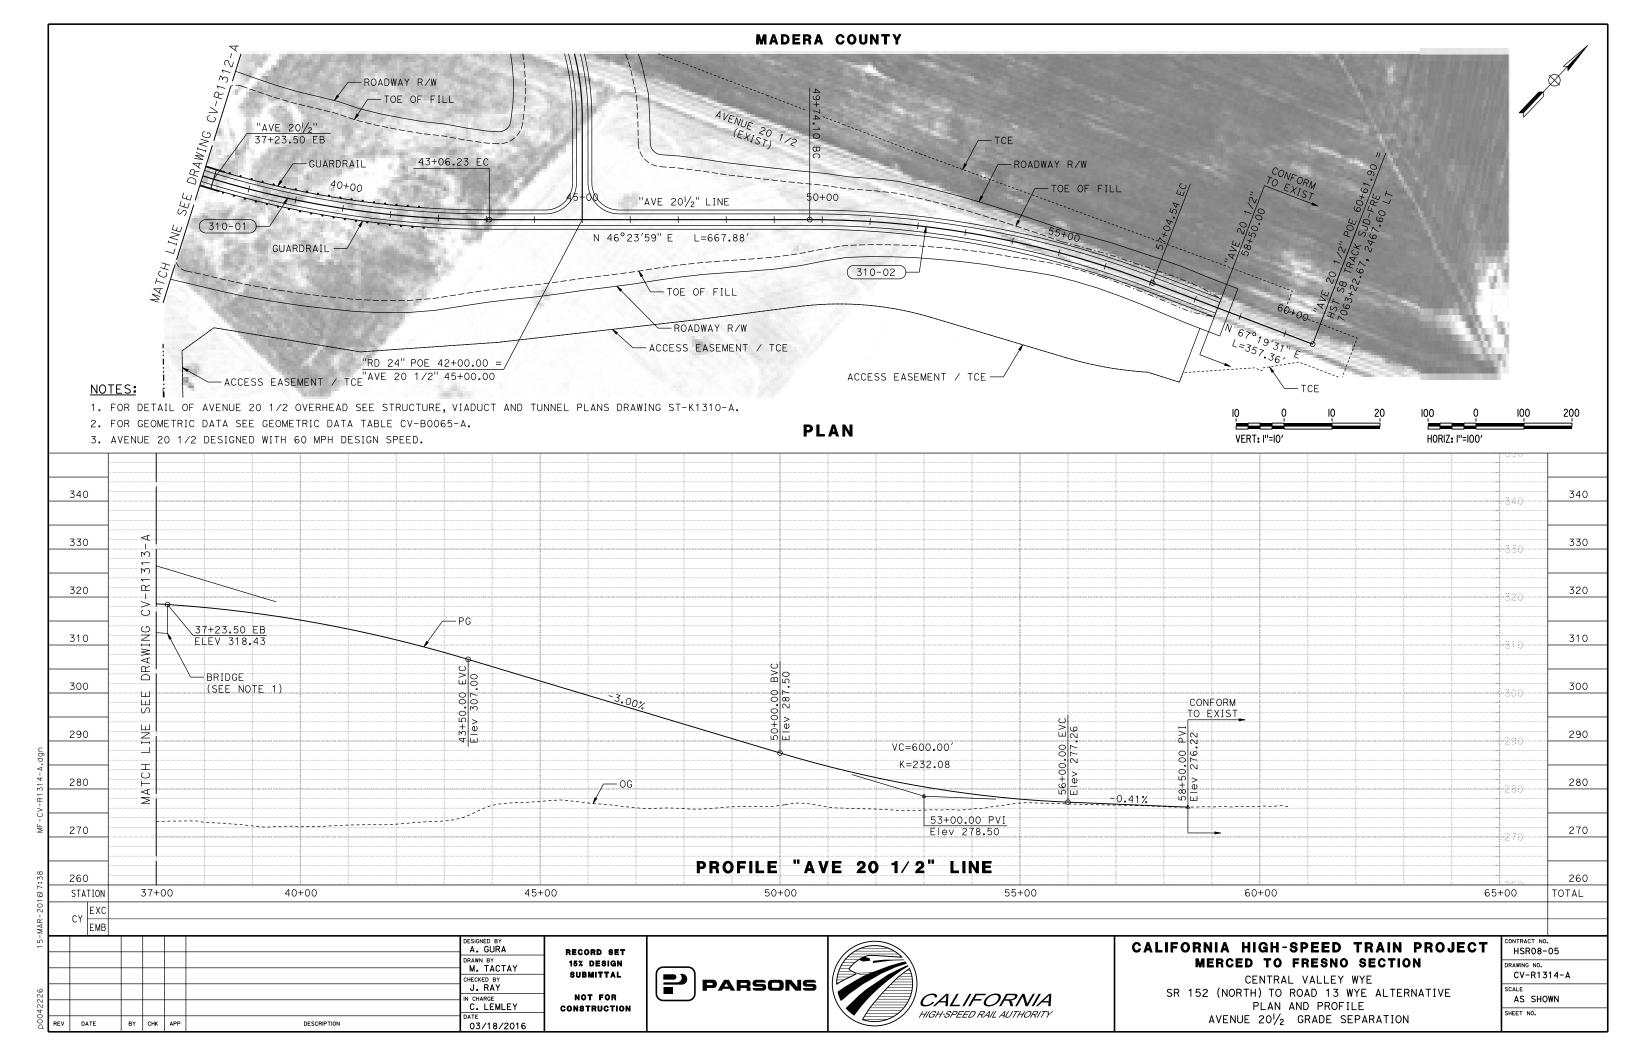


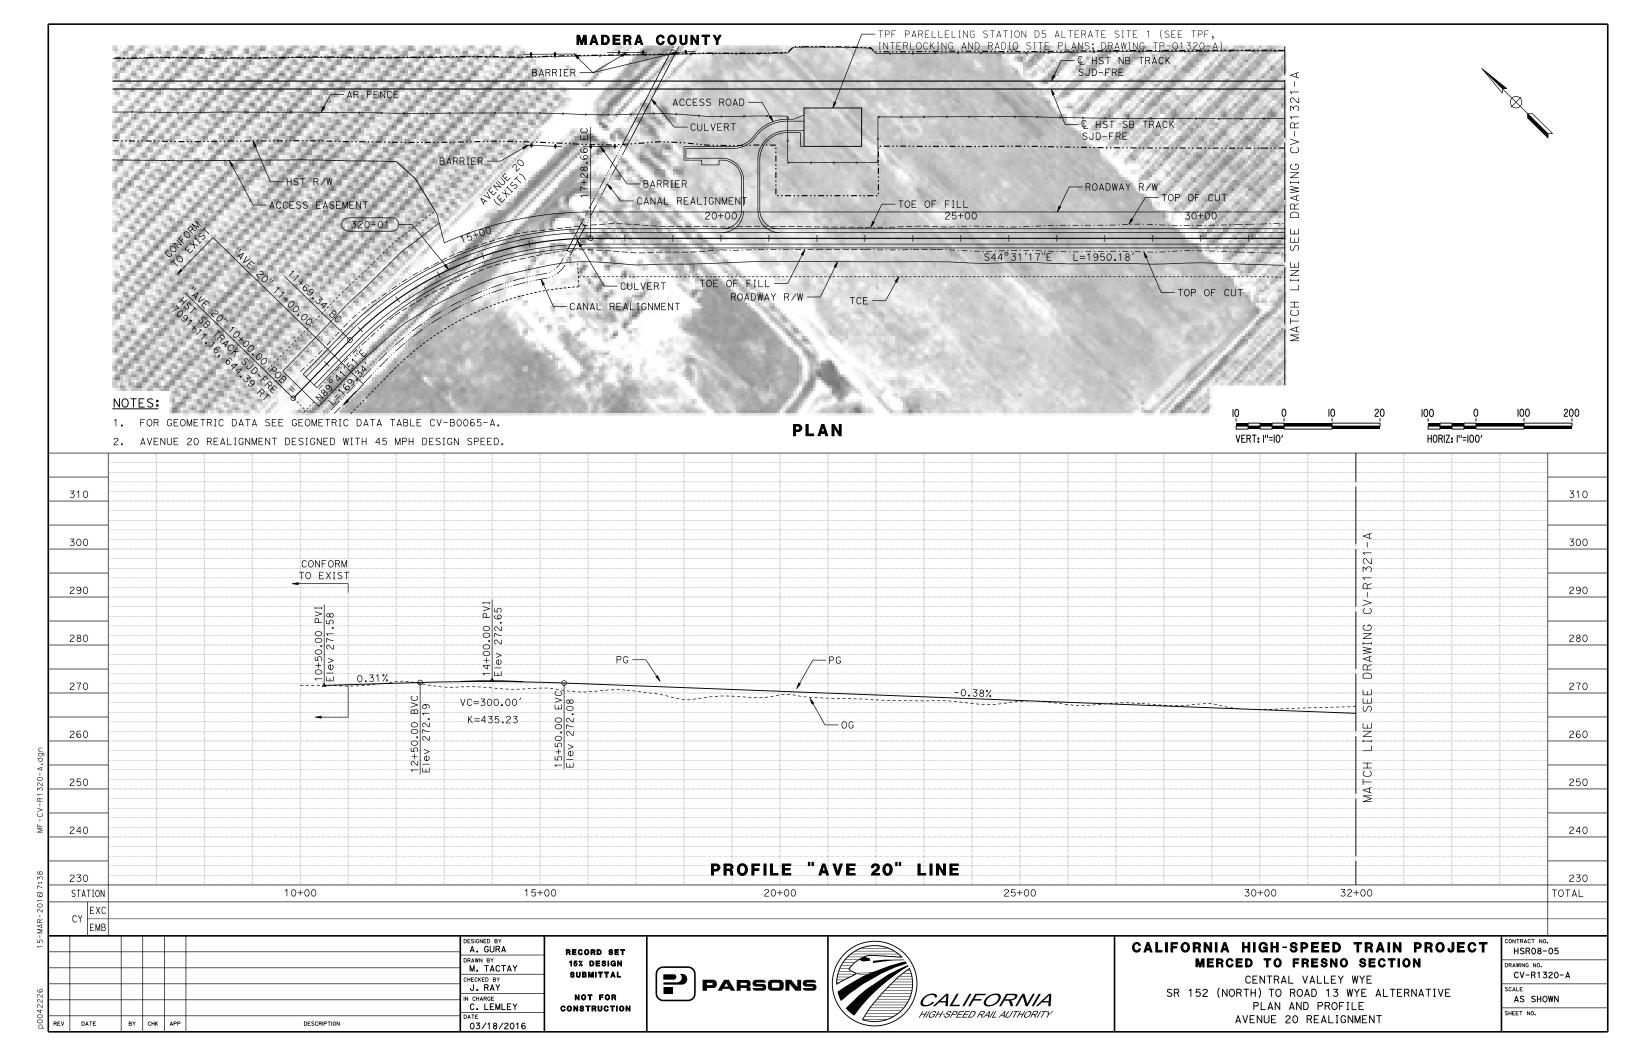


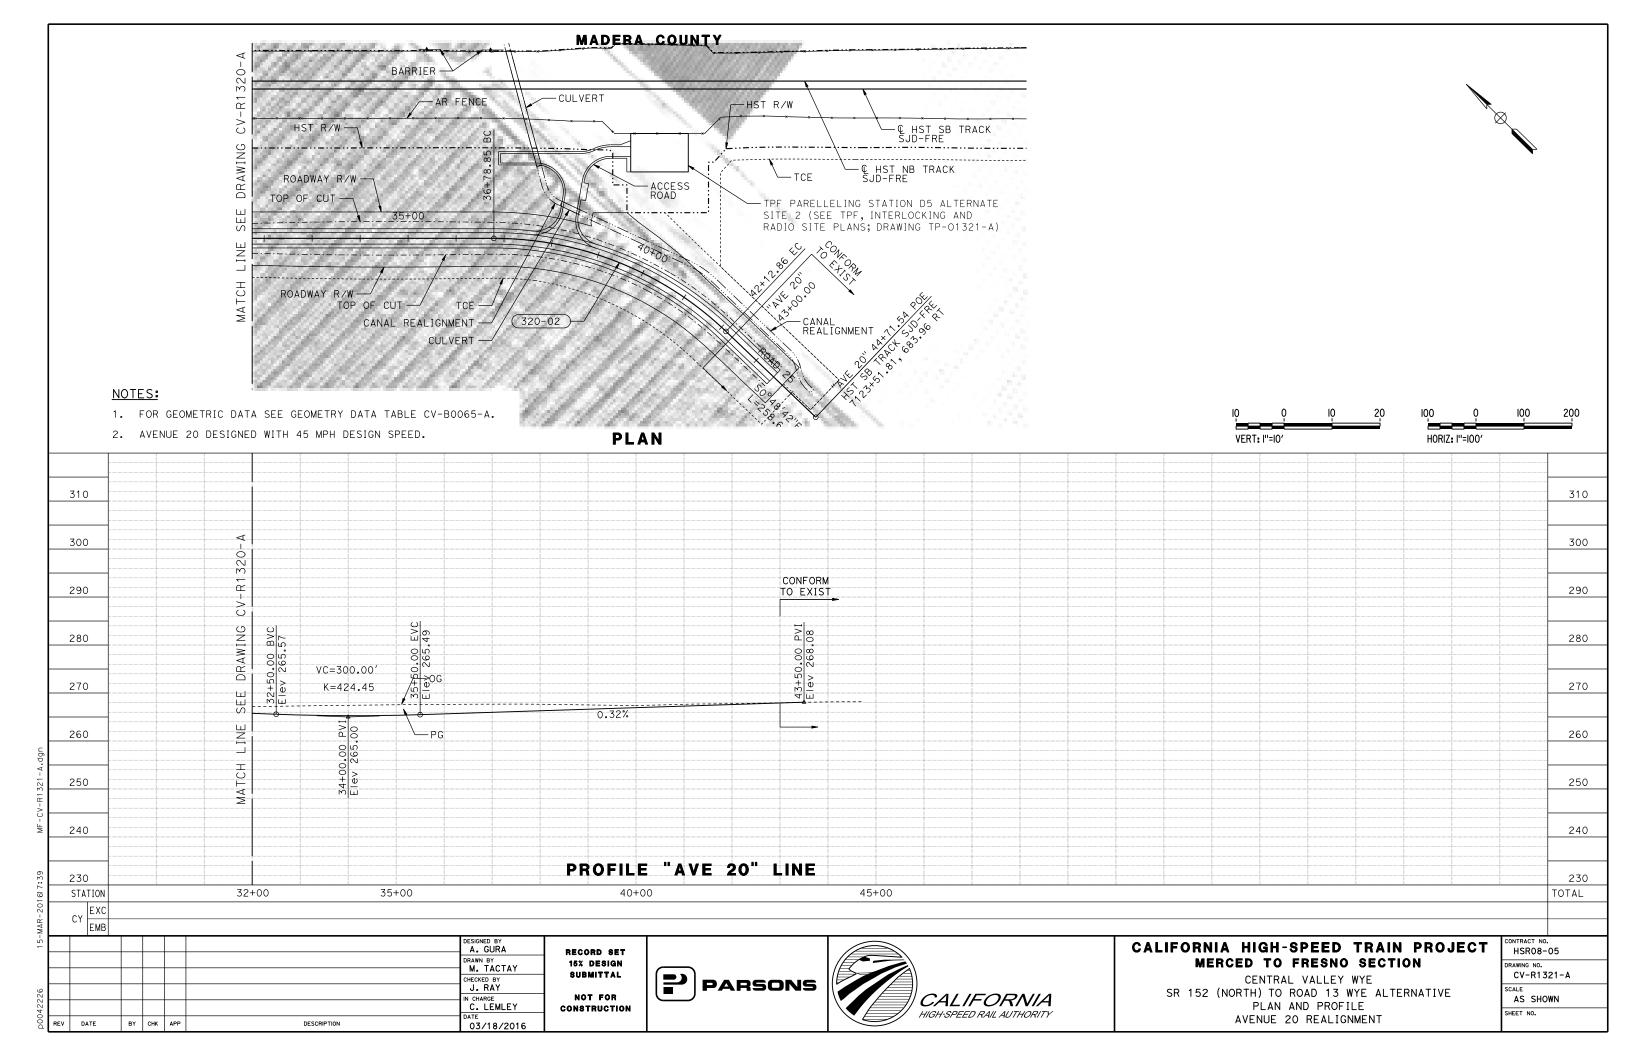


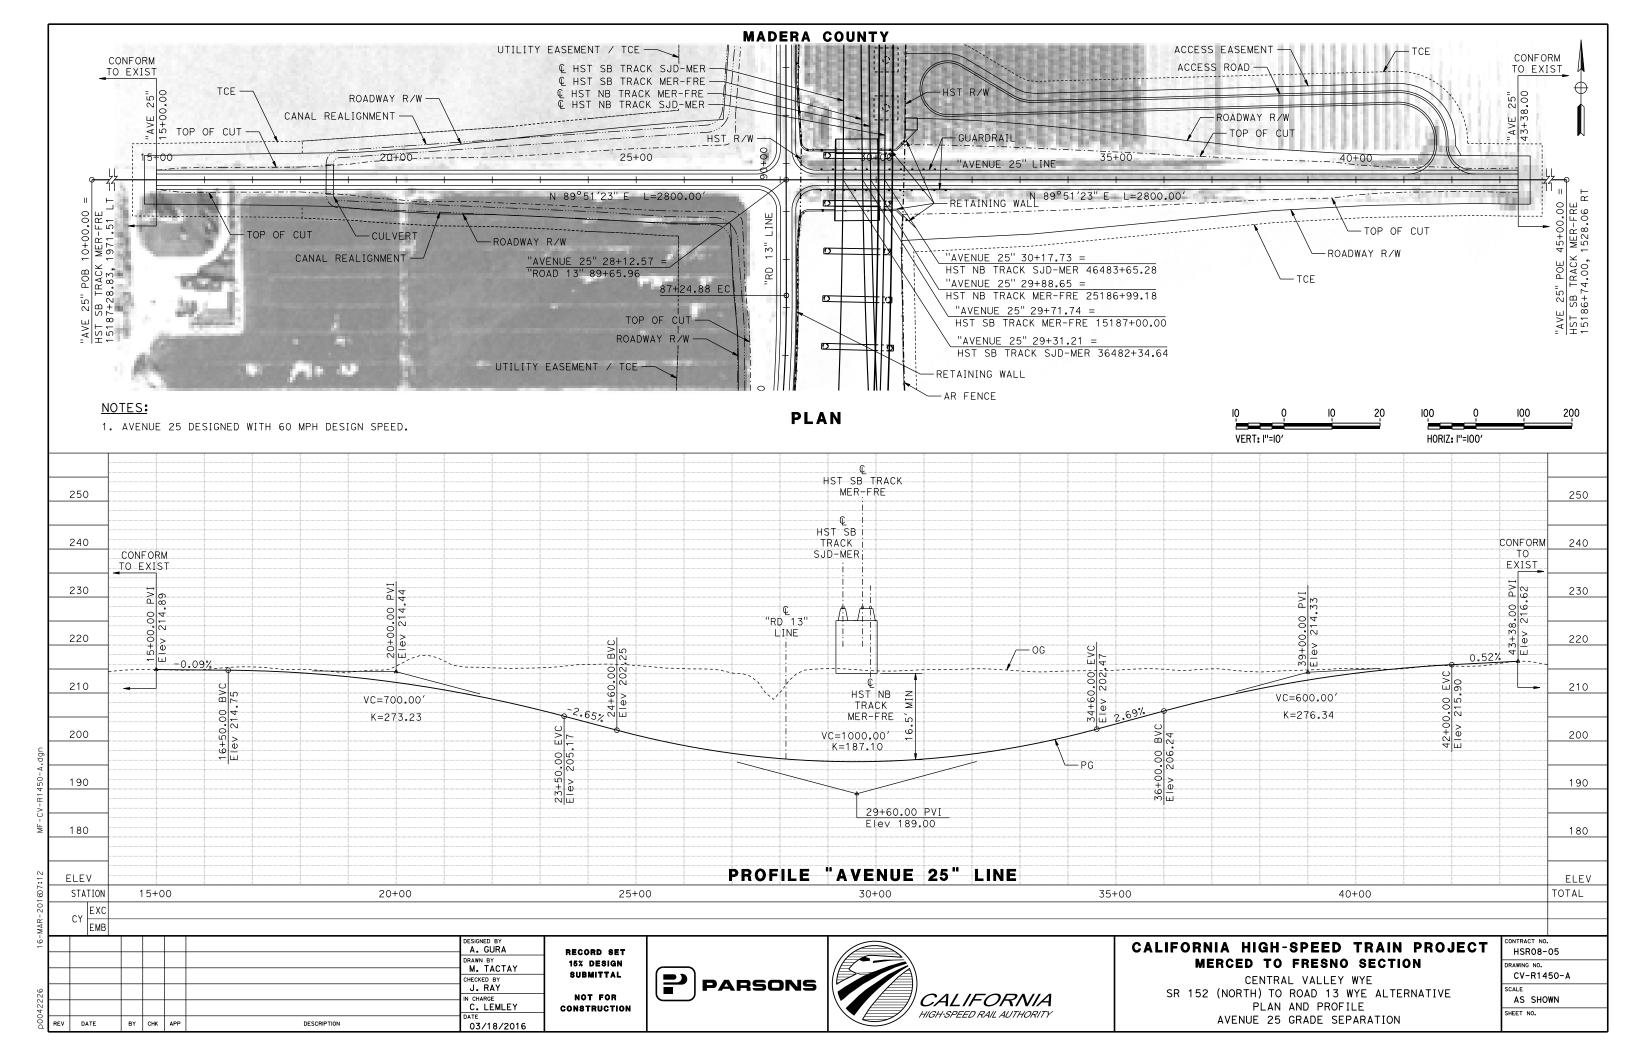


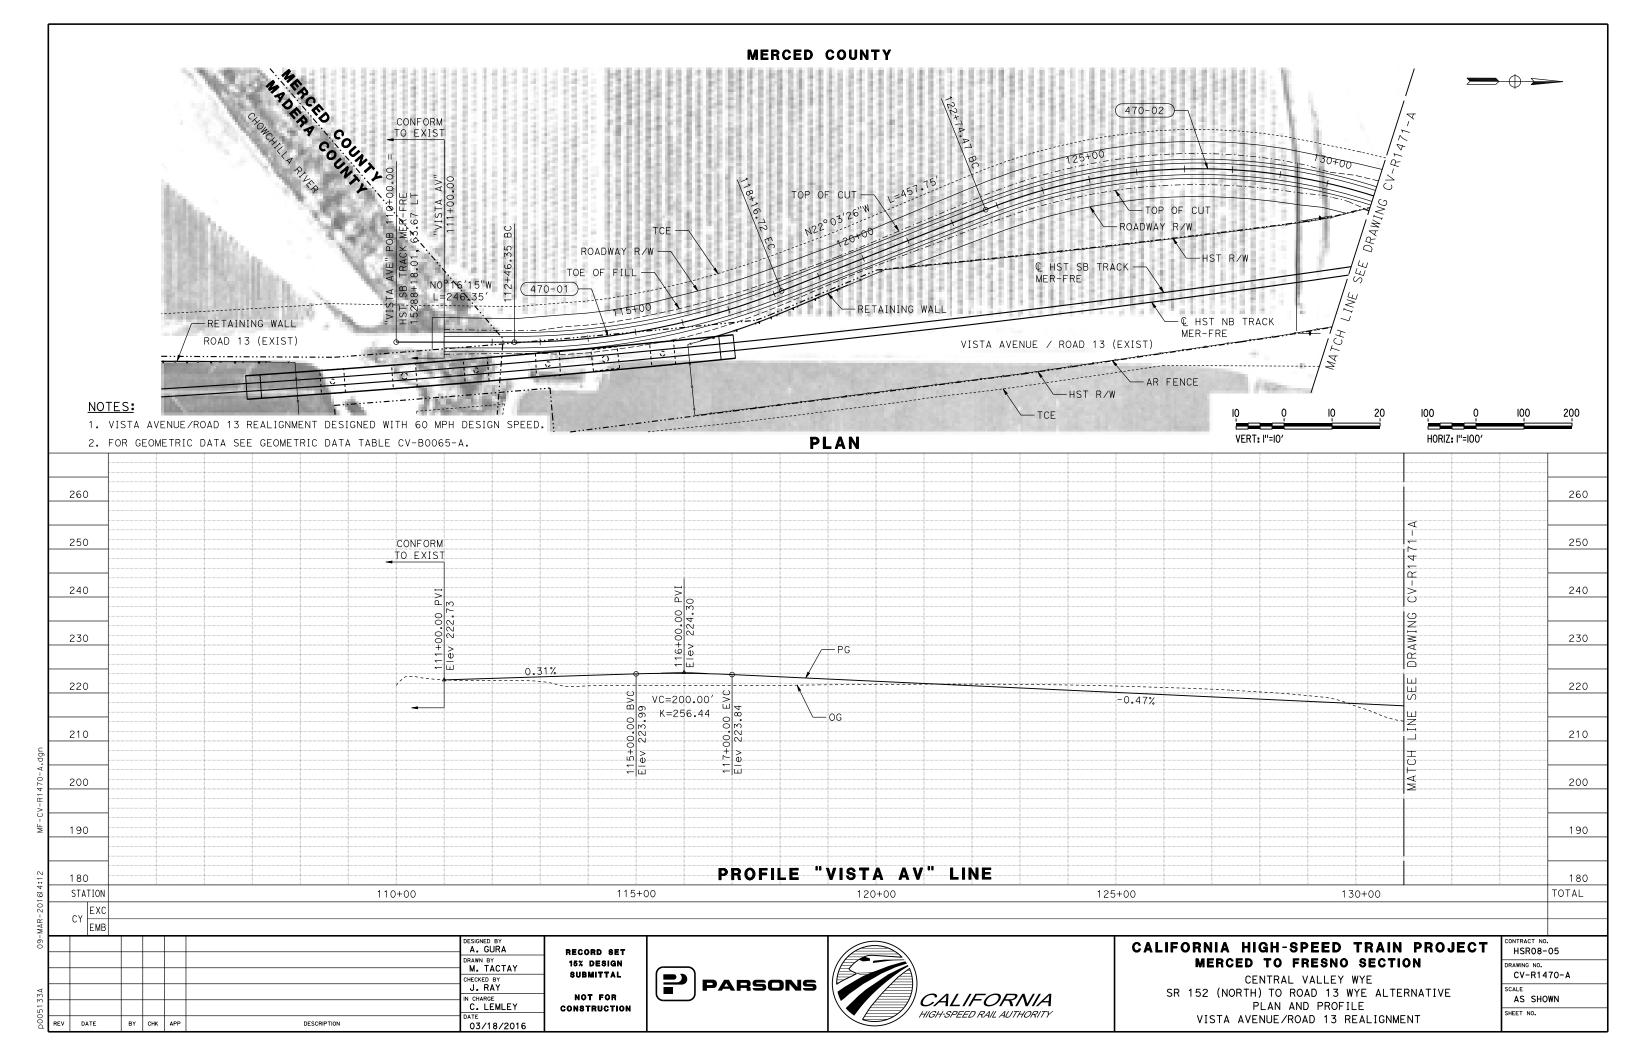


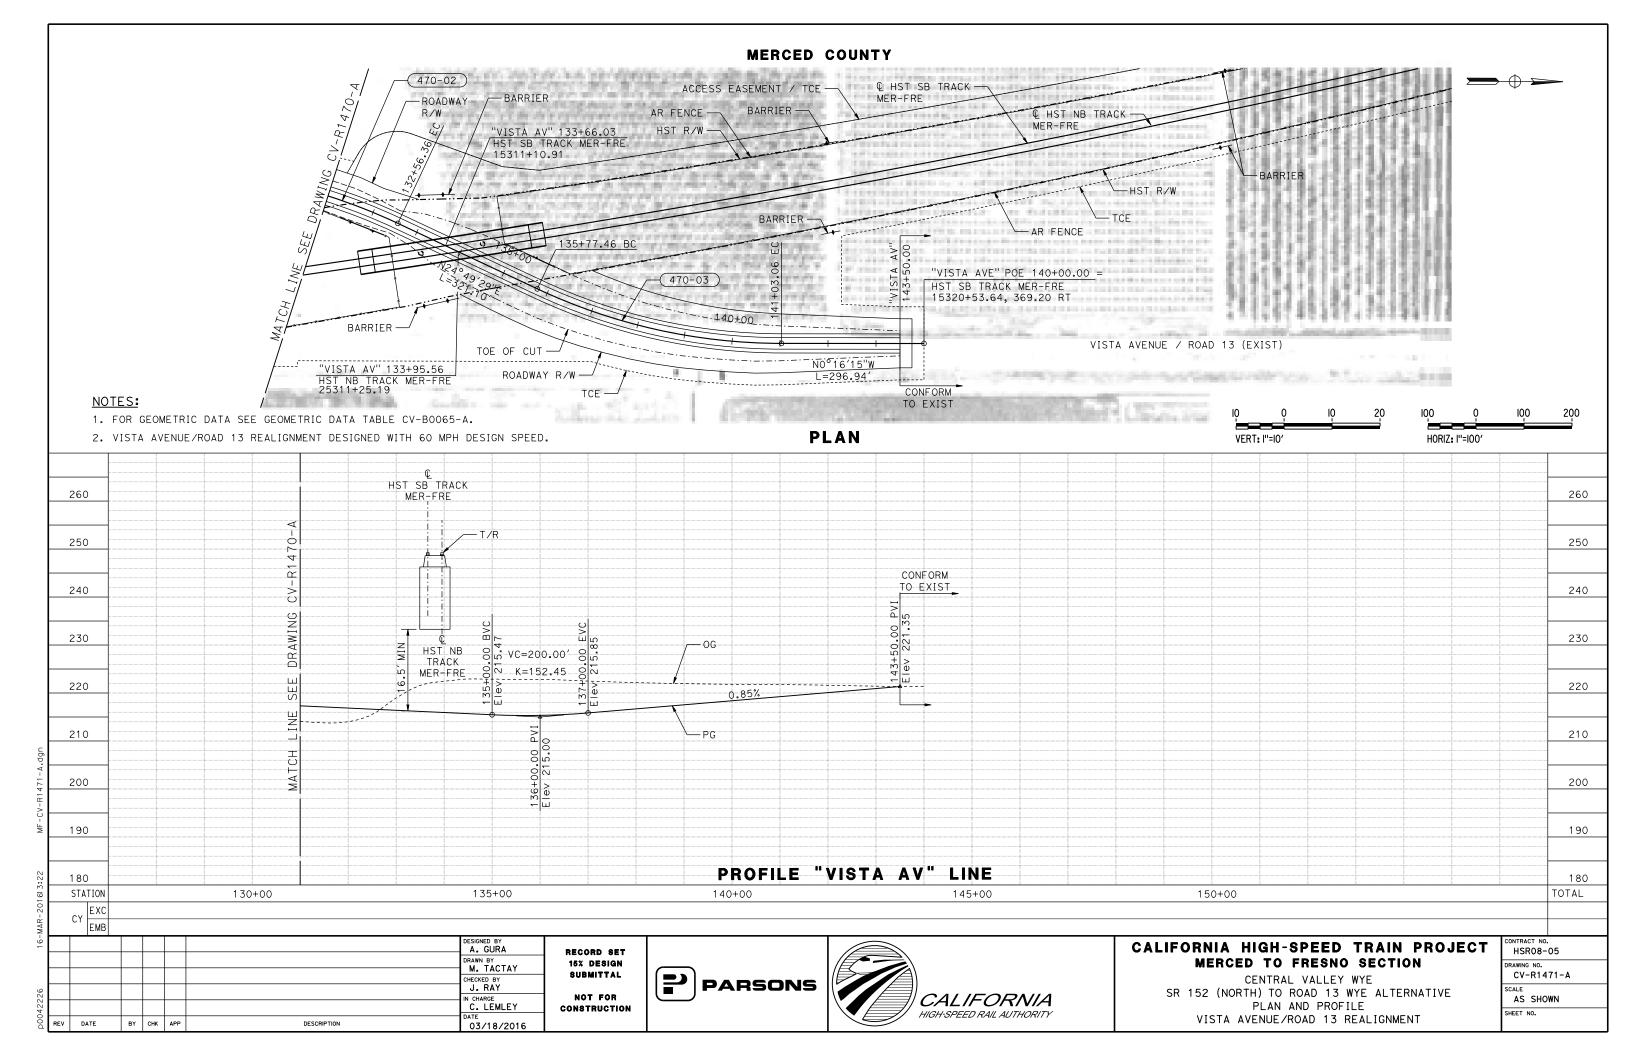


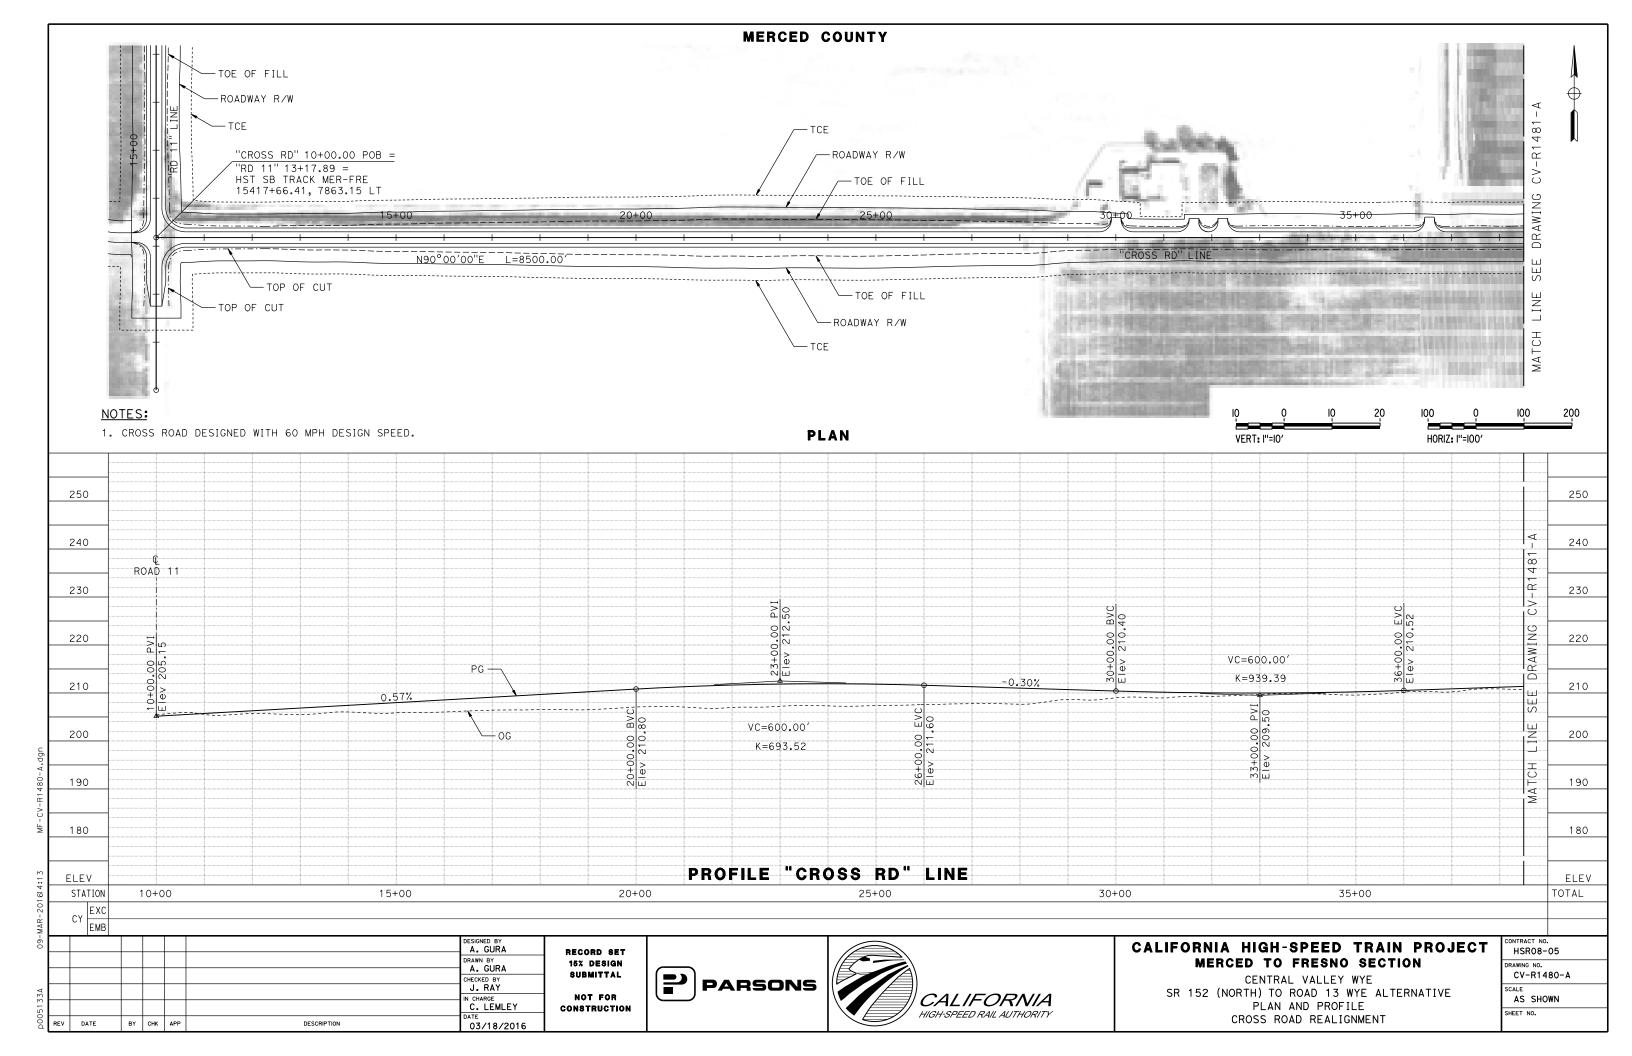


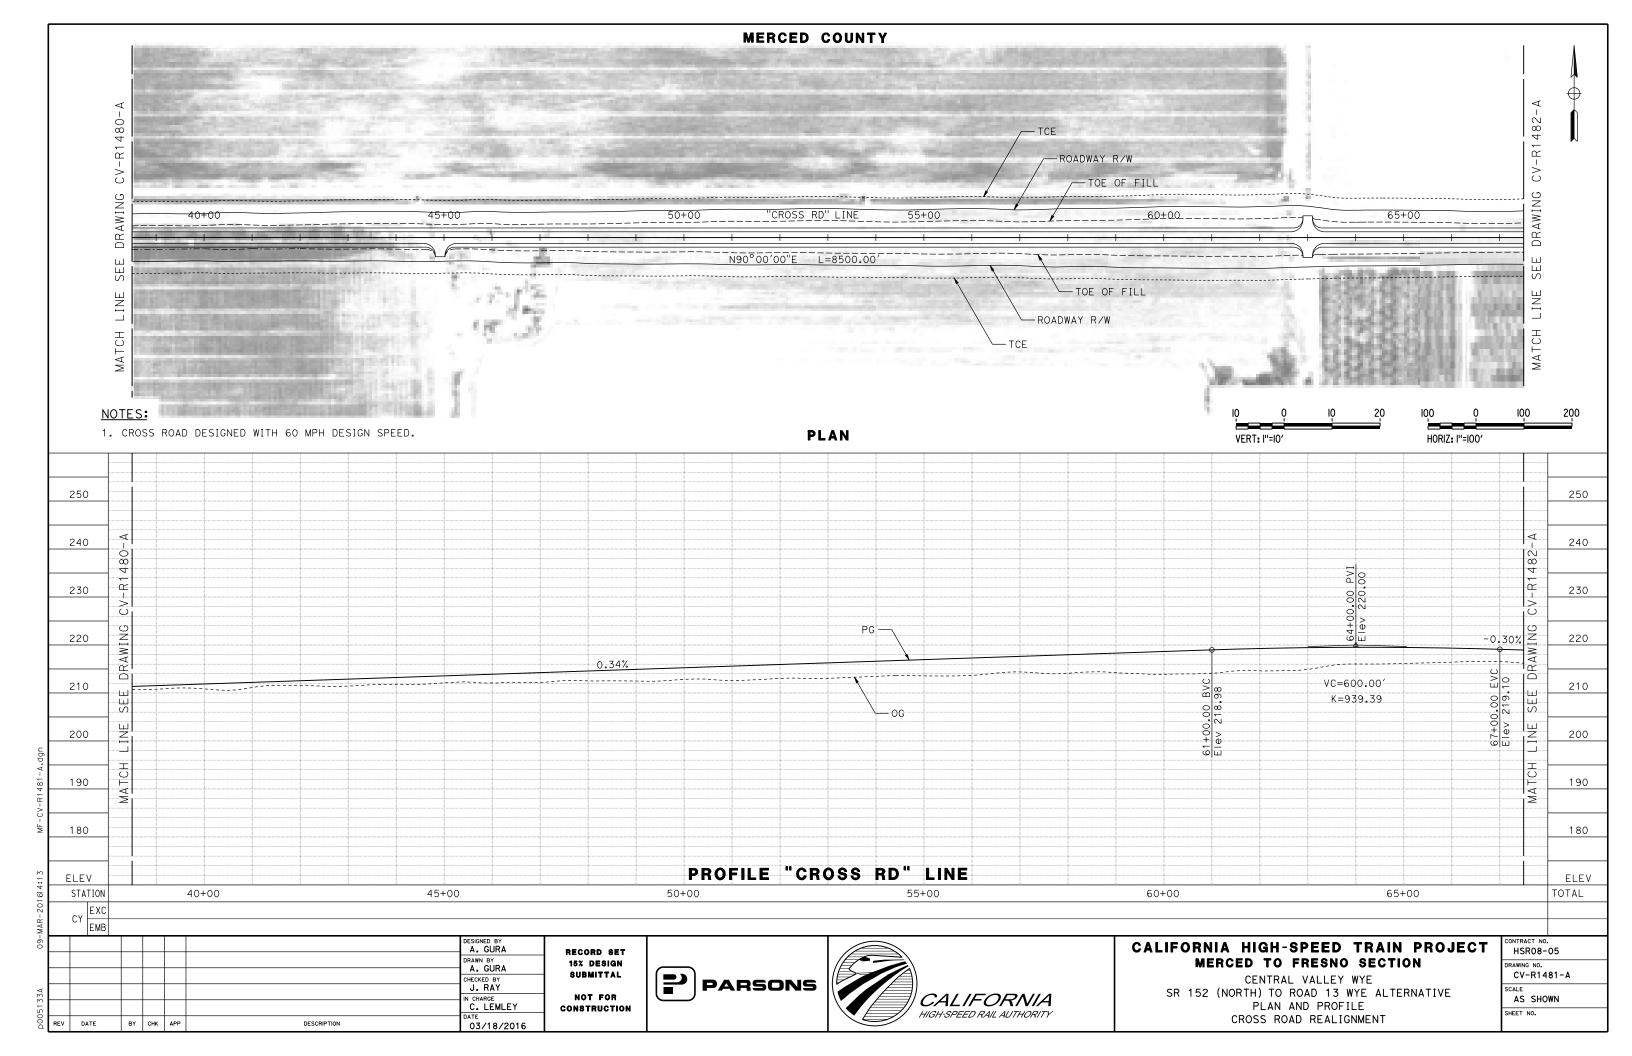


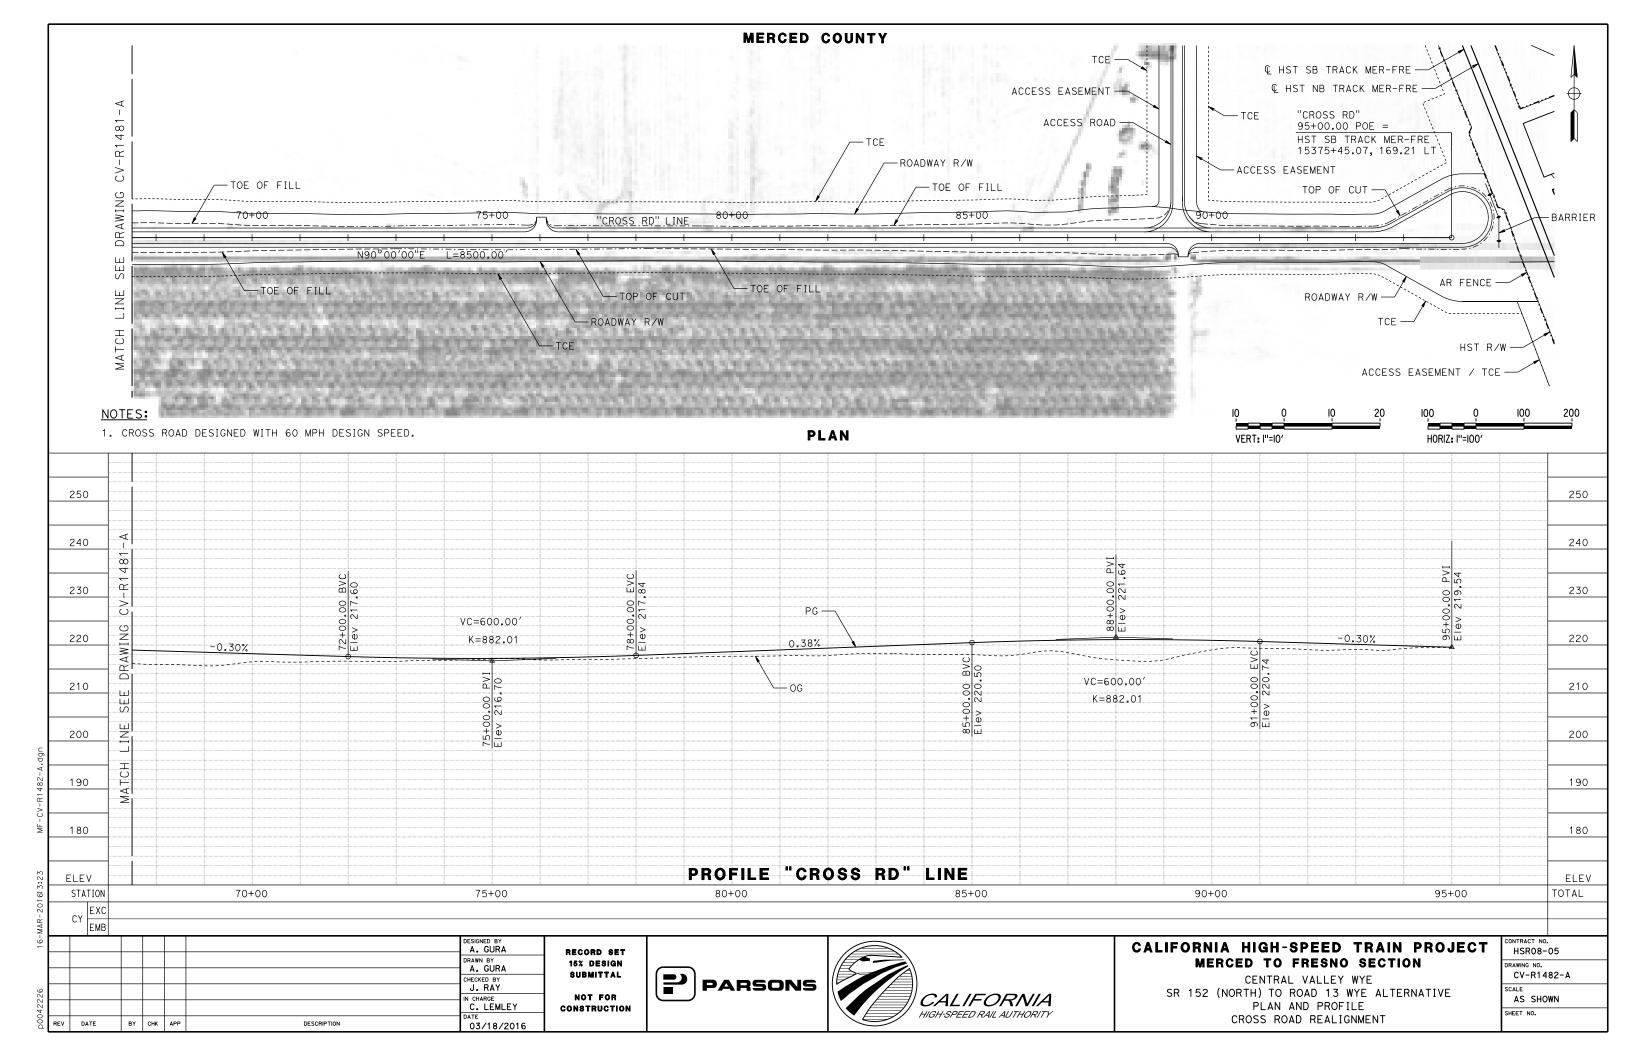


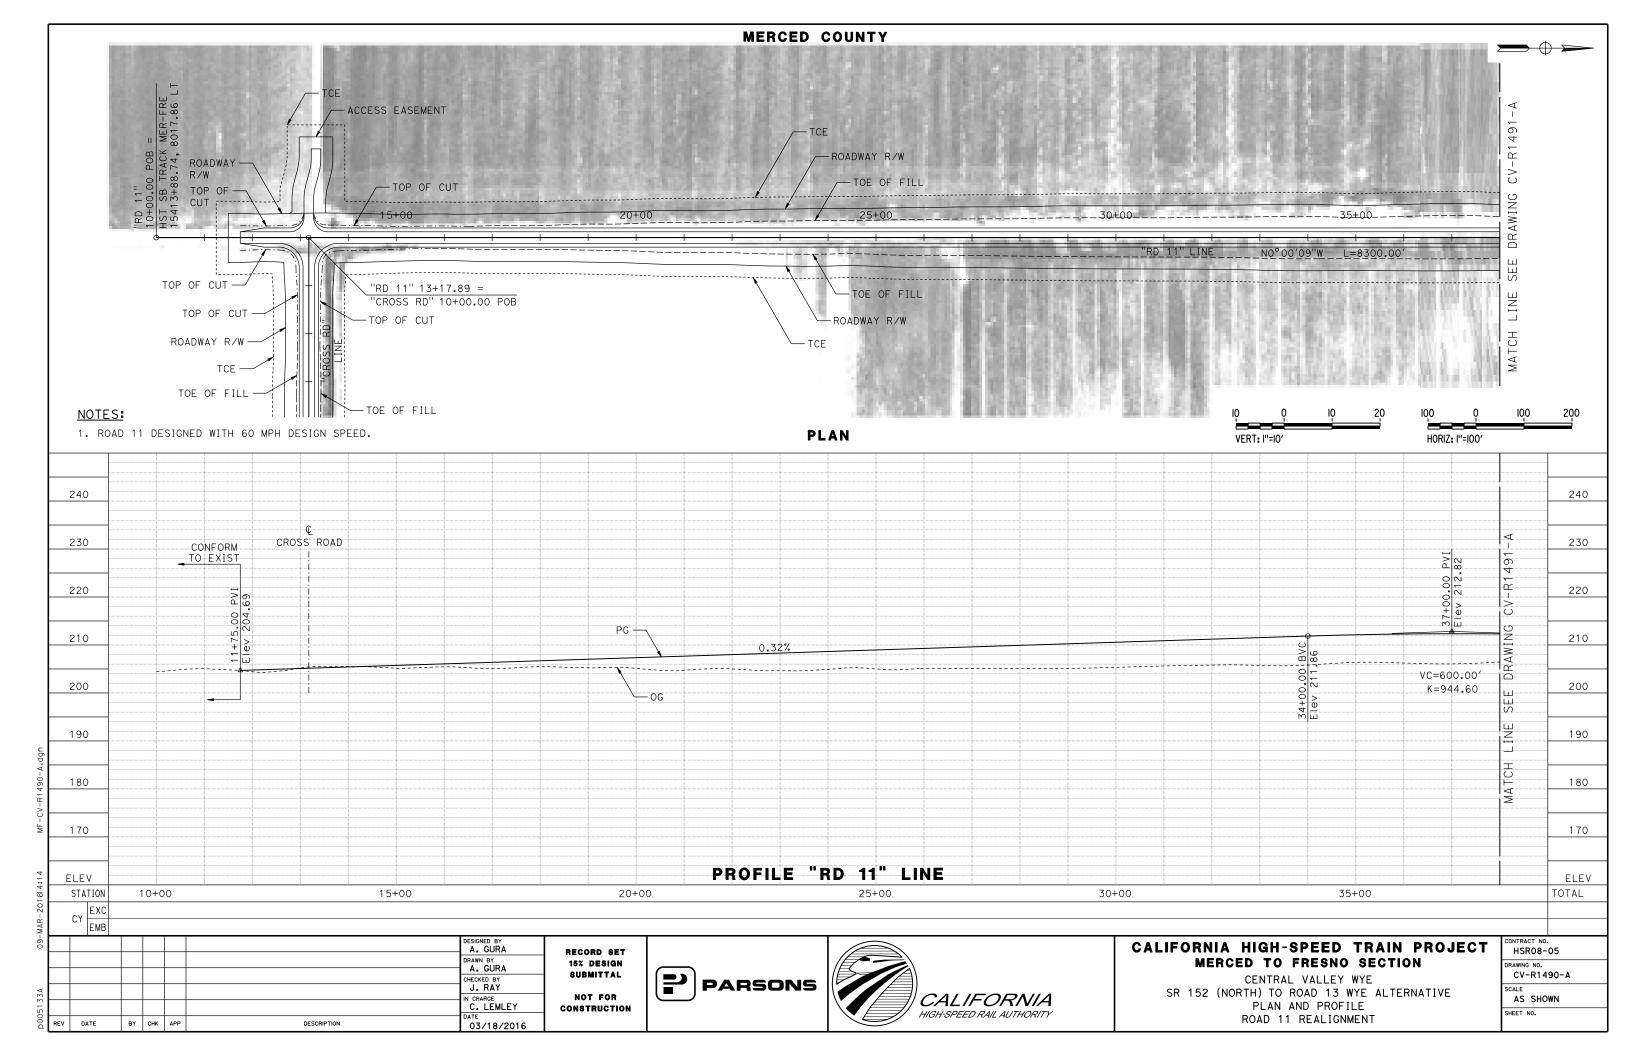


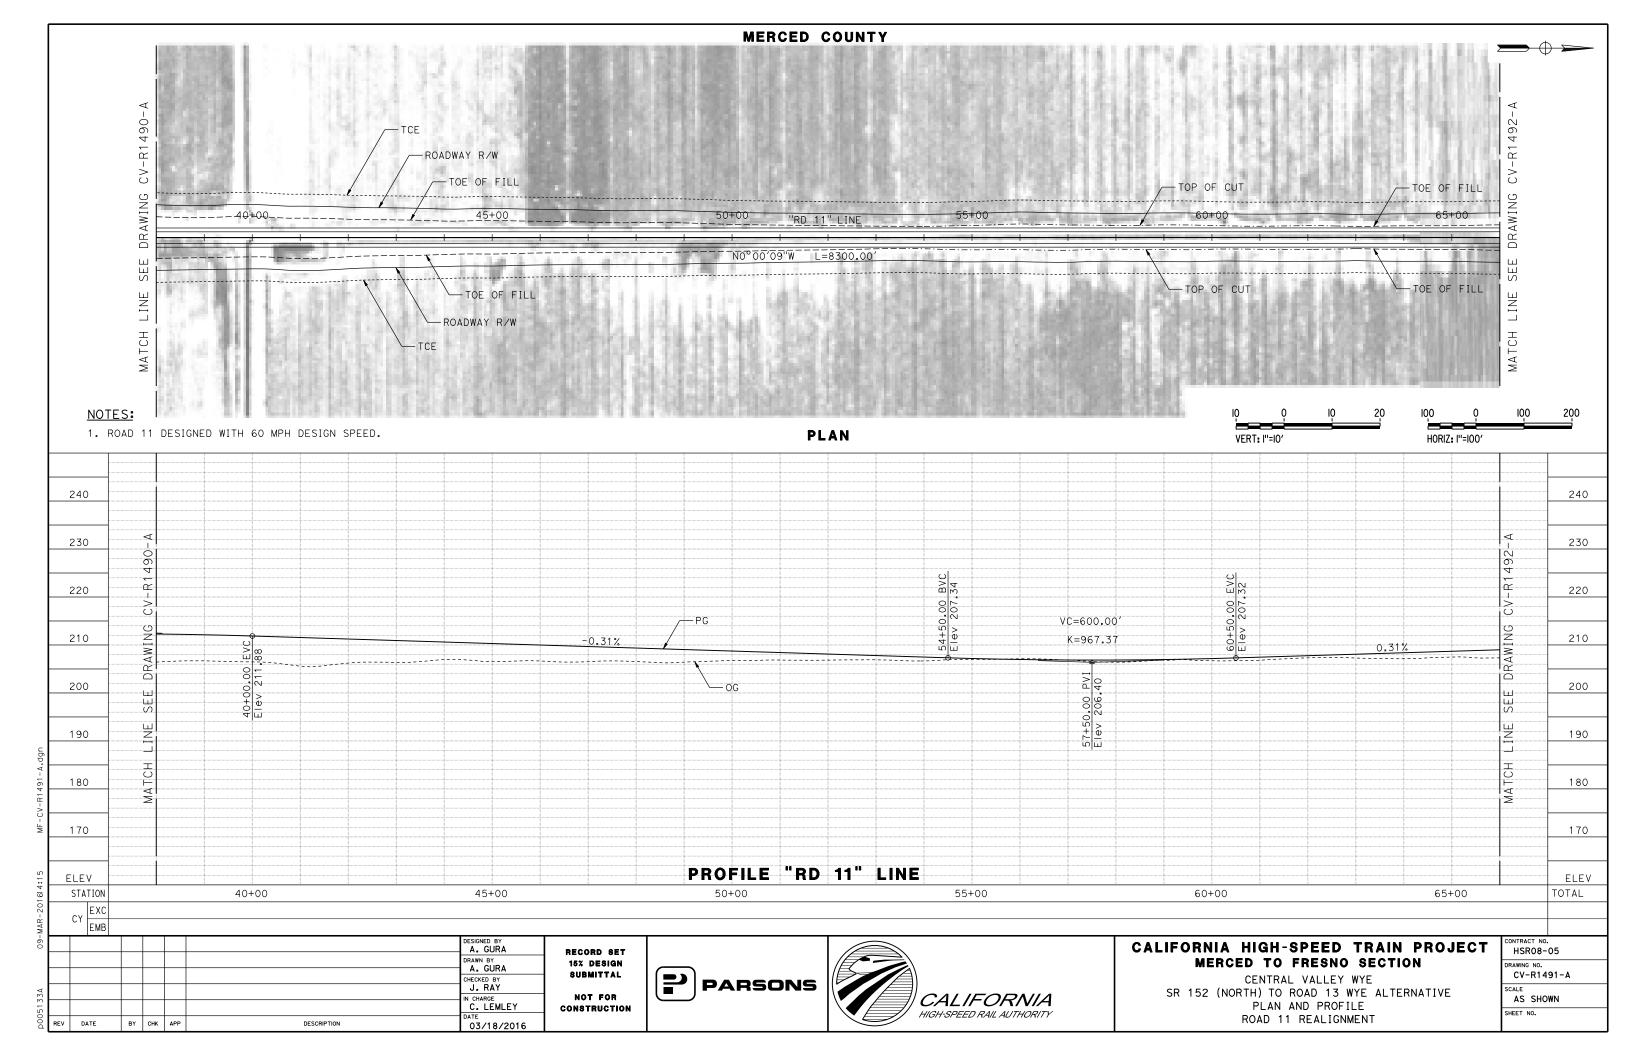


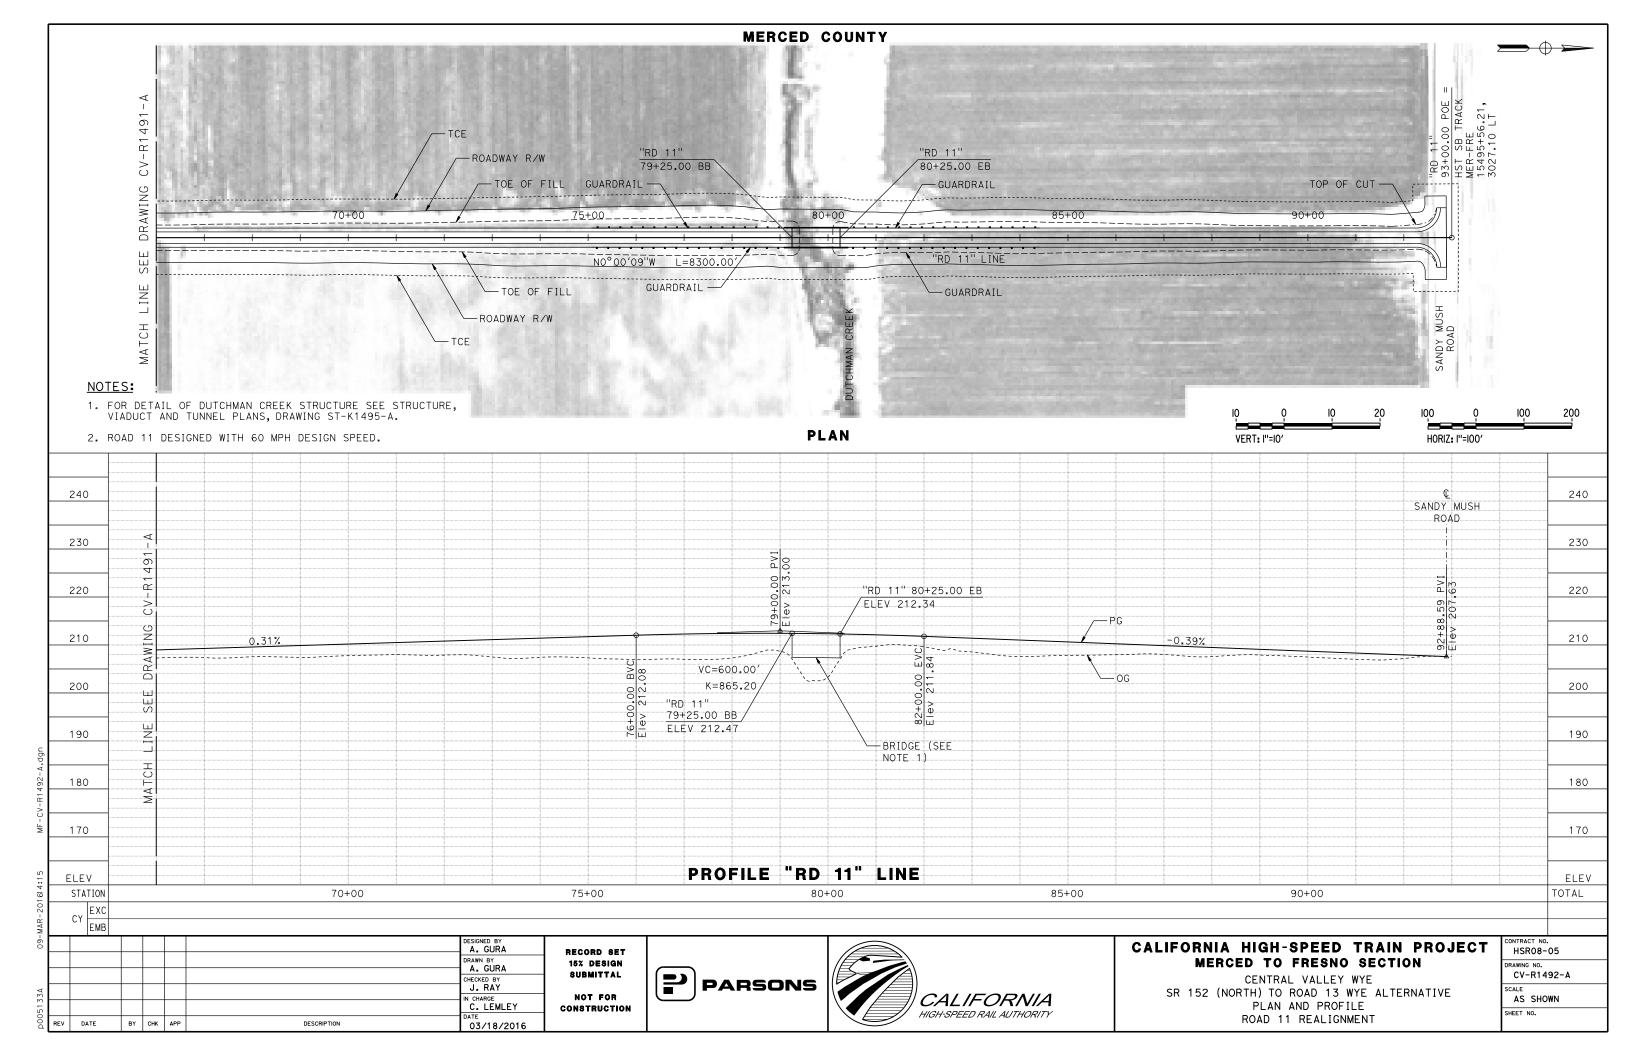

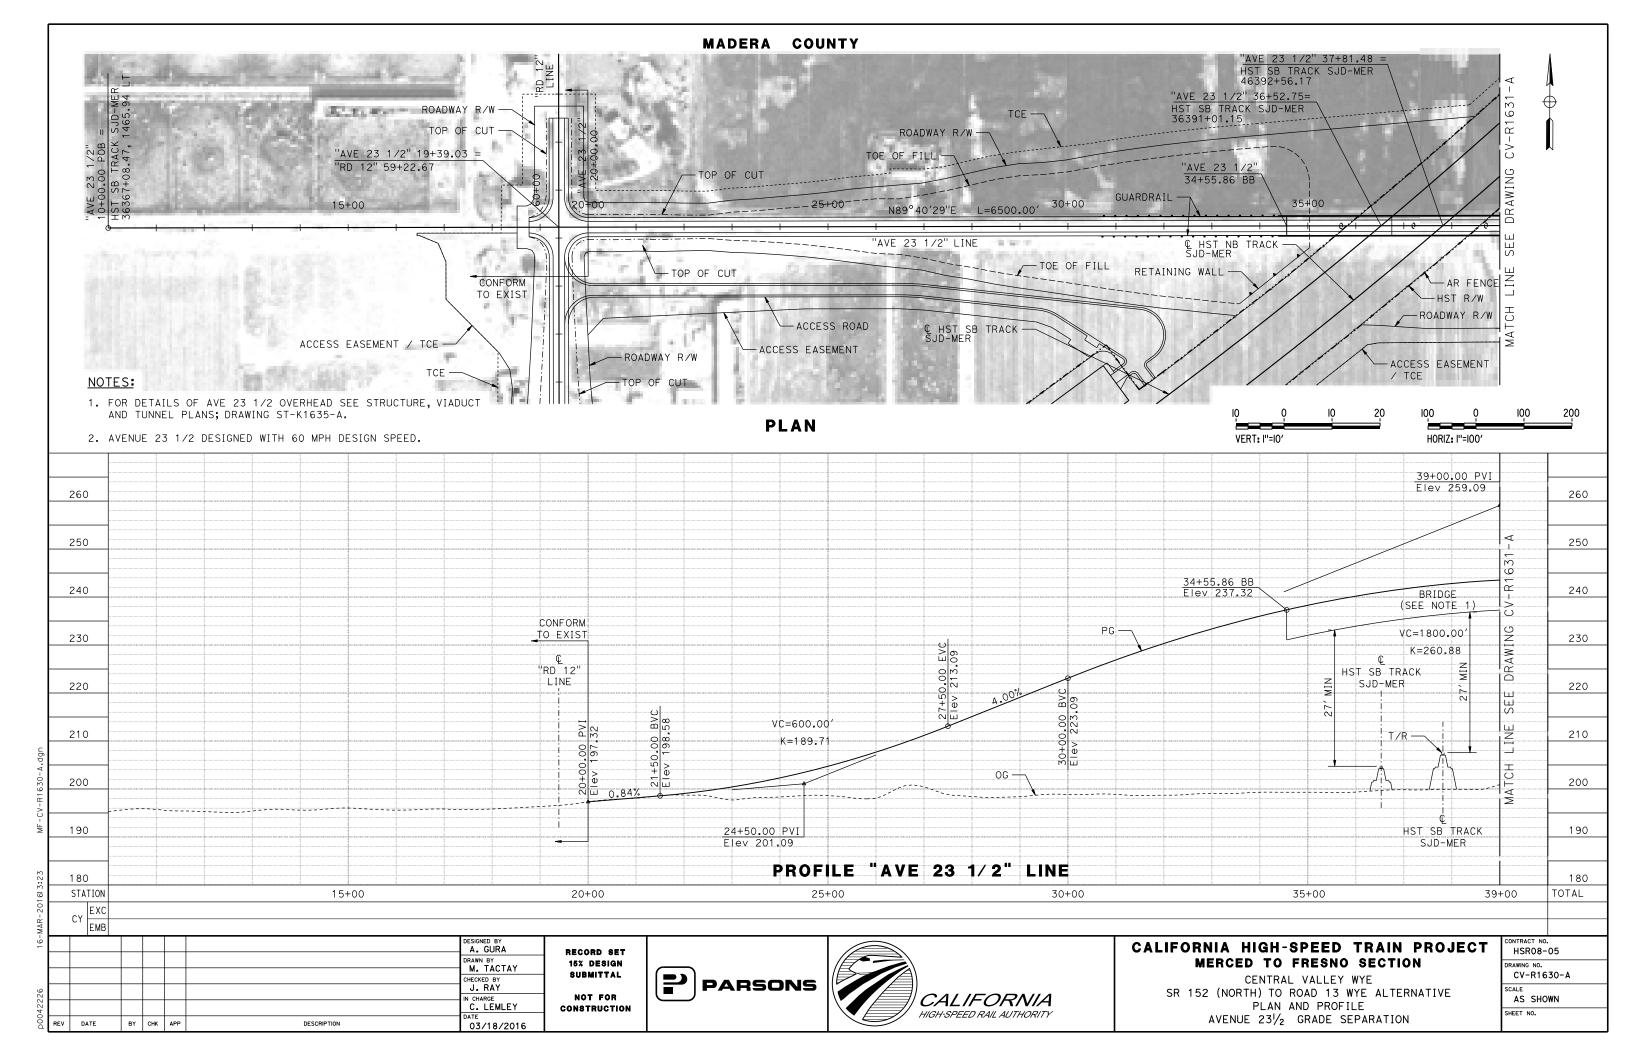

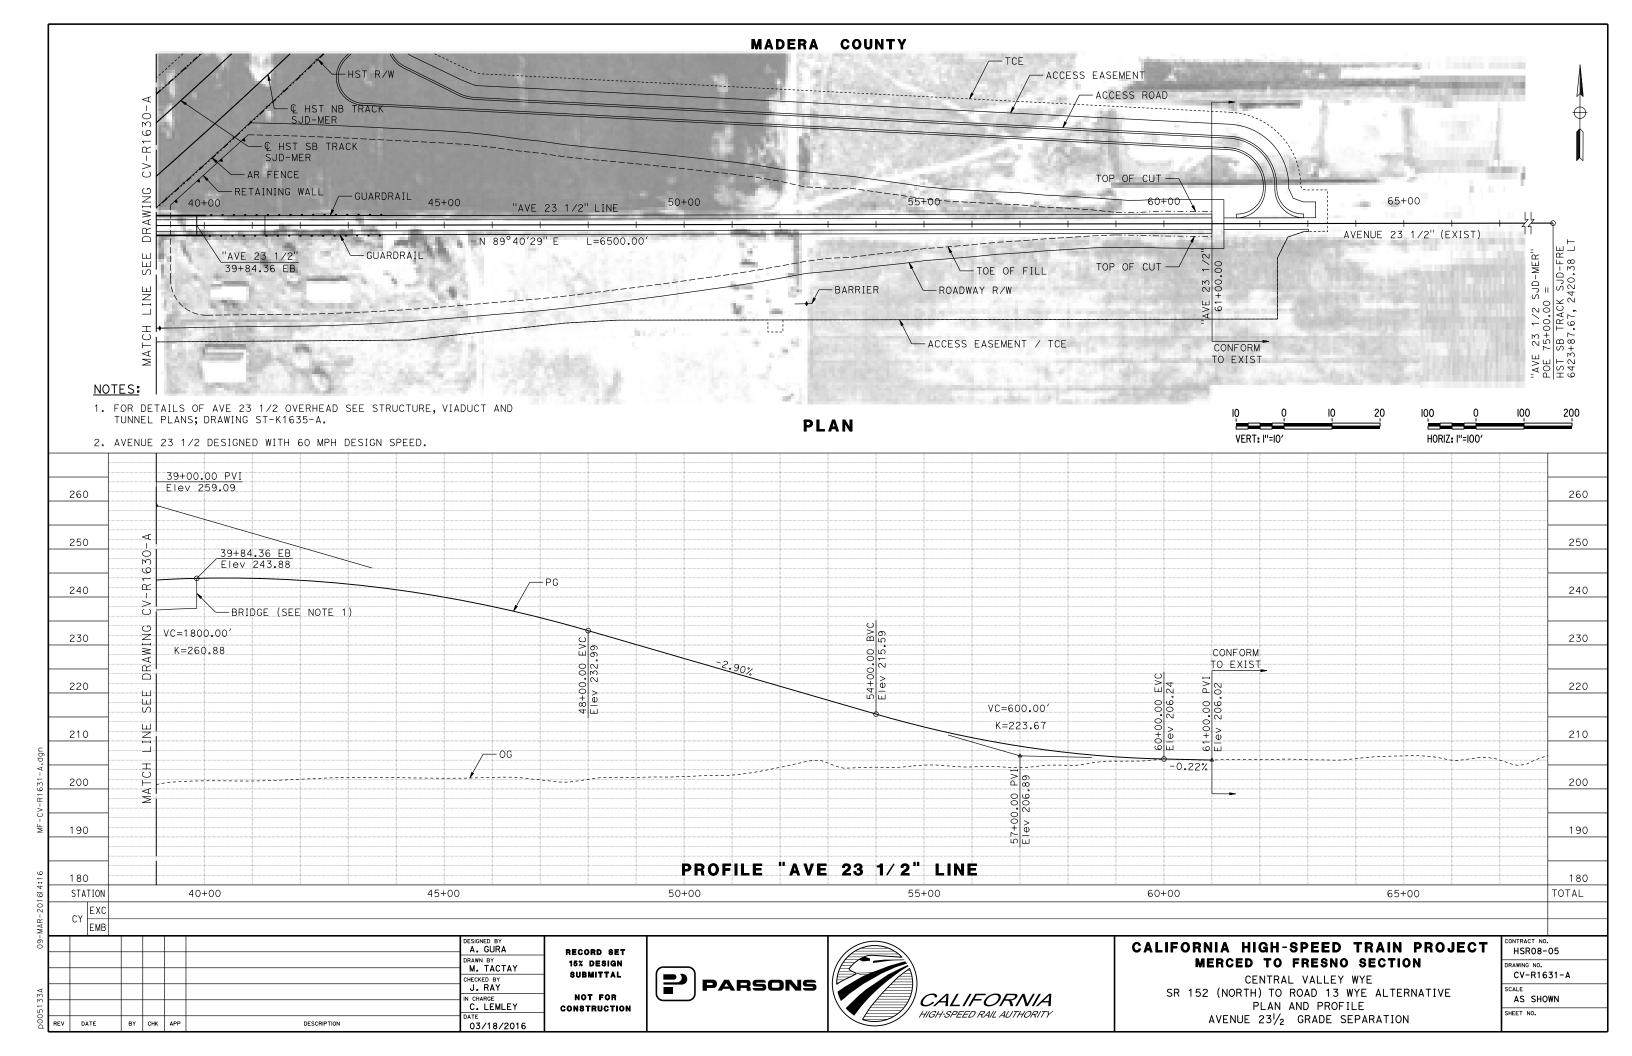

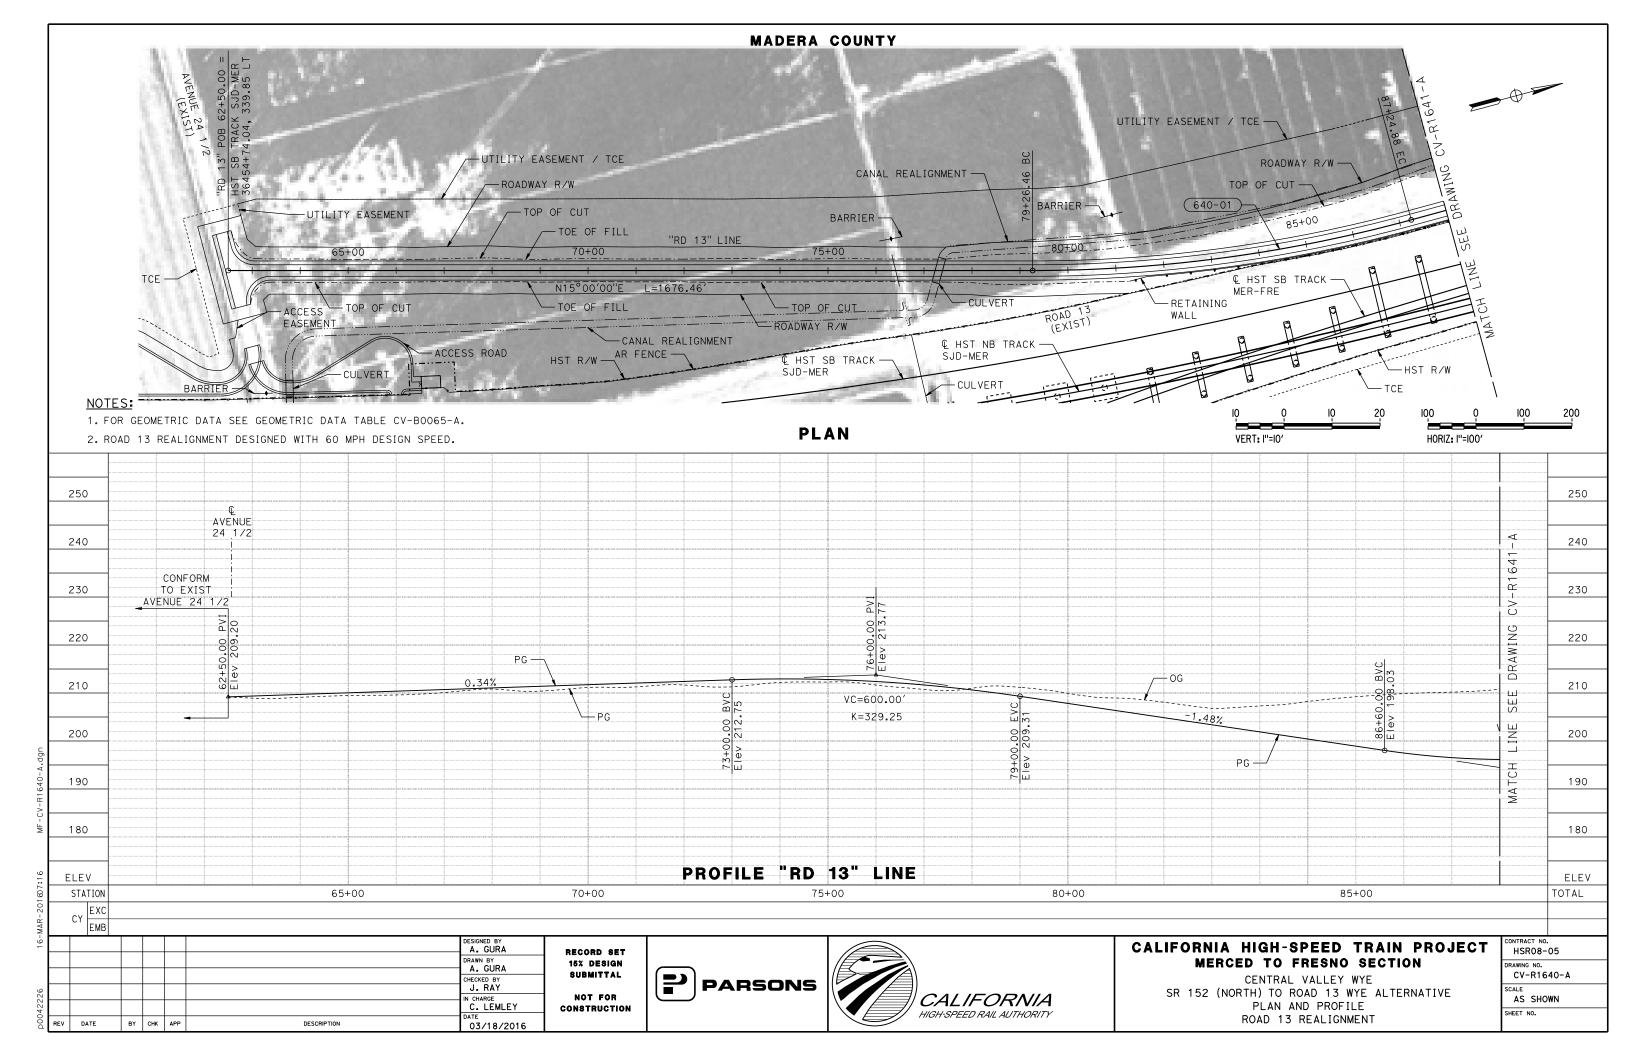

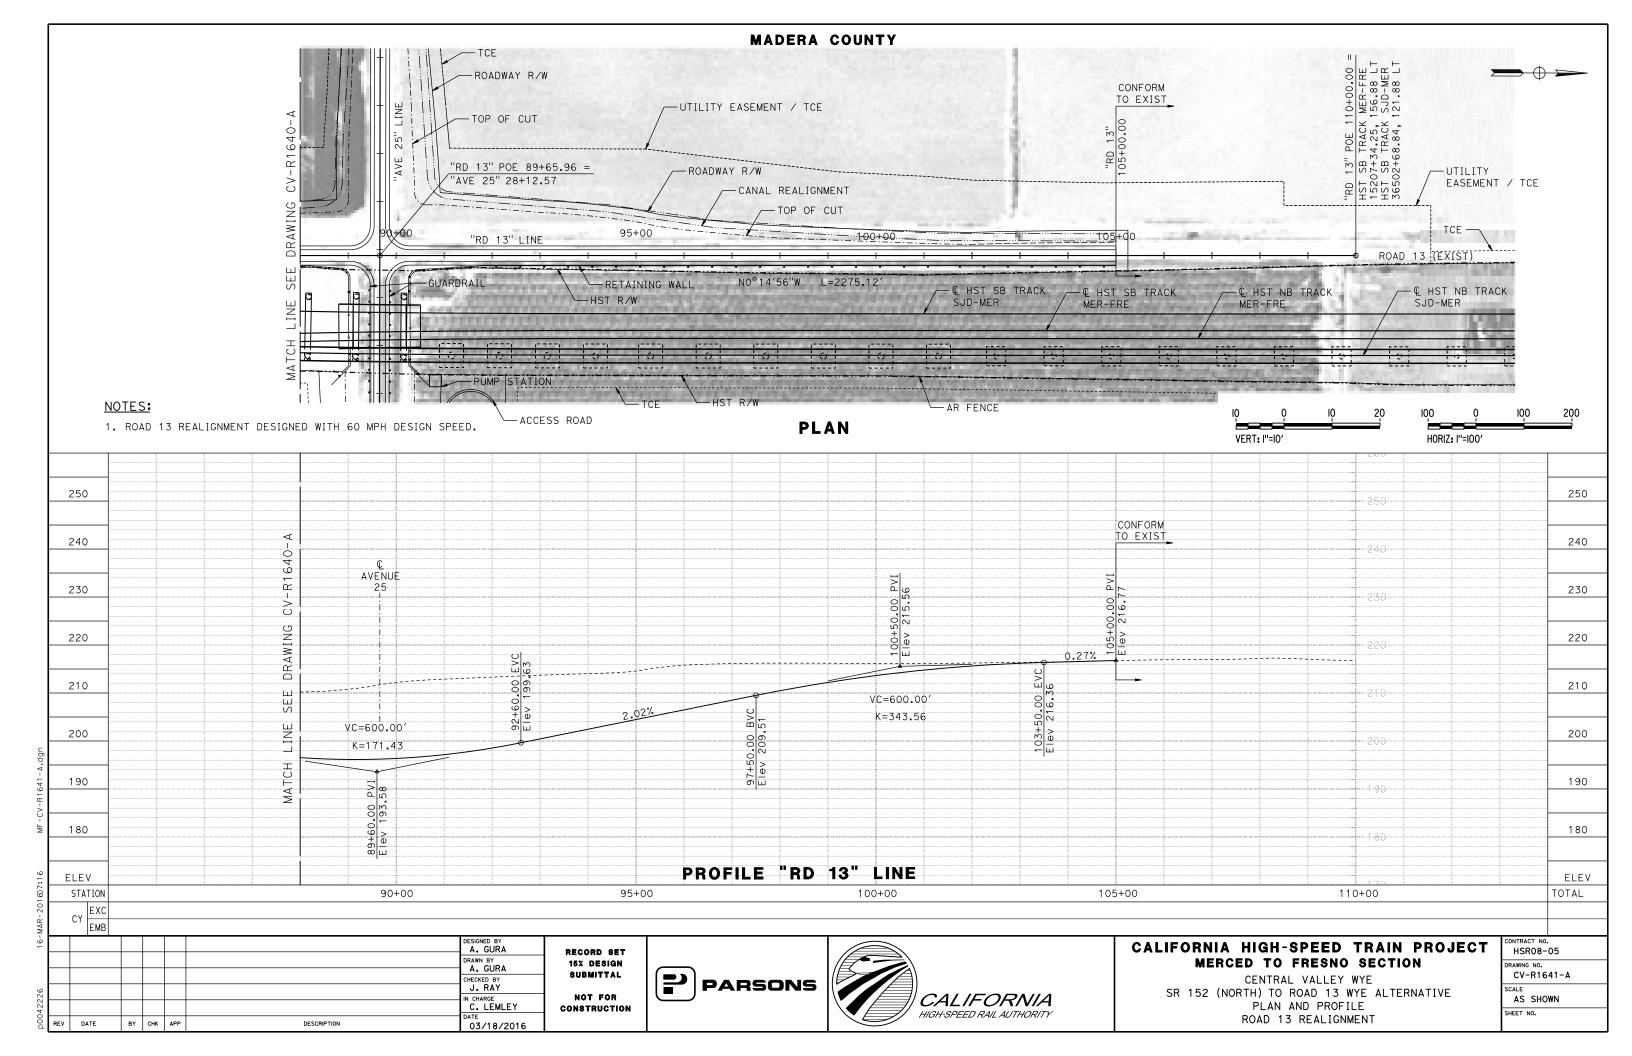

### INDIANA ROAD DETOUR:

- 1. CONSTRUCT TEMPORARY ROAD ON WEST SIDE OF INDIANA ROAD.
- DURING CONSTRUCTION OF INDIANA ROAD GRADE SEPARATION, DIRECT TRAFFIC ONTO TEMPORARY ROADWAY.
- RESTORE TRAFFIC TO INDIANA ROAD UPON COMPLETION OF ROADWAY REALIGNMENT WORK.
- 4. REMOVE TEMPORARY ROADWAY.

# SR 59 DETOUR:

1. FOR STAGE CONSTRUCTION DETAIL OF SR 59 SEE DRAWINGS CV-I4100-A TO CV-I4103-A.

### ROAD 4 / LINCOLN ROAD DETOUR:

- DURING CONSTRUCTION OF ROAD 4 / LINCOLN ROAD GRADE SEPARATION, DETOUR NB TRAFFIC TO EB AVE 21, NB ROAD 6, WB SR 152, NB RD 5 THEN WB AVENUE 23 1/2.
- DETOUR SB TRAFFIC TO EB AVENUE 23 1/2, SB RD 5, EB SR 152, SB ROAD 6, THEN WB AVÉ 21,
- RESTORE TRAFFIC TO ROAD 4 / LINCOLN RD UPON COMPLETION OF GRADE SEPARATION WORK.

# ROAD 9 / HEMLOCK ROAD DETOUR:

1. FOR STAGE CONSTRUCTION DETAIL OF RD 9 / HEMLOCK RD SEE DRAWINGS CV-I4160-A TO CV-I4163-A.

### ROAD 12 DETOUR:

- 1. DURING CONSTRUCTION OF RD 12 GRADE SEPARATION, DETOUR NB TRAFFIC TO EB AVE 22 1/2, NB RD 13, THEN WB AVE 24.
- 2. DETOUR SB TRAFFIC TO EB AVE 24, SB RD 13, THEN WB AVE 22 1/2.
- RESTORE TRAFFIC TO RD 12 UPON COMPLETION OF GRADE SEPARATION WORK.

# SR 152 AT ROAD 12 DETOUR:

- CONSTRUCT PROPOSED EASTBOUND AND WESTBOUND LANES OF SR 152.
- SHIFT EASTBOUND AND WESTBOUND SR 152 TRAFFIC ONTO PROPOSED SR 152 REALIGNMENT.
- 3. DEMOLISH EXISTING SR 152.

# SR 233 / ROBERTSON BOULEVARD DETOUR:

1. FOR STAGE CONSTRUCTION DETAIL OF SR 233 / ROBERTSON BLVD SEE DRAWINGS CV-I4210-A TO CV-I4214-A.

## ROAD 16 DETOUR:

1. FOR STAGE CONSTRUCTION DETAIL OF ROAD 16 SEE DRAWINGS CV-I4230-A TO CV-I4233-A.

# ROAD 17 1/2 DETOUR:

- DURING CONSTRUCTION OF ROAD 17 1/2 GRADE SEPARATION, DETOUR SB TRAFFIC TO WB AVENUE 23 1/2, SB ROAD 17, EB SR 152, SB SR 99, SB AVENUE 21 1/2, THEN NB RD 19.
- DETOUR NB TRAFFIC TO SB RD 19, NB AVE 21 1/2, NB SR 99, WB SR 152, NB RD 17, THEN EB AVE 23 1/2.
- 3. RESTORE TRAFFIC TO RD 17 1/2 UPON COMPLETION OF GRADE SEPARATION.

#### ROAD 20 DETOUR:

- 1. DURING CONSTRUCTION OF RD 20 GRADE SEPARATION. DETOUR NB TRAFFIC TO WB AVE 22 1/2, THEN NB RD 19 1/2, THEN TO EB AVE 23
- DETOUR SB TRAFFIC TO WB AVE 23 1/2, THEN SB RD 19 1/2, THEN EB AVE 22 1/2.
- RESTORE TRAFFIC TO RD 20 UPON COMPLETION OF GRADE SEPARATION WORK.

# ROAD 22 DETOUR:

- DURING CONSTRUCTION OF RD 22 GRADE SEPARATION, DETOUR NB TRAFFIC TO NB FAIRMEAD BLVD, EB AVE 22, NB RD 20, THEN EB AVE 24.
- 2. DETOUR SB TRAFFIC TO WB AVE 24, SB RD 20, WB AVE 22, THEN SB FAIRMEAD BLVD.
- 3. BUILD TEMPORARY ROADWAY ON SOUTH SIDE OF AVE 22, CONNECTING AVE 22 TRAFFIC TO ROAD 22.
- RESTORE TRAFFIC TO RD 22 AND AVE 22 UPON COMPLETION OF GRADE SEPARATION WORK.

# ROAD 24 AND AVENUE 20 1/2 DETOUR:

- CONSTRUCT TEMPORARY ROADS ON WEST SIDE OF ROAD 24 AND SOUTH SIDE OF AVENUE 20 1/2
- DURING CONSTRUCTION OF ROAD 24 AND AVENUE 20 1/2 REALIGNMENT, DIRECT TRAFFIC ONTO TEMPORARY ROADWAYS.
- RESTORE TRAFFIC TO ROAD 24 AND AVENUE 20 1/2 UPON COMPLETION OF ROADWAY REALIGNMENT WORK.
- 4. REMOVE TEMPORARY ROADWAYS.

### AVENUE 23 1/2 DETOUR:

- 1. DURING CONSTRUCTION OF AVE 23 1/2 GRADE SEPARATION, DETOUR EB TRAFFIC TO SB RD 11, EB SR 152, THÉN NB ROBERTSON BLVD.
- 2. DETOUR WB TRAFFIC TO SB ROBERTSON BLVD, WB SR 152, THEN NB RD 11.
- 3. RESTORE TRAFFIC TO AVE 23 1/2 UPON COMPLETION OF GRADE SEPARATION WORK.

#### ROAD 13 DETOUR

- 1. NO CONCURRENT CONSTRUCTION OF ROAD 13 AND AVENUE 25 IS ALLOWED.
- DURING CONSTRUCTION OF RD 13 GRADE SEPARATION, DETOUR NB TRAFFIC TO EB AVENUE 23 1/2, NB RD 14, THEN WB AVE 25 1/2.
- DETOUR SB TRAFFIC TO EB AVENUE 25 1/2, SB ROAD 14, THEN WB AVENUE 23 1/2.
- 4. RESTORE TRAFFIC TO ROAD 13 UPON COMPLETION OF GRADE SEPARATION WORK.

#### AVENUE 25 DETOUR:

- 1. DURING CONSTRUCTION OF AVE 25 GRADE SEPARATION. DETOUR EB TRAFFIC TO NB RD 12, EB AVE 26, SB RD 13, THEN EB AVE 25 1/2.
- DETOUR WB TRAFFIC TO NB ROAD 14, WB AVENUE 25 1/2, NB RD 13, WB AVENUE 26, THEN SB ROAD 12.
- 3. RESTORE TRAFFIC TO AVENUE 25 UPON COMPLETION OF GRADE SEPARATION WORK.

# CUT-AND-COVER TUNNEL AT SANDY MUSH STAGING:

MAINTAIN ONE LANE IN EACH DIRECTION AT ALL TIMES DURING CONSTRUCTION OF CUT-AND-COVER

A. GURA A. GURA J. RAY N CHARGE C. LEMLEY DATE BY CHK APP DESCRIPTION 10/30/2015

RECORD SET 15% DESIGN SUBMITTAL NOT FOR

CONSTRUCTION






# CALIFORNIA HIGH-SPEED TRAIN PROJECT MERCED TO FRESNO SECTION

CENTRAL VALLEY WYE SR 152 NORTH TO ROAD 13 WYE STAGE CONSTRUCTION PLAN GENERAL NOTES

RAWING NO. CV-I0001-A

NO SCALE SHEET NO.

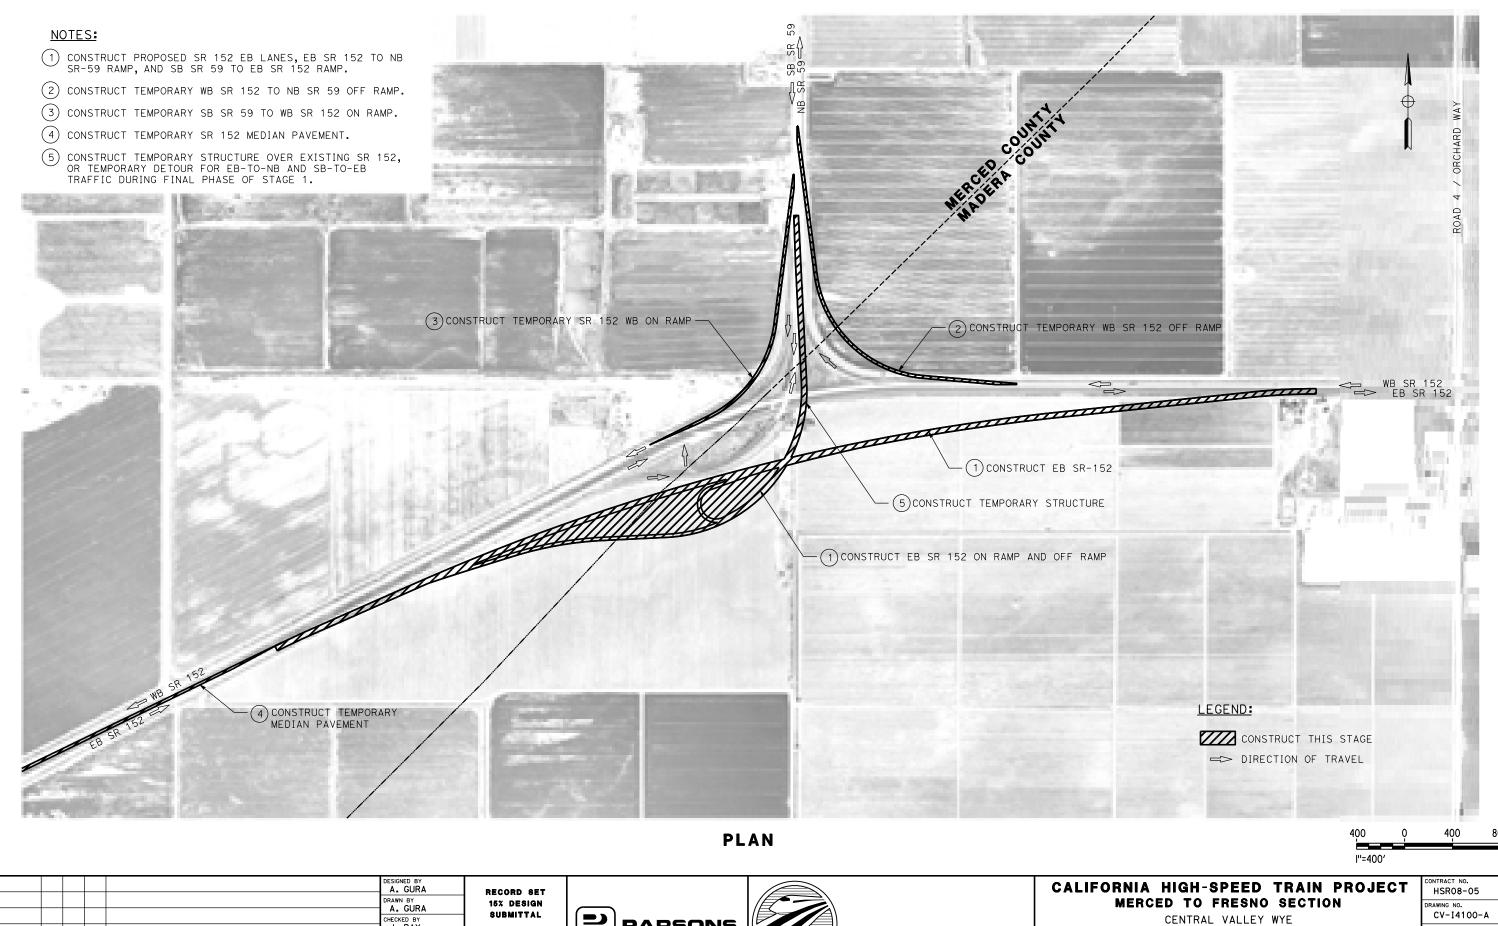

CHECKED BY IN CHARGE
C. LEMLEY DESCRIPTION 10/30/2015

NOT FOR CONSTRUCTION








SR 152 (NORTH) TO ROAD 13 WYE ALTERNATIVE STAGE CONSTRUCTION PLAN SR 59/SR 152 STAGE 1 OF 4

HSR08-05	
DRAWING NO. CV-I4100-A	
SCALE AS SHOWN	

SHEET NO.

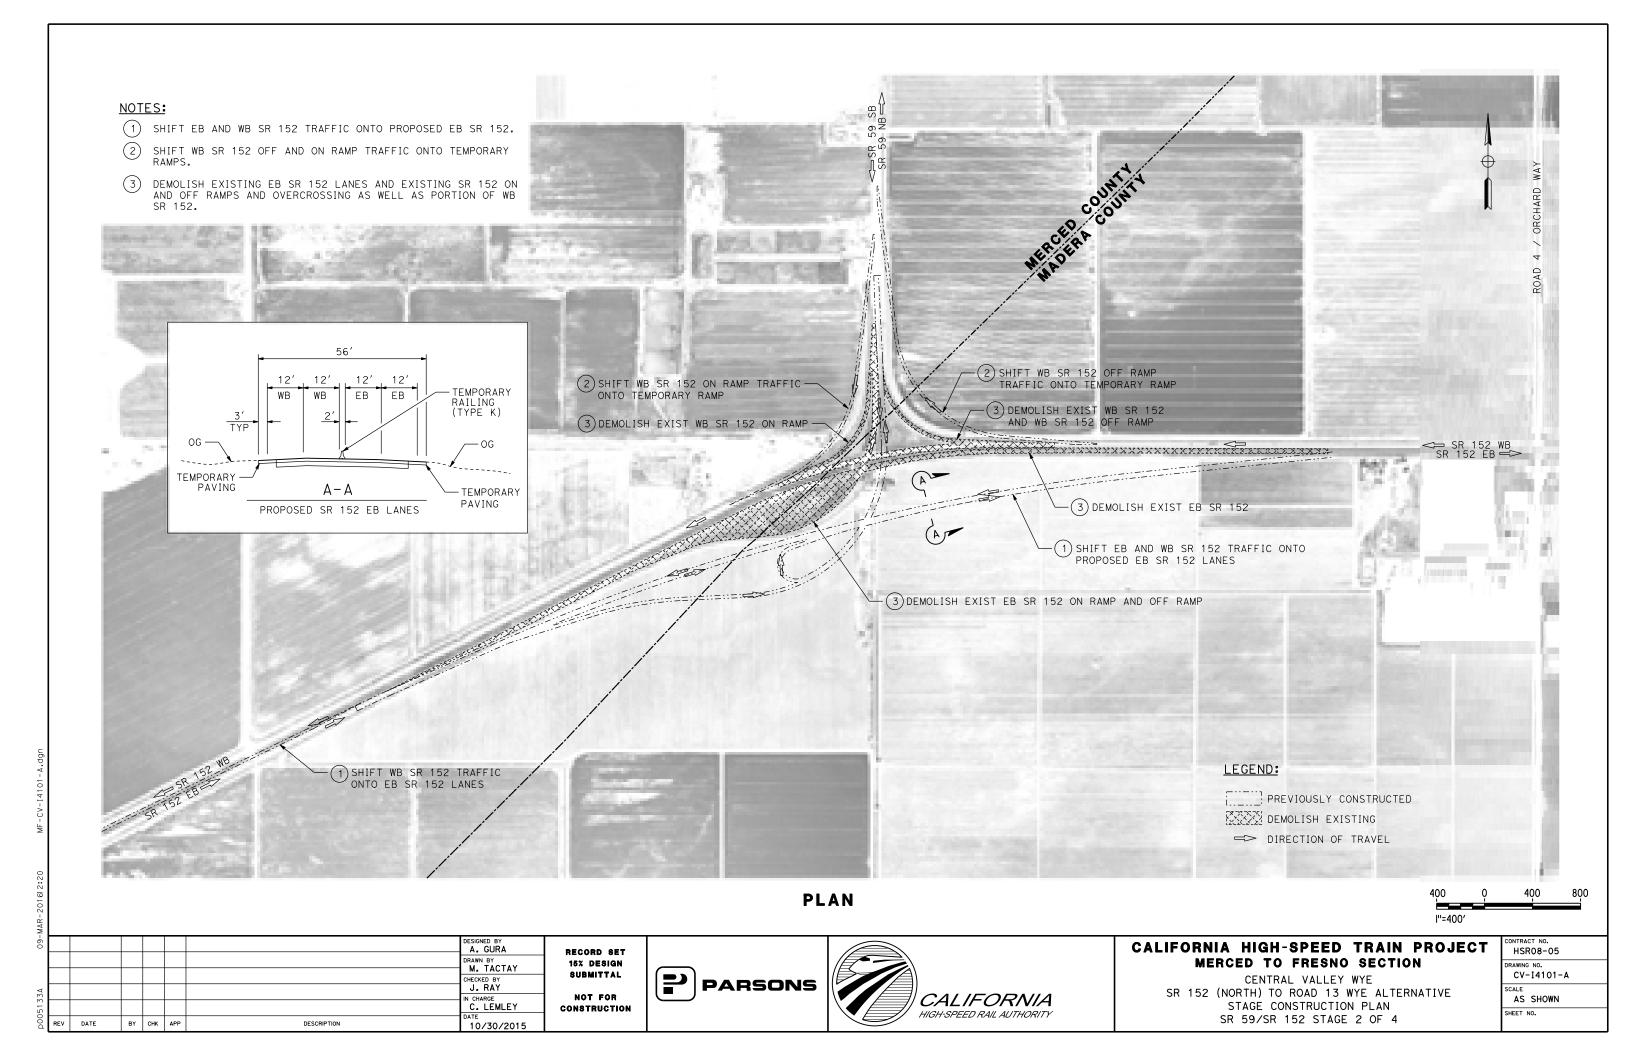

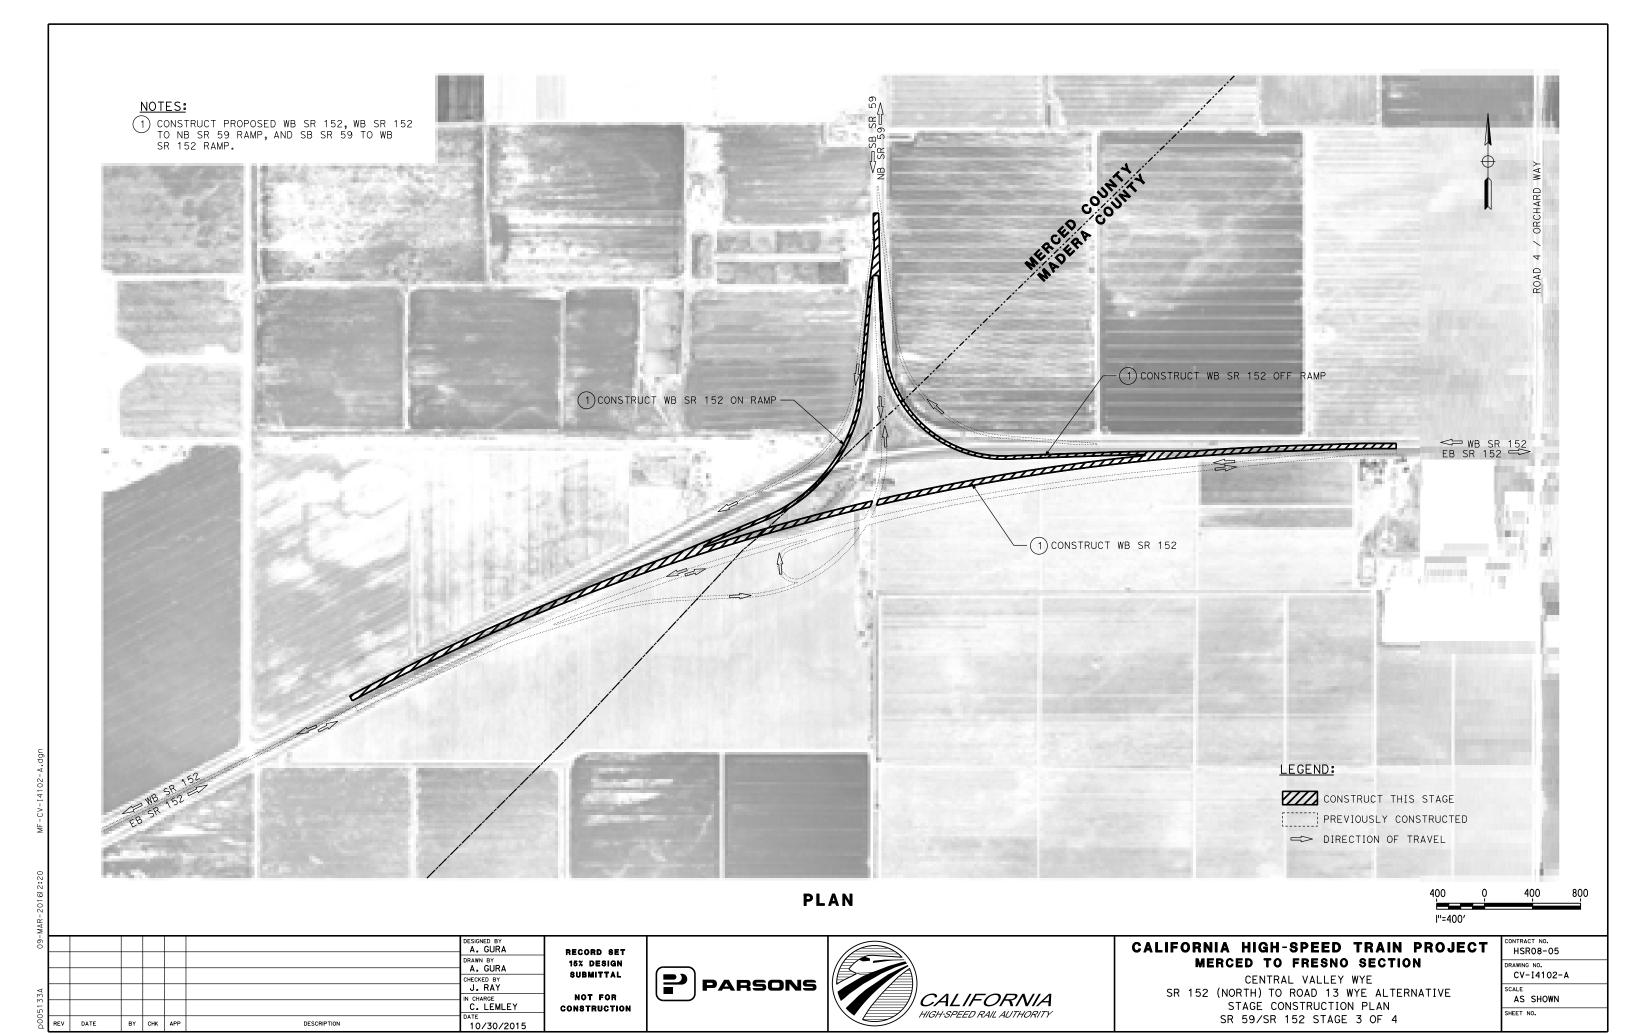

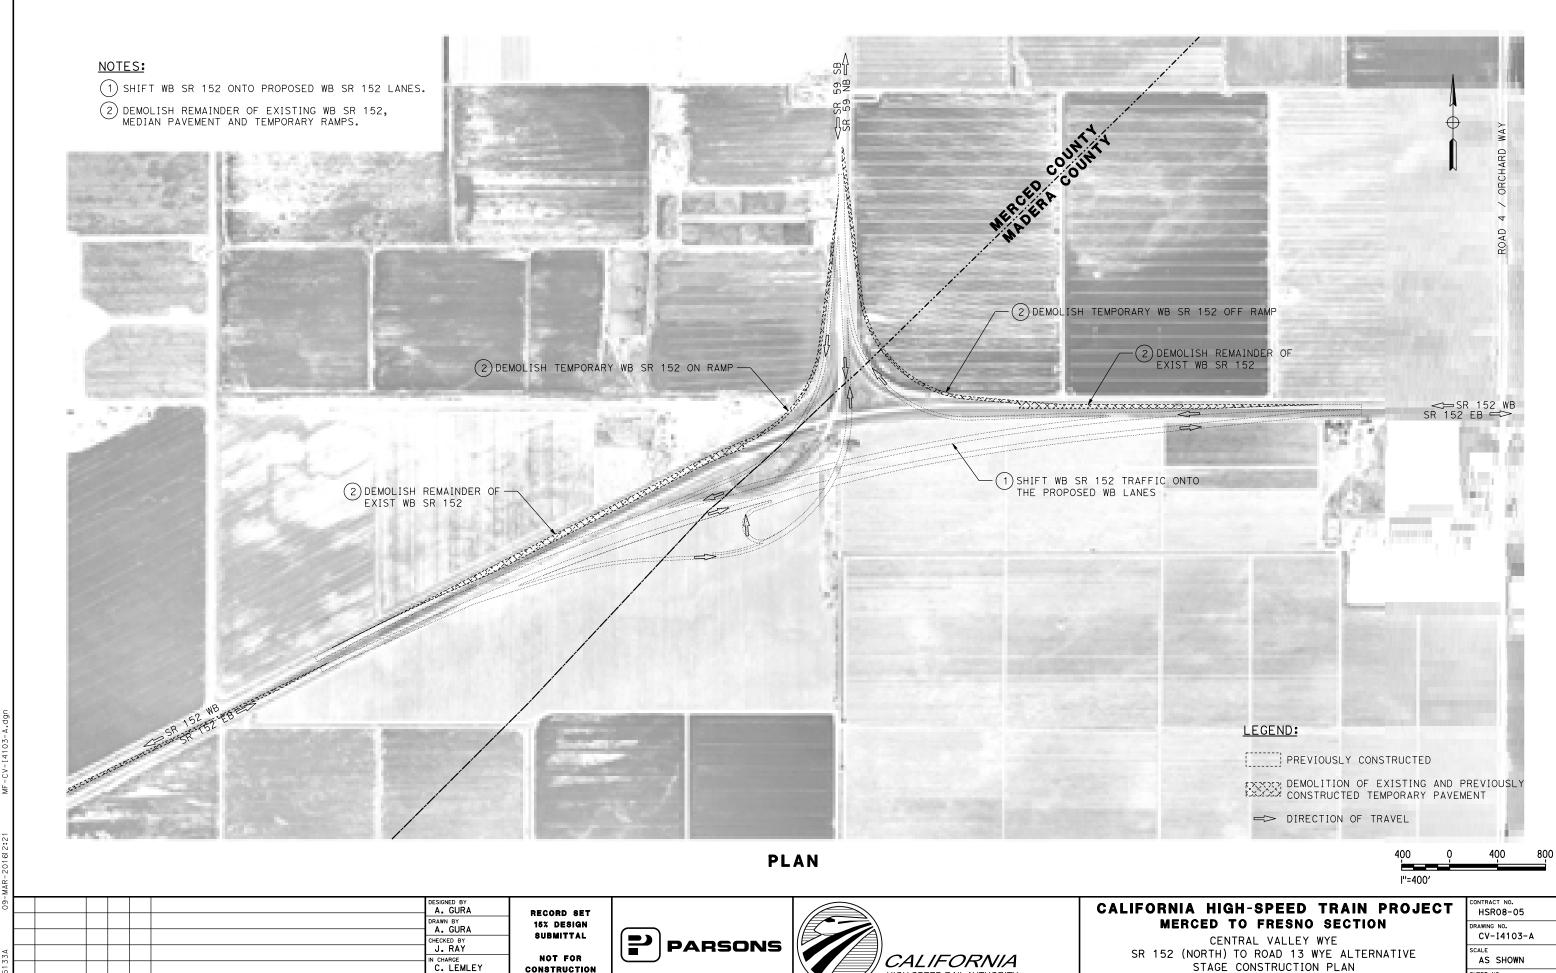


DESCRIPTION

CONSTRUCTION 10/30/2015



STAGE CONSTRUCTION PLAN SR 59/SR 152 STAGE 4 OF 4

HSR08-05
DRAWING NO.
CV-I4103-A
SCALE
AS SHOWN
SHEET NO.

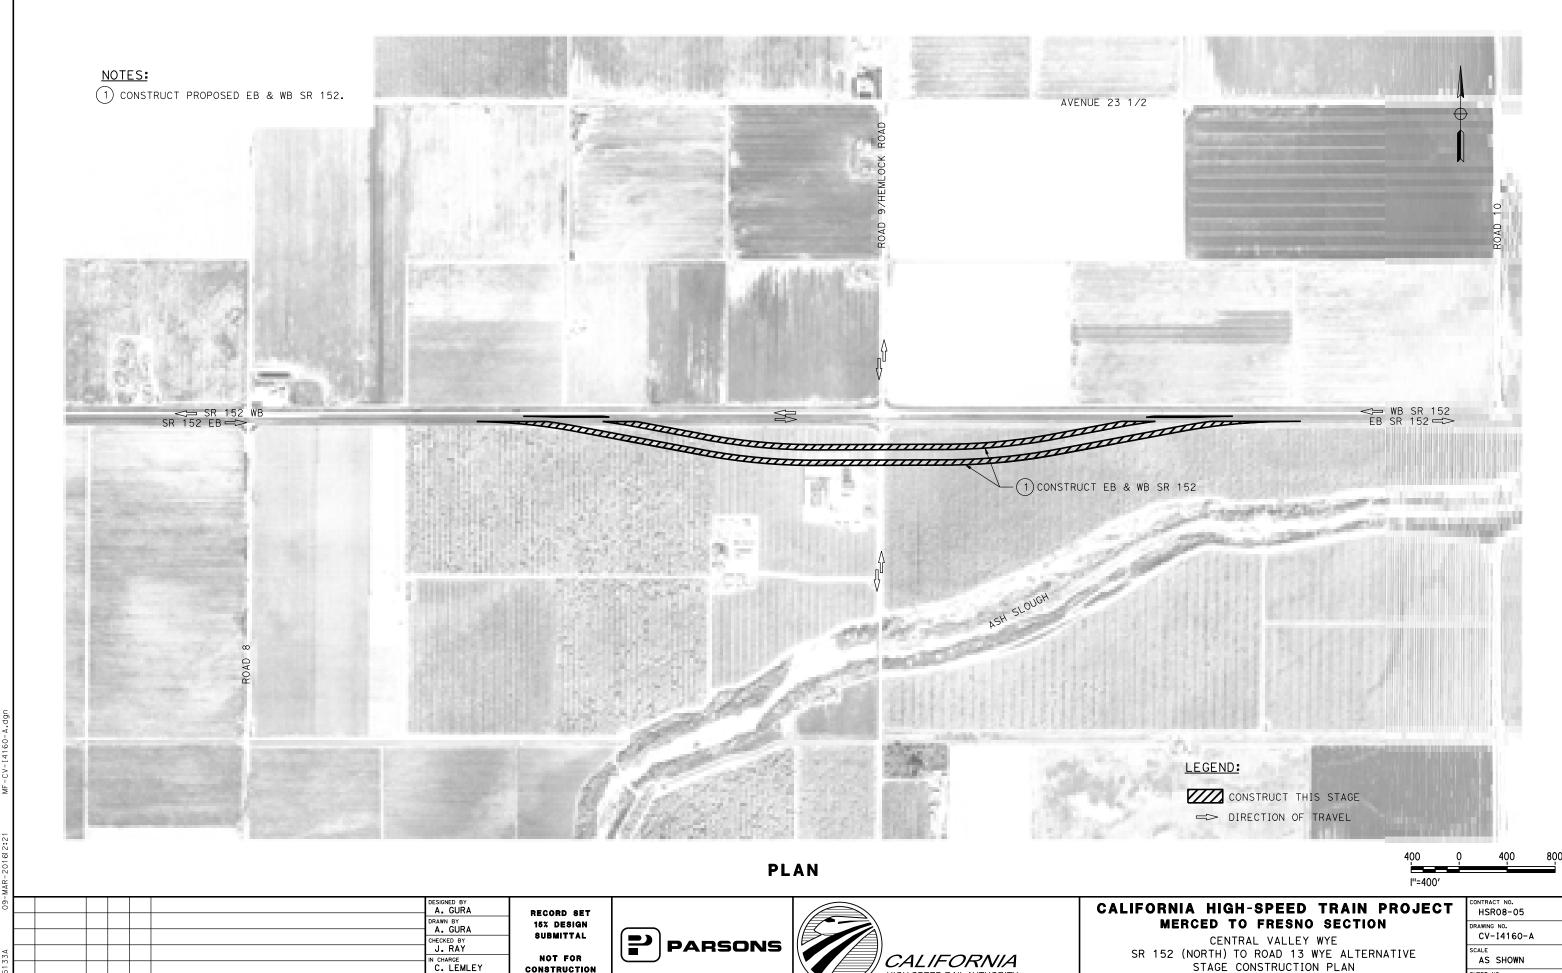

HIGH-SPEED RAIL AUTHORITY

CONSTRUCTION


10/30/2015

BY CHK APP

DESCRIPTION

AS SHOWN SHEET NO.

ROAD 9/SR 152 STAGE 1 OF 4

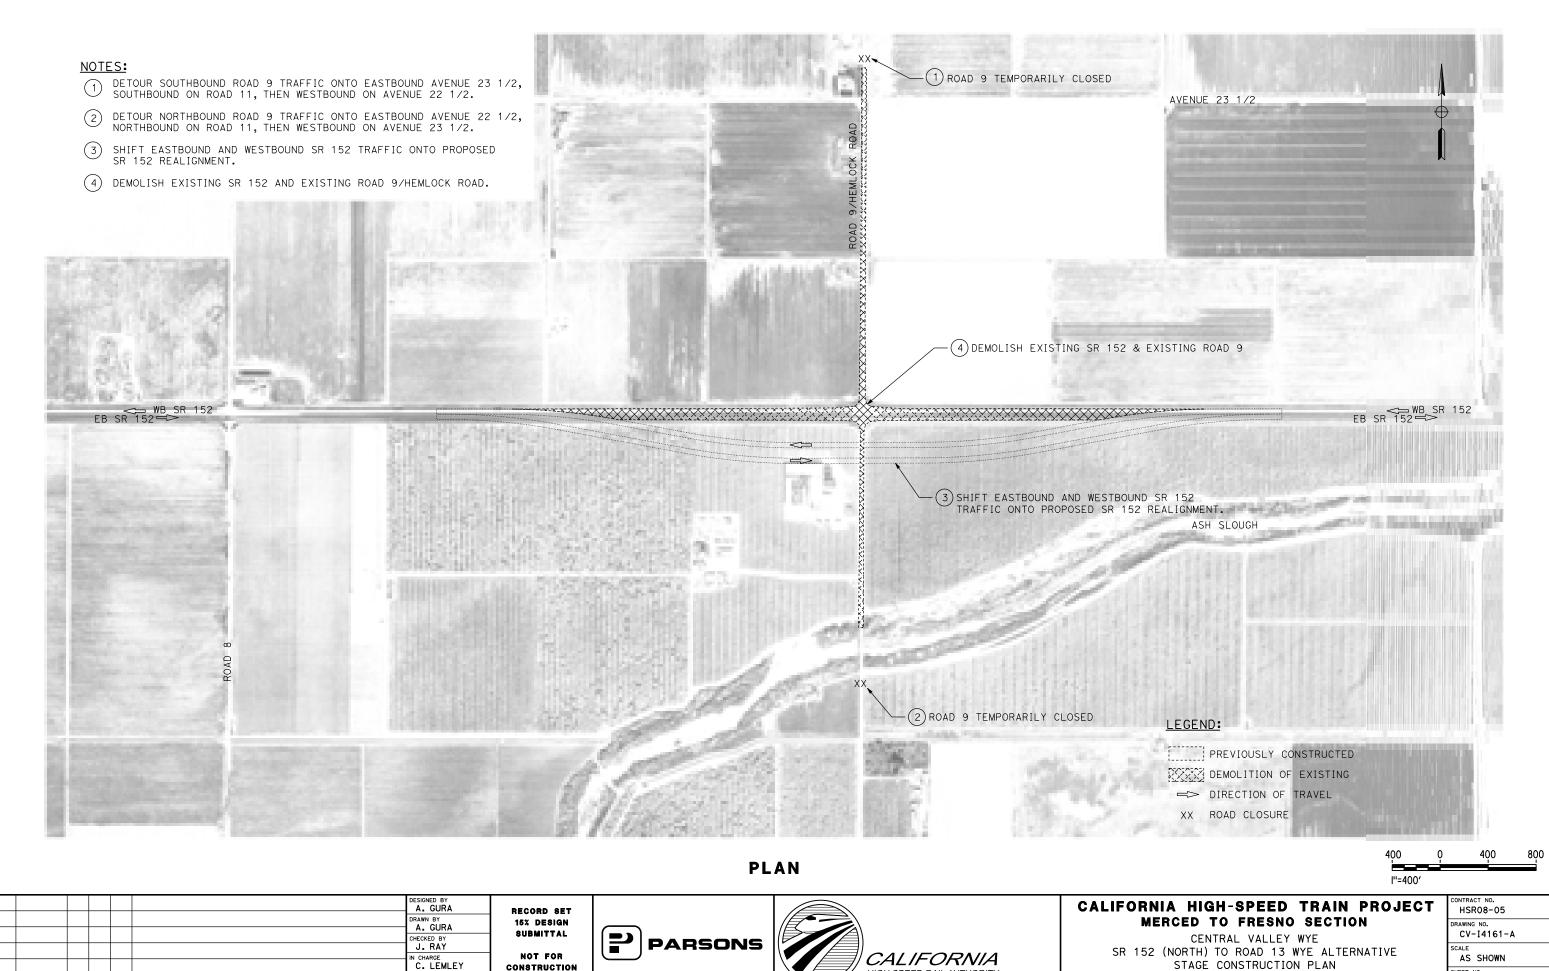


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10/30/2015



STAGE CONSTRUCTION PLAN ROAD 9/SR 152 STAGE 2 OF 4

HSR08-05	
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SHEET NO.	

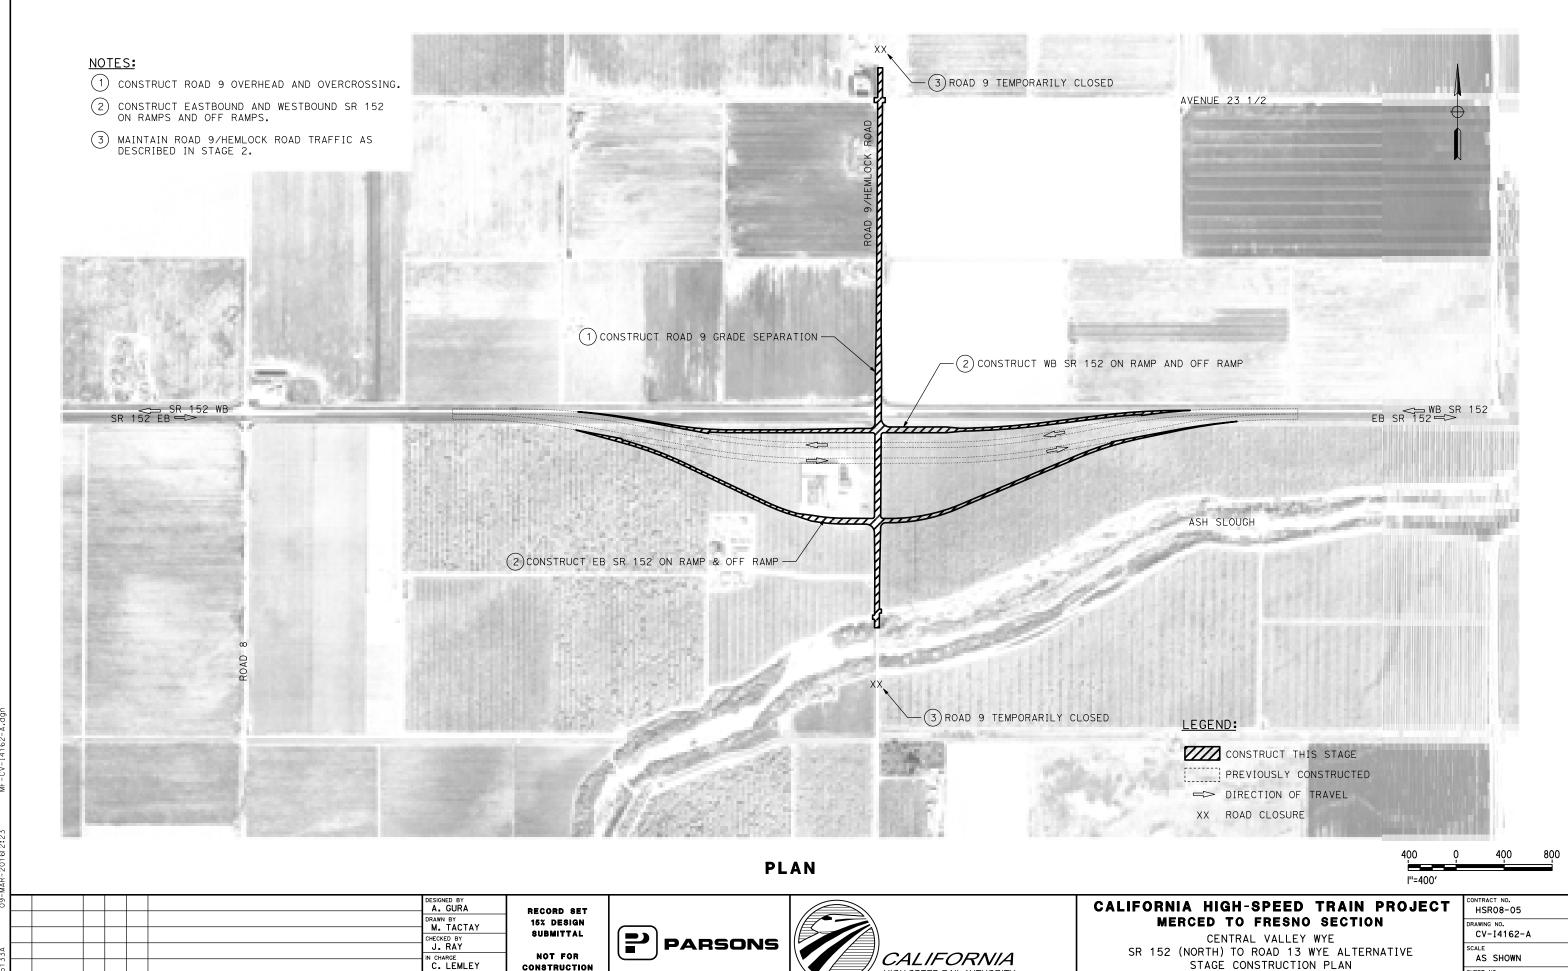


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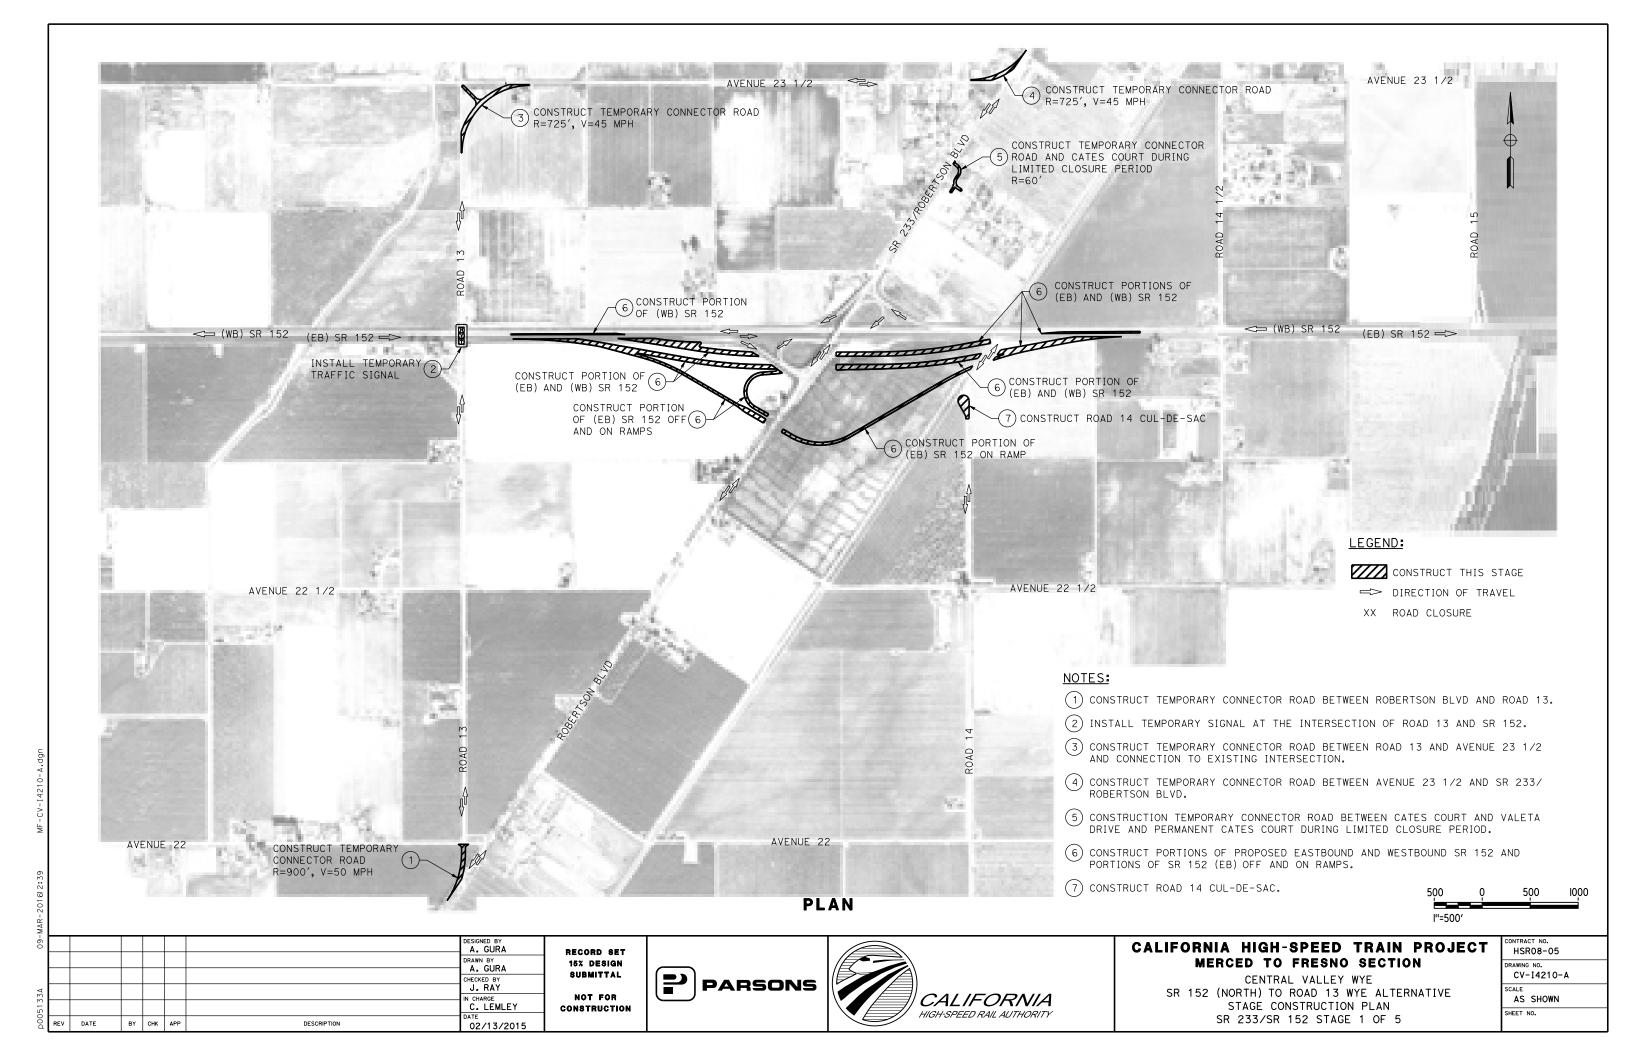
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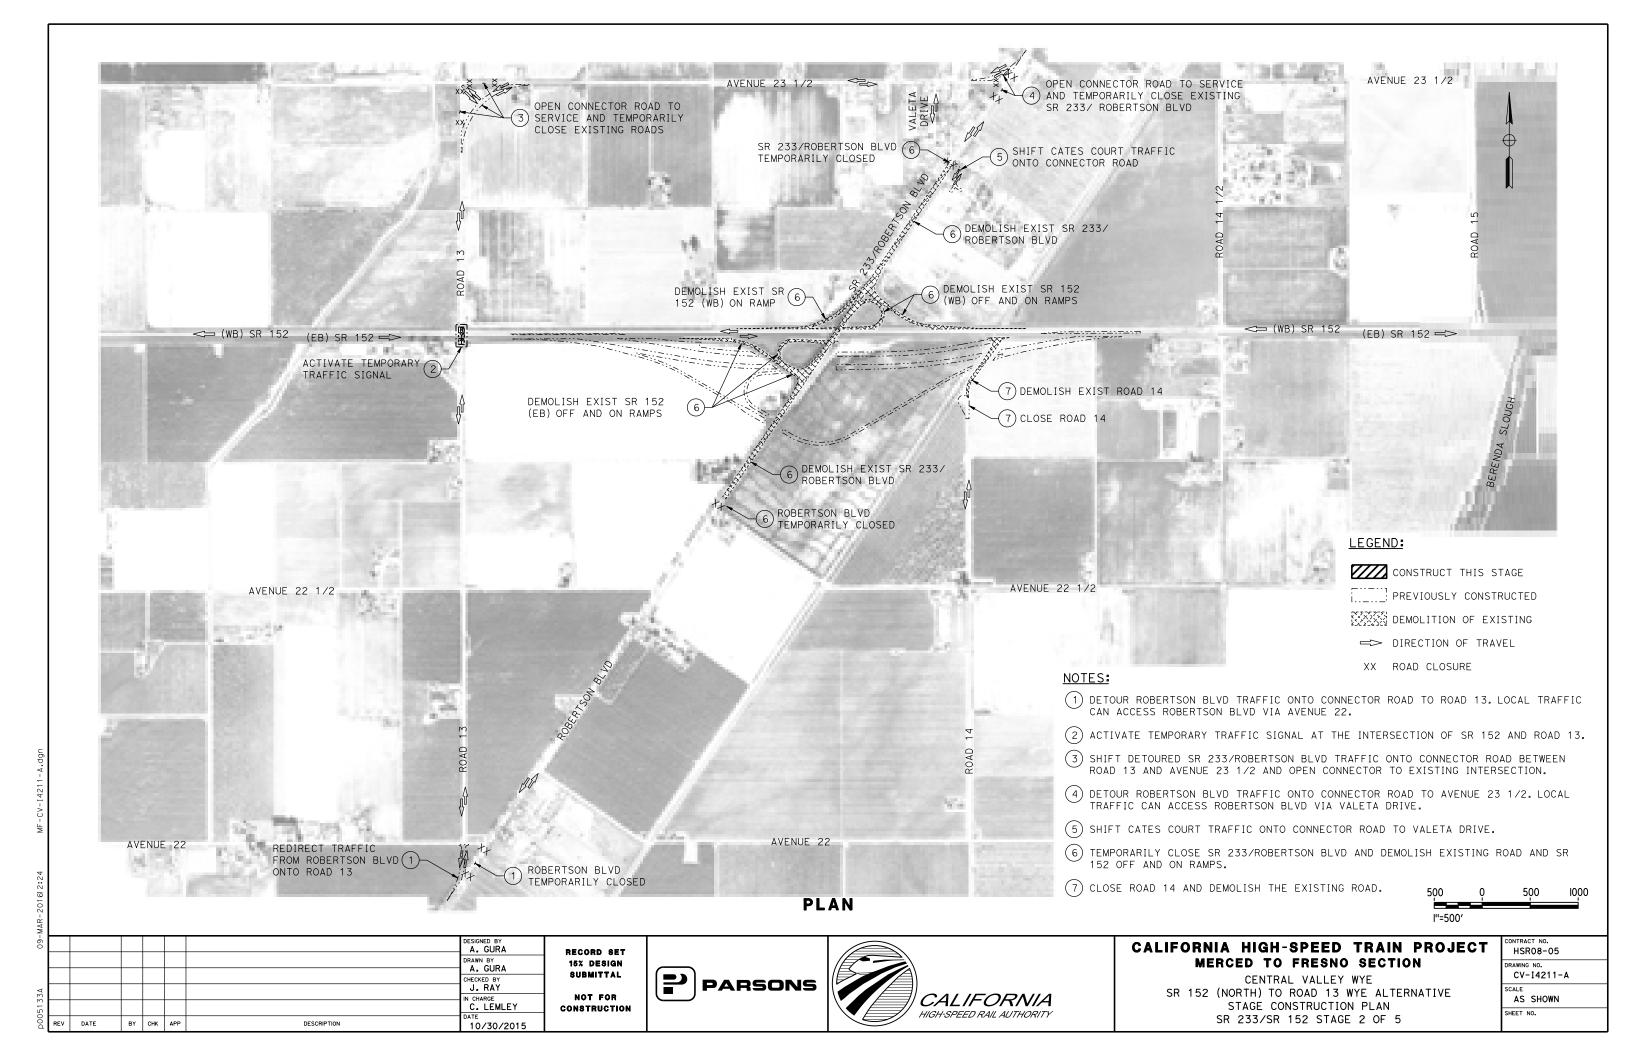



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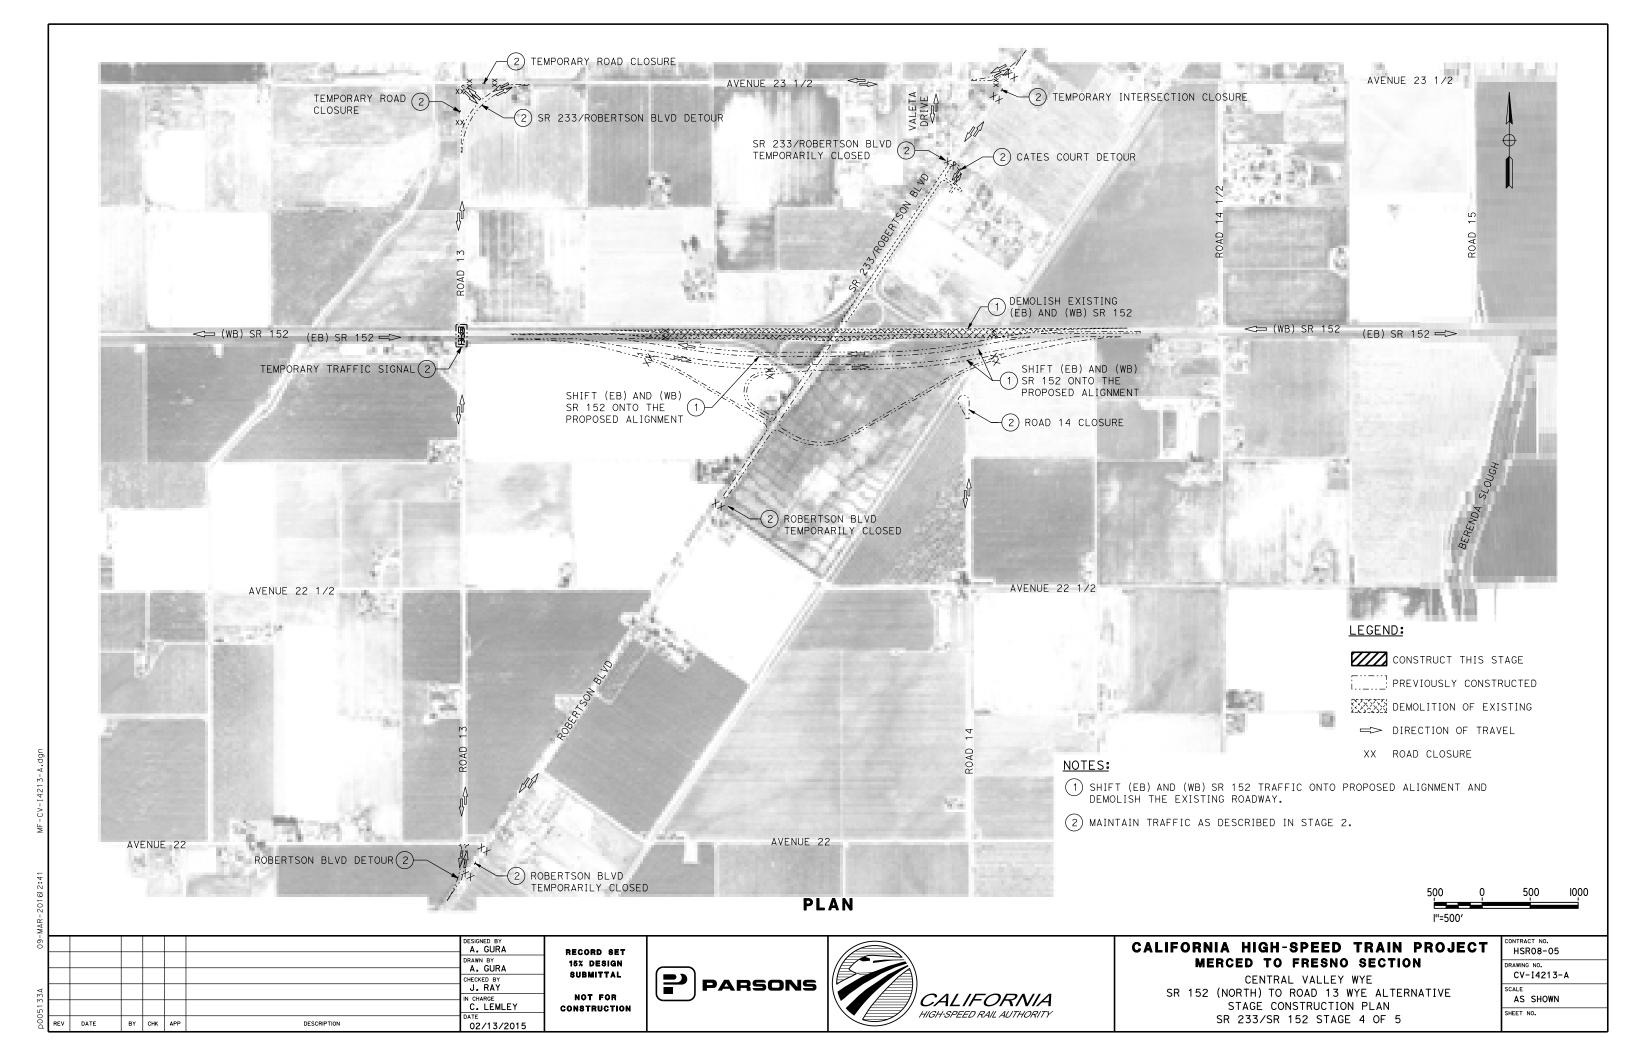
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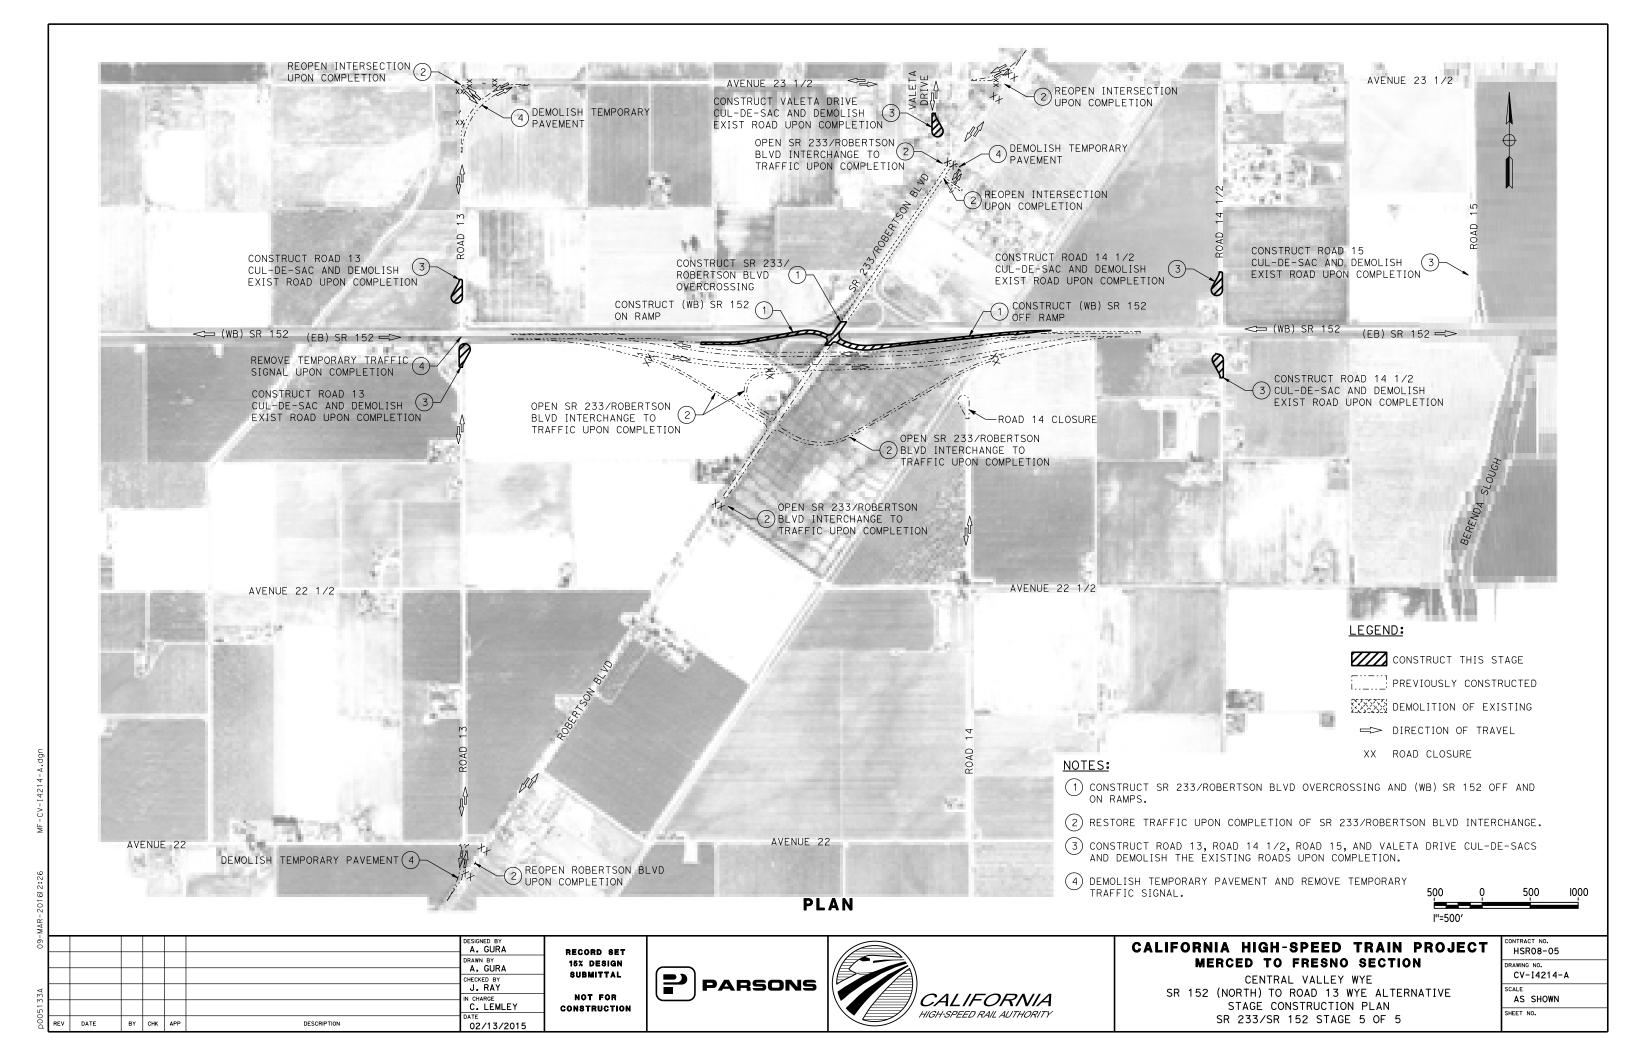









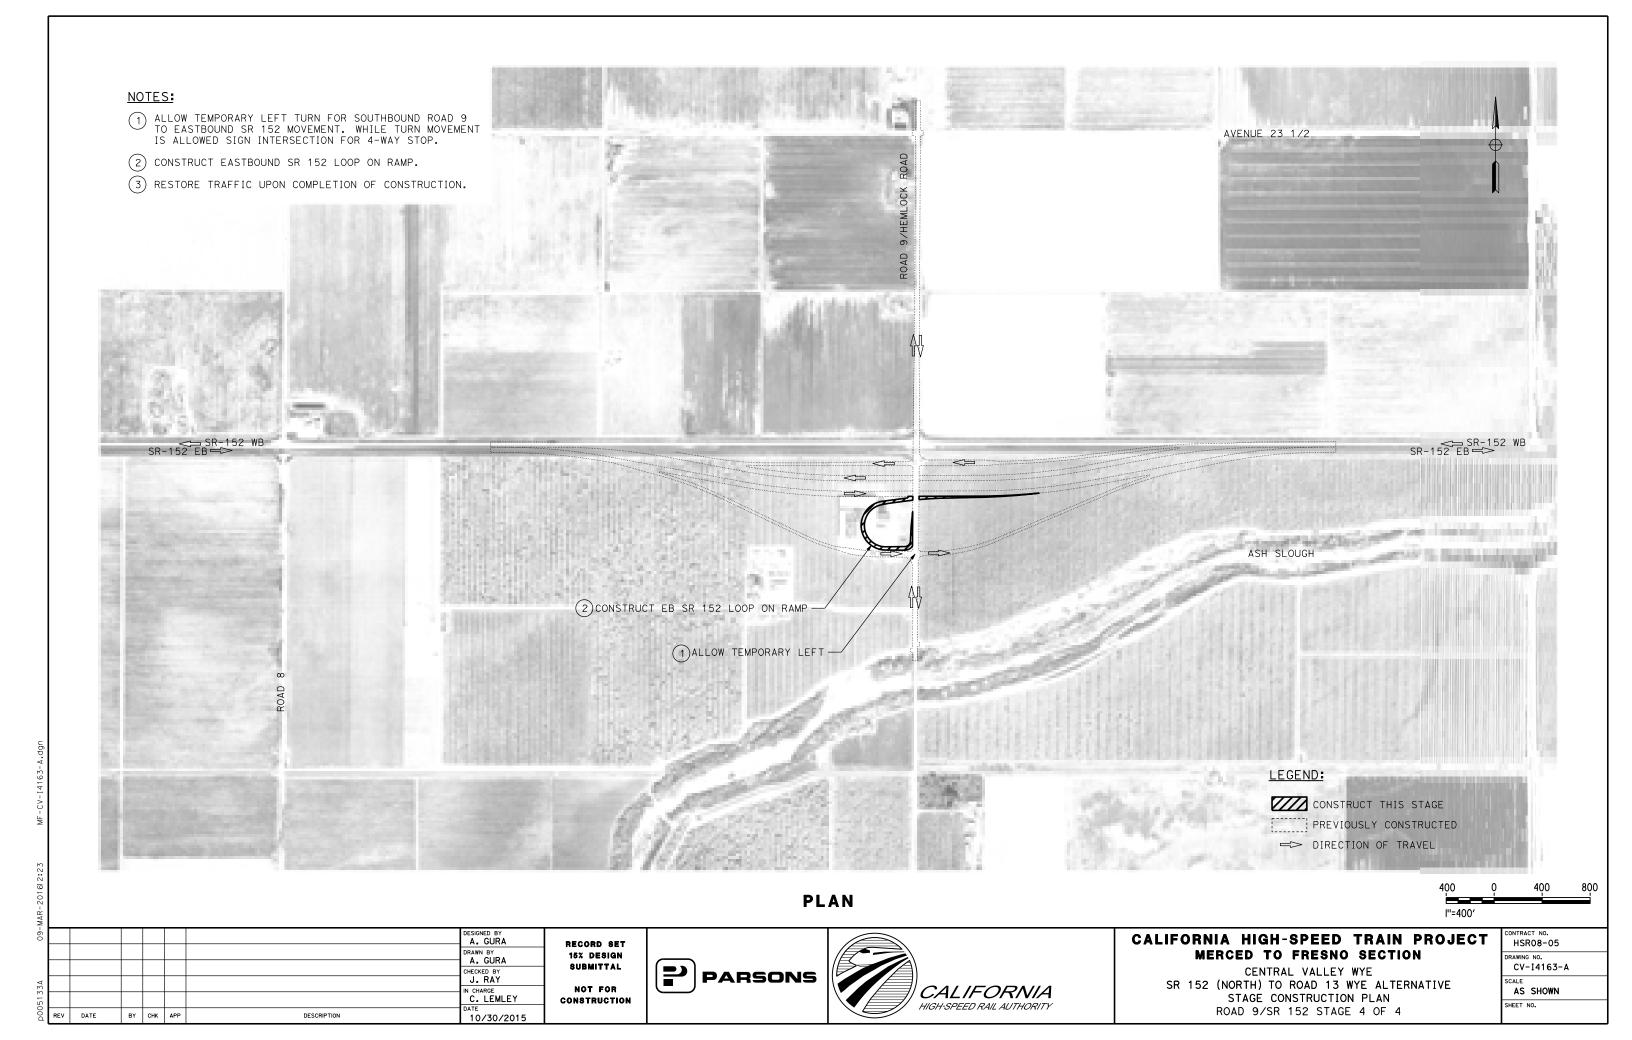

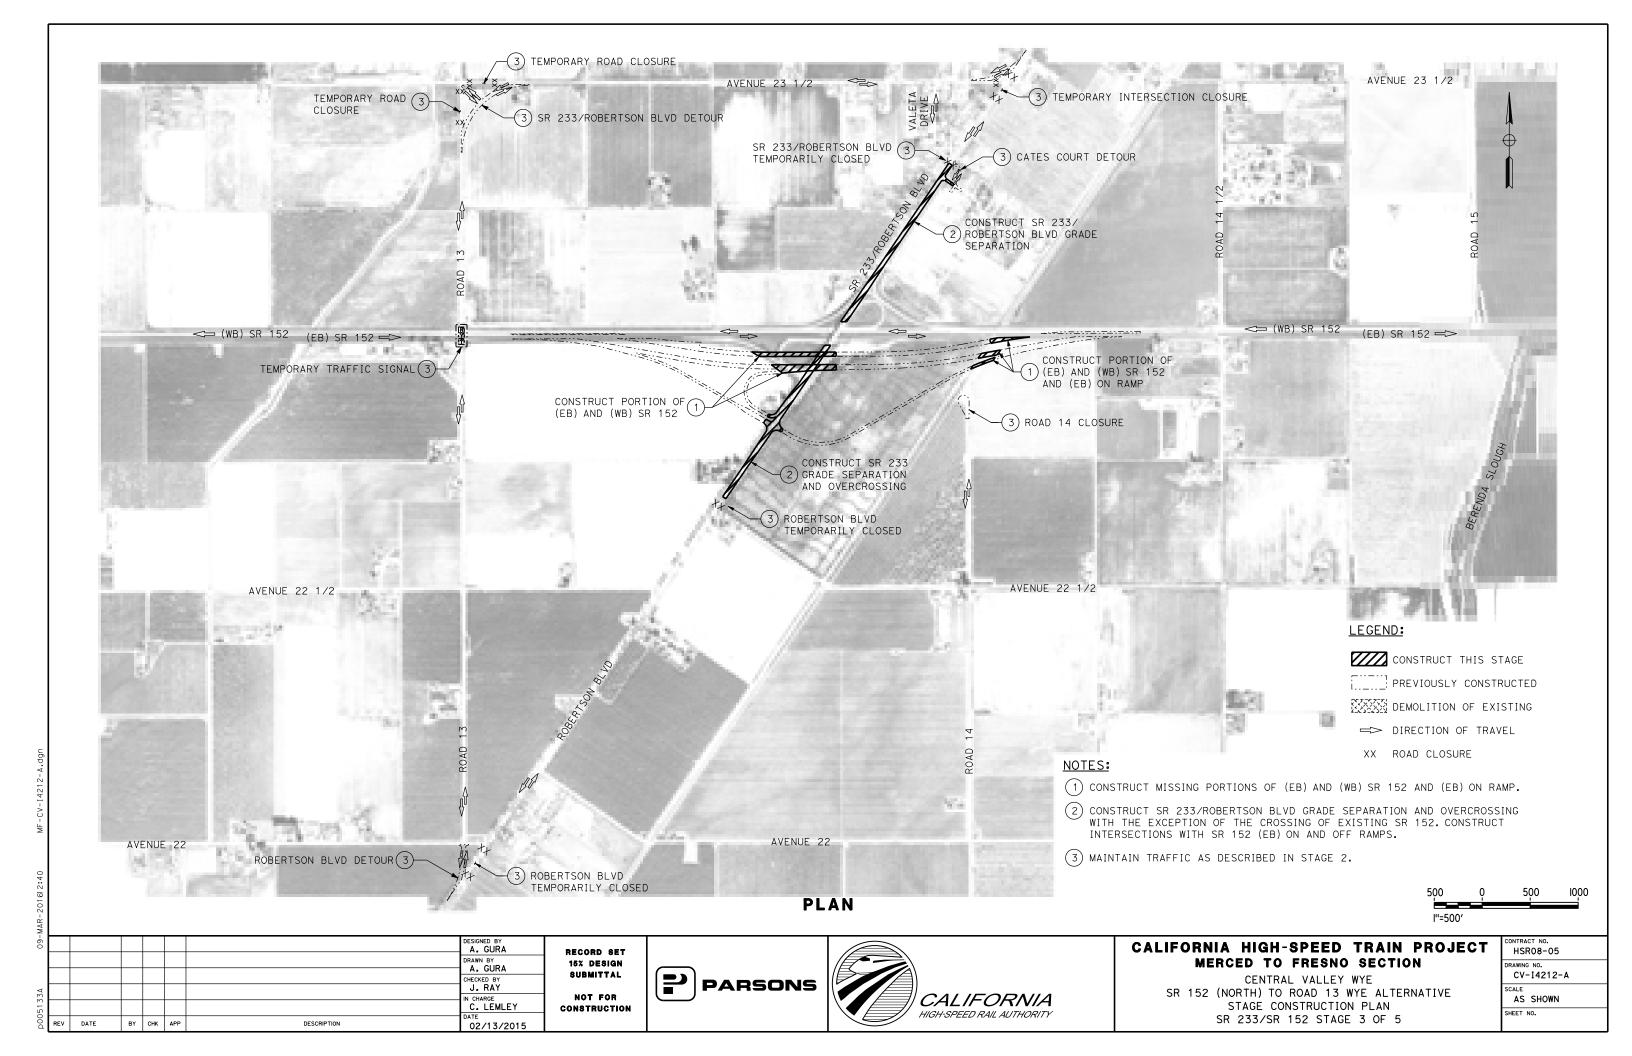

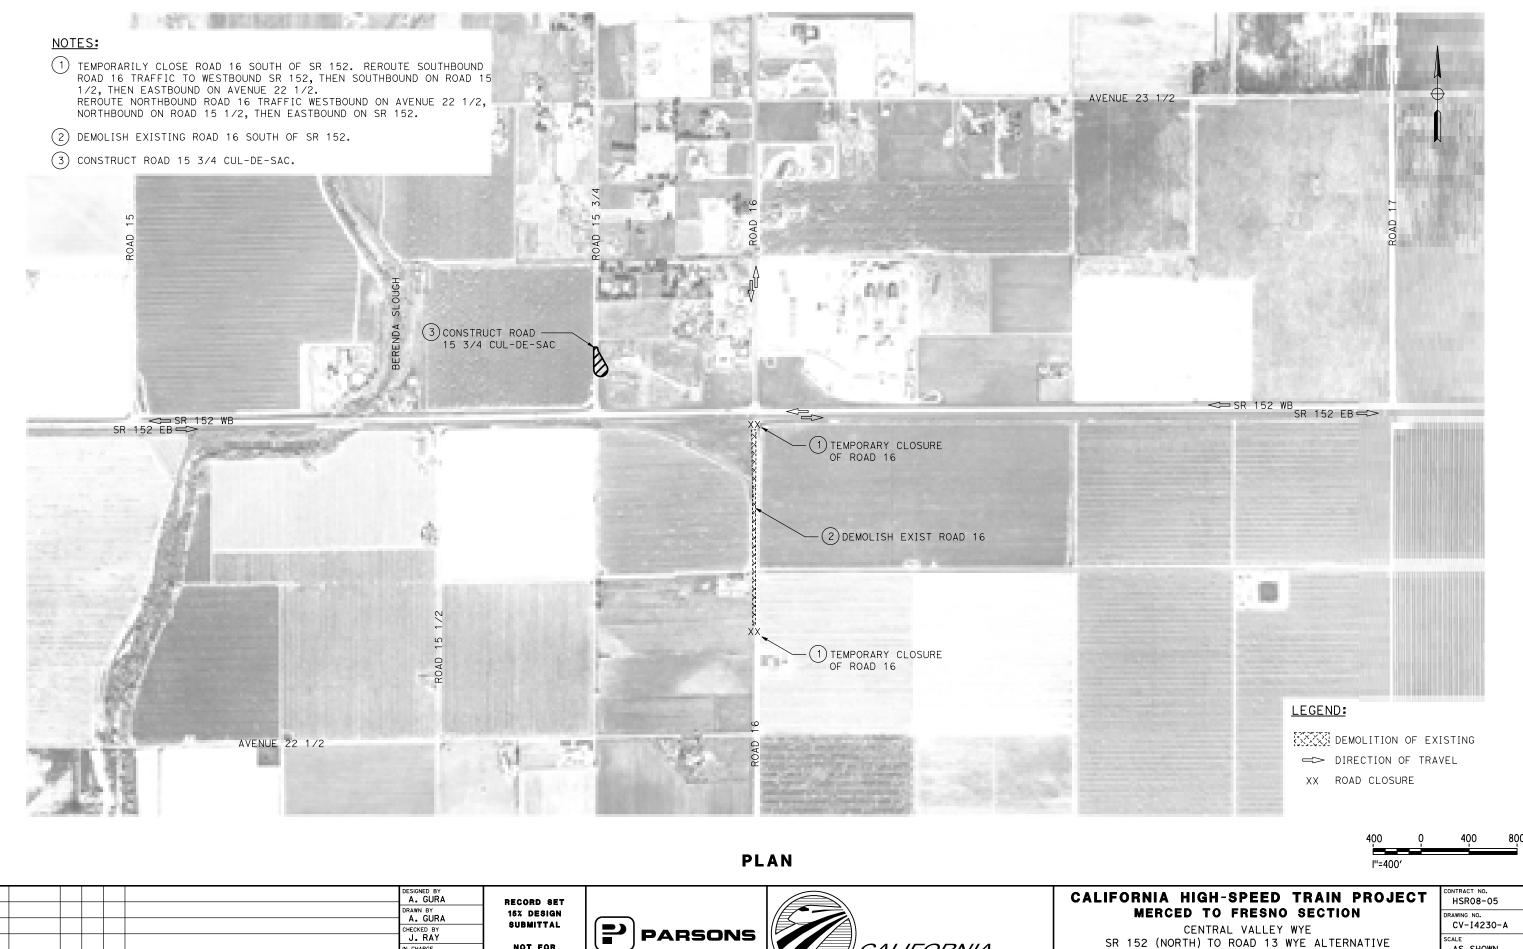

CALIFORNIA

HIGH-SPEED RAIL AUTHORITY

NOT FOR

CONSTRUCTION

IN CHARGE
C. LEMLEY

10/30/2015


BY CHK APP

DESCRIPTION

AS SHOWN SHEET NO.

STAGE CONSTRUCTION PLAN

ROAD 16/SR 152 STAGE 1 OF 4

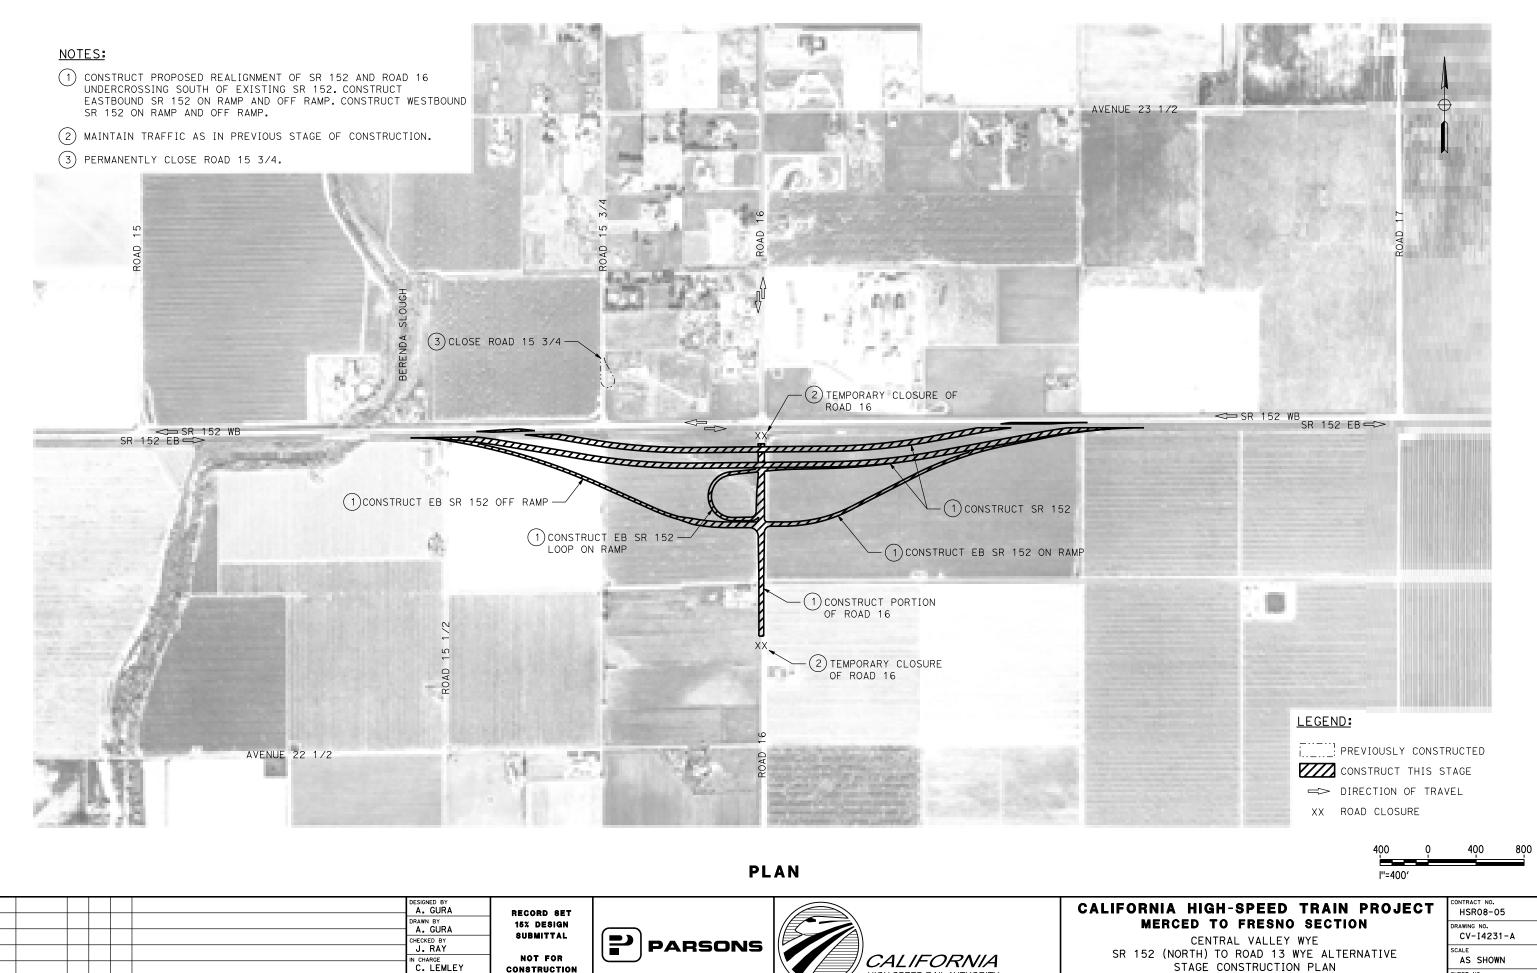


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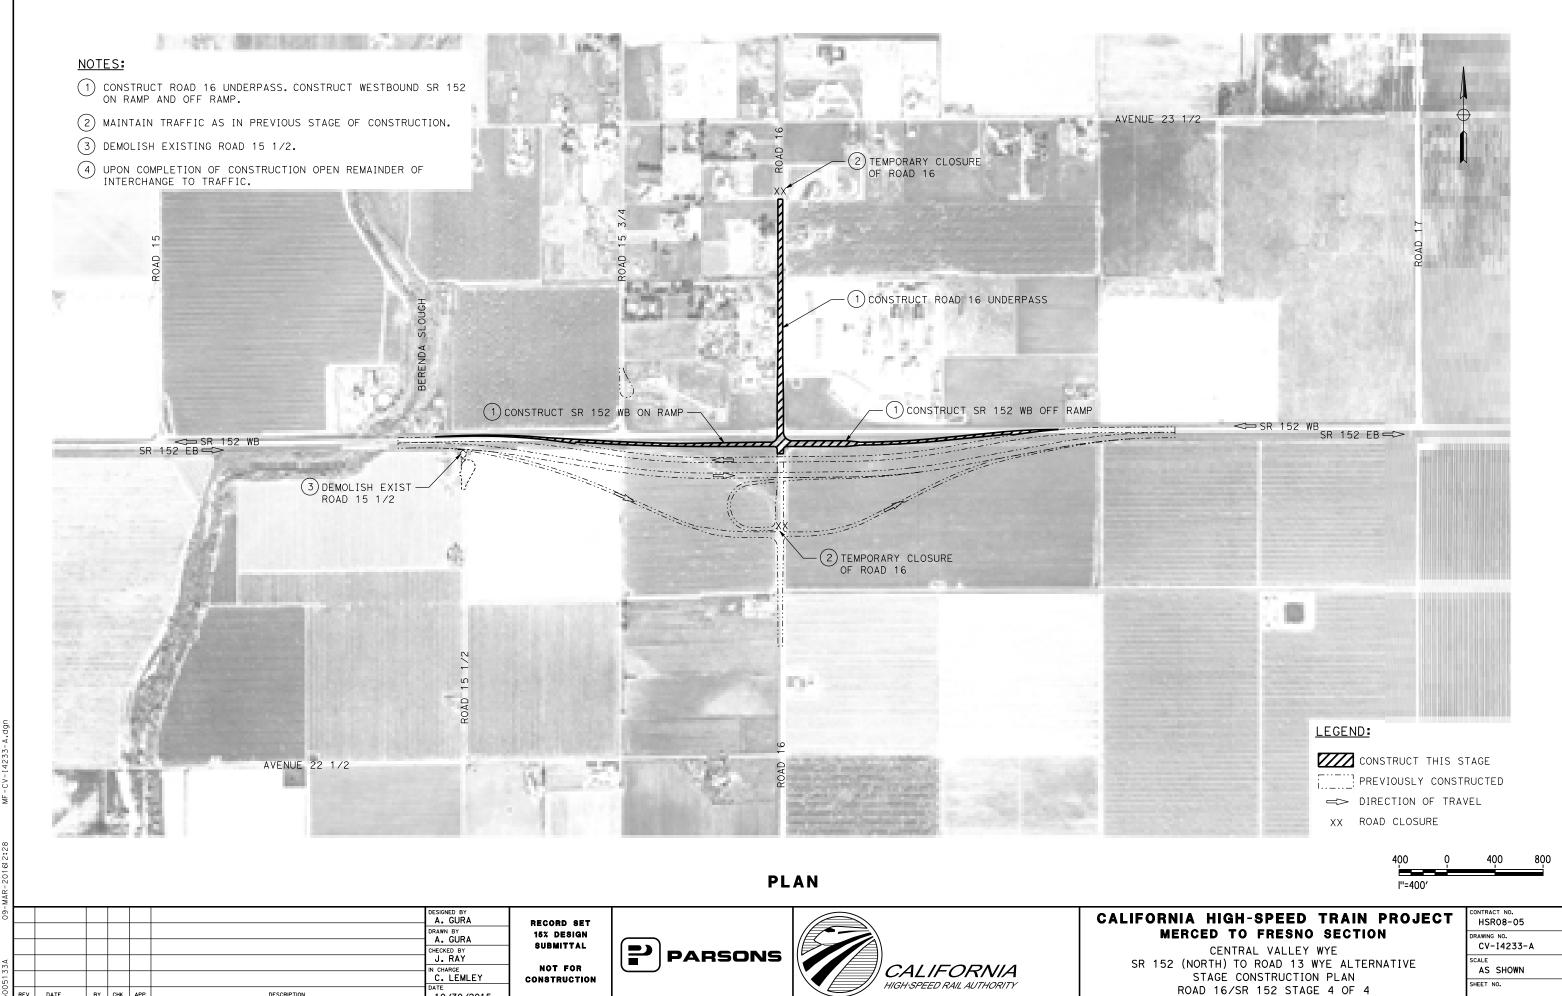
10/30/2015

HIGH-SPEED RAIL AUTHORITY

SHEET NO.

STAGE CONSTRUCTION PLAN ROAD 16/SR 152 STAGE 2 OF 4



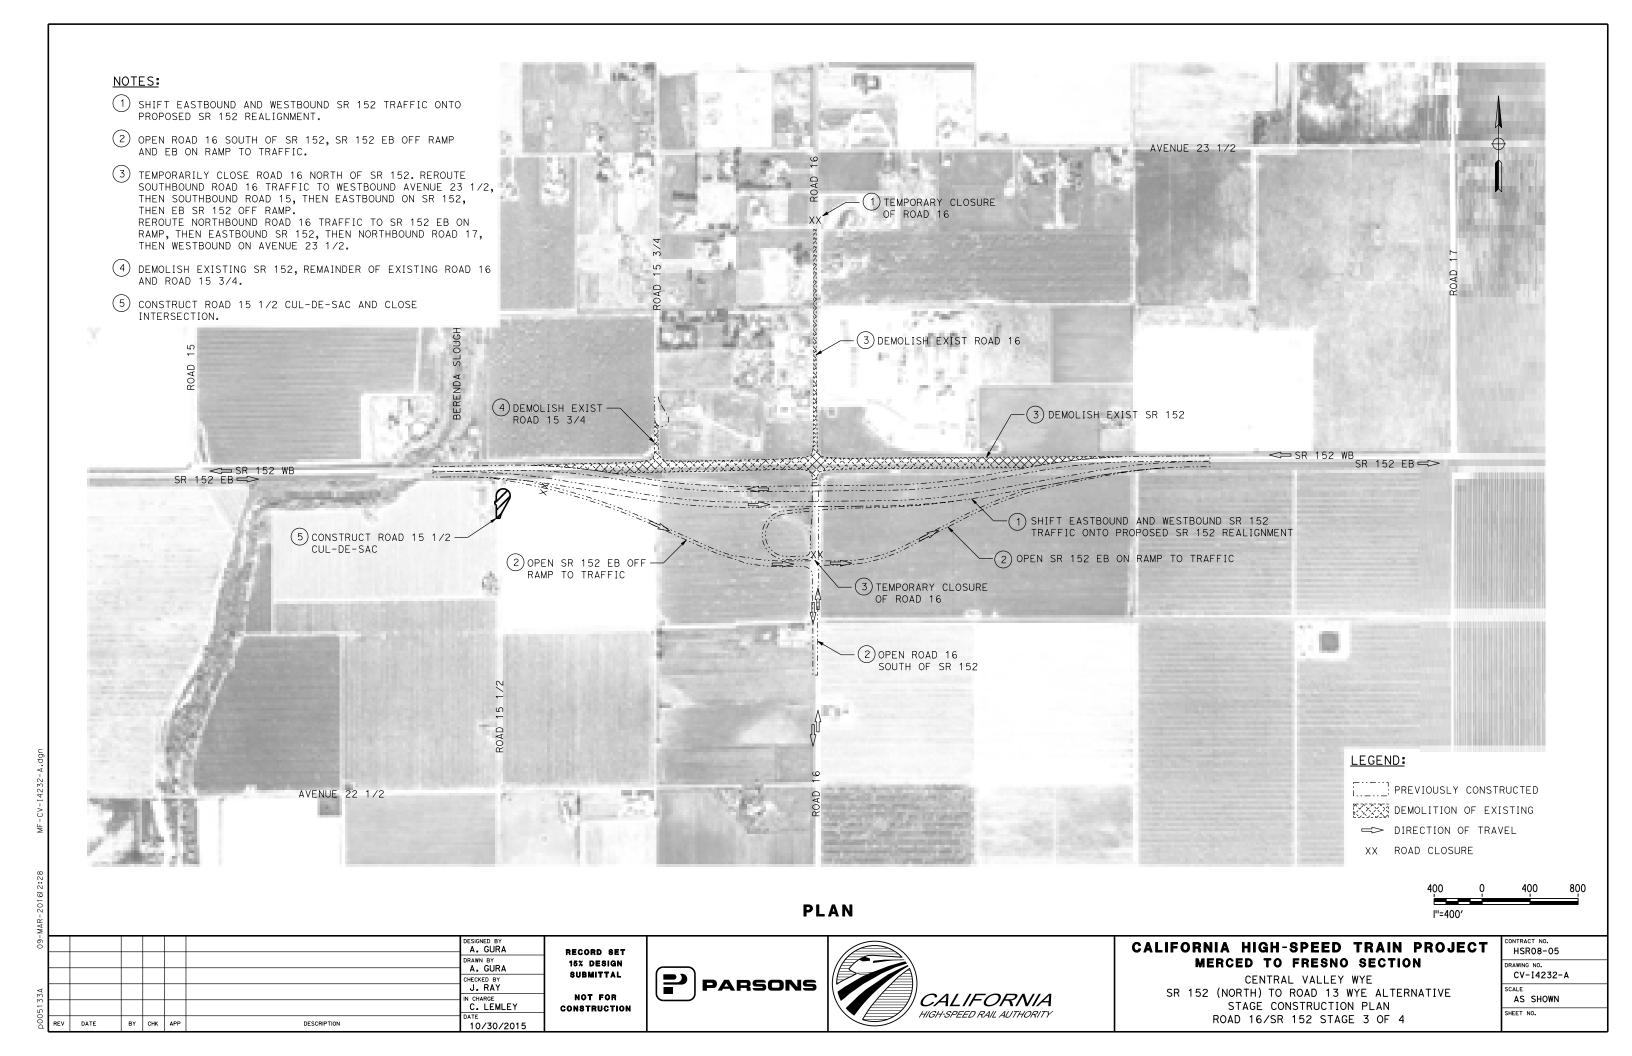

10/30/2015

BY CHK APP

DESCRIPTION